ISSUANCE				T OF DRAWINGS
	2024-4-12 PERMIT	2023-12-04 Cost Est.	DRAWING #	
	2024	2023	ORA	DESCRIPTION
	•	•	A0.0	COVER SHEET
		•	A0.1	GENERAL NOTES, CODE INFO
	•	•	A1.01	OVERALL PLANS - UNIT 1504
	•	•	A1.02	OVERALL PLANS - UNIT 1506
	•	•	A1.03	OVERALL PLANS - UNIT 1508
	•	•	A1.1	DEMO/ REWORK/ CLG./ ELEC 1504 L.L.
	•	•	A1.2	DEMO/ REWORK/ CLG./ ELEC 1504 U.L.
	•	•	A1.3	DEMO/ REWORK/ CLG./ ELEC 1506 L.L.
	•	•	A1.4 A2.0	DEMO/ REWORK/ CLG./ ELEC 1506 U.L. INTERIOR ELEVATIONS + ADA BATH PLAN
	•	•	A3.00	EXTERIOR ELEVATIONS - 1504 DEMO
	•	•	A3.01	EXTERIOR ELEVATIONS- 1504 REWORK
	•	•	A3.10	EXTERIOR ELEVATIONS - 1506 DEMO
	•	•	A3.11	EXTERIOR ELEVATIONS - 1506 REWORK
	•	•	A3.20	EXTERIOR ELEVATIONS - 1508 DEMO
	•	•	A3.21	EXTERIOR ELEVATIONS- 1508 REWORK
	•	•	A4.0	WINDOWS AND DOORS
	•	•	A4.1	WALL SECTIONS
	•		A4.2	ENTRY DETAIL- 1504/1506 UPPER
	•		A4.3	ENTRY DETAIL- 1506 LOWER
	•		MEP001	MEP COVERSHEET
	•		M1.0	PARTIAL FLOOR PLAN DEMO/ NEW
	•		M2.0	MECHANICAL SCHEDULES AND DETAILS
	•		P0.01	PLUMBING COVERSHEET
	•		P1.0	PARTIAL F.P UNDERGROUND DEMO/ NEW
	•		P1.1	PARTIAL F.P DEMO/ NEW
	•		P2.0	PLUMBING SCHEDULES AND DETAILS
	•		MEP1.0	BASEMENT MECH/ PLUMBING
	•		MEP1.1 E0.01	BUILDING ELEVATION ELECTRICAL COVERSHEET
	•		E1,1	REWORK ELEC PLANS 1504 LOWER
	•		E1.01	OVERALL REWORK PLANS 1504
	•		E1.2	DEMO/REWORK ELEC PLANS 1504
	•		E1.02	OVERALL REWORK PLANS 1506
	•		E1.3	DEMO/ REWORK ELEC PLANS 1506 LOWER
	•		E1.4	DEMO/ REWORK ELEC PLANS 1506 UPPER
	•		E1.5	ELEC RENO UNIT 1506 BASEMENT
	•		E401	ELECTRICAL DISER 4504
	•		E5.1 E5.2	ELECTRICAL RISER 1504 ELECTRICAL RISER 1506
	•		E5.2 E5.3	FEEDER SCHEDULE
	•		E600	ELECTRICAL PANEL SCHEDULES
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DANIEL A. SONNTAG AIA, NCARB 734.604.8833 MI ARCHITECT LICENSE #13010-41258 EXPIRATION 12/21/2025

MEP ENGINEER

IMEG 201 SOUTH ANN ARBOR ST SALINE, MI 48176

OWNER

ANN ARBOR HOUSING DEVELOPMENT CORPORATION - COLONIAL OAKS LLC 2000 S. INDUSTRIAL HIGHWAY ANN ARBOR, MI 48104

PROJECT DESCRIPTION

ALTERATION OF THREE APARTMENT BUILDINGS (19 UNITS) - BUILDING #1504, #1506, & #1508 - SEE KEY PLANS FOR SCOPE MIX OF LEVEL 1 AND LEVEL 2 WORK PER MRCEB

TO US-23

TO US-23

TO US-23

TO US-23

TO US-23

TO DOWNTOWN
ANN ARBOR

FULLER ROAD


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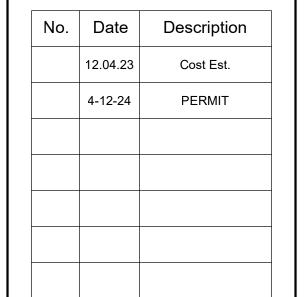
TO US-23

UNIVERSITY OF MICHIGAN NORTH CAMPUS

FULLER ROAD

NOT TO SCALE



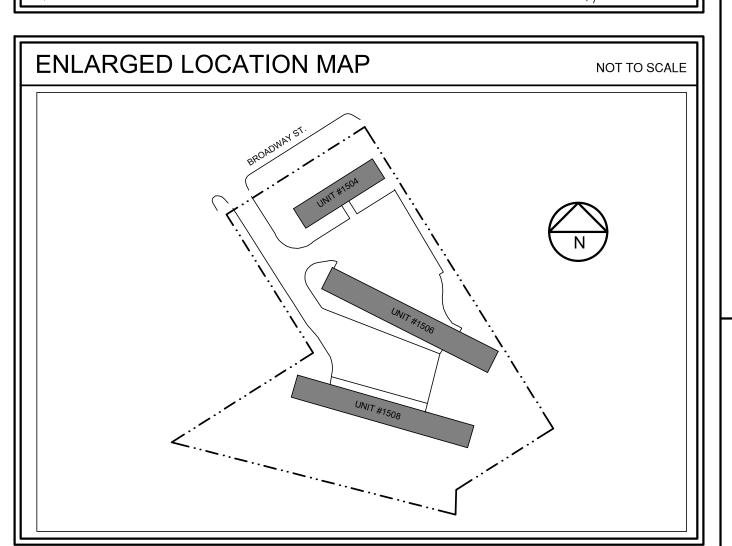

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FACILITY/CLIENT

BROADWAY TERRACE 4-1506-1508 BROADWAY STREET ANN ARBOR, MI 48105



PROJECT

1504-1506-1508 REPLACEMENT WINDOWS 1504-1506 INTERIOR RENOVATIONS



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SONNTAG Design Group

architecture - plc 106 S. MAIN STREET ANN ARBOR, MI 48104 TEL 734.604.8833 DASONNTAG@GMAIL.COM

SHEET TITLE

COVER SHEET GENERAL NOTES

AO.0

GENERAL NOTES

ALL WORK BY ALL TRADES SHALL CONFORM WITH ALL APPLICABLE FEDERAL, STATE AND LOCAL CODES, RULES AND REGULATIONS, OSHA REQUIREMENTS.

ALL WORK SHALL FOLLOW COMMONLY ACCEPTED INDUSTRY STANDARDS AND SHALL MEET ANY AND ALL MANUFACTURER'S HANDLING AND INSTALLATION SPECIFICATIONS.

CONTRACTOR AND ALL SUBCONTRACTORS MUST BE AWARE OF ALL APPLICABLE CODES, REGULATIONS AND INDUSTRY STANDARDS. IN THE CASE OF CONFLICT, THE MOST STRINGENT REQUIREMENT SHALL APPLY.

CONTRACTOR SHALL NOTIFY OWNER OF ANY DISCREPANCIES OR OTHER ISSUES WHICH SHALL NECESSITATE ALTERATION OF DESIGN INTENT PRIOR TO COMMENCEMENT OF RELATED WORK.

CONTRACTOR SHALL BE RESPONSIBLE FOR OBTAINING ALL REQUIRED PERMITS AND INSPECTIONS.

CONTRACTOR SHALL PROVIDE ALL TEMPORARY UTILITIES REQUIRED FOR COMPLETION OF THE WORK. CONTRACTOR TO COORDINATE ANY NECESSARY UTILITY SHUT- OFF WITH OWNER.

COORDINATE SITE ACCESS, STAGING AND STORAGE AREAS. AND PROJECT SCHEDULING CLOSELY WITH OWNER.

CONTRACTOR SHALL MAINTAIN THE IMMEDIATE CONSTRUCTION SITE IN A SAFE, SECURE AND CLEAN

CONTRACTOR TO PROVIDE ANY TEMPORARY WEATHERPROOFING WHICH MAY BE REQUIRED BY

CONTRACTOR TO STORE ALL MATERIALS AND REFUSE IN A SAFE AND SECURE MANNER.

COORDINATE WITH OWNER WHETHER ANY MATERIALS OR FIXTURES REMOVED DURING DEMOLITION SHALL BE SALVAGED AND RETURNED TO OWNER.

CONTRACTOR SHALL BE RESPONSIBLE FOR REMOVAL AND DISPOSAL OF ALL CONSTRUCTION DEBRIS FROM SITE.

CONTRACTOR SHALL BE RESPONSIBLE FOR TEMPORARY PROTECTION OF ALL EXISTING CONSTRUCTION AND ITEMS WHICH ARE TO REMAIN

CONTRACTOR SHALL BE RESPONSIBLE FOR PROVIDING FUME AND DUST CONTROL WITHIN THE STRUCTURE TO THE SATISFACTION OF THE OWNER.

MATERIAL OR CONSTRUCTION PROCEDURES WHICH ARE PROHIBITED BY LAW OR WHICH MAY CAUSE A HARMFUL EFFECT TO THE NATURAL ENVIRONMENT OR THE HEALTH OF ANY PERSON ON THE SITE DURING CONSTRUCTION AND/ OR DURING OCCUPANCY SHALL NOT BE USED ON THE PROJECT.

NO SMOKING SHALL BE ALLOWED INSIDE THE STRUCTURE OR IN THE IMMEDIATE VICINITY DURING CONSTRUCTION.

CONTRACTOR TO BE RESPONSIBLE FOR PROVIDING ANY TEMPORARY SHORING, BRACING OR OTHER SUPPORT NECESSARY DURING REWORK.

DIMENSIONS AND ALIGNMENTS SHOWN ARE BASED UPON VISUAL INSPECTION OF EXISTING STRUCTURE AND CONSTRUCTION DOCUMENTS FOR EXISTING BUILDING PROVIDED BY OWNER. VERIFY COMPLIANCE WITH DESIGN. INTENT (HORIZONTAL AND VERTICAL ALIGNMENT, ETC.) PRIOR TO CONSTRUCTION.

NOTIFY DESIGNER IMMEDIATELY IF ANY DEVIATION FROM DESIGN INTENT IS NECESSARY DUE TO FIELD CONDITIONS

DO NOT SCALE DRAWINGS! USE DIMENSIONS AND ALIGNMENT NOTES PROVIDED.

VERIFY ROUGH OPENING SIZES PRIOR TO PURCHASE AND INSTALLATION OF ANY PREFAB ITEMS SUCH AS DOORS, WINDOWS, FIXTURES AND EQUIPMENT. NOTIFY DESIGN + OWNER OF ANY DISCREPANCY WHICH WILL NECESSITATE ALTERATION OF DESIGN INTENT.

CONTRACTOR SHALL BE RESPONSIBLE FOR ANY AND ALL TYPICAL ITEMS NOT SPECIFICALLY NOTED IN DRAWINGS BUT NECESSITATED BY ITEMS SHOWN SUCH AS BLOCKING. BRACING, INFILL PANELS, FIRESTOPPING, FASTENERS, PLUMBING, ELEC. AND MECH. WORK, ETC. ASSOCIATED WITH THE NEW AND RENOVATED ITEMS SHOWN OR NOTED IN DRAWINGS.

PATCH, REPAIR AND/ OR REFINISH ALL CONSTRUCTION AS NECESSARY ADJACENT TO AREAS DISTURBED BY REWORK OR DAMAGED OR OTHERWISE AFFECTED BY CONTRACTOR'S OR SUBCONTRACTORS' PERSONNEL DURING PROJECT

COORDINATE ALL WORK BETWEEN ALL SHEETS IN THIS SET AND OTHER SUPPLEMENTARY ITEMS PROVIDED BY ARCHITECT OR OWNER SUCH AS BULLETINS, ADDENDA, OWNER'S FINISH AND FIXTURE CHOICES, ETC.

CONTRACTOR TO ENSURE THAT ALL TRADES. SUBCONTRACTORS AND OTHER PERSONS DOING WORK ON THIS PROJECT ARE WORKING FROM CURRENT INFORMATION. IF BULLETINS ARE ISSUED FOR ANY SHEET IN THIS SET OR OTHER CHANGES ARE MADE TO THE WORKING DRAWINGS, CONTRACTOR SHALL BE RESPONSIBLE FOR PROVIDING CURRENT SHEETS. ALL REPLACED SHEETS SHALL BE CLEARLY MARKED AS "VOID" ALONG WITH THE DATE OF THE REPLACEMENT SHEET.

SAMPLE SUBMITTALS FOR FINISH MATERIALS INCLUDING BUT NOT LIMITED TO PAINT, WOOD (SPECIES, GRAIN CHARACTER, FINISH) STONE, TILE, ETC SHALL BE PROVIDED FOR OWNER + DESIGNER REVIEW AND APPROVAL.

SHOP DRAWINGS/ CUTSHEETS SHALL BE PROVIDED FOR OWNER/ DESIGNER REVIEW FOR ITEMS SUCH AS BUT NOT LIMITED TO TRIM PROFILES, LIGHT FIXTURES, HARDWARE,

VERIFY PATTERN LAYOUT FOR ALL APPLICABLE ITEMS WITH DESIGNER PRIOR TO FABRICATION/ INSTALLATION

GENERAL MEP NOTES

DRAWINGS ARE FOR LAYOUT PURPOSES ELECTRICAL, PLUMBING, MECHANICAL WORK IS TO BE DESIGN-BUILD IN NATURE BEYOND FUNCTIONAL/ VISIBLE COMPONENTS DEPICTED HEREIN.

APPROPRIATE DISCIPLINE PERMIT SUBMITTAL BY

ALL WORK TO BE CODE-COMPLIANT WITH ALL

MEP DRAWINGS TO BE PRODUCED FOR

APPLICABLE STATE, LOCAL AND FEDERAL CODES, REGULATIONS, ORDINANCES, ETC.

FINISH QUALITY FOR PARTICULAR INDUSTRY

STANDARDS.

GIVEN ITEMS SHOWN/ NOTED

ALL WORK AND MATERIALS TO BE OF THE HIGHEST

ALL WORK TO INCLUDE ALL COMPONENTS NECESSARY FOR CODE-COMPLIANT AND INDUSTRY-ACCEPTED NORMS FOR INSTALLATION OF

ANY SUBMITTAL DOCUMENTS REQUIRED BY REVIEWING AGENCIES BEYOND THESE PLANS ARE TO BE PROVIDED BY SUBCONTRACTORS.

SUBCONTRACTOR TO PROVIDE CUTSHEETS FOR ALL DECORATIVE/ FUNCTIONAL ITEMS FOR OWNER/ DESIGNER REVIEW. PROVIDE FINISH SAMPLES FOR ANY APPLICABLE ITEMS.

SUBCONTRACTORS TO VERIFY LAYOUTS AT PRE-ROUGH WALKTHROUGH MEETING- AFTER DEMO AND ONCE EXACT LAYOUTS HAVE BEEN DETERMINED COORDINATED WITH FIELD CONDITIONS, EXACT DIMENSIONS, ETC.

COORDINATE ANY MINOR REVISIONS TO EXISTING MECHANICAL, ELECTRICAL, PLUMBING ITEMS WHICH NEED TO BE ADJUSTED/ RELOCATED DUE TO NEW WORK WITH DESIGNER

| ELECTRICAL NOTES

ALL WORK AND MATERIALS TO BE OF THE HIGHEST FINISH QUALITY FOR PARTICULAR INDUSTRY STANDARDS.

ALL WORK TO BE CODE-COMPLIANT WITH ALL APPLICABLE STATE, LOCAL AND FEDERAL CODES, REGULATIONS, ORDINANCES, ETC.

ELECTRICAL DRAWING IS FOR LAYOUT PURPOSES-ELECTRICAL WORK IS ASSUMED TO BE DESIGN-BUILD IN NATURE BEYOND FUNCTIONAL/ VISIBLE COMPONENTS DEPICTED HEREIN.

ALL WORK TO INCLUDE ALL COMPONENTS NECESSARY FOR CODE-COMPLIANT AND NDUSTRY-ACCEPTED NORMS FOR INSTALLATION OF GIVEN ITEMS SHOWN INCLUDING BUT NOT LIMITED TO FASTENERS, BLOCKING, CONDUIT, WIRING, BRACING, SUSPENSION AND FRAMING SYSTEMS

ELECTRICAL CONTRACTOR IS TO VERIFY EXISTING PANEL LAYOUTS AND CIRCUIT LOADS, AND LAY OUT NEW DEVICES SO AS TO FUNCTION TOGETHER AS NOTED IN THIS PLAN.

COORDINATE ALL ELECTRICAL WORK WITH REMAINDER OF ARCHITECTURAL SHEETS- FLOOR AND CEILING PLANS AND DETAILS. DO NOT SCALE DRAWINGS FOR LAYOUT

EXISTING DEVICES SUCH AS SWITCHES, OUTLETS. ETC WITHIN REWORKED AREAS ARE TO BE REMOVED OR RELOCATED AS NOTED FOR LAYOUT DEPICTED. CAP ALL REMOVED ELECTRICAL AS NECESSARY.

EXISTING DEVICES (SWITCHES, OUTLETS) NOT NOTED OTHERWISE ARE TO REMAIN

EXISTING ELECTRICAL TO REMAIN UNLESS SPECIFICALLY NOTED IN SPACES NOT BEING REWORKED

ALL CONDUIT, J-BOXES, ETC IN FINISHED SPACES ARE O BE RECESSED/ CONCEALED WITHIN WALL SURFACES, ABOVE CEILINGS, ETC- NO SUCH COMPONENTS ARE TO VISIBLE WITHIN FINISHED SPACES

NO REWORK IS TO LEAVE VESTIGAL J-BOXES WITH COVER PLATES IN FINISHED AREAS UNLESS APPROVED BY DESIGNER- ANY SUCH SITUATIONS MUST HAVE WIRING PULLED BACK TO J-BOXES WITHIN CLOSETS, OUT-OF-SIGHT, ETC.


ANY ACCESS PANELS REQUIRED IN DRYWALL CEILINGS FOR VALVES, CONTROLS, UNAVOIDABLE ELECTRICAL JUNCTION BOXES, ETC TO BE FLUSH MUD-OVER-FLANGE STYLE, METAL. LOCATIONS TO BE COORDINATED WITH DESIGNER PRIOR TO ROUGH-IN

ANY ELECTRICAL WORK IMPACTING EXISTING OR NEW CODE-REQUIRED RATED ASSEMBLIES/ PARTY WALLS TO BE PATCHED TO RETAIN CONTINUITY OF SEPARATION.

ALL ITEMS NOTED ARE TO HAVE FULL SUBMITTALS TO DESIGNER FOR REVIEW- SHOP DRAWINGS FOR LAYOUT, ELECTRICAL CIRCUITING, FIXTURE CUTSHEETS, ETC.

NFORM DESIGNER OF ANY DISCREPANCY OR OTHER SSUES BETWEEN DESIGN INTENT, EXISTING CONDITIONS, CODE REQUIREMENTS- VERIFY PROPER FUNCTION OF SYSTEMS PRIOR TO ANY COMPONENT INSTALLATION

FIRE SAFETY SYSTEM MODIFICATIONS IF REQUIRED BY THE MUNICIPALITY ARE TO BE UNDER THE ELECTRICAL SUBCONTRACTOR INCLUDING ALL COMPONENTS' DESIGN, SUPPLY, INSTALLATION, AND COORDINATION WITH WORK OF OTHER TRADES. FIELD VERIFY EXISTING CONDITIONS AND REWORK REQUIRED.

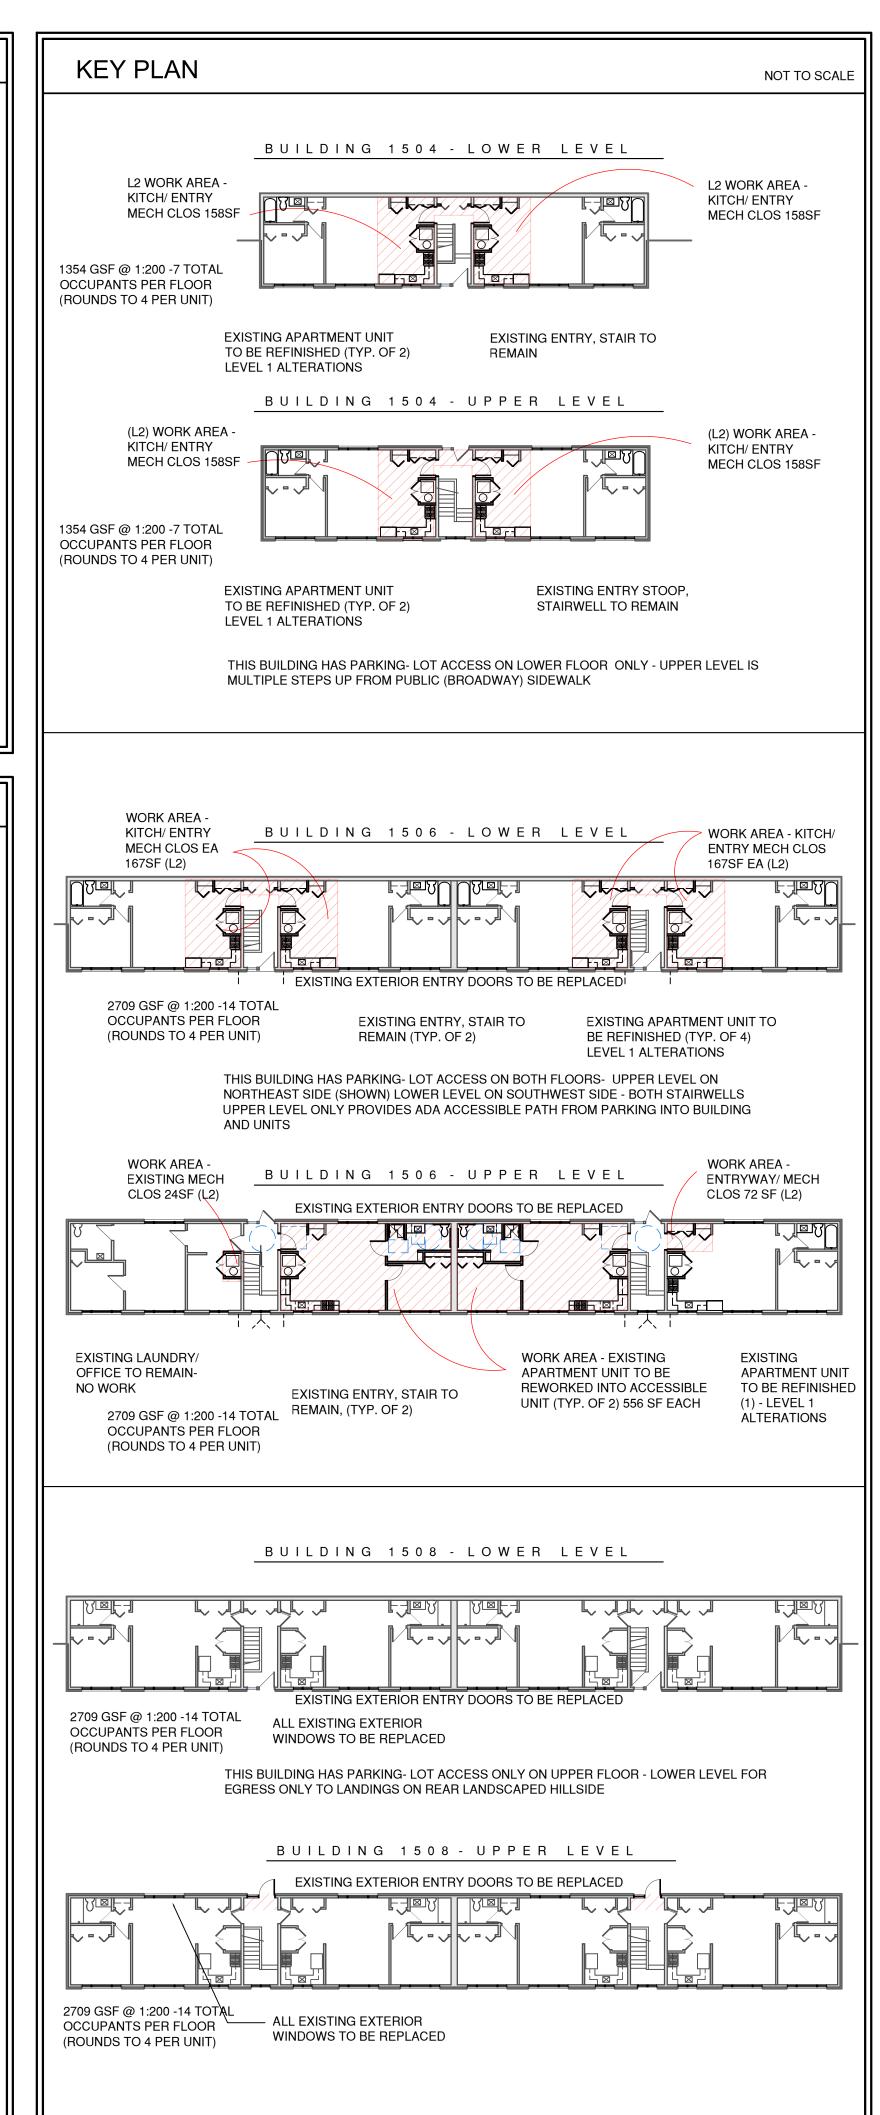

BUILDING DATA

- 2015 Michigan Rehabilitation Code for Existing
- Buildings(MRCEB) 2018 Michigan Plumbing Code (MPC)
- 2015 Michigan Mechanical Code (MMC)
- 2017 National Electric Code(NEC) with Michigan Part 8
- 2015 Michigan Energy Code Including ASHRAE 90.1 -
- 2009 ICC A117.1 Standard for Accessible Buildings and Facilities

ALTERATION LEVEL 2 - CHAPTER 8

2015 International Fire Code 2010 NFPA 13R

COMPLIANCE

 MICHIGAN REHAB CODE 2015 - WORK AREA 301. 1. 2 -**ALTERATION LEVEL 1- CHAPTER 7**

CONSTRUCTION TYPE

• 5-B

USE GROUP

SEPARATION

R-2 - EXISTING TO REMAIN

AND STAIRWELLS TO BE MAINTAINED

1HOUR EXISTING DEMISING BETWEEN UNITS, UNITS

BUILDING FOOTPRINT / OVERALL UNIT #1504 - 1380 SF PER FLOOR = 2760 SF TOTAL

- UNIT #1506 2760 SF PER FLOOR = 5520 SF TOTAL
- UNIT #1508 2760 SF PER FLOOR = 5520 SF TOTAL

WORK AREA (LEVEL 2 - RECONFIGURATION)

• UNIT #1504 - 316 SF FLOOR 1 (23%) 316 SF FLOOR 2 (23%)

632 SF - 632/2760 = 23% • UNIT #1506 - 632 SF FLOOR 1 (23%) 1208 SF FLOOR 2 (44%)

1840 - 1840/5520 = 33% UNIT #1508 - LEVEL 1 ALTERATIONS ONLY

EXCEPT ROOF OVERHANG MODIFICATIONS AT UPPER ENTRIES (EXTERIOR OF BUILDING)

NO CHANGE OF USE NO ADDITIONS

NO SITE/ EXTERIOR STAIR/ WALK WORK PROPOSED

BUILDING HEIGHT

EXISTING TO REMAIN (2 STORIES) - 25'

DISTANCE BETWEEN BUILDINGS NO CHANGES TO EXISTING

FIRE SUPPRESSION

 NOT CURRENTLY SUPPRESSED - NO FLOOR HAS OVER 50% WORK AREA PROPOSED

ACCESSIBILITY

CIRCULATION PATHS TO REMAIN

UNITS #1504 #1506 #1508 - EXISTING BUILDING ENTRY,

(2) REWORKED APARTMENTS DESIGNED TO BE FULLY ADA-COMPLIANT (#1506 UPPER LEVEL 4B+7B)

ACCESSIBLE ROUTE TO EXTEND FROM UPPER PARKING AREA INTO AND THROUGHOUT UNITS 4B+7B

EXISTING LAUNDRY/ OFFICE AREA IN BUILDING #1506 TO REMAIN-

ACCESSIBLE

OF BUILDINGS SLATED FOR INTERIOR REWORK OF ANY SCOPE ONLY UPPER LEVEL OF BUILDING 1506 CURRENTLY SITED TO ALLOW COMPLIANT ACCESS AT-GRADE DUE TO SLOPING SITE

OCCUPANCY/ EGRESS

OCCUPANT LOAD: EXISTING TO REMAIN - NO CHANGES

EACH UNIT - 677 GSF (2709/4) AT 1:200 (T1004.1.2) UNDER 10 OCCUPANTS, SINGLE EXIT TO APT OK

UNIT ENTRIES MODIFIED TO 36" DOOR WIDTH

EACH UNIT TO HAVE BEDROOM WINDOW MODIFIED FOR EGRESS COMPLIANCE (SIZE OF OPENING, SILL HEIGHT)

BUILDING EGRESS: 36" EXTERIOR DOOR AT BOTH TOP AND BOTTOM OF STAIR (SLOPING SITE)- NO CHANGES

No. Date Description 12.04.23 Cost Est. 4-12-24 PERMIT

DAS/ ARG DRAWN BY

FACILITY/CLIENT

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PROJECT

1504-1506-1508 REPLACEMENT WINDOWS 1504-1506 INTERIOR RENOVATIONS



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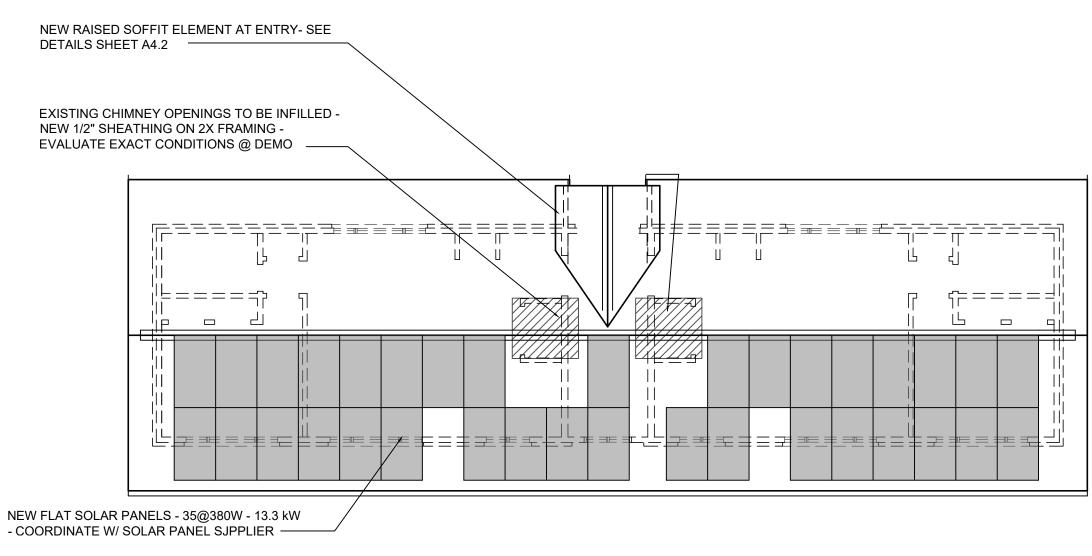
SONNTAG DESIGN GROUP

architecture - plo 106 S. MAIN STREET ANN ARBOR, MI 48104 TEL 734.604.8833


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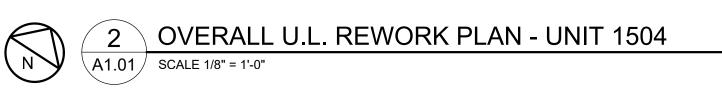
GENERAL NOTES, CODE INFO


SHEET TITLE







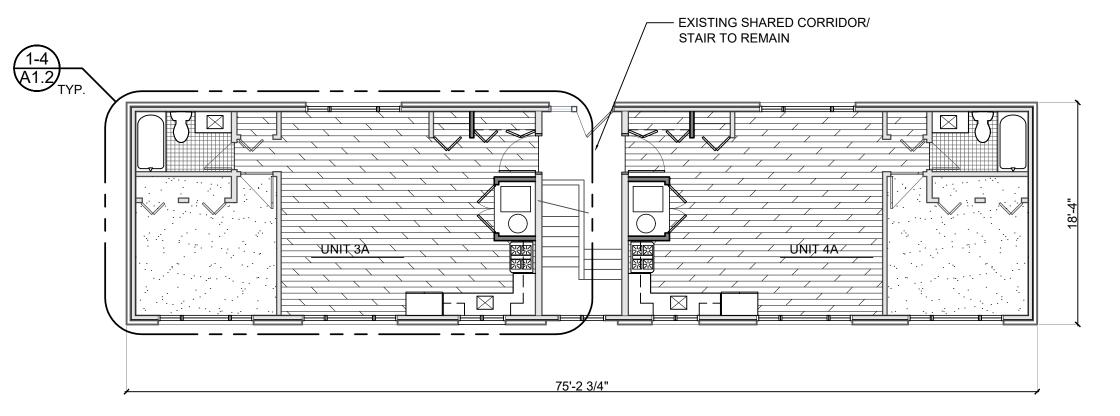

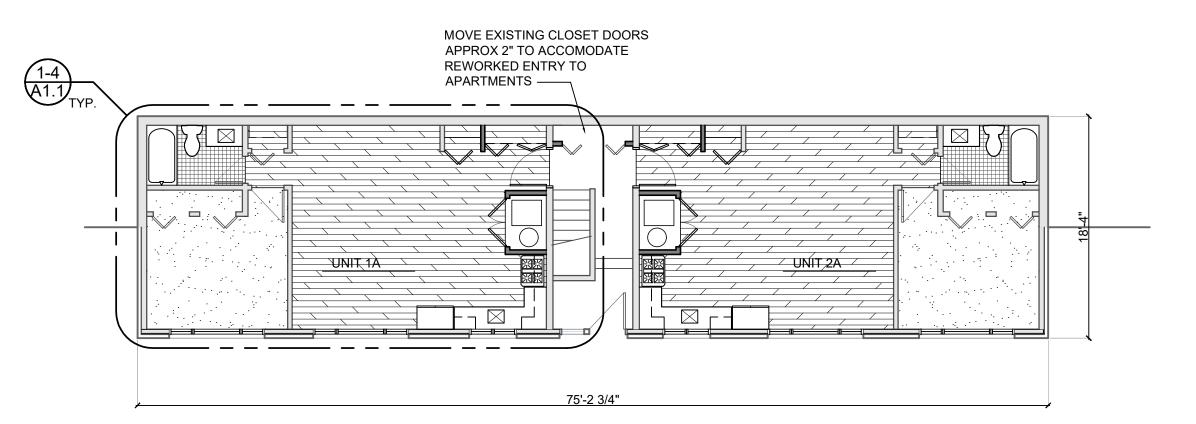



No.	Date	Description
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	4-12-24	PERMIT

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FACILITY/CLIENT

BROADWAY IERRACE 506- 1508 BROADWAY STREE ANN ARBOR, MI 48105



SCOPE NOTES - UNIT 1504

RECONFIGURED, CHIMNEYS REMOVED, CHIMNEY OPENINGS AT FLOORS AND ROOF TO BE FRAMED FLUSH W/ EXISTING

NEW ROOFING - NEW SHINGLES, UNDERLAYMENT, ICE SHIELD, FLASHINGS ON EXIST. SHEATHING/ STRUCTURE. REPAIR AS NECESSARY. NEW FASCIA TRIM, GUTTERS &

NEW SOLAR SYSTEM INSTALLED ON ROOF - DESIGNED BY

KITCHEN CABINETRY, COUNTERS, FIXTURES, APPLIANCES REMOVED - NEW INSTALLED PER LAYOUTS. DIVIDER WALLS

BATHROOM FIXTURES, FINISHES REMOVED. NEW INSTALLED

NEW LIGHT FIXTURES ON EXISTING ROUGH-INS. SOME NEW/

ALL NEW WINDOWS IN OPENINGS REWORKED FOR EGRESS

NEW INSULATION - BLOWN-IN (NOT REMOVING EXISTING

NEW ENTRY DOORS, FRAMES & SIDELITES IN STAIRWELLS

NEW FINISHES, SUBSTRATE. PATCH & REPAIR THROUGHOUT

NO WORK IN STAIRWELLS EXCEPT INCIDENTAL TO OTHER WORK- PATCH & REPAIR ETC. DUE TO WINDOW/ DOOR

ALL NEW EXTERIOR WINDOWS IN EXISTING OPENINGS

NEW MECHANICALS, MECHANICAL CLOSETS

DOWNSPOUTS, EXISTING SOFFITS TO REMAIN

BETWEEN KITCHEN AND LIVING AREA REMOVED

RELOCATED PER ENLARGED PLANS.

(LIVING AREA, KITCHEN, STAIRWELL)

COMPLIANCE (BEDROOMS)

(UPPER AND LOWER LEVELS)

FLOOR ROOF STRUCTURE

MANUFACTURER

PER PLANS

DRYWALL)

APARTMENTS

REPLACEMENTS

APPLIANCES BY OWNER

WINDOW TREATMENTS BY OWNER

PROJECT

1504-1506-1508 REPLACEMENT WINDOWS 1504-1506 INTERIOR RENOVATIONS



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SONNTAG
DESIGN
GROUP

architecture - plc 106 S. MAIN STREET ANN ARBOR, MI 48104 TEL 734.604.8833 DASONNTAG@GMAIL.COM

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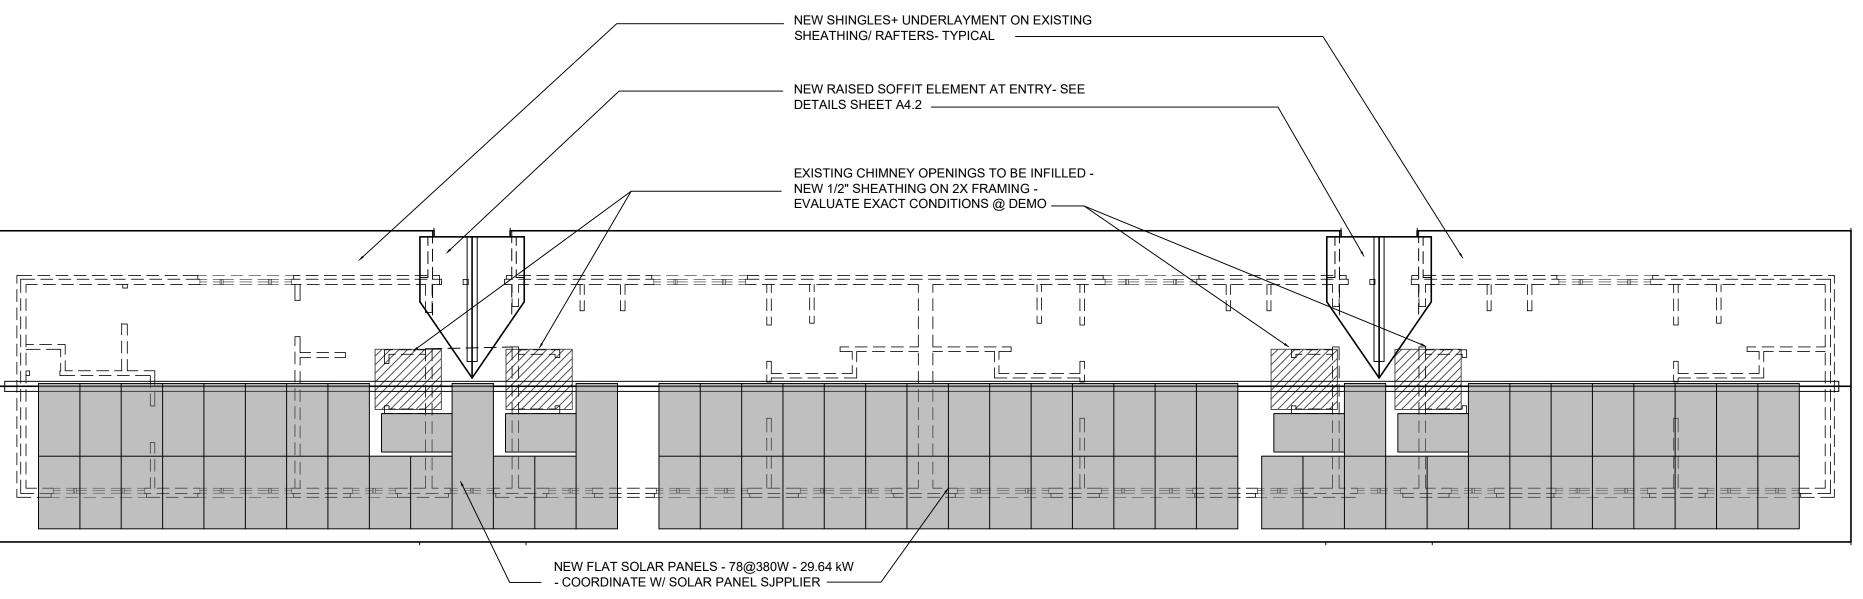
OVERALL REWORK/ ROOF

UNIT 1504


PLANS


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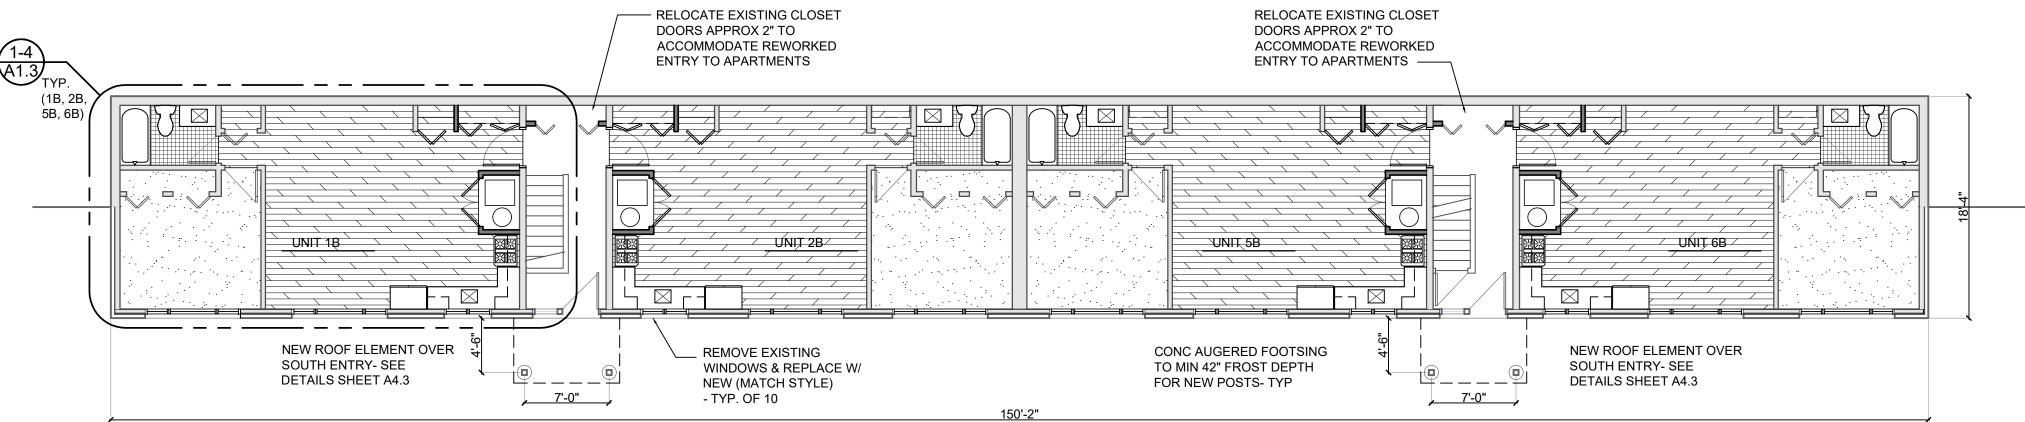
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No.	Date	Description
	12.04.23	Cost Est.
	4-12-24	PERMIT

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FACILITY/CLIENT

BROADWAY STREET

BROADW 506, 1509, 1

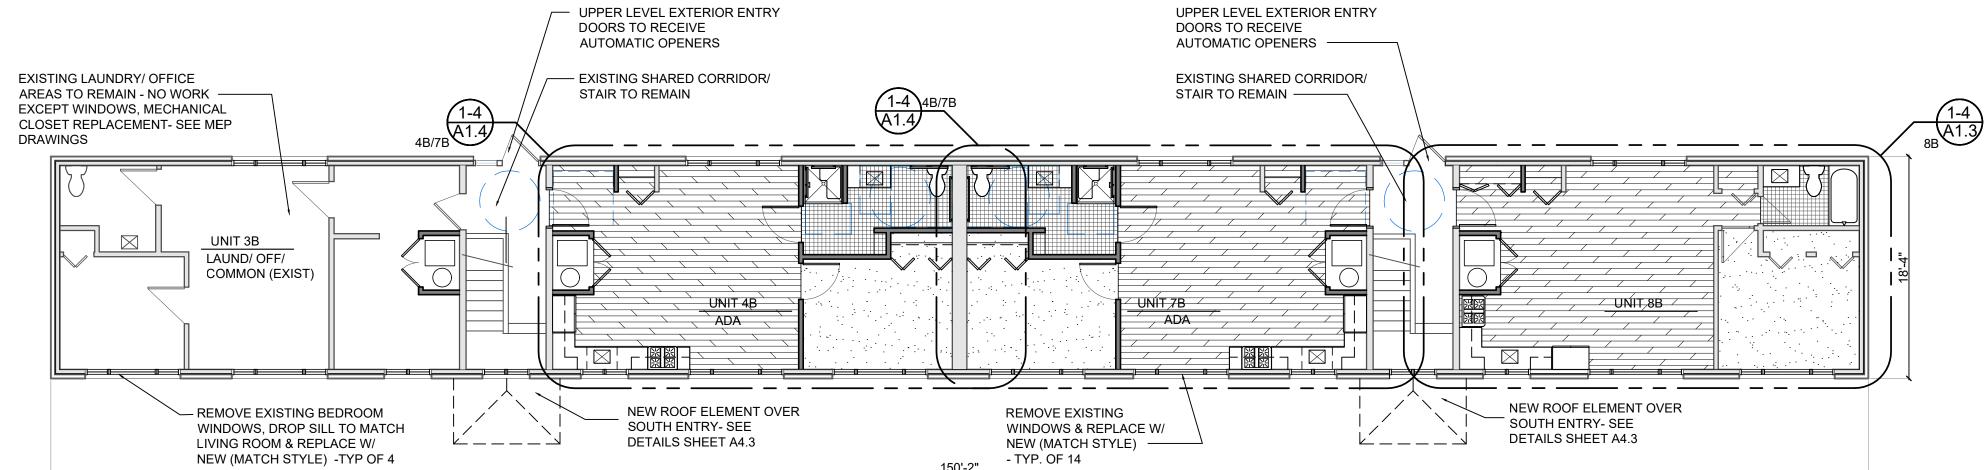SCOPE NOTES - UNIT 1506

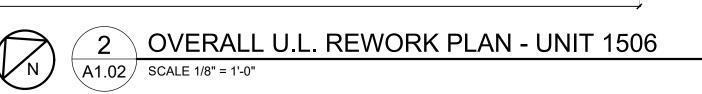NEW MECHANICALS, MECHANICAL CLOSETS RECONFIGURED, CHIMNEYS REMOVED, CHIMNEY OPENINGS AT FLOORS AND

ROOF TO BE FRAMED FLUSH W/ EXISTING FLOOR ROOF

NEW ROOFING - NEW SHINGLES, UNDERLAYMENT, ICE SHIELD, FLASHINGS ON EXIST. SHEATHING/ STRUCTURE. REPAIR AS NECESSARY. NEW FASCIA TRIM, GUTTERS &

NEW SOLAR SYSTEM INSTALLED ON ROOF - DESIGNED BY

KITCHEN CABINETRY, COUNTERS, FIXTURES, APPLIANCES REMOVED - NEW INSTALLED PER LAYOUTS. DIVIDER WALLS

BATHROOM FIXTURES, FINISHES REMOVED. NEW INSTALLED

NEW ADA UNITS (2) ON UPPER LEVEL - UTILITY WORK DUE TO

NEW LIGHT FIXTURES ON EXISTING ROUGH-INS. SOME NEW/

ALL NEW WINDOWS IN OPENINGS REWORKED FOR EGRESS

NEW INSULATION - BLOWN-IN (NOT REMOVING EXISTING

NEW ENTRY DOORS, FRAMES & SIDELITES IN STAIRWELLS

UPPER EXTERIOR ENTRY DOORS (2) TO RECEIVE AUTOMATIC

NEW FINISHES, SUBSTRATE. PATCH & REPAIR THROUGHOUT

NO WORK IN STAIRWELLS EXCEPT INCIDENTAL TO OTHER

WORK- PATCH & REPAIR ETC. DUE TO WINDOW/ DOOR

ALL NEW EXTERIOR WINDOWS IN EXISTING OPENINGS

DOWNSPOUTS, EXISTING SOFFITS TO REMAIN

BETWEEN KITCHEN AND LIVING AREA REMOVED

NEW ADA UNITS (2) ON UPPER LEVEL - BEDROOM/

REF. AND RANGE SWAPPED LOCATIONS

RELOCATED PER ENLARGED PLANS.

(LIVING AREA, KITCHEN, STAIRWELL)

COMPLIANCE (BEDROOMS)

(UPPER AND LOWER LEVELS)

APARTMENTS

REPLACEMENTS

APPLIANCES BY OWNER

WINDOW TREATMENTS BY OWNERS

BATHROOM WALLS DEMO'D, NEW WALL/ DOOR/ CLOSET CONFIGURATION - BATH FIXTURES RELOCATED, FLOOR

MANUFACTURER

PER PLANS



PROJECT

1504-1506-1508 REPLACEMENT WINDOWS 1504-1506 INTERIOR RENOVATIONS



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SONNTAG Design Group


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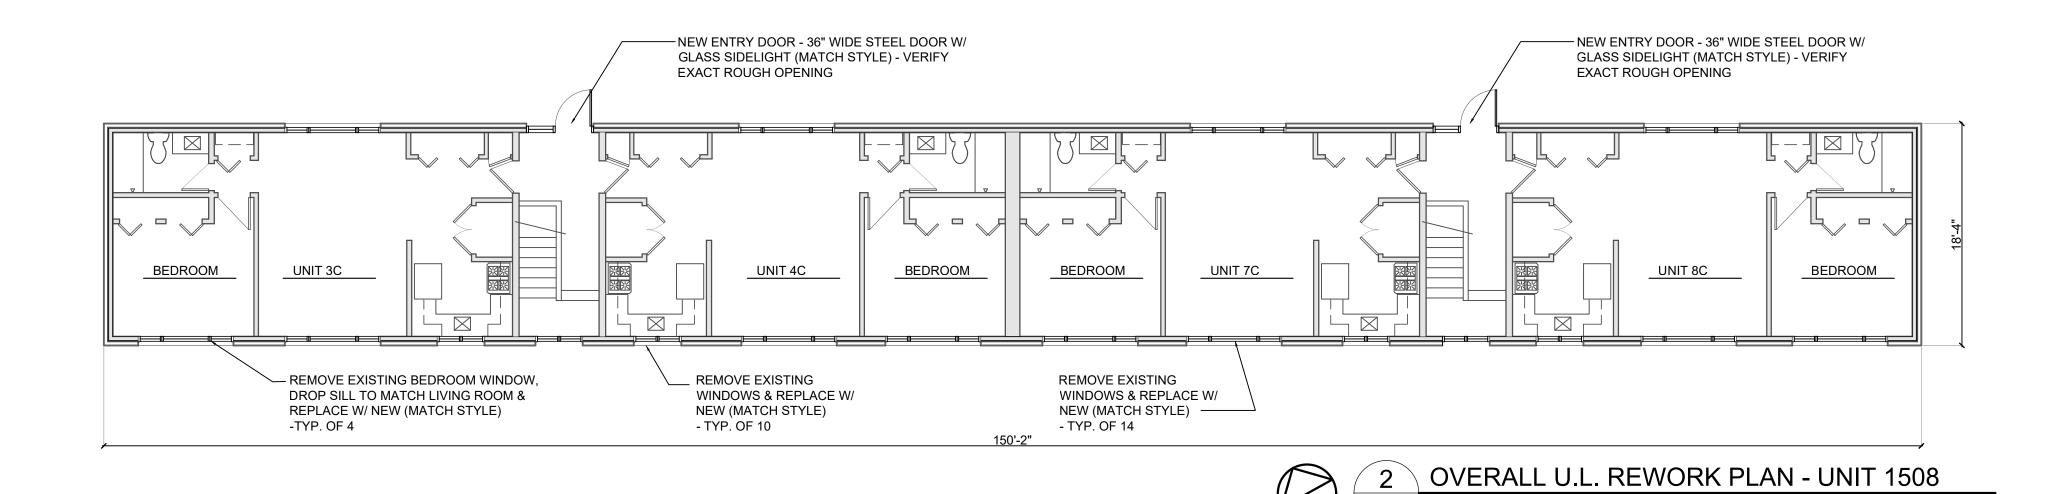
OVERALL REWORK/ ROOF


PLANS

UNIT 1506





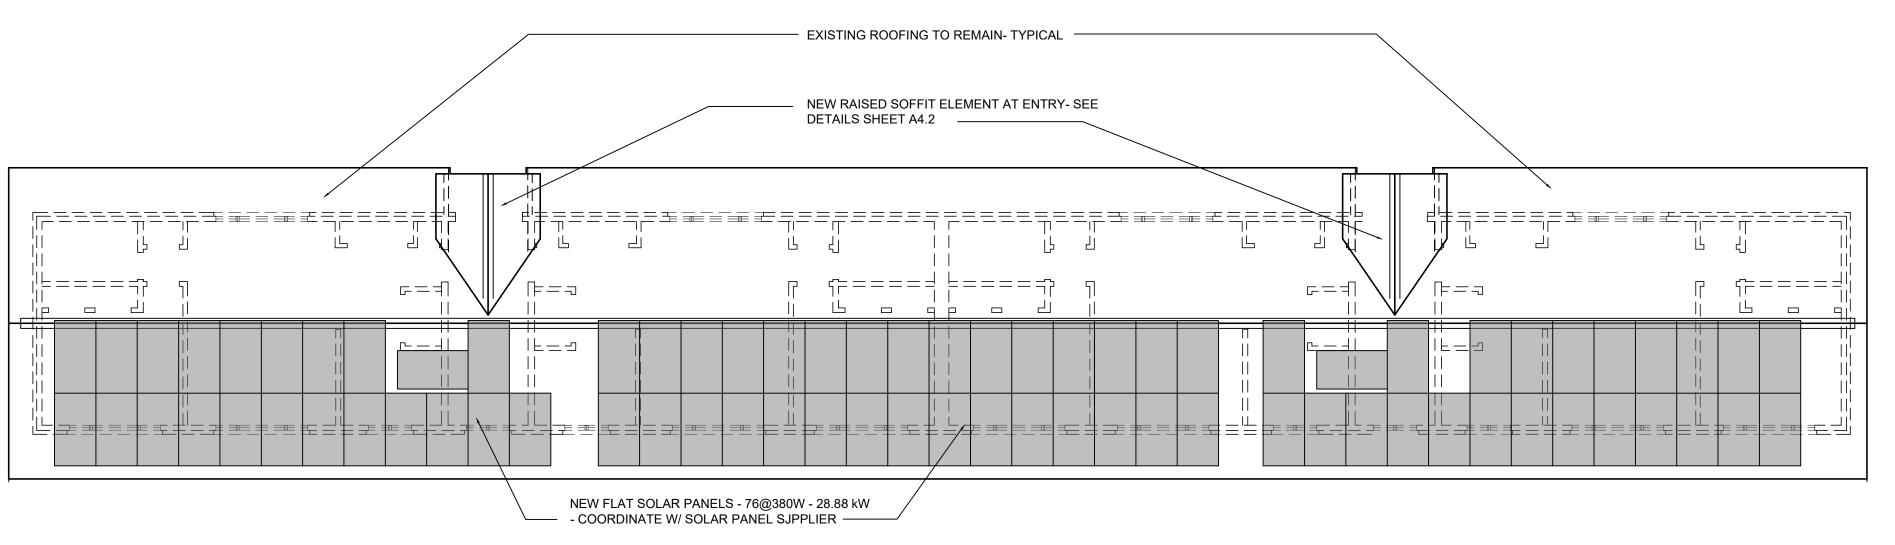

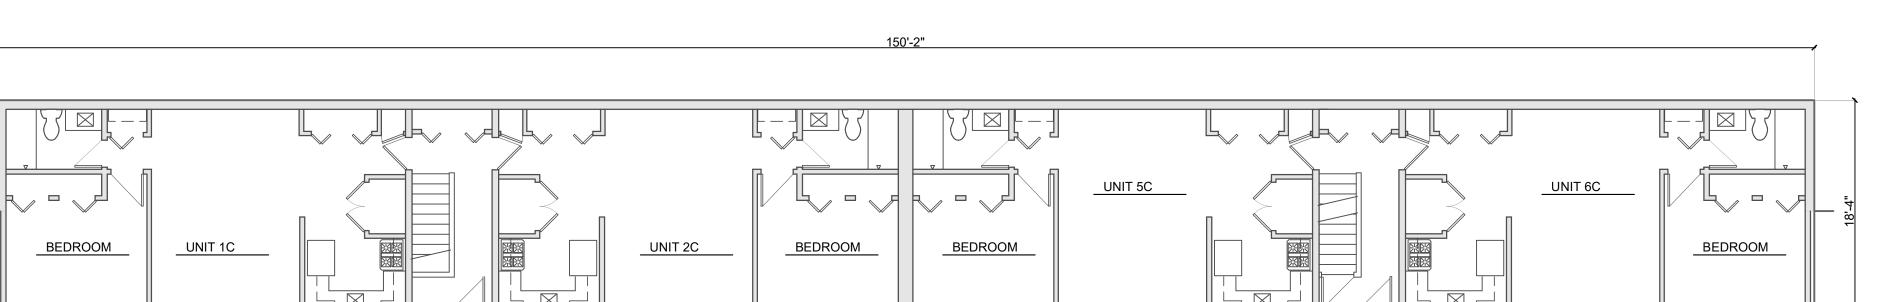

REMOVE EXISTING
BEDROOM WINDOW, DROP
SILL TO MATCH LIVING ROOM
& REPLACE W/ NEW (MATCH
STYLE)
-TYP. OF 4

OVERALL L.L. REWORK PLAN - UNIT 1508

SCALE 1/8" = 1'-0"

No. Date Description

12.04.23 Cost Est.

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TREET

BROADWAY TERRACE 1504-1506- 1508 BROADWAY STREE ANN ARBOR, MI 48105

SCOPE NOTES - UNIT 1508

(LIVING AREA, KITCHEN, STAIRWELL)

(UPPER LEVEL ONLY)

ALL NEW EXTERIOR WINDOWS IN EXISTING OPENINGS

ALL NEW WINDOWS IN OPENINGS REWORKED FOR EGRESS

NEW ENTRY DOORS, FRAMES & SIDELITES IN STAIRWELLS

PATCH & REPAIR AS REQ'D DUE TO WINDOW/ DOOR REPLACEMENT



PROJECT

1504-1506-1508 REPLACEMENT WINDOWS 1504-1506 INTERIOR RENOVATIONS



106 S. MAIN STREET ANN ARBOR, MI 48104 TEL. 734.998.0098 FAX 734.996.8899

SONNTAG
DESIGN
GROUP

architecture - plc 106 S. MAIN STREET ANN ARBOR, MI 48104 TEL 734.604.8833 DASONNTAG@GMAIL.COM


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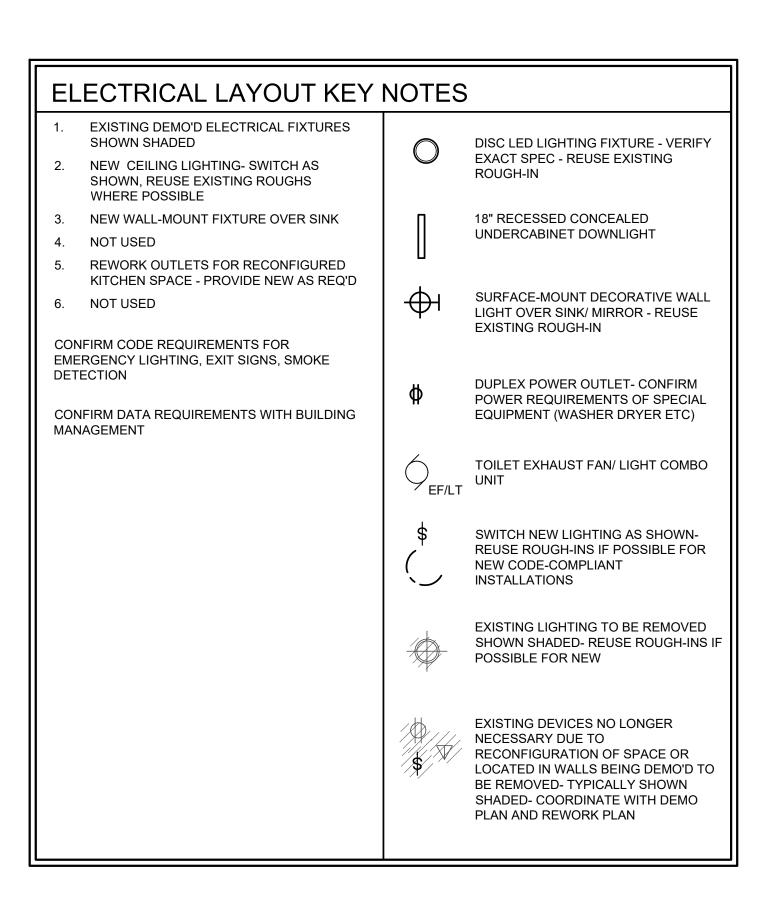
OVERALL REWORK/ ROOF


PLANS

UNIT 1508


SHEET NO.
A1.03



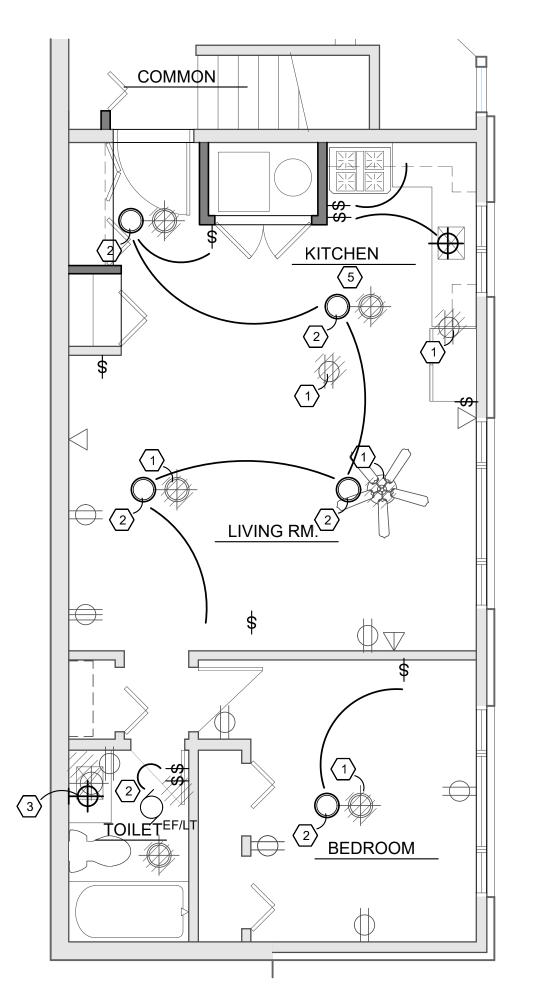

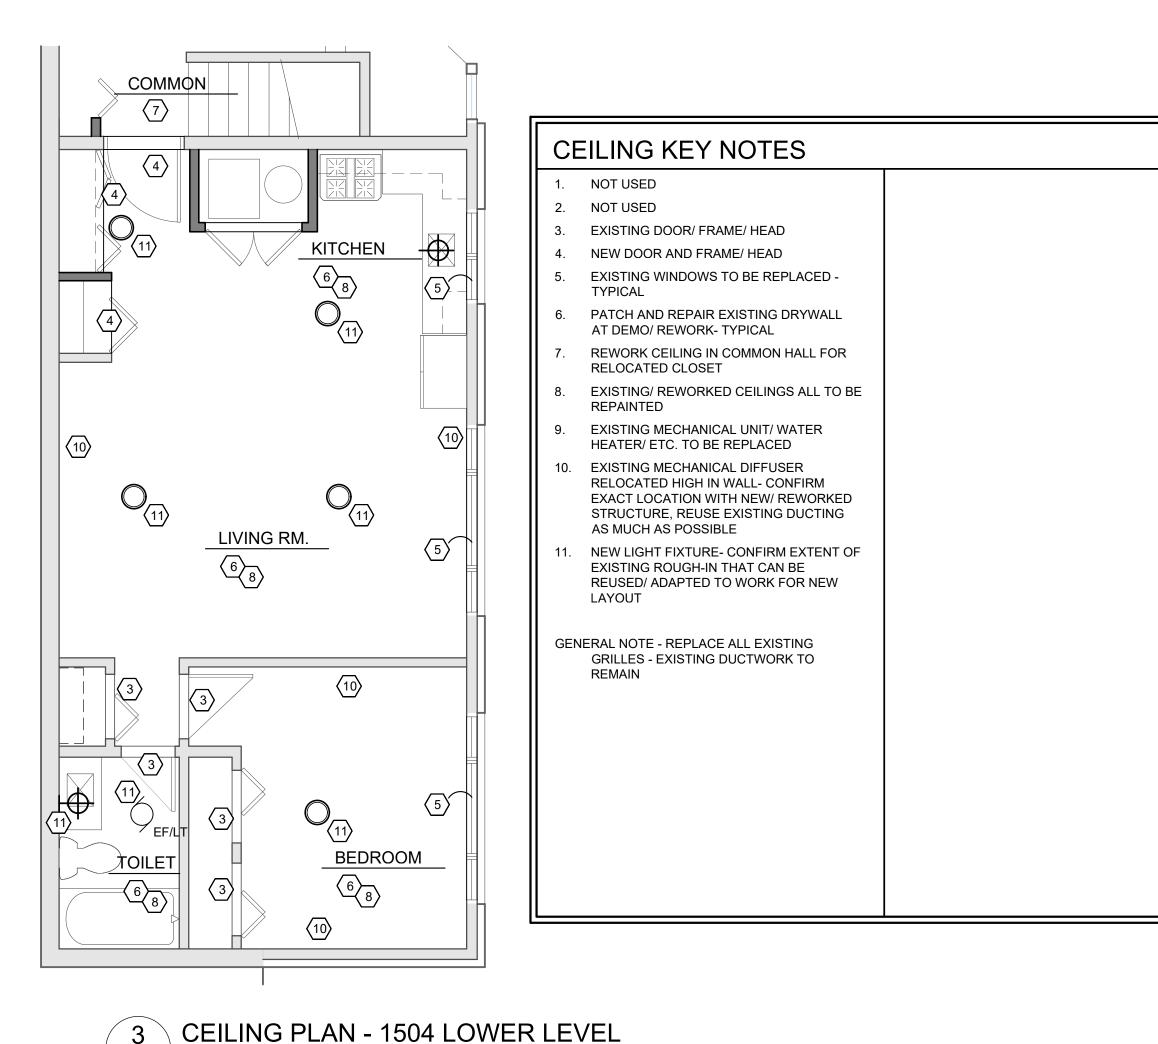

4 LIGHTING/ ELECTRICAL PLAN - 1504 LOWER LEVEL
A1.1 SCALE 1/4" = 1'-0"

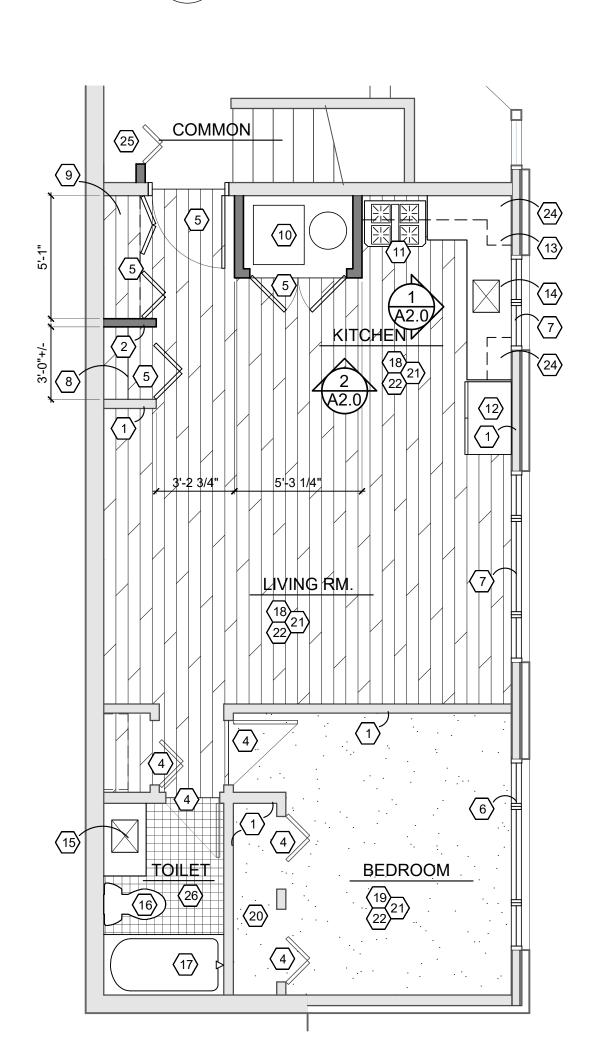

REWORK KEY NOTES 21. NEW RUBBER COVE BASE THROUGHOUT EXISTING WALL TO REMAIN SPACE EXCEPT TOILET NEW WALL CONSTRUCTION- DRYWALL BOTH SIDES 2X4 FRAMING, PAINTED 22. REPAINT THROUGHOUT SPACE NOT USED NOT USED 24. CABINET ABOVE 4. EXISTING DOOR/ FRAME TO REMAIN NEW 36" WIDE DOOR AND FRAME IN 25. RELOCATED CLOSET DOORS REWORKED OPENING- MATCH STYLE OF 26. NEW 2X2 CERAMIC TILE WITH 4" TILE BASE, EXISTING- CONFIRM LOCKING/ ACCESS SHEET WATERPROOFING ON SUBSTRATE WITH OWNER BENEATH NEW WINDOW IN RESIZED OPENING - STYLE TO MATCH EXISTING GENERAL NOTE - PROVIDE ADA-COMPLIANT NEW WINDOW IN EXISTING OPENING -TRANSITION STRIPS BETWEEN DIFFERING STYLE TO MATCH EXISTING FLOORING MATERIALS- BOTH NEW-TO-NEW CURTAIN ROD & SHELF IN NEW CLOSET AND NEW-TO-EXISTING NEW 18" DP. SHELVING- CONFIRM EXACT STYLE, LAYOUTS WITH TENANT GENERAL NOTE: ALL APPLIANCES BY OWNER 10. NEW MECHANICAL UNIT/ FLUE/ DUCTWORK/ WATER HEATER GENERAL NOTE: ALL WINDOW TREATMENTS BY 11. NEW RANGE/ STOVE IN EXISTING ROUGH-IN-OWNER UNDERCABINET MICROWAVE ABOVE 12. NEW REFRIGERATOR IN REWORKED 13. NEW CABINETRY & COUNTERTOP - VERIFY MATERIALS 14. NEW SINK IN REWORKED EXISTING ROUGH-IN 15. NEW SINK IN NEW C'TOP & CABINETRY 16. NEW FLOOR-MOUNT TOILET ON NEW ROUGH-INS- PATCH + REPAIR CEILING 17. NEW BATH - REWORK EXISTING ROUGH-IN AS REQ'D 18. NEW FLOORING - 20mil LVT GLUE-DOWN-PREP FLOOR APPROPRIATELY- CONFIRM COLOR WITH OWNER 19. NEW FLOORING TYPICAL THROUGHOUT-24X24 CARPET SQUARES- CONFIRM COLOR WITH OWNER 20. EXISTING CLOSET TO REMAIN

GHOUT

ILE BASE, STRATE

IANT FFERING W-TO-NEW

DWNER
ENTS BY

9

(10)

A1.1 SCALE 1/4" = 1'-0"

COMMON **DEMO KEY NOTES** 21. NOT USED EXISTING WALL TO REMAIN 22. EXISTING LIGHT FIXTURES TO BE PORTION OF WALL CONSTRUCTION TO BE REMOVED- CONFIRM EXTENT OF REMOVAL REMOVED SHOWN DASHED OF ABANDONED WIRING/ BOXES ETC AND EXISTING CABINETRY+ COUNTERTOP TO WHAT CAN BE REUSED FOR NEW IN BE REMOVED SIMILAR LOCATIONS 4. EXISTING DOOR/ FRAME TO REMAIN 23. EXISTING POWER/ CABLE/ DATA IN WALLS EXISTING DOOR+ FRAME TO BE REMOVED TO BE REMOVED- CONFIRM EXTENT OF KITCHEN WHAT CAN BE SALVAGED EXISTING WINDOW TO BE REMOVED -DROP ROUGH SILL FOR ADA-COMPLIANT 24. NOT USED NEW WINDOWS- ALIGN WITH LIVING ROOM ADJACENT - TYP. @ BEDROOM WINDOWS **EXISTING WINDOW TO BE REMOVED -**REPAIR/REWORK EXISTING HEADER/ POSTS FOR NEW WINDOW EXISTING SHELVING TO BE REMOVED EXISTING SINK TO BE REMOVED- CAP UTILITIES BACK FOR PLAN REWORK 10. EXISTING BATH/ SHOWER TO BE REMOVED- REMOVE ALL WALL AND FLOOR 11. EXISTING TOILET, ROUGH-IN, DRAIN TO BE LIVING RM. REMOVED 12. NOT USED 13. REMOVE EXISTING FLOORING, ADHESIVE, PREP FOR NEW 14. REMOVE EXISTING WOOD WALL BASE, REPAIR/ PREP FOR NEW 4" VINYL 15. REMOVE EXISTING TILE FLOOR 16. EXISTING DRYWALL CEILING TYPICALLY TO REMAIN THROUGHOUT - REWORK W/ DEMO AS REQ'D 17. EXISTING KITCHEN CABINETRY TO BE REMOVED 18. EXISTING STOVE TO BE REMOVED-REMOVED ROUGH-IN, CAP BACK 19. EXISTING SINK, DISHWASHER TO BE REMOVED- REMOVE ROUGH-INS, CAP **BEDROOM**

20. EXISTING MECHANICAL ROOM, FURNACE, FLUE, WATER HEATER TO BE REMOVED

1504-1

No. Date

DRAWN BY

FACILITY/CLIENT

12.04.23

4-12-24

Description

Cost Est.

PERMIT

DAS/ARG

ROOM OF DARCHITE

ARCHITECT

PROJECT

1504-1506-1508 REPLACEMENT WINDOWS 1504-1506 INTERIOR RENOVATIONS



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GROUP

architecture - plc
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ANN ARBOR, MI 48104

SHEET TITLE

DEMO/ REWORK/ CEILING/
ELECTRICAL PLANS

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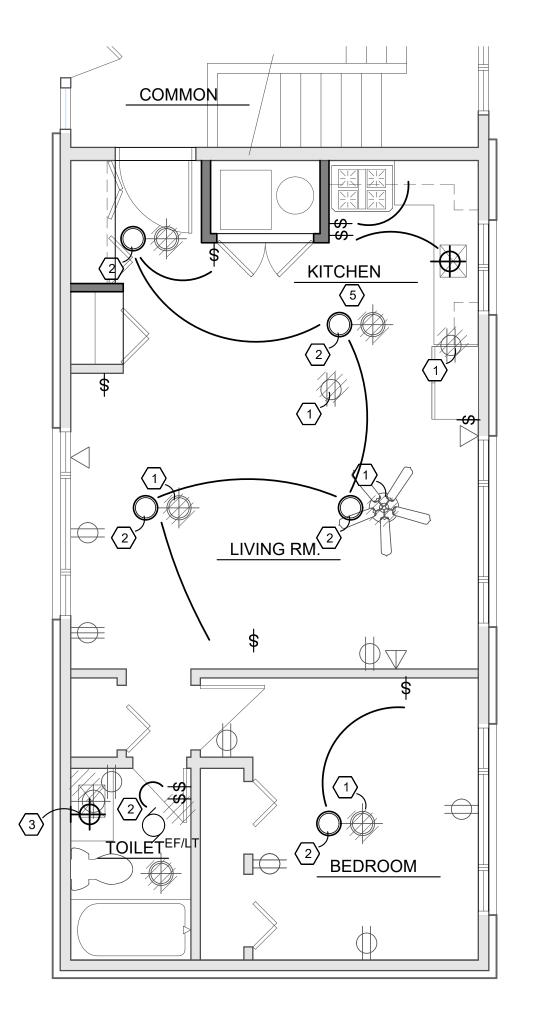
SHEET NO.


UNIT 1504 LOWER LEVEL


2 REWORK FLOOR PLAN - 1504 LOWER LEVEL

A1.1 SCALE 1/4" = 1'-0"


1 DEMOLITION PLAN - 1504 LOWER LEVEL
A1.1 SCALE 1/4" = 1'-0"



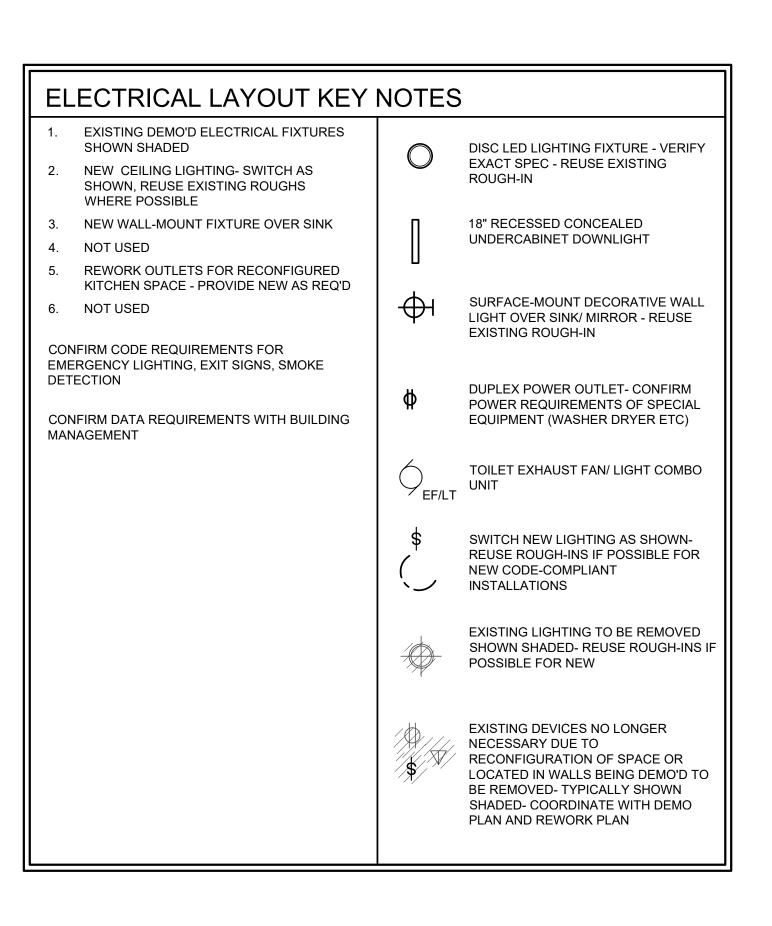


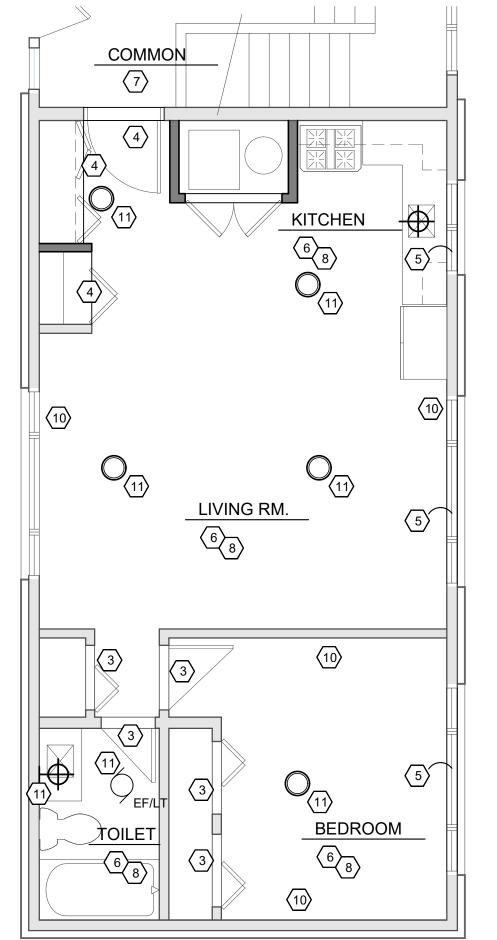

A1.2 SCALE 1/4" = 1'-0"

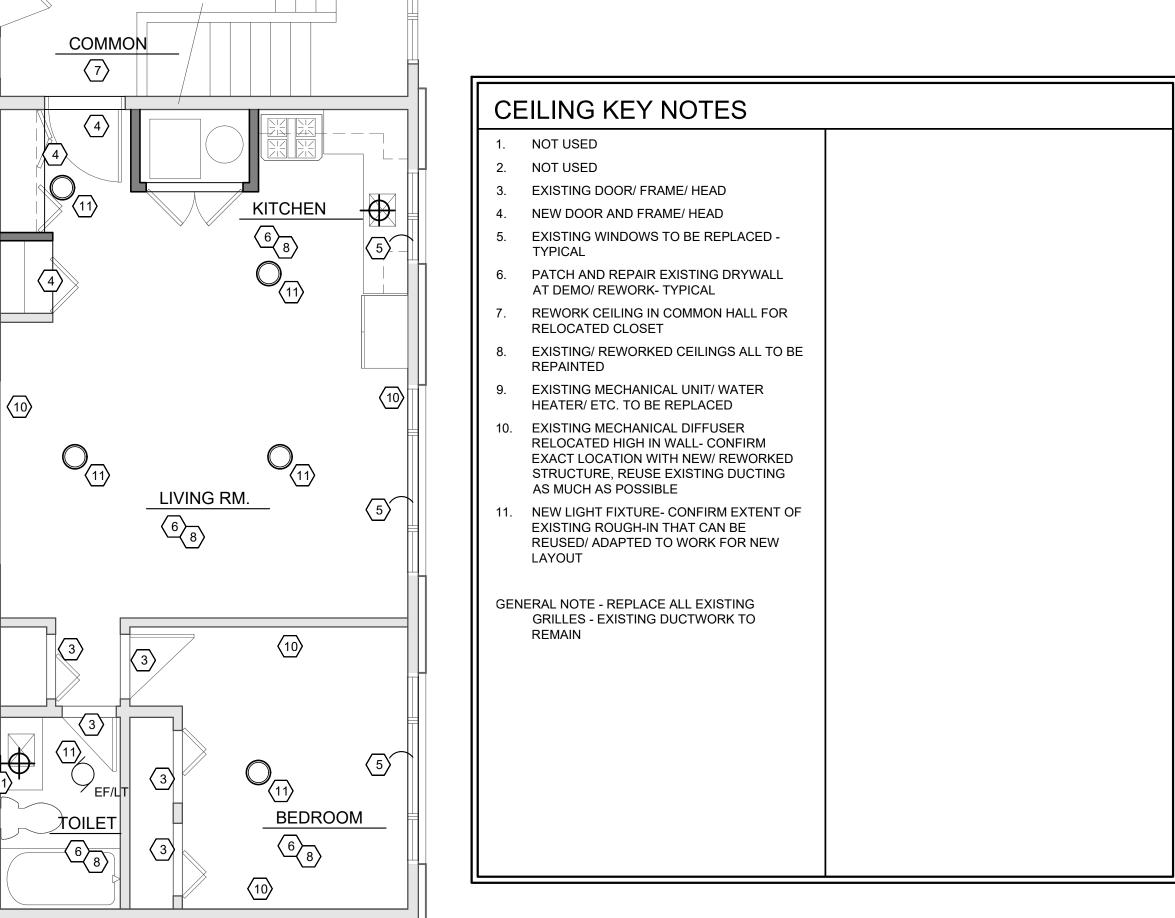

LIGHTING/ ELECTRICAL PLAN - 1504 UPPER LEVEL A1.2 SCALE 1/4" = 1'-0"

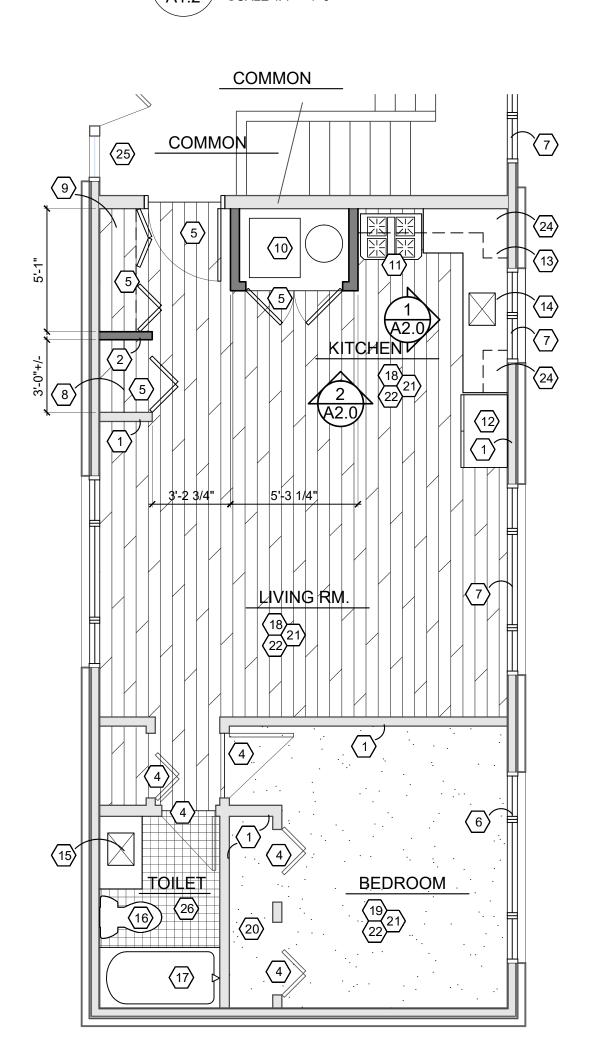


1.	EXISTING WALL TO REMAIN	21.	NEW RUBBER COVE BASE THROUGHOUT			
2.	NEW WALL CONSTRUCTION- DRYWALL	00	SPACE EXCEPT TOILET			
0	BOTH SIDES 2X4 FRAMING, PAINTED	22.	REPAINT THROUGHOUT SPACE			
3.	NOT USED	23.	NOT USED			
4.	EXISTING DOOR/ FRAME TO REMAIN	24.				
5.	NEW 36" WIDE DOOR AND FRAME IN REWORKED OPENING- MATCH STYLE OF EXISTING- CONFIRM LOCKING/ ACCESS WITH OWNER		RELOCATED CLOSET DOORS NEW 2X2 CERAMIC TILE WITH 4" TILE BASE, SHEET WATERPROOFING ON SUBSTRATE BENEATH			
6.	NEW WINDOW IN RESIZED OPENING - STYLE TO MATCH EXISTING		BENEATT			
7.	NEW WINDOW IN EXISTING OPENING - STYLE TO MATCH EXISTING	GEN	ERAL NOTE - PROVIDE ADA-COMPLIANT TRANSITION STRIPS BETWEEN DIFFERING FLOORING MATERIALS- BOTH NEW-TO-NEW			
8.	CURTAIN ROD & SHELF IN NEW CLOSET	AND NEW-TO-EXISTING				
9.	NEW 18" DP. SHELVING- CONFIRM EXACT STYLE, LAYOUTS WITH TENANT	GEN	ERAL NOTE: ALL APPLIANCES BY OWNER			
10.	NEW MECHANICAL UNIT/ FLUE/ DUCTWORK/ WATER HEATER					
11.	NEW RANGE/ STOVE IN EXISTING ROUGH-IN- UNDERCABINET MICROWAVE ABOVE	GEN	ERAL NOTE: ALL WINDOW TREATMENTS BY OWNER			
12.	NEW REFRIGERATOR IN REWORKED LOCATION					
13.	NEW CABINETRY & COUNTERTOP - VERIFY MATERIALS					
14.	NEW SINK IN REWORKED EXISTING ROUGH-IN					
15.	NEW SINK IN NEW C'TOP & CABINETRY					
16.	NEW FLOOR-MOUNT TOILET ON NEW ROUGH-INS- PATCH + REPAIR CEILING BELOW					
17.	NEW BATH - REWORK EXISTING ROUGH-IN AS REQ'D					
18.	NEW FLOORING - 20mil LVT GLUE-DOWN- PREP FLOOR APPROPRIATELY- CONFIRM COLOR WITH OWNER					
19.	NEW FLOORING TYPICAL THROUGHOUT- 24X24 CARPET SQUARES- CONFIRM COLOR WITH OWNER					
20.	EXISTING CLOSET TO REMAIN					

LIVING RM. 6 **BEDROOM**

(10)

DEMO KEY NOTES 21. NOT USED EXISTING WALL TO REMAIN PORTION OF WALL CONSTRUCTION TO BE 22. EXISTING LIGHT FIXTURES TO BE REMOVED- CONFIRM EXTENT OF REMOVAL REMOVED SHOWN DASHED OF ABANDONED WIRING/ BOXES ETC AND EXISTING CABINETRY+ COUNTERTOP TO WHAT CAN BE REUSED FOR NEW IN BE REMOVED SIMILAR LOCATIONS EXISTING DOOR/ FRAME TO REMAIN 23. EXISTING POWER/ CABLE/ DATA IN WALLS TO BE REMOVED- CONFIRM EXTENT OF EXISTING DOOR+ FRAME TO BE REMOVED WHAT CAN BE SALVAGED EXISTING WINDOW TO BE REMOVED -DROP ROUGH SILL FOR ADA-COMPLIANT 24. NOT USED NEW WINDOWS- ALIGN WITH LIVING ROOM ADJACENT - TYP. @ BEDROOM WINDOWS EXISTING WINDOW TO BE REMOVED -REPAIR/REWORK EXISTING HEADER/ POSTS FOR NEW WINDOW EXISTING SHELVING TO BE REMOVED EXISTING SINK TO BE REMOVED- CAP UTILITIES BACK FOR PLAN REWORK 10. EXISTING BATH/ SHOWER TO BE REMOVED- REMOVE ALL WALL AND FLOOR 11. EXISTING TOILET, ROUGH-IN, DRAIN TO BE REMOVED 12. NOT USED 13. REMOVE EXISTING FLOORING, ADHESIVE, PREP FOR NEW 14. REMOVE EXISTING WOOD WALL BASE, REPAIR/ PREP FOR NEW 4" VINYL 15. REMOVE EXISTING TILE FLOOR 16. EXISTING DRYWALL CEILING TYPICALLY TO REMAIN THROUGHOUT - REWORK W/ DEMO AS REQ'D 17. EXISTING KITCHEN CABINETRY TO BE REMOVED 18. EXISTING STOVE TO BE REMOVED-REMOVED ROUGH-IN, CAP BACK 19. EXISTING SINK, DISHWASHER TO BE REMOVED- REMOVE ROUGH-INS, CAP 20. EXISTING MECHANICAL ROOM, FURNACE, FLUE, WATER HEATER TO BE REMOVED

CEILING PLAN - 1504 UPPER LEVEL

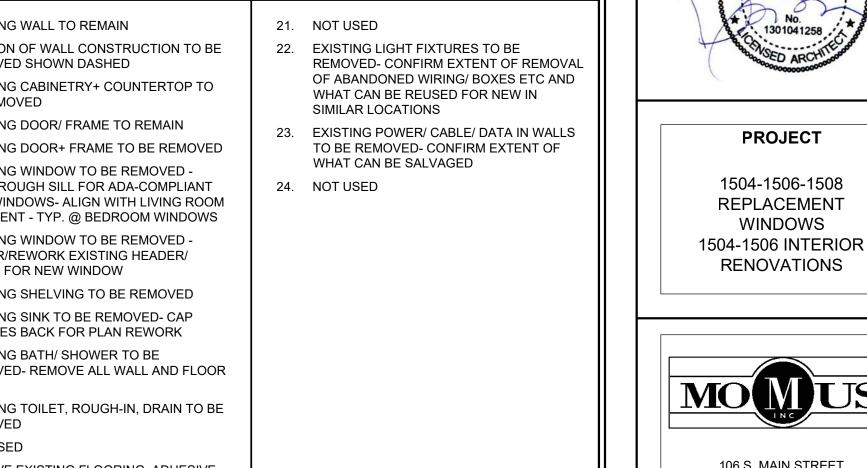

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ARCHITECT

PROJECT

1504-1506-1508

REPLACEMENT

WINDOWS

RENOVATIONS

No. Date

DRAWN BY

FACILITY/CLIENT

12.04.23

4-12-24

Description

Cost Est.

PERMIT


DAS/ARG


SHEET TITLE DEMO/ REWORK/ CEILING/ ELECTRICAL PLANS UNIT 1504 UPPER LEVEL

TEL 734.604.8833 DASONNTAG@GMAIL.COM

SHEET NO. A1.2

DEMOLITION PLAN - 1504 UPPER LEVEL A1.2 SCALE 1/4" = 1'-0"

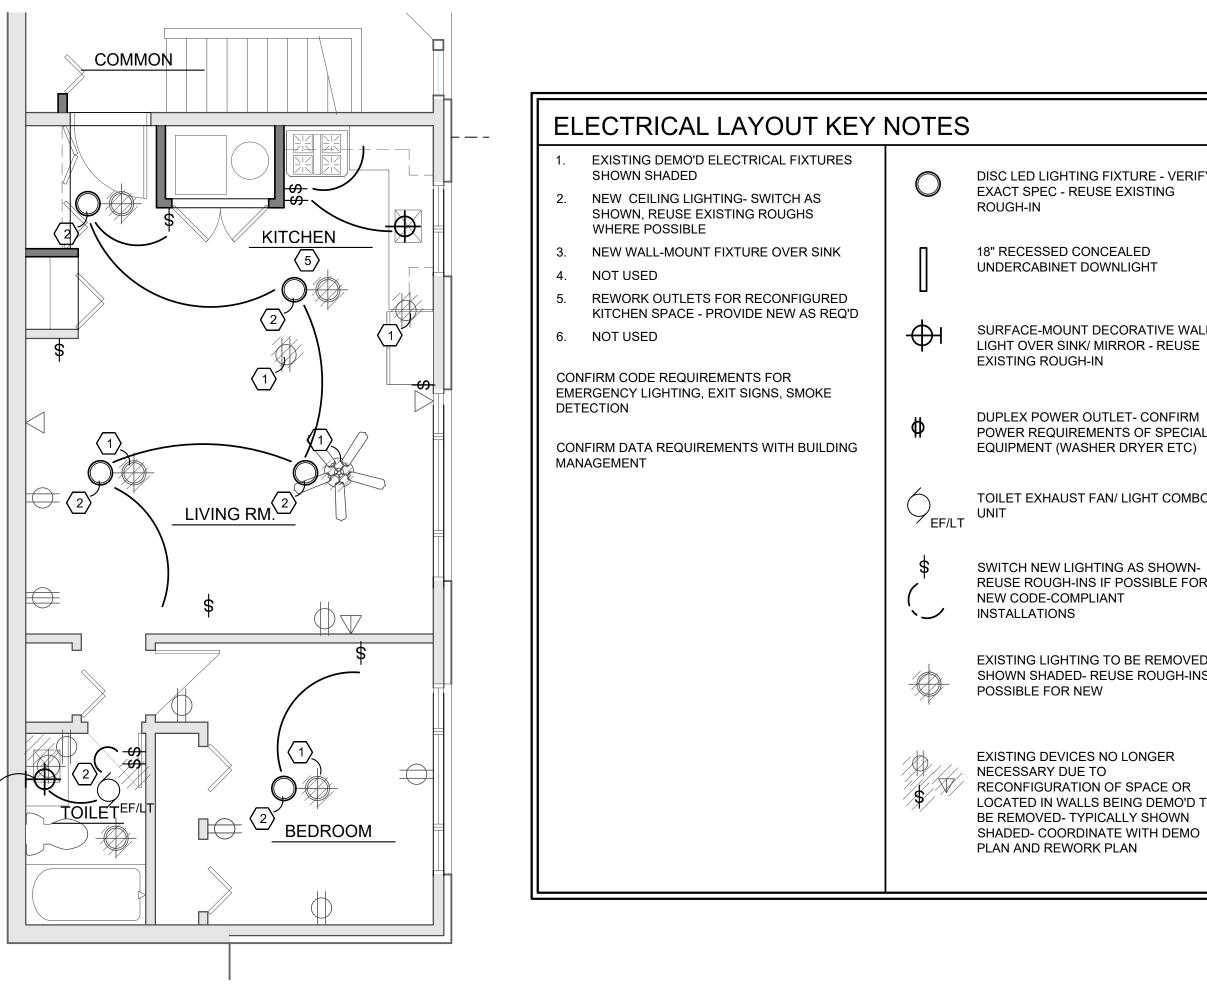

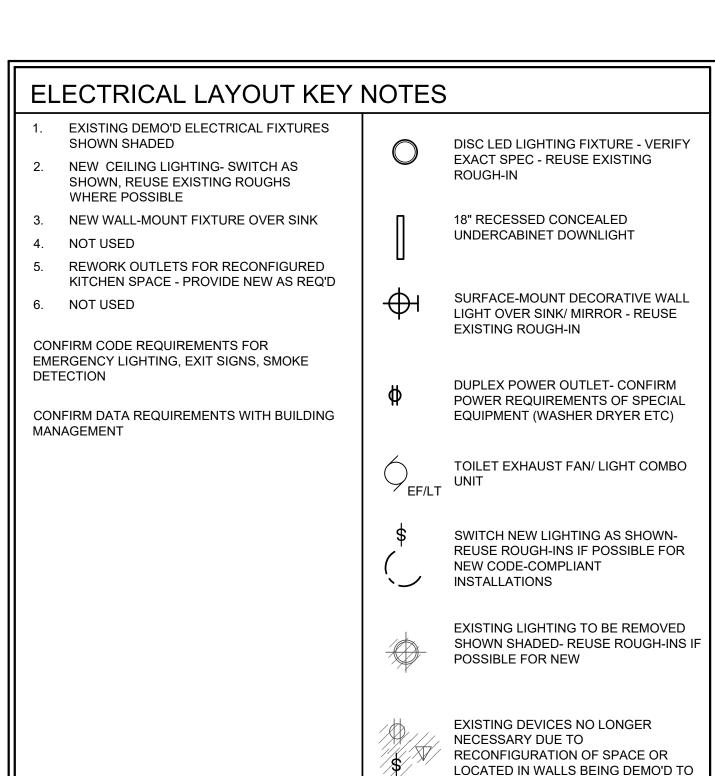


CEILING KEY NOTES 1. NOT USED NOT USED 3. EXISTING DOOR/ FRAME/ HEAD KITCHEN 4. NEW DOOR AND FRAME/ HEAD 68 5. EXISTING WINDOWS TO BE REPLACED -PATCH AND REPAIR EXISTING DRYWALL AT DEMO/ REWORK- TYPICAL REWORK CEILING IN COMMON HALL FOR RELOCATED CLOSET EXISTING/ REWORKED CEILINGS ALL TO BE EXISTING MECHANICAL UNIT/ WATER HEATER/ ETC. TO BE REPLACED 10. EXISTING MECHANICAL DIFFUSER RELOCATED HIGH IN WALL- CONFIRM **EXACT LOCATION WITH NEW/ REWORKED** STRUCTURE, REUSE EXISTING DUCTING AS MUCH AS POSSIBLE LIVING RM. 11. NEW LIGHT FIXTURE- CONFIRM EXTENT OF EXISTING ROUGH-IN THAT CAN BE REUSED/ ADAPTED TO WORK FOR NEW LAYOUT GENERAL NOTE - REPLACE ALL EXISTING GRILLES - EXISTING DUCTWORK TO **(5)** BEDROOM 才OILET 6 8

LIGHTING/ ELECTRICAL PLAN - 1506 LOWER LEVEL A1.3 SCALE 1/4" = 1'-0"


2 REWORK FLOOR PLAN - 1506 LOWER LEVEL


A1.3 SCALE 1/4" = 1'-0"

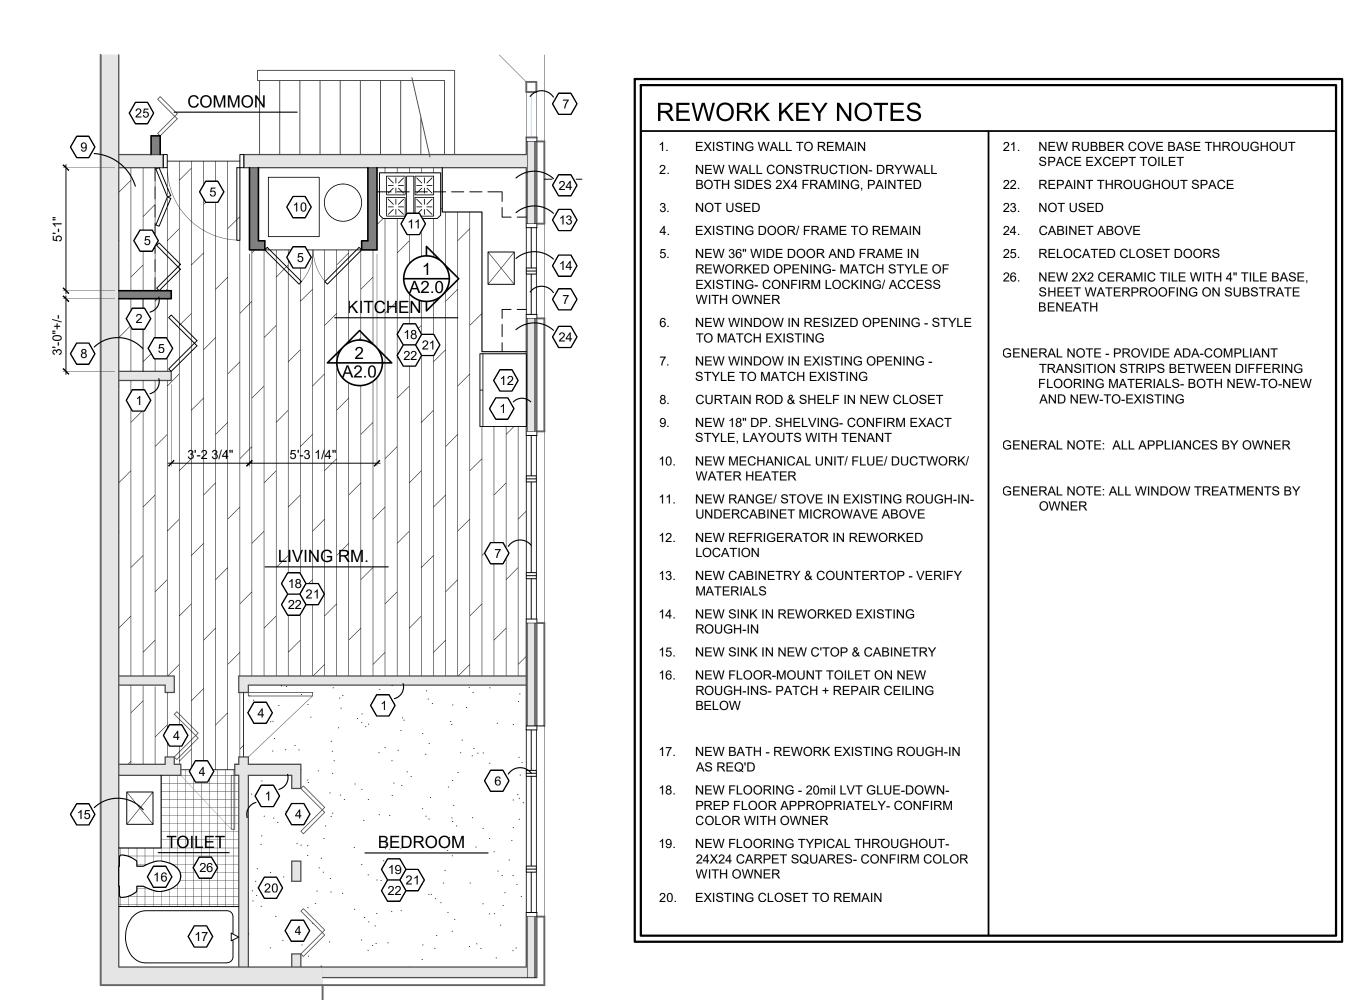

CEILING PLAN - 1506 LOWER LEVEL A1.3 SCALE 1/4" = 1'-0"

COMMON

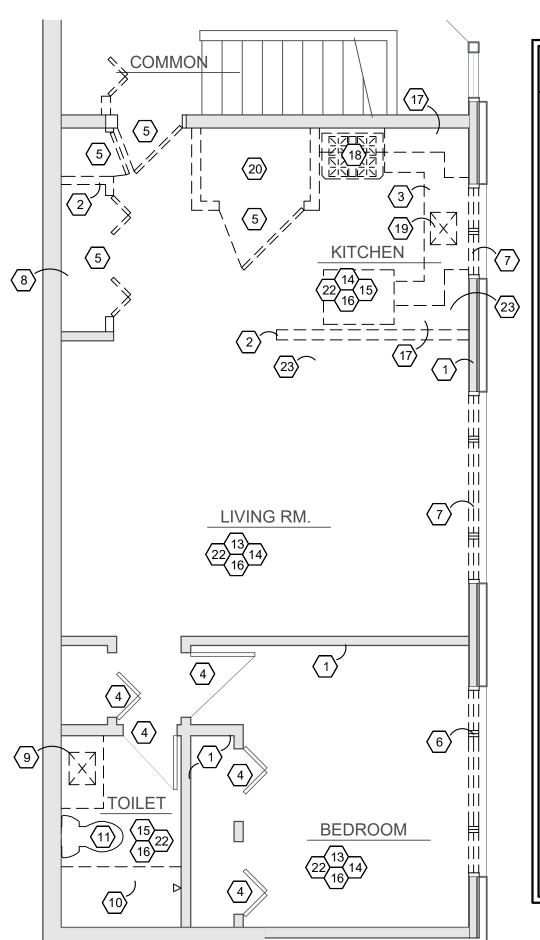

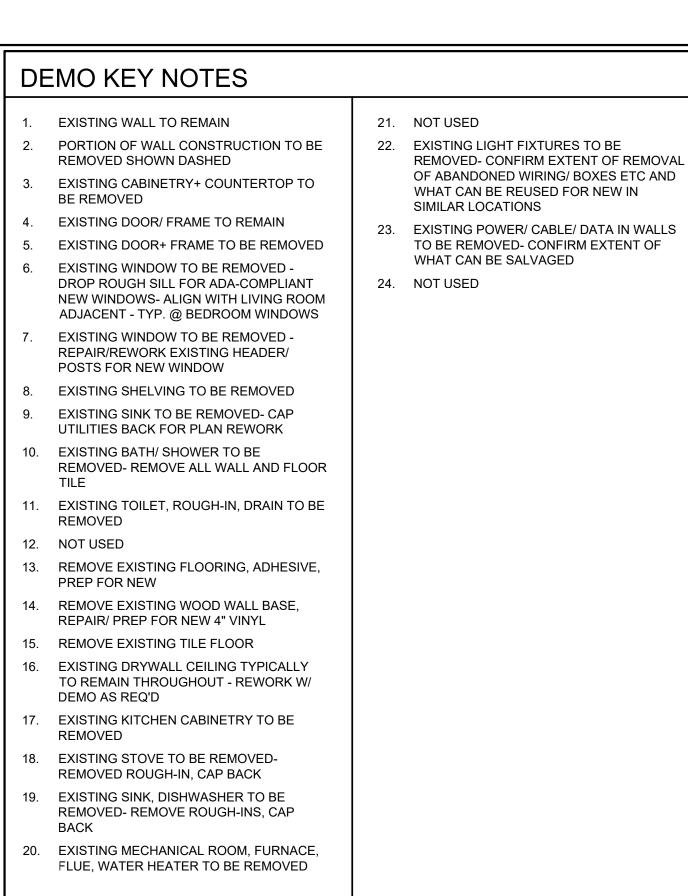

No. Date Description 12.04.23 Cost Est. 4-12-24 PERMIT DAS/ARG DRAWN BY FACILITY/CLIENT



PROJECT

1504-1506-1508 REPLACEMENT WINDOWS 1504-1506 INTERIOR RENOVATIONS



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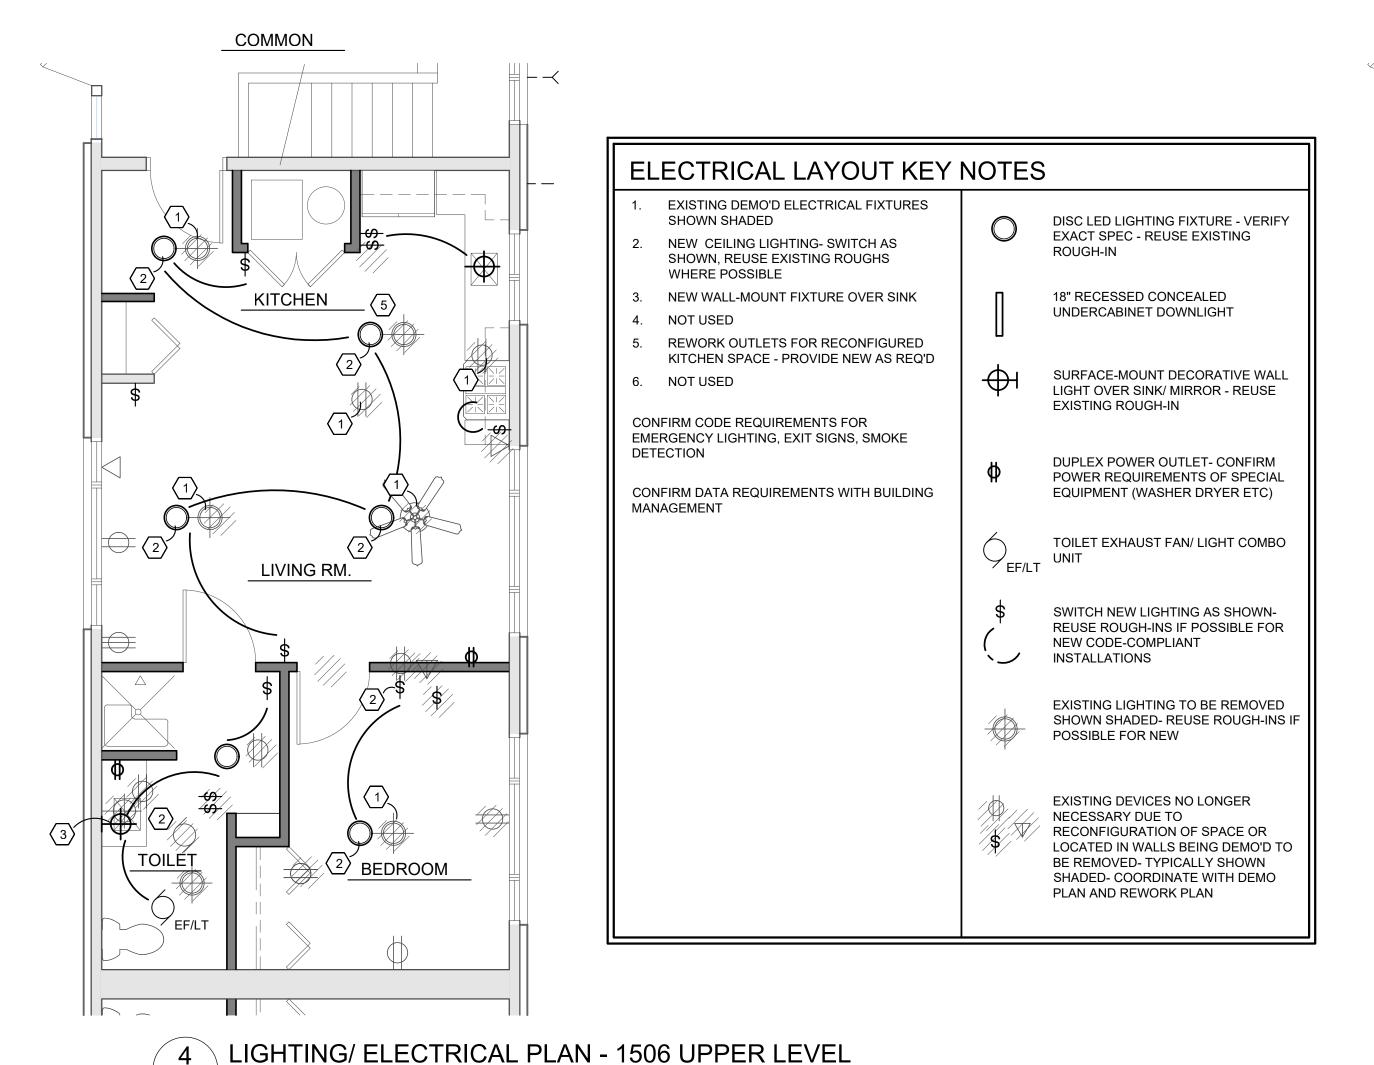
SONNTAG DESIGN GROUP architecture - plc


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SHEET TITLE DEMO/ REWORK/ CEILING/ ELECTRICAL PLANS **UNIT 1506 LOWER LEVEL**

> SHEET NO. A1.3


DEMOLITION PLAN - 1506 LOWER LEVEL \land A1.3 / SCALE 1/4" = 1'-0"



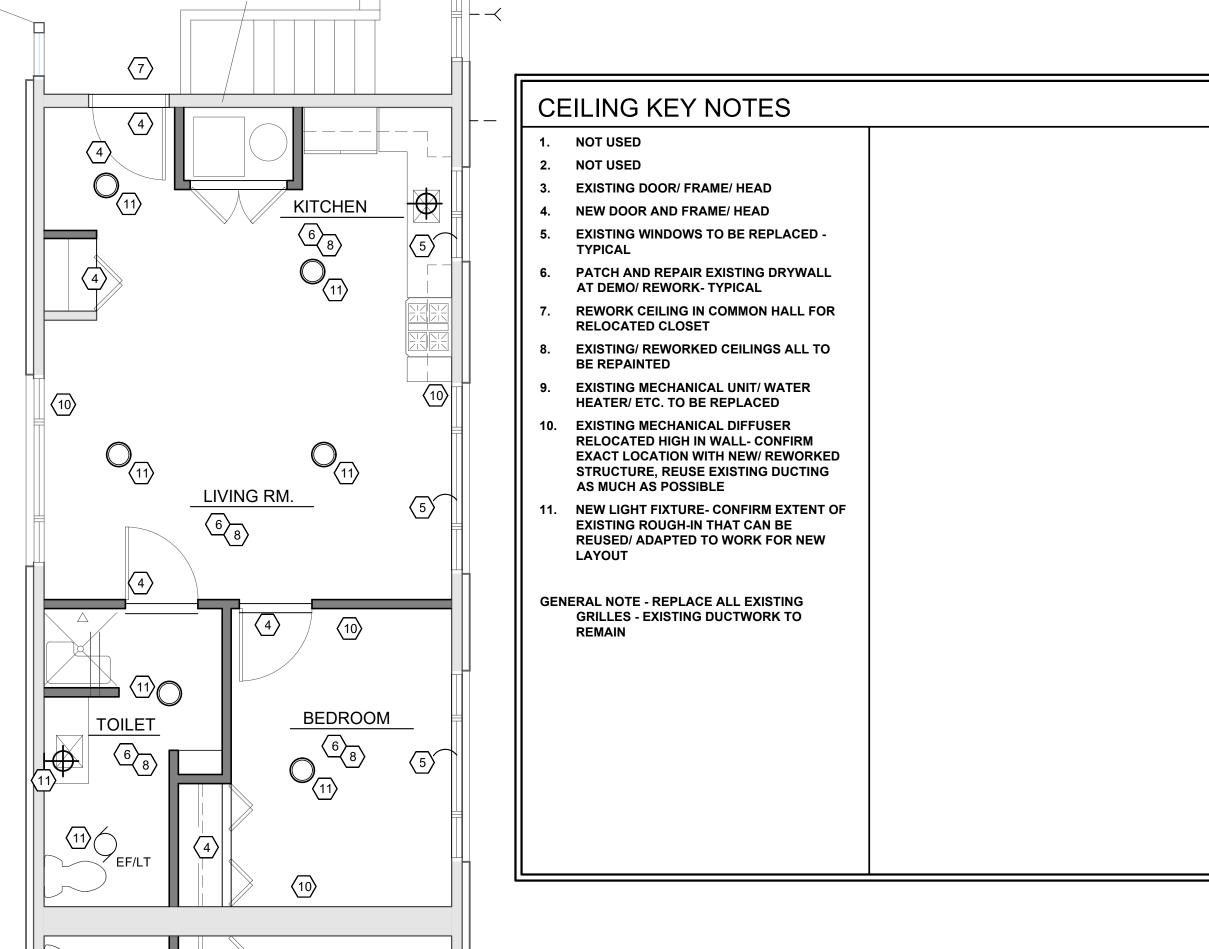



CEILING PLAN - 1506 UPPER LEVEL **A1.4** / SCALE 1/4" = 1'-0"

COMMON

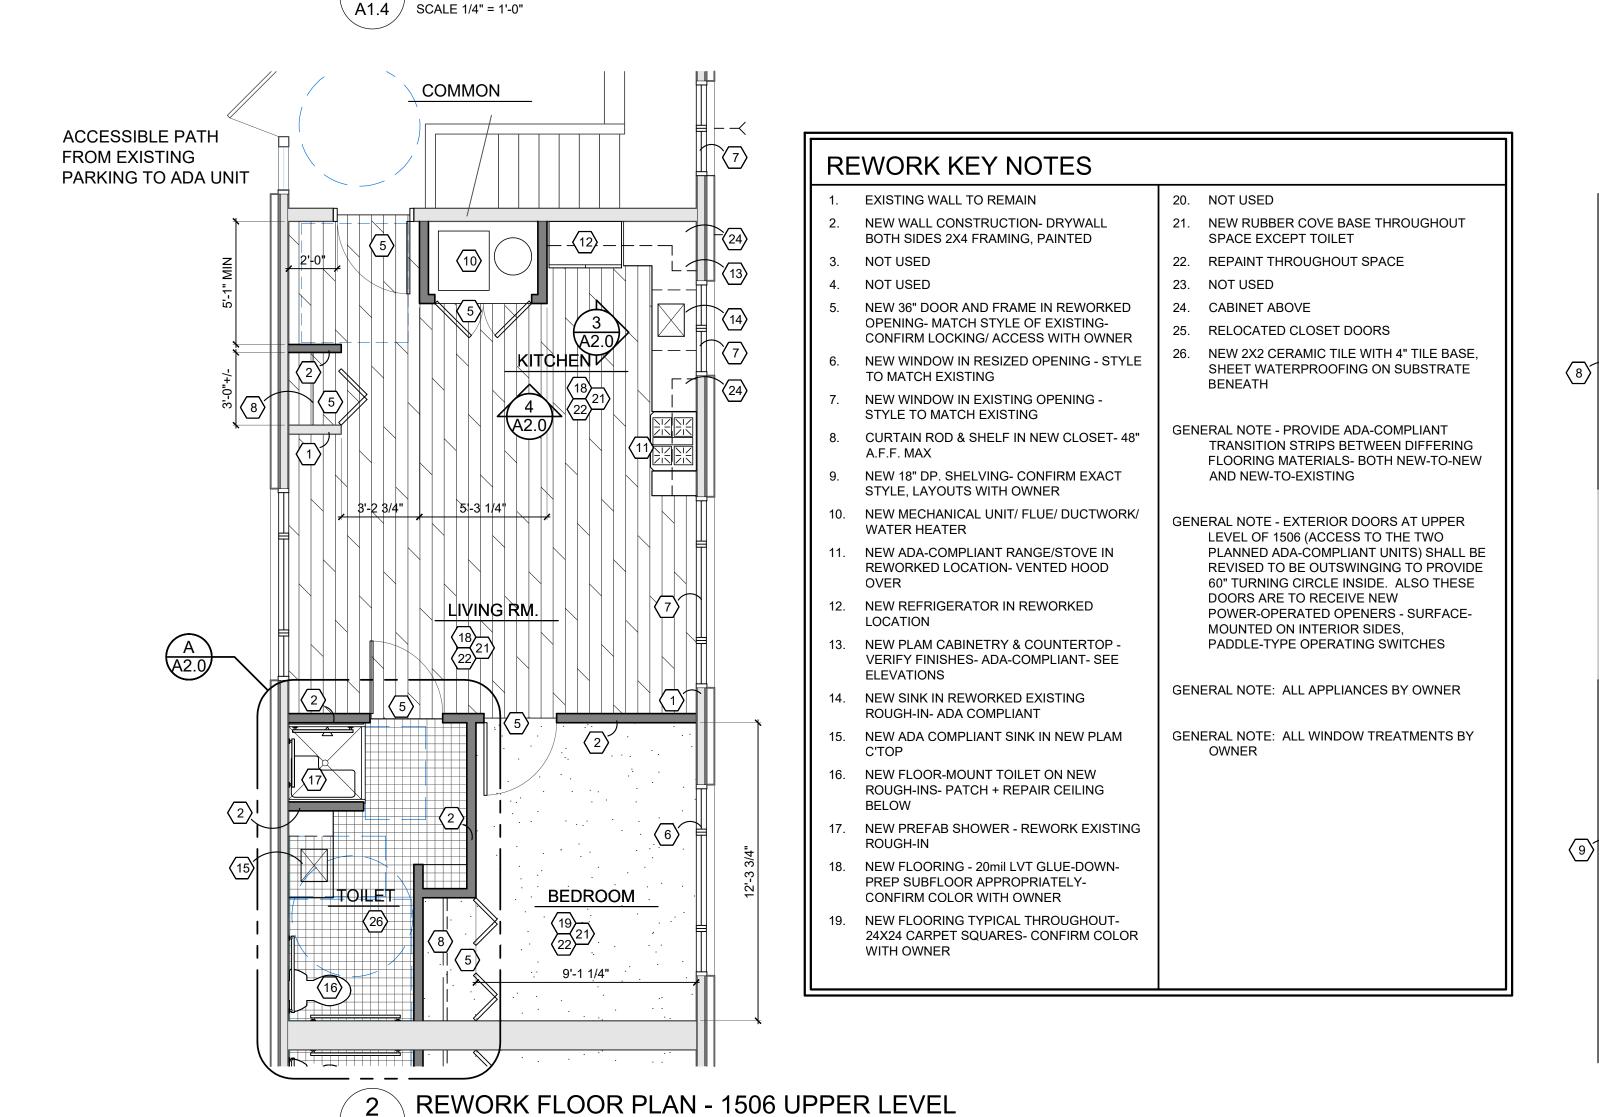

A1.4 / SCALE 1/4" = 1'-0"

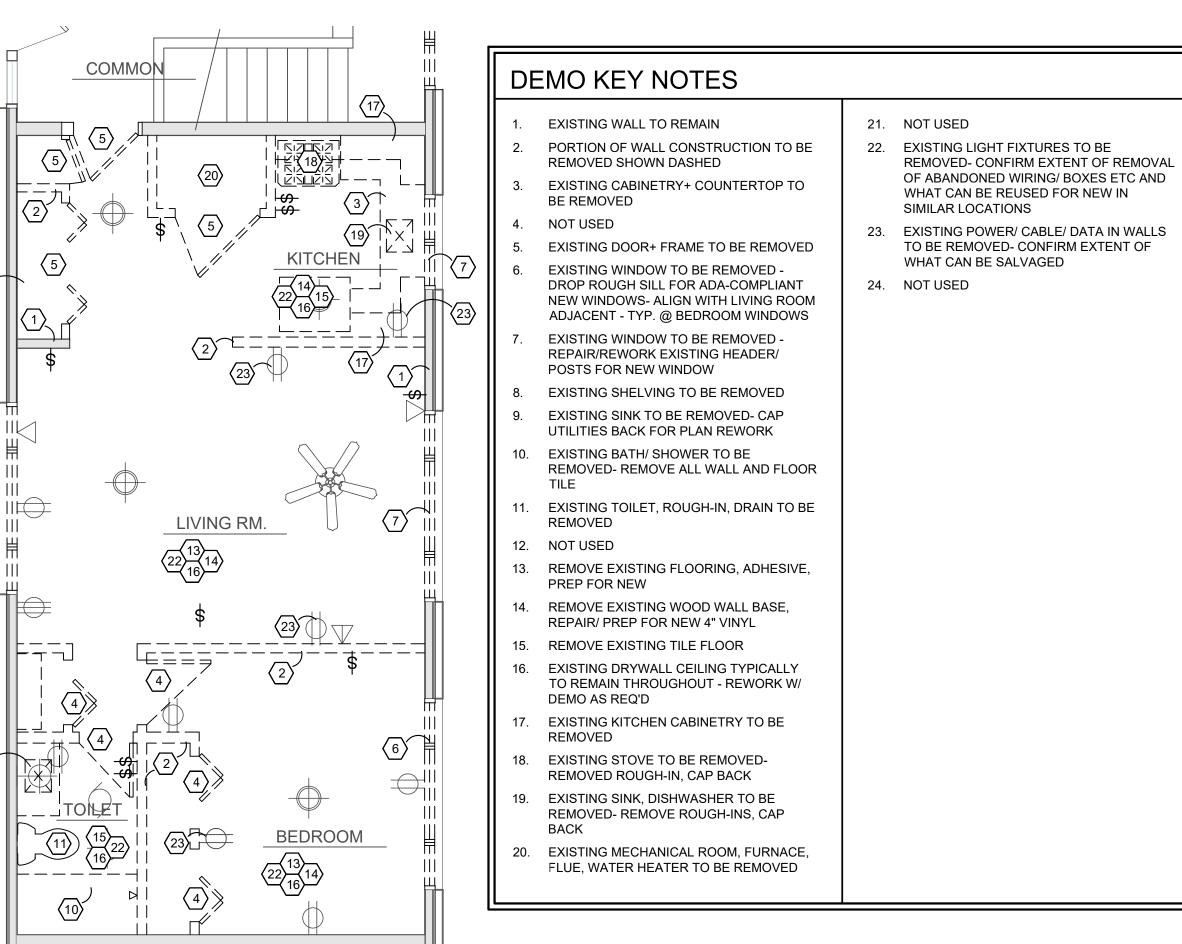

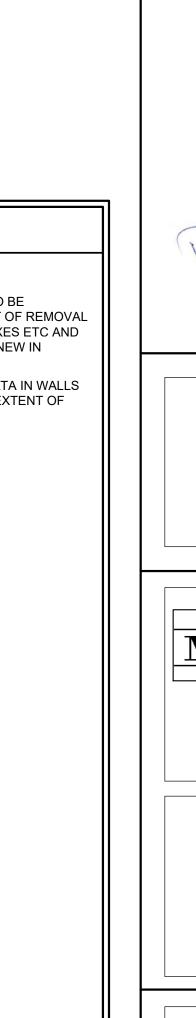

DEMOLITION PLAN - 1506 UPPER LEVEL A1.4 / SCALE 1/4" = 1'-0"

DRAWN BY DAS/ARG

Description

Cost Est.

PERMIT

No. Date

12.04.23

4-12-24

FACILITY/CLIENT

TREE

ARCHITECT

PROJECT

1504-1506-1508 REPLACEMENT WINDOWS 1504-1506 INTERIOR RENOVATIONS




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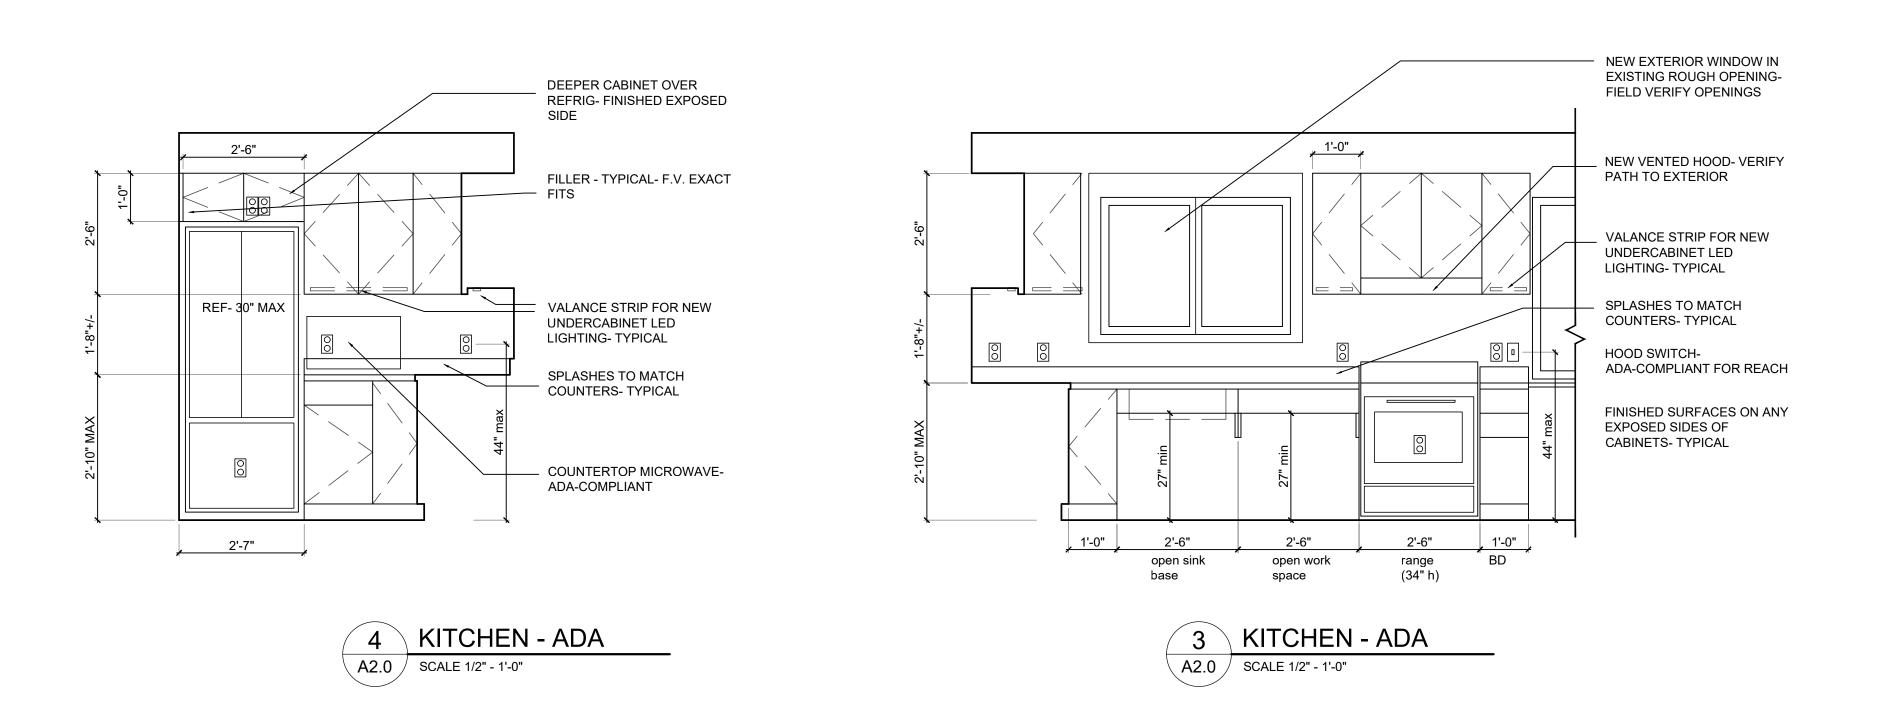
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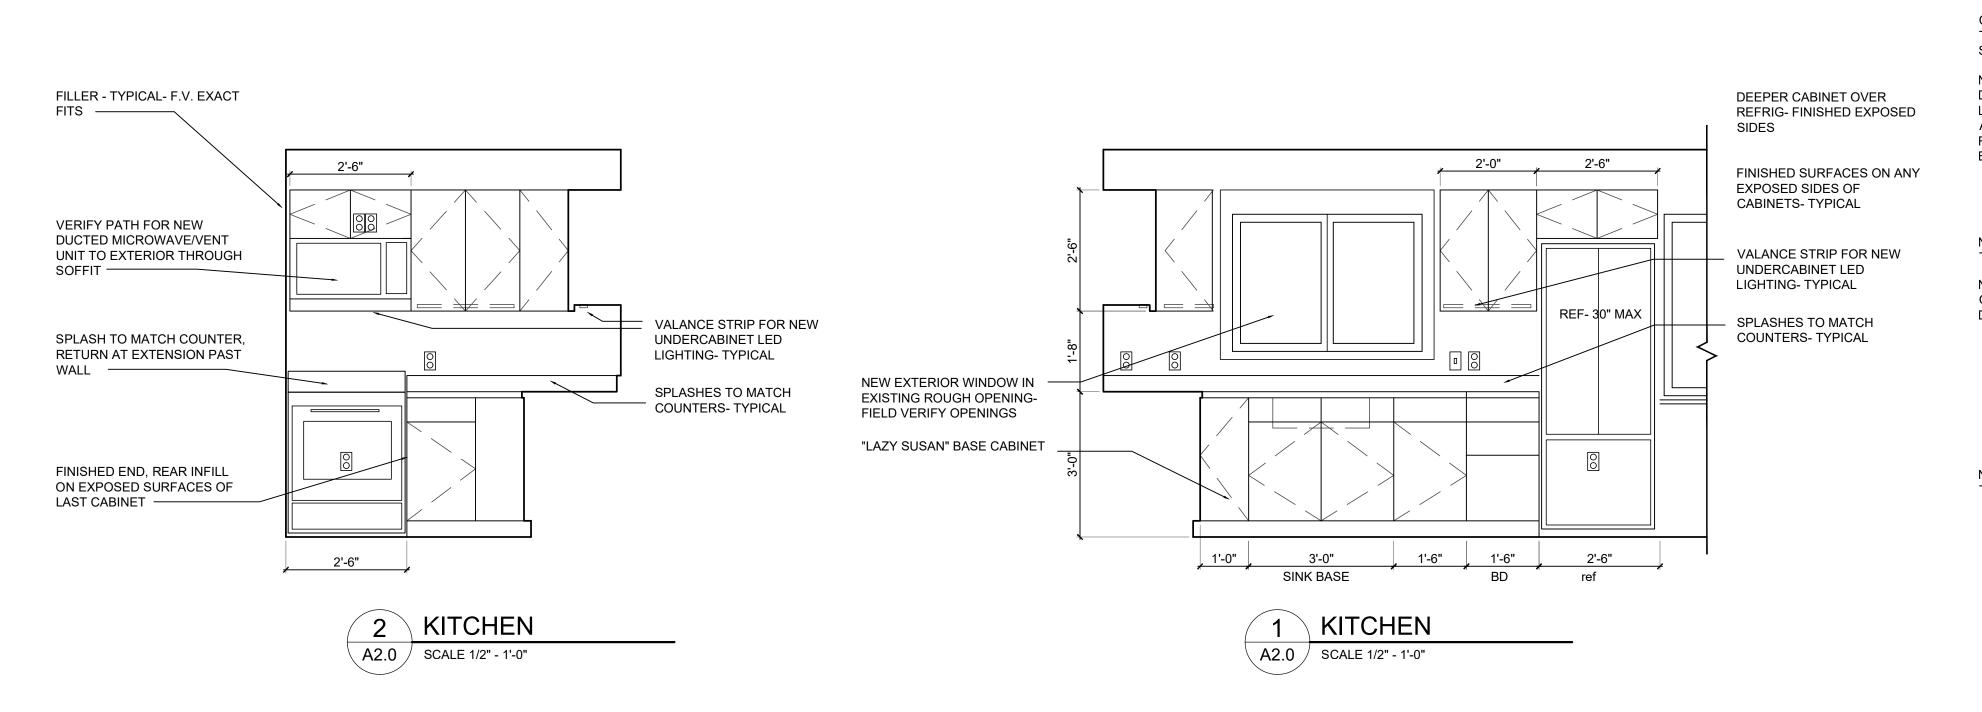
ANN ARBOR, MI 48104 TEL 734.604.8833 DASONNTAG@GMAIL.COM


SHEET TITLE DEMO/ REWORK/ CEILING/ ELECTRICAL PLANS **UNIT 1506 UPPER LEVEL**

> SHEET NO. A1.4






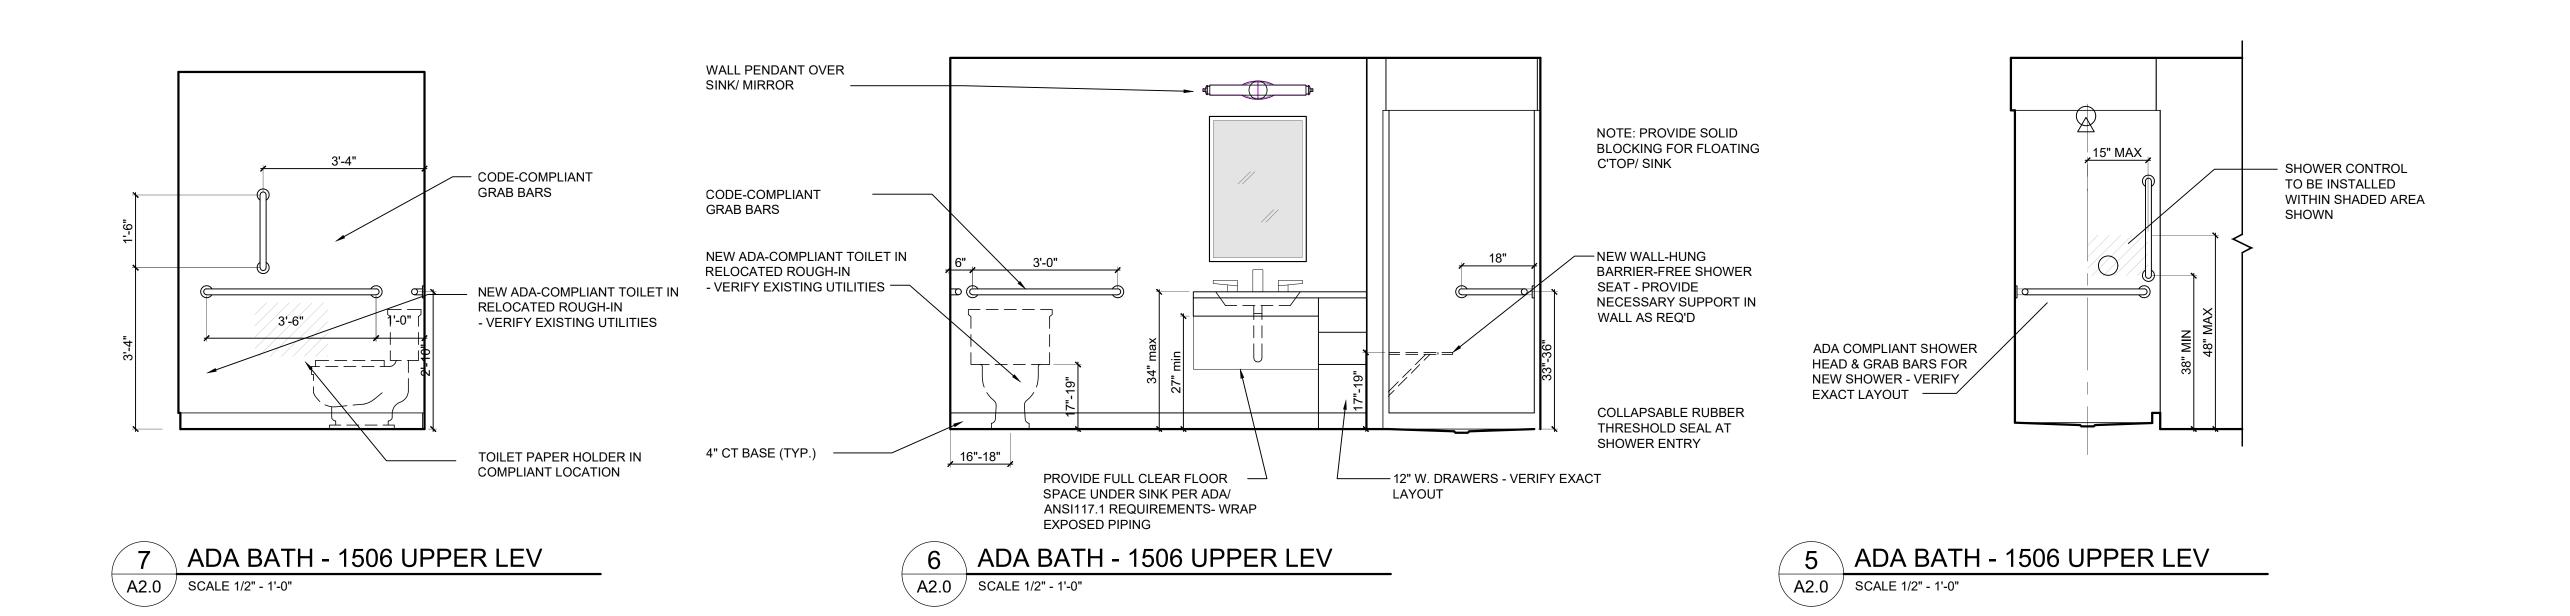

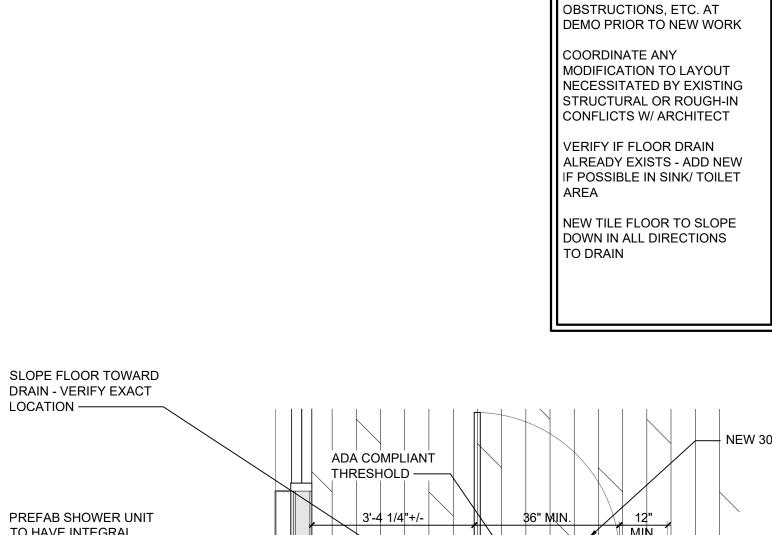


GENERAL NOTES

FIELD VERIFY ALL EXISTING

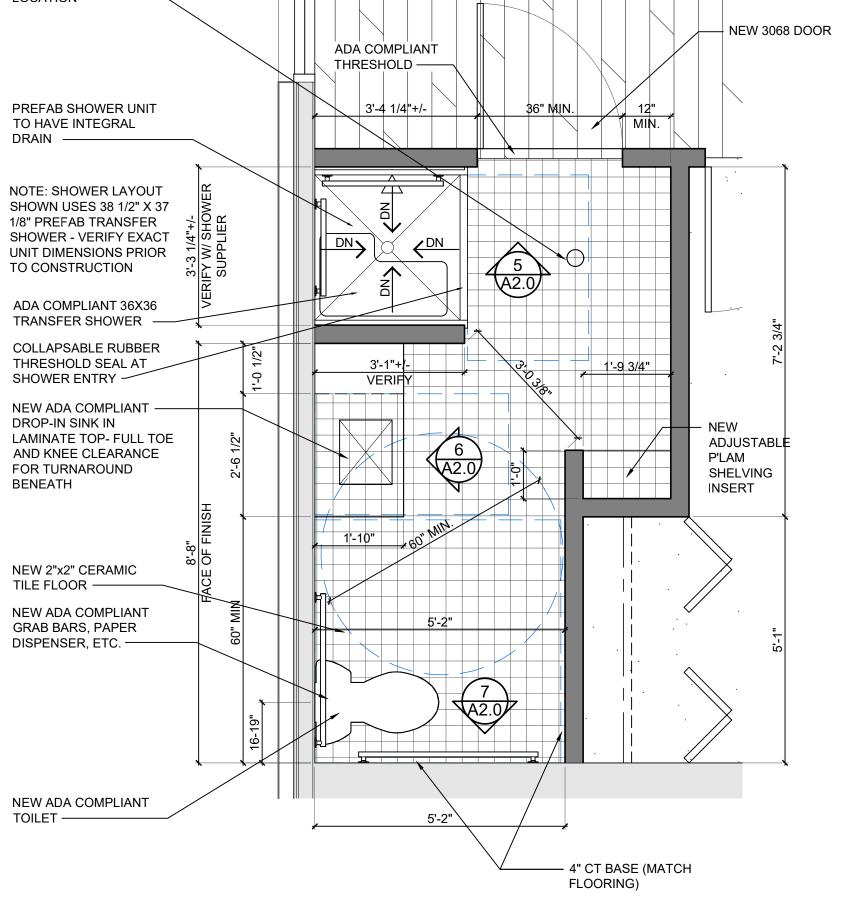

ENLARGED ADA TOILET PLAN

A2.0 SCALE 1/2" = 1'-0"

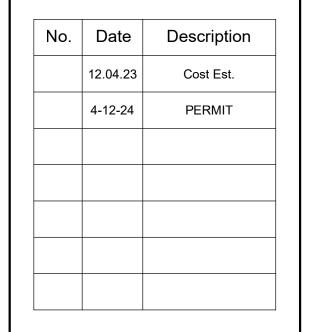

DAS/ARG DRAWN BY

FACILITY/CLIENT

TREE



PROJECT

1504-1506-1508 REPLACEMENT **WINDOWS** 1504-1506 INTERIOR RENOVATIONS




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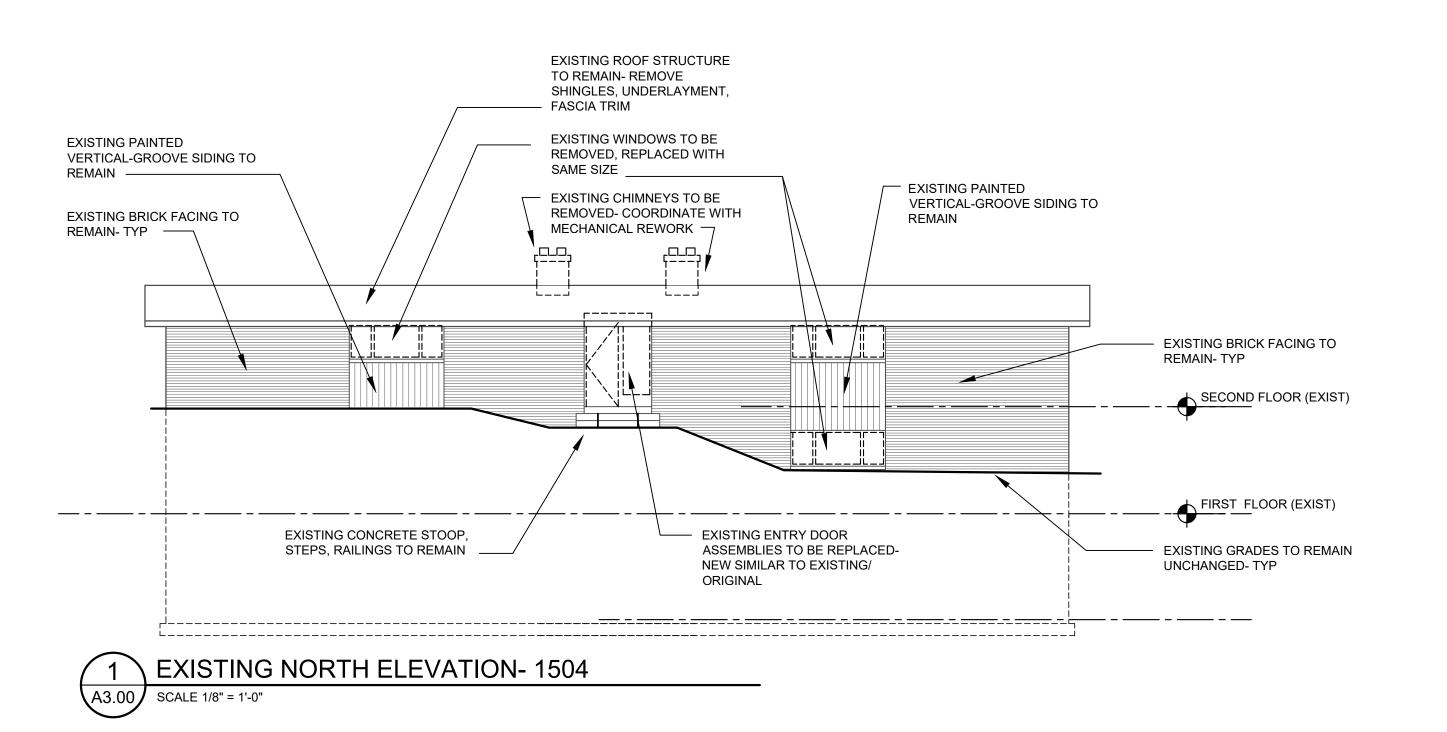
SHEET TITLE **ENLARGED ADA TOILET** PLAN/ INTERIOR **ELEVATIONS**








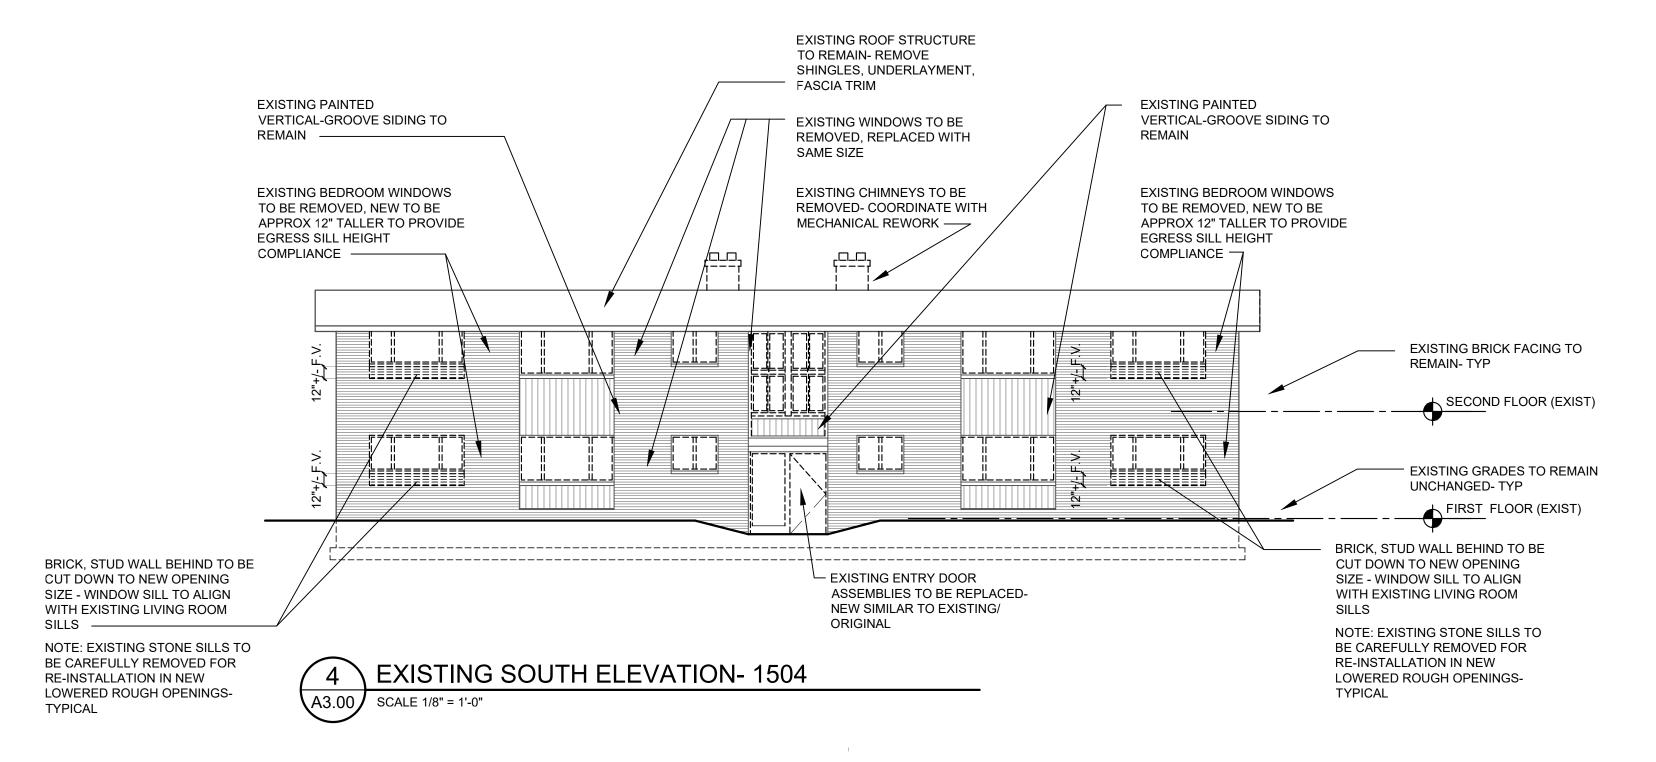



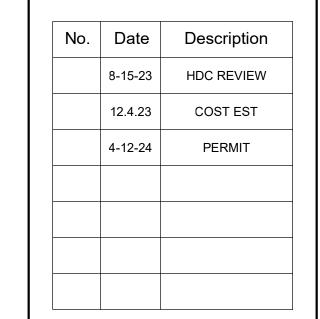

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FACILITY/CLIENT

BROADWAY TERRACE 04-1506-1508 BROADWAY STREET ANN ARBOR, MI 48105



PROJECT

1504-1506-1508

REPLACEMENT

WINDOWS

1504-1506 INTERIOR

RENOVATIONS



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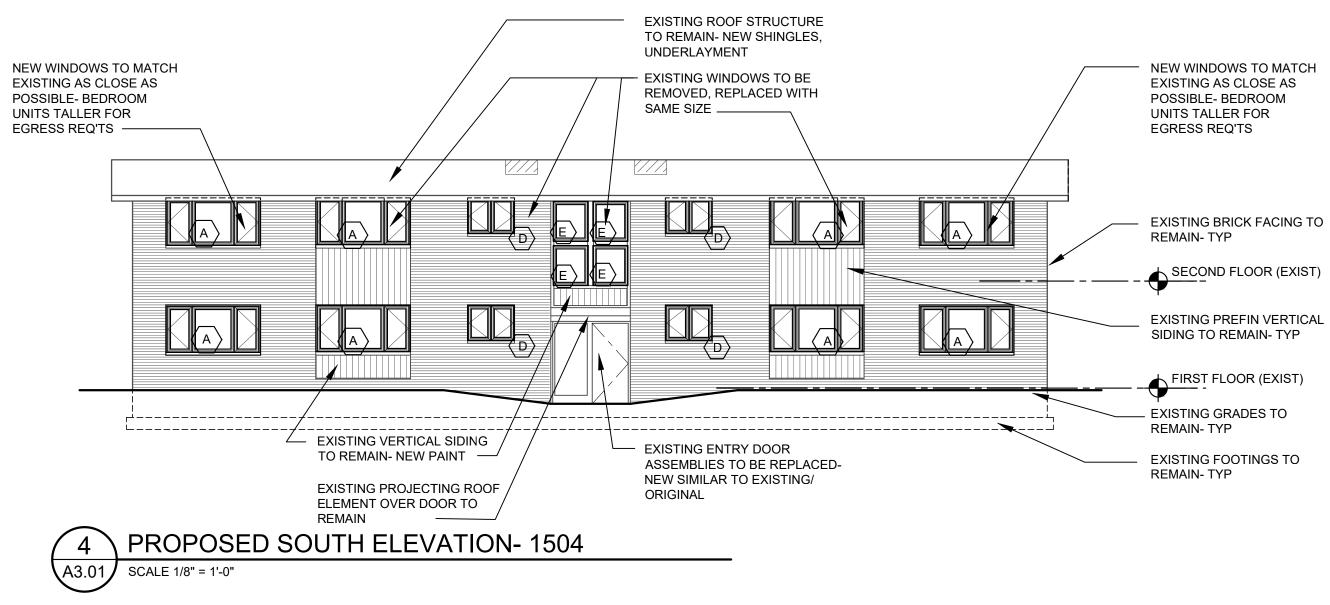
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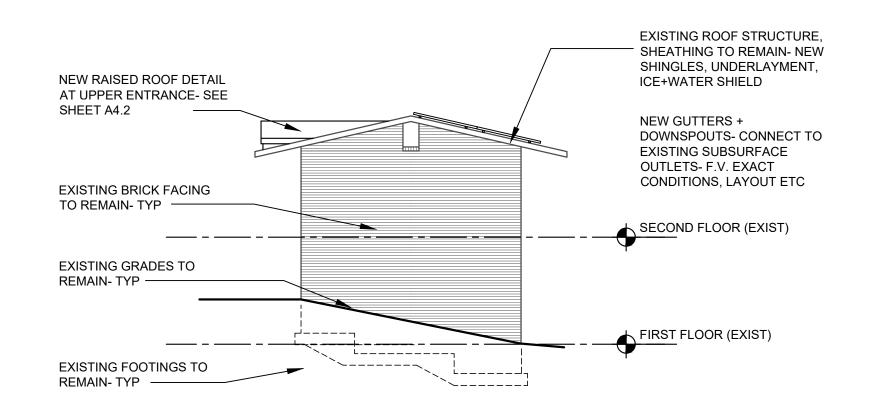
1504

EXTERIOR ELEVATIONS-

SHEET NO.

EXISTING/ DEMO






_ NEW RAISED ROOF DETAIL AT UPPER ENTRANCE- SEE SHEET A4.2 EXISTING ROOF STRUCTURE, SHEATHING TO REMAIN- NEW SHINGLES, UNDERLAYMENT, ICE+WATER SHIELD -NEW GUTTERS + DOWNSPOUTS- CONNECT TO EXISTING SUBSURFACE OUTLETS- F.V. EXACT EXISTING BRICK FACING CONDITIONS, LAYOUT ETC TO REMAIN- TYP — SECOND FLOOR (EXIST) EXISTING GRADES TO REMAIN- TYP -EXISTING FOOTINGS TO REMAIN- TYP -





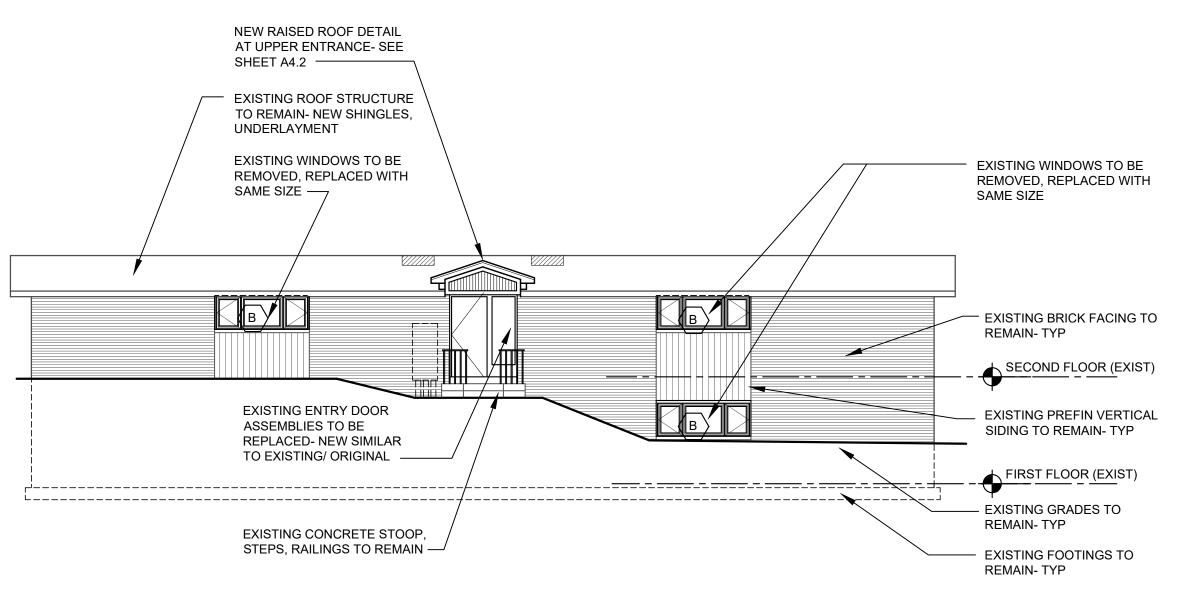

PROPOSED NORTH ELEVATION- 1504

SCALE 1/8" = 1'-0"

No.	Date	Description
	8-15-23	HDC REVIEW
	12.4.23	COST EST
	4-12-24	PERMIT
	No.	8-15-23 12.4.23

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FACILITY/CLIENT

BROADWAY TERRACE 1504-1506-1508 BROADWAY STREET ANN ARBOR, MI 48105



PROJECT

1504-1506-1508

REPLACEMENT

REPLACEMENT
WINDOWS
1504-1506 INTERIOR
RENOVATIONS



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GROUP


architecture - plc 106 S. MAIN STREET ANN ARBOR, MI 48104 TEL 734.604.8833 DASONNTAG@GMAIL.COM


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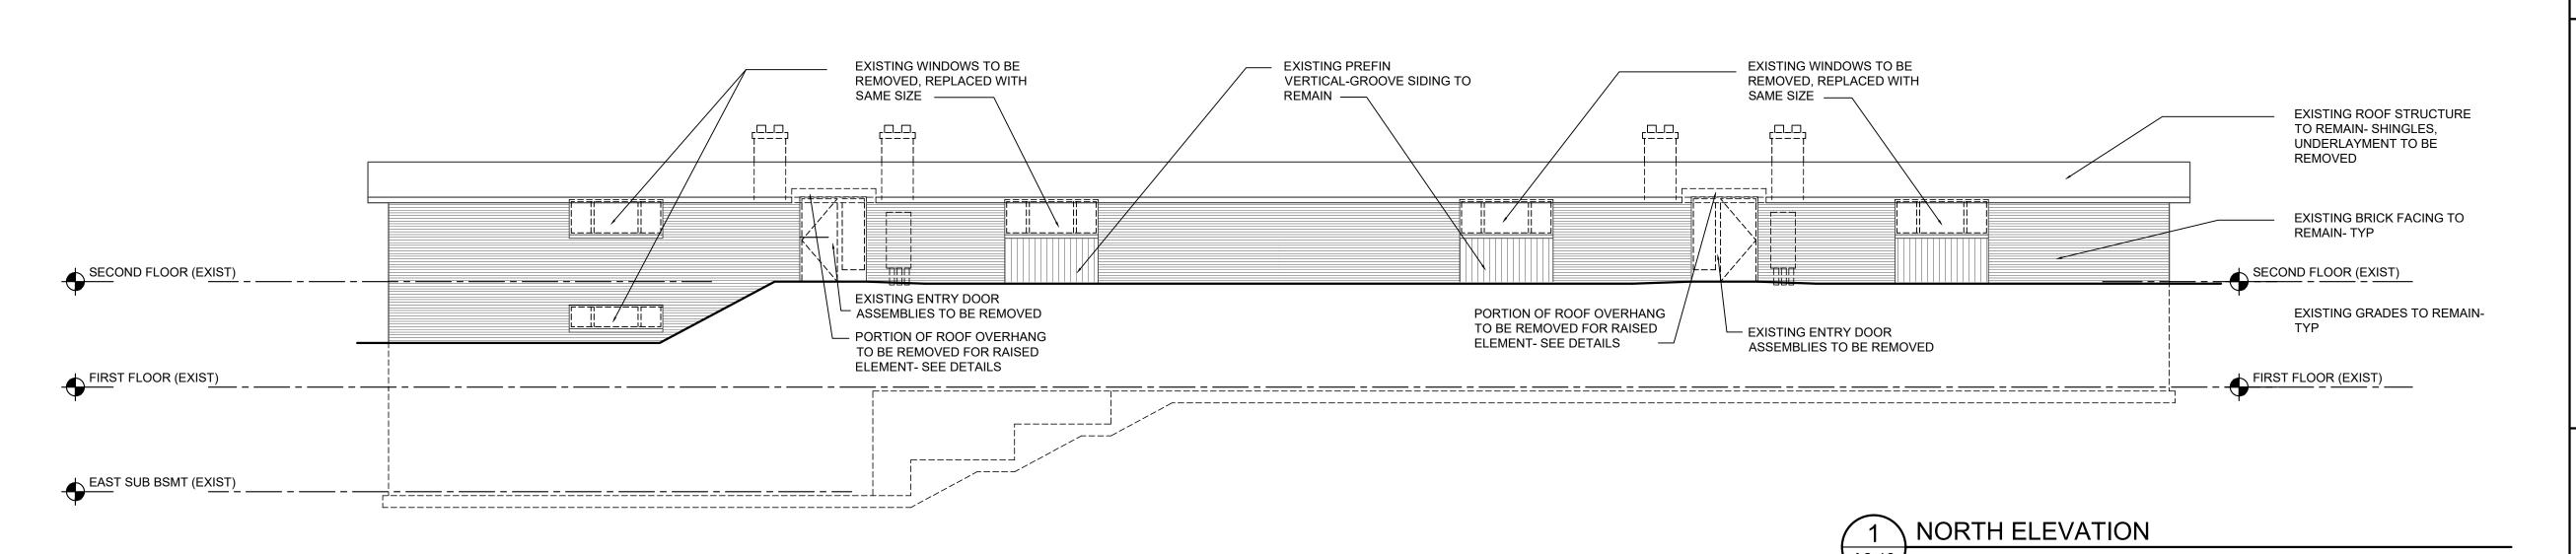
1504

EXTERIOR ELEVATIONSPROPOSED ALTERATIONS

SHEET NO.
A3.01



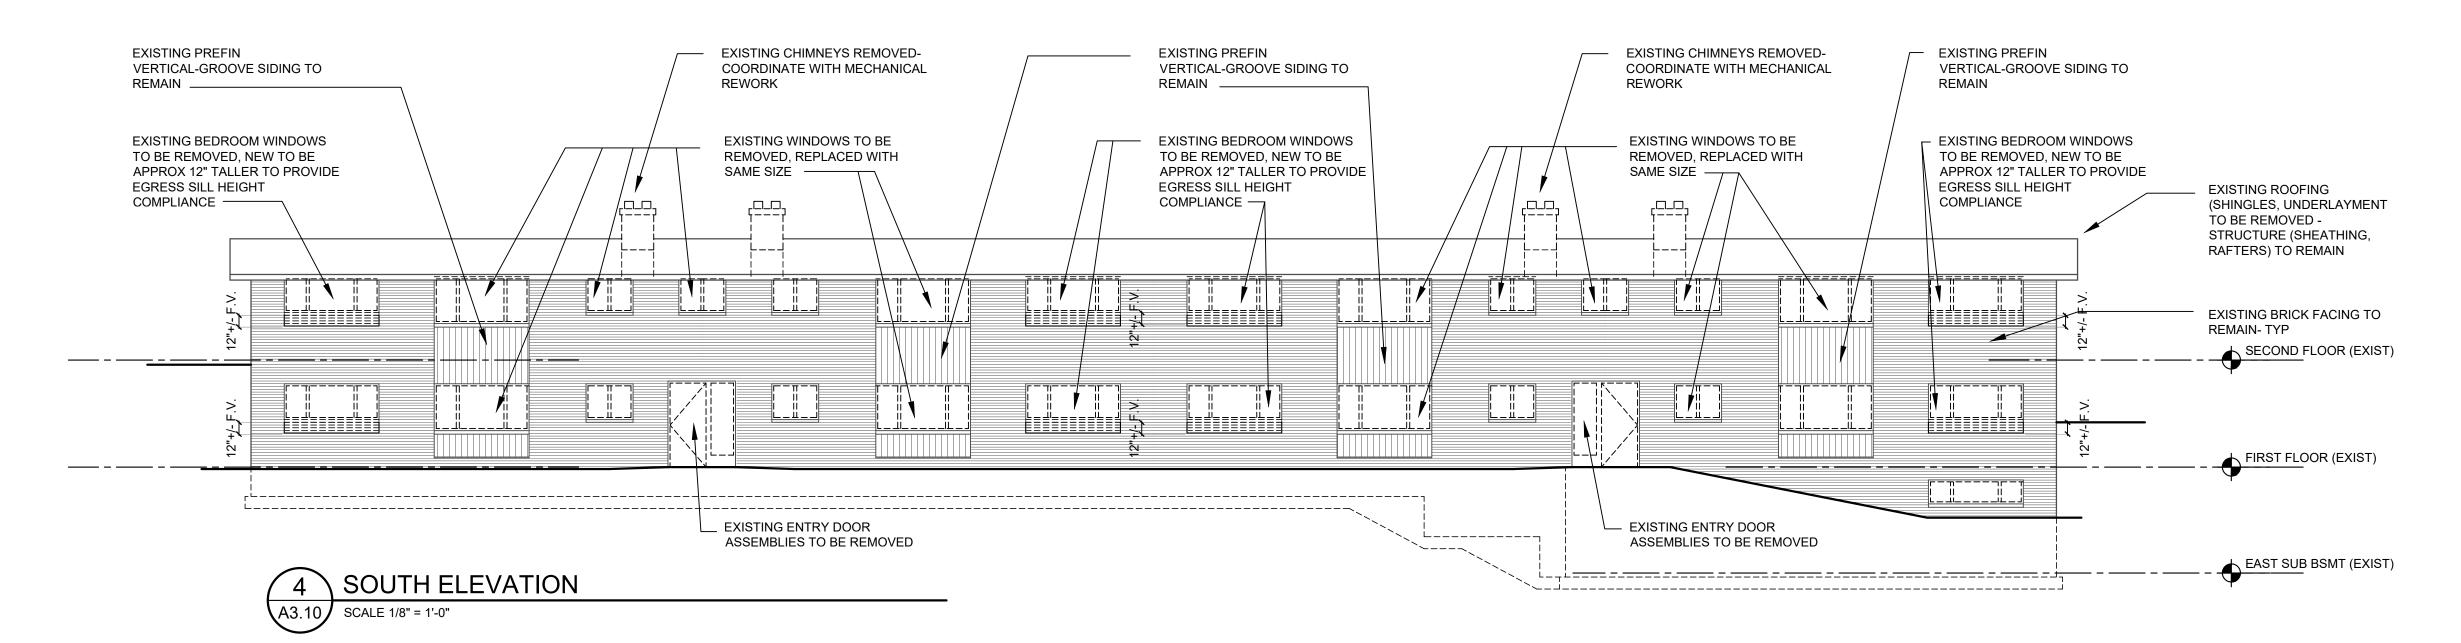

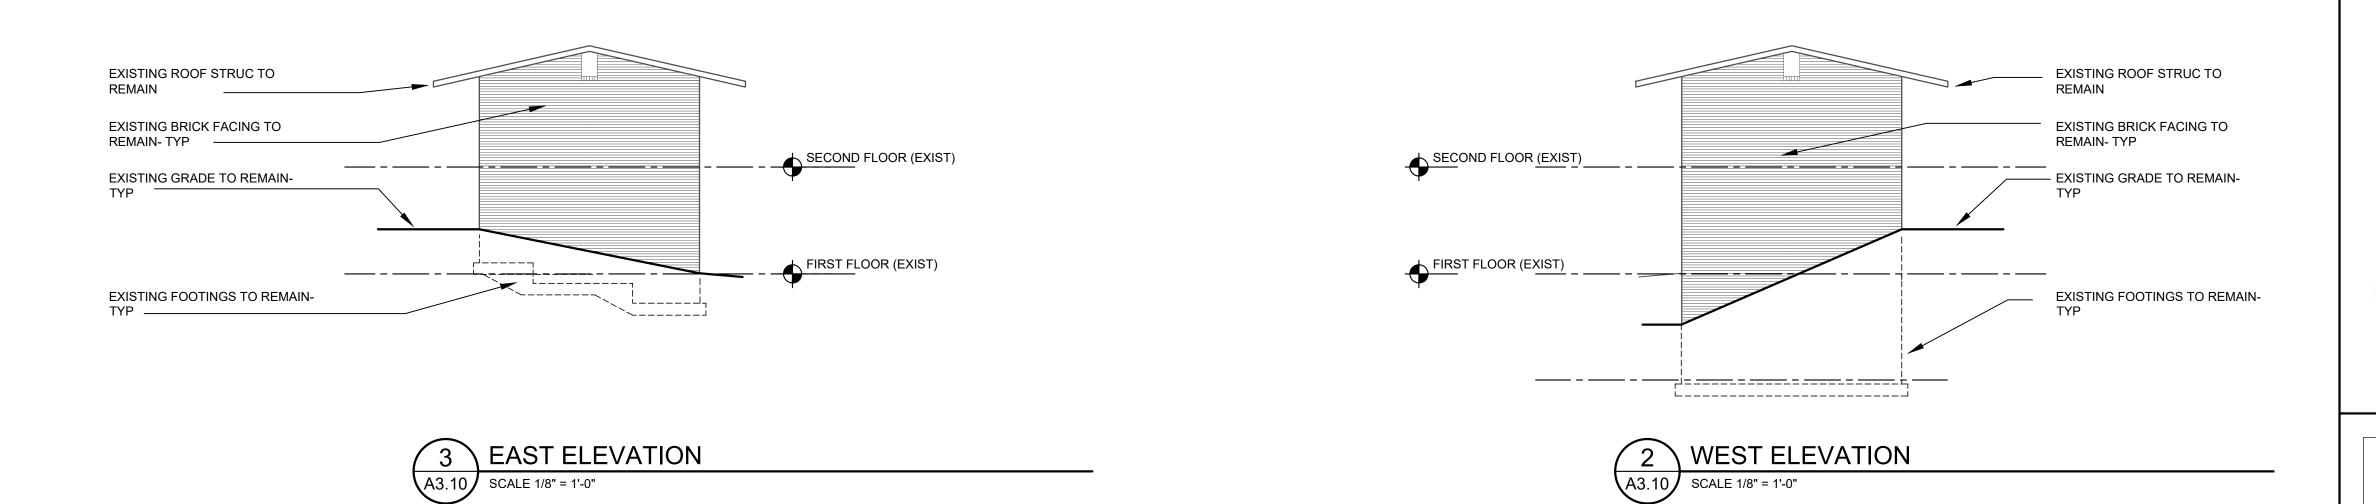

No.	Date	Description	
	8-15-23	HDC REVIEW	
	12.4.23	COST EST	
	4-12-24	PERMIT	

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PROJECT

1504-1506-1508
REPLACEMENT
WINDOWS
1504-1506 INTERIOR

RENOVATIONS



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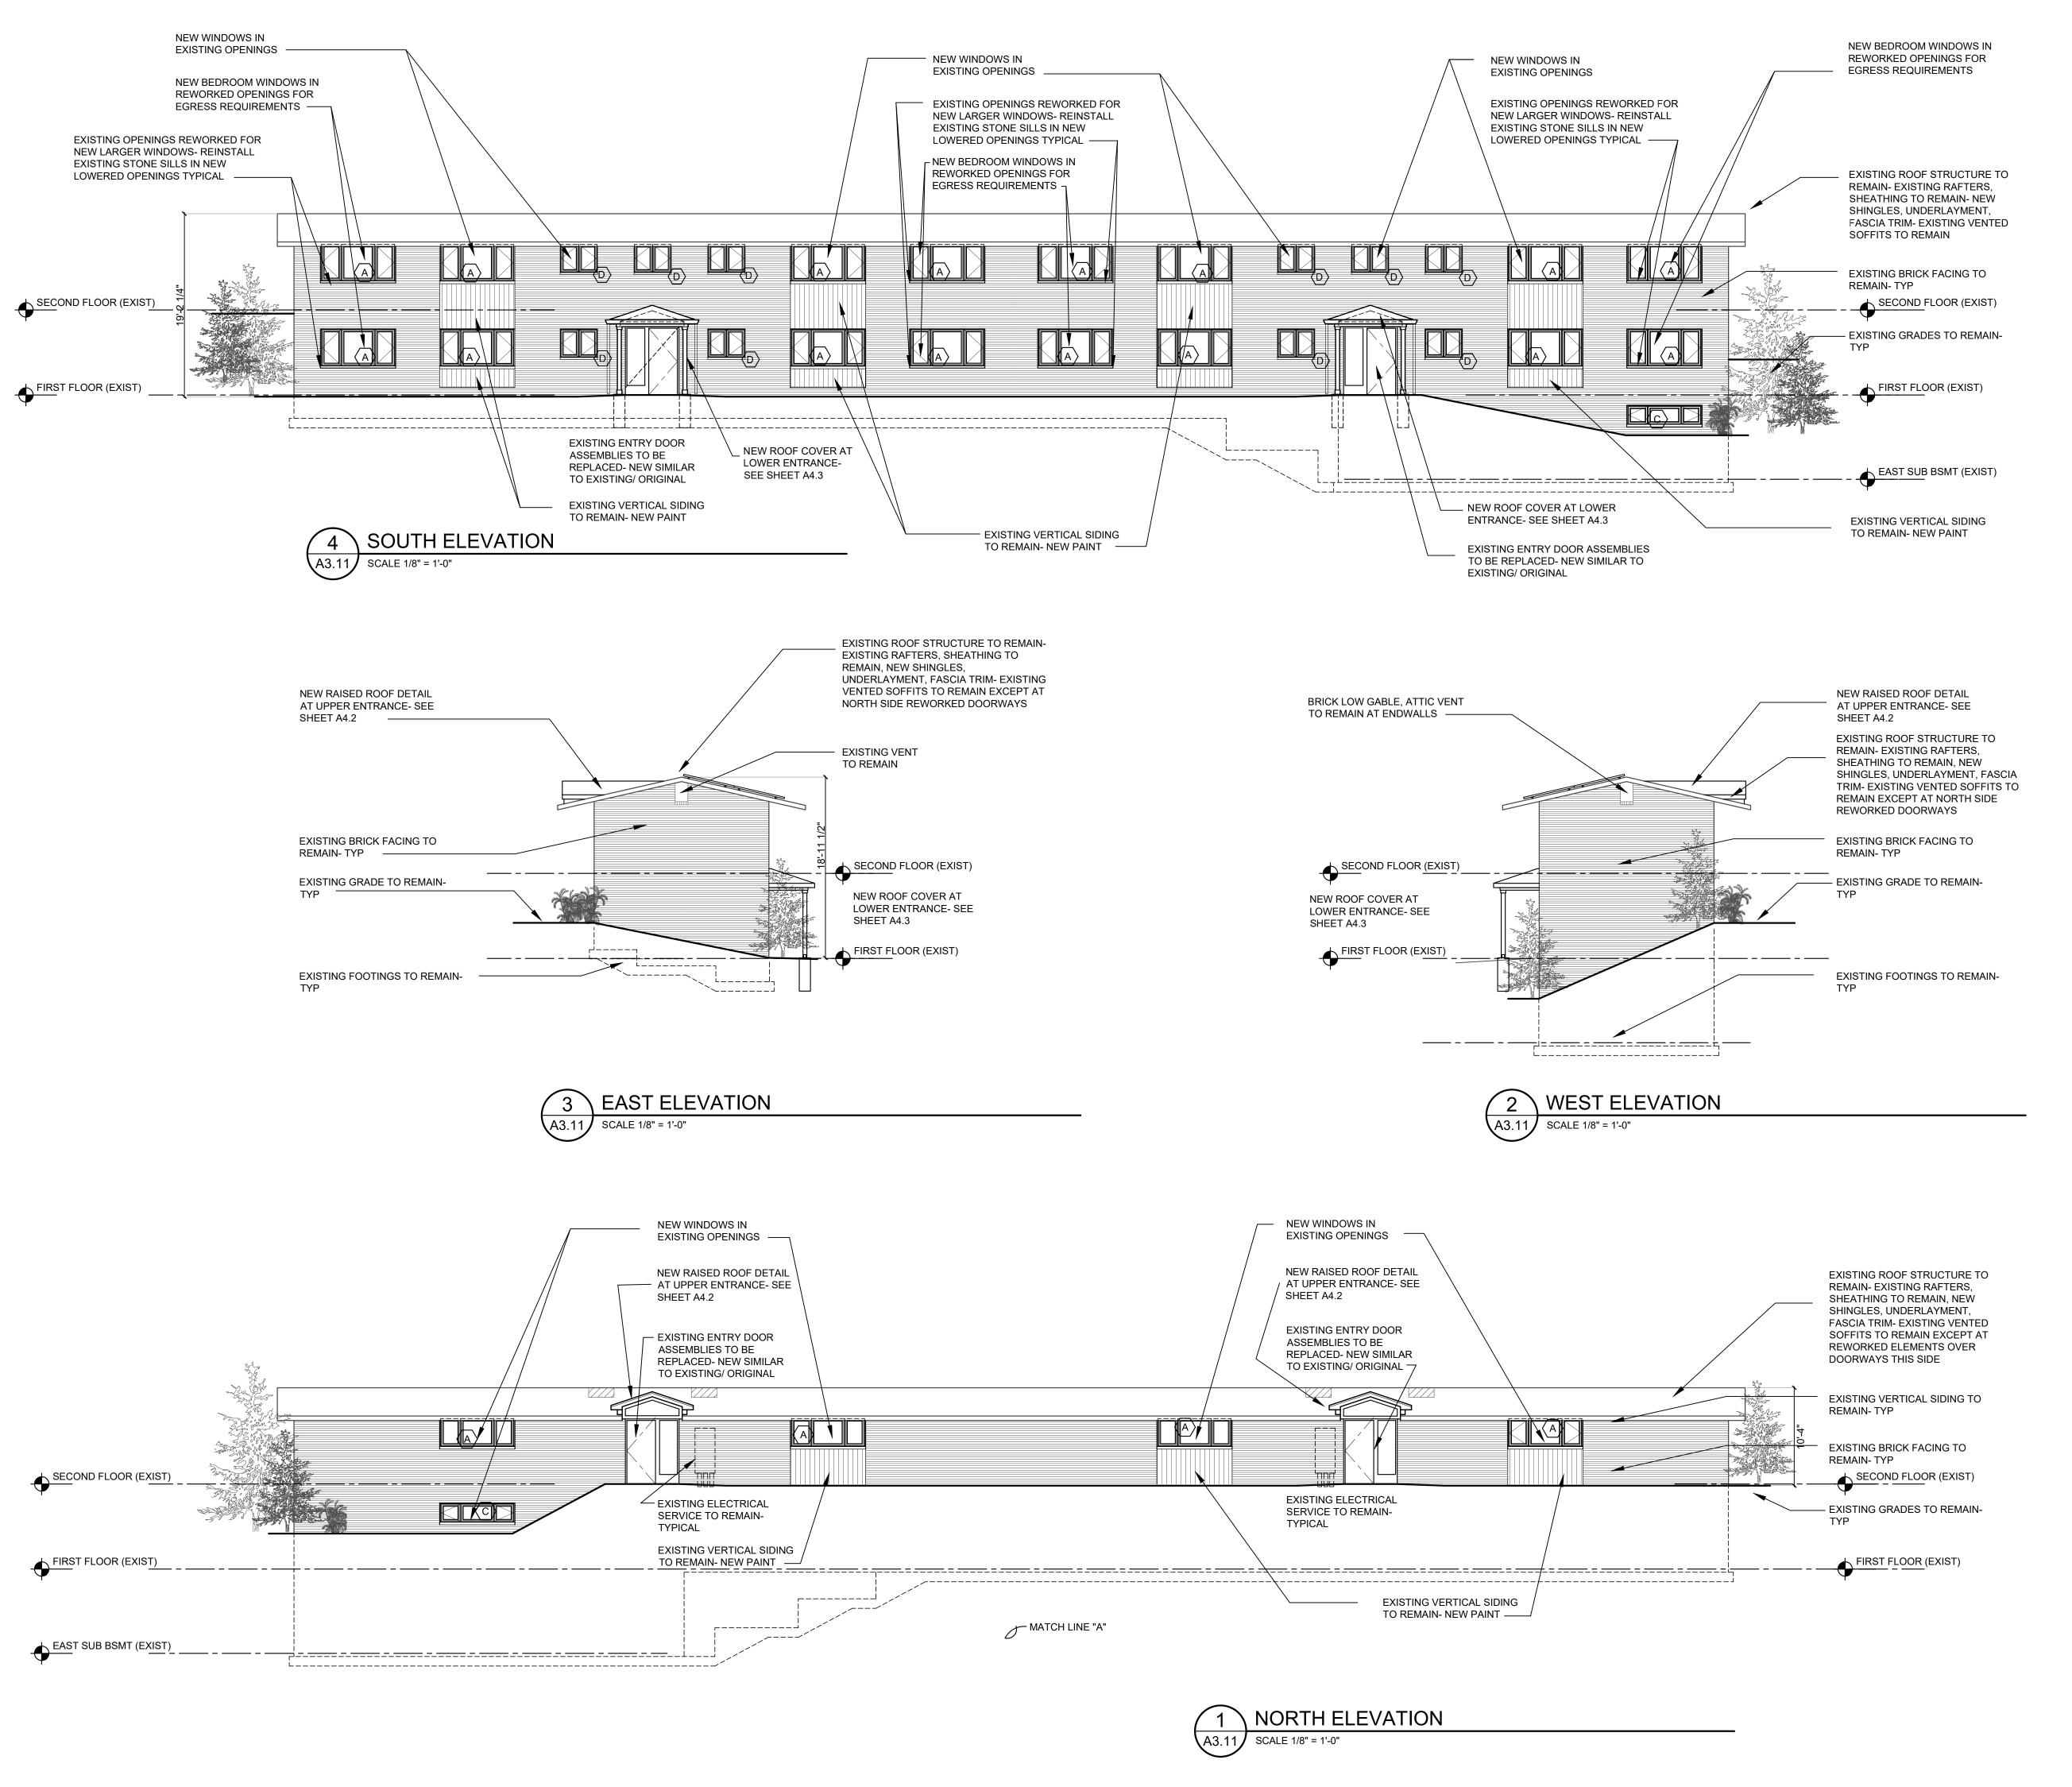
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DESIGN
GROUP

architecture - plc
106 S. MAIN STREET
ANN ARBOR, MI 48104

TEL 734.604.8833 DASONNTAG@GMAIL.COM

SHEET TITLE

1506 EXTERIOR
ELEVATIONSDEMO



No. Date Description

8-15-23 HDC REVIEW

12.4.23 COST EST

4-12-24 PERMIT

DRAWN BY DAS/ ARG

FACILITY/CLIENT

BROADWAY TERRACE 504-1506-1508 BROADWAY STREET ANN ARBOR, MI 48105



PROJECT

1504-1506-1508 REPLACEMENT WINDOWS 1504-1506 INTERIOR RENOVATIONS



106 S. MAIN STREET ANN ARBOR, MI 48104 TEL. 734.998.0098 FAX 734.996.8899


SONNTAG DESIGN GROUP

architecture - plc 106 S. MAIN STREET ANN ARBOR, MI 48104 TEL 734.604.8833 DASONNTAG@GMAIL.COM

SHEET TITLE

1506
EXTERIOR ELEVATIONSPROPOSED REWORK


SHEET NO. **A3.11**

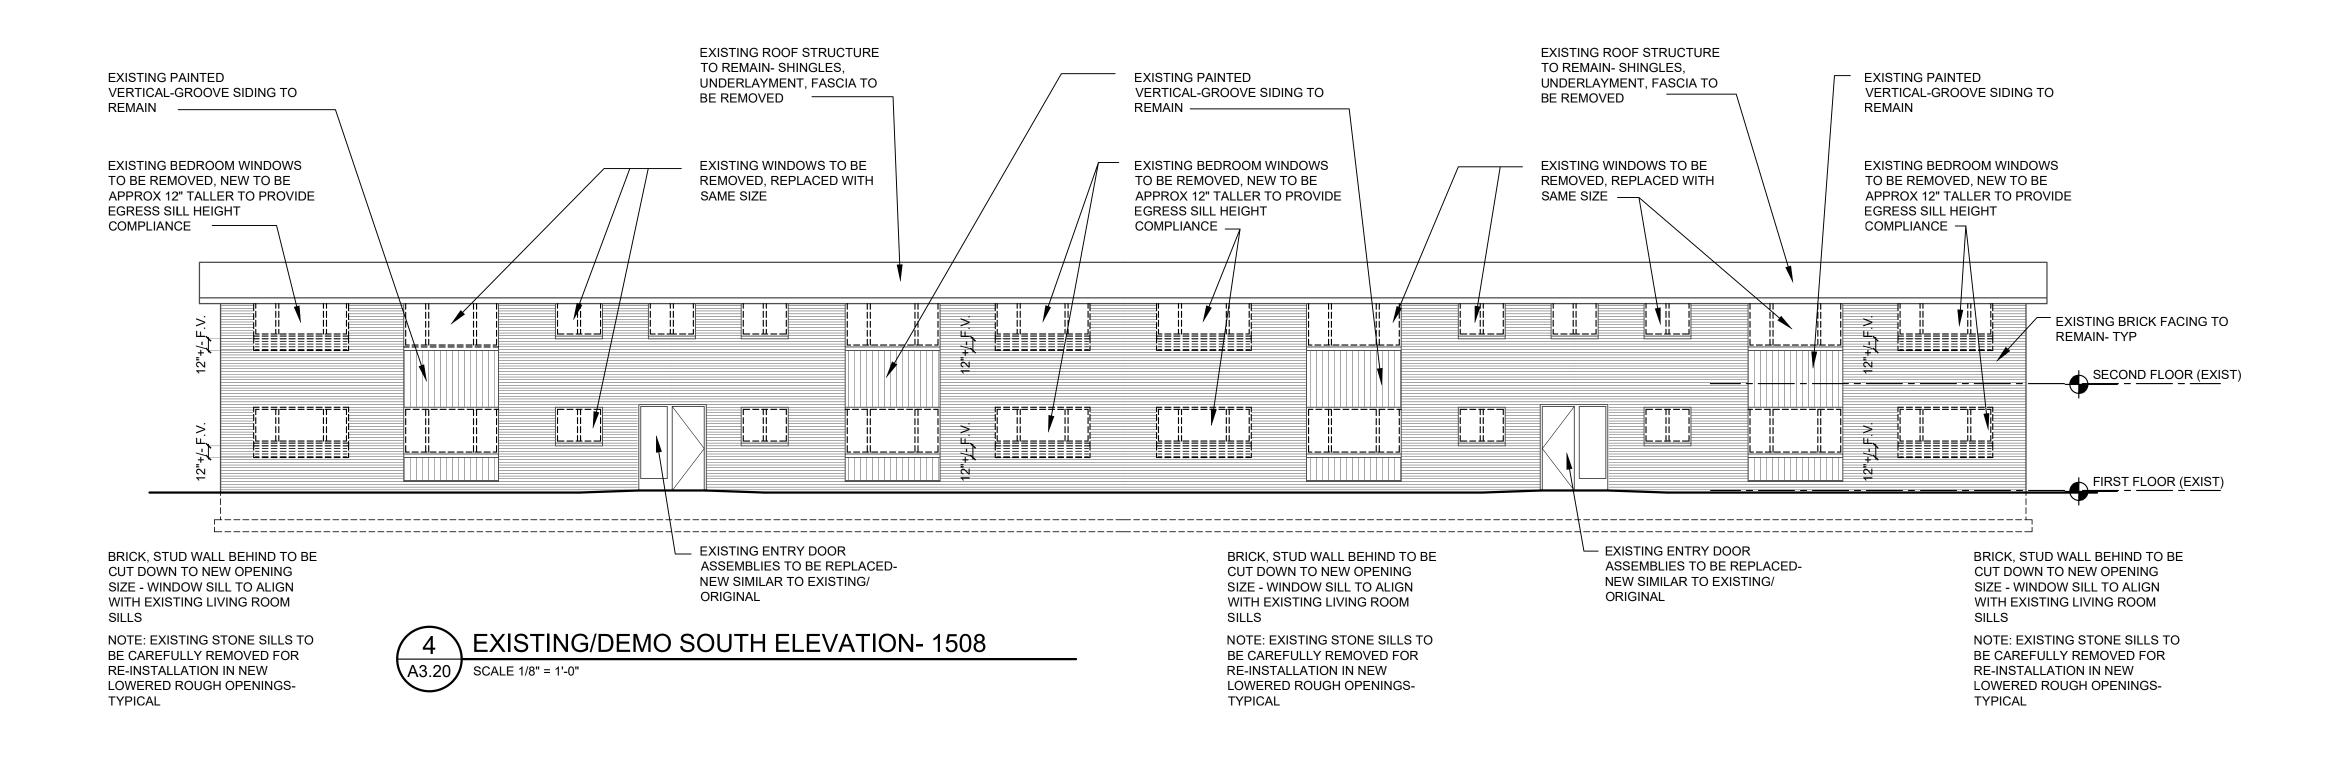



WEST ELEVATION DEMO- 1508

SCALE 1/8" = 1'-0"

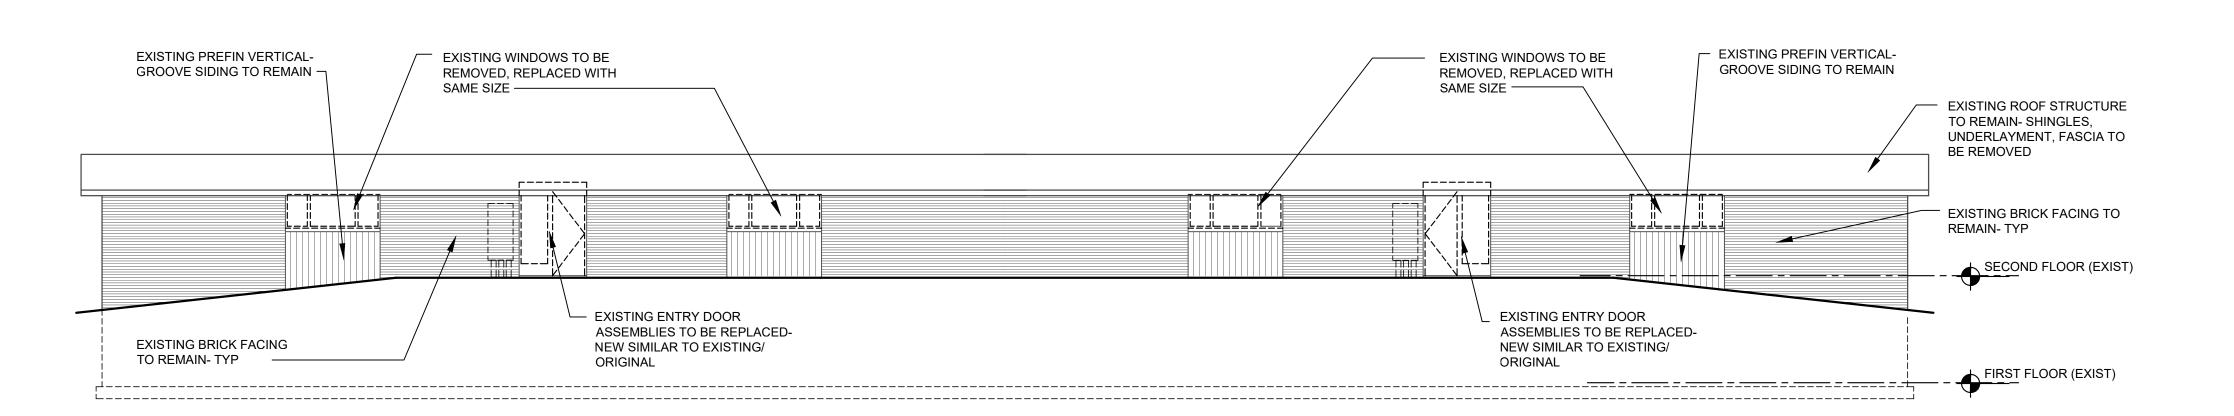



EAST ELEVATION DEMO - 1508

SCALE 1/8" = 1'-0"

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FACILITY/CLIENT

BROADWAY TERRACE 504-1506-1508 BROADWAY STREET ANN ARBOR, MI 48105



PROJECT

1504-1506-1508 REPLACEMENT WINDOWS 1504-1506 INTERIOR RENOVATIONS



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SONNTAG
DESIGN
GROUP


architecture - plc
106 S. MAIN STREET
ANN ARBOR, MI 48104


TEL 734.604.8833 DASONNTAG@GMAIL.COM


SHEET TITLE

1508
EXTERIOR ELEVATIONSEXISTING/ DEMO

A3.20

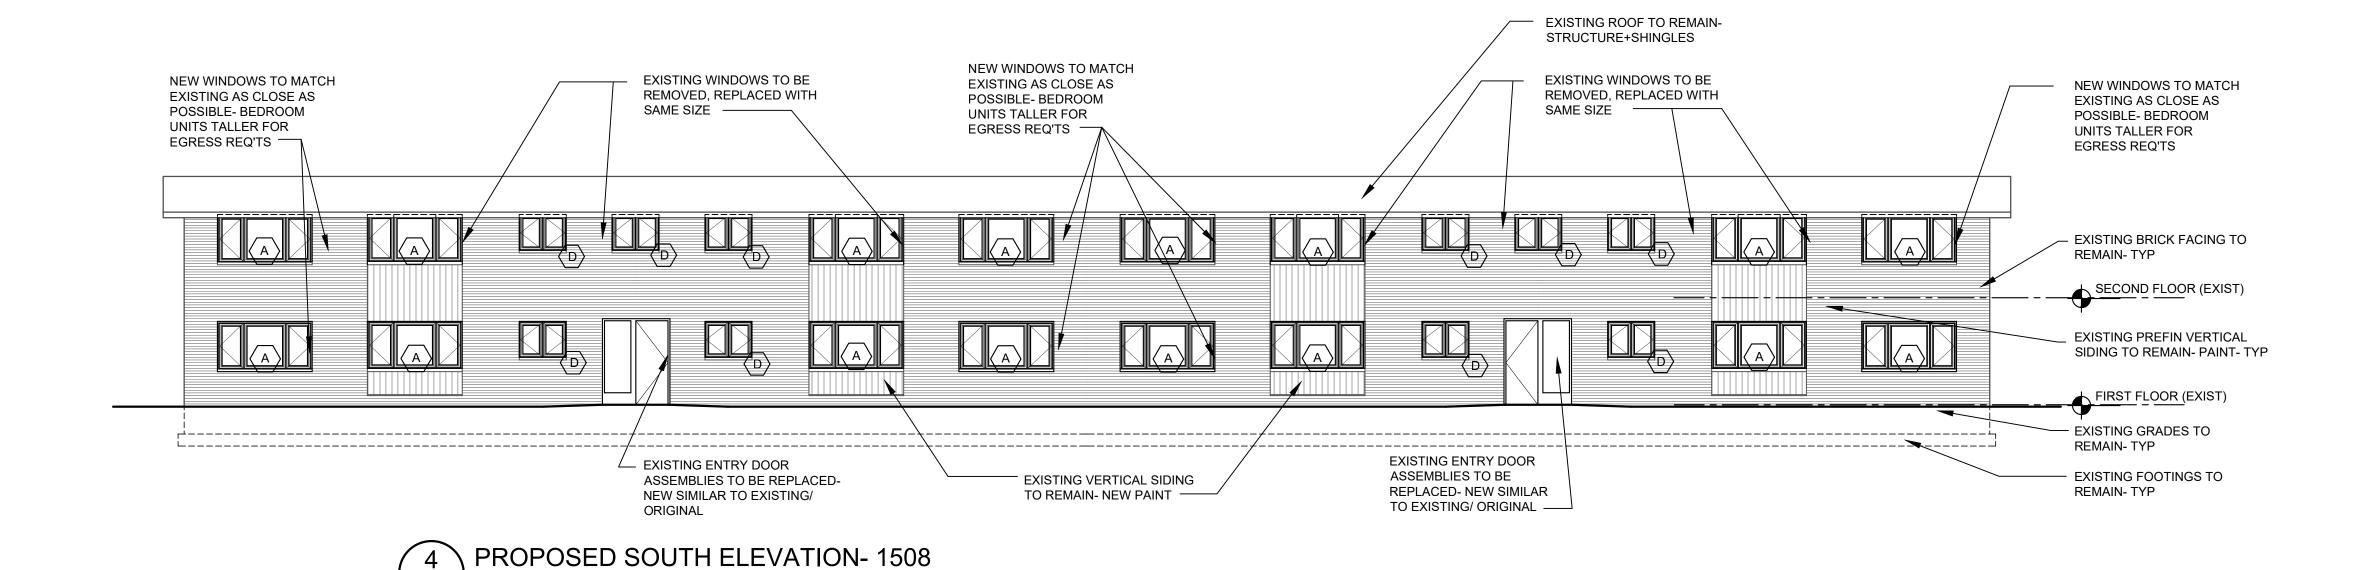

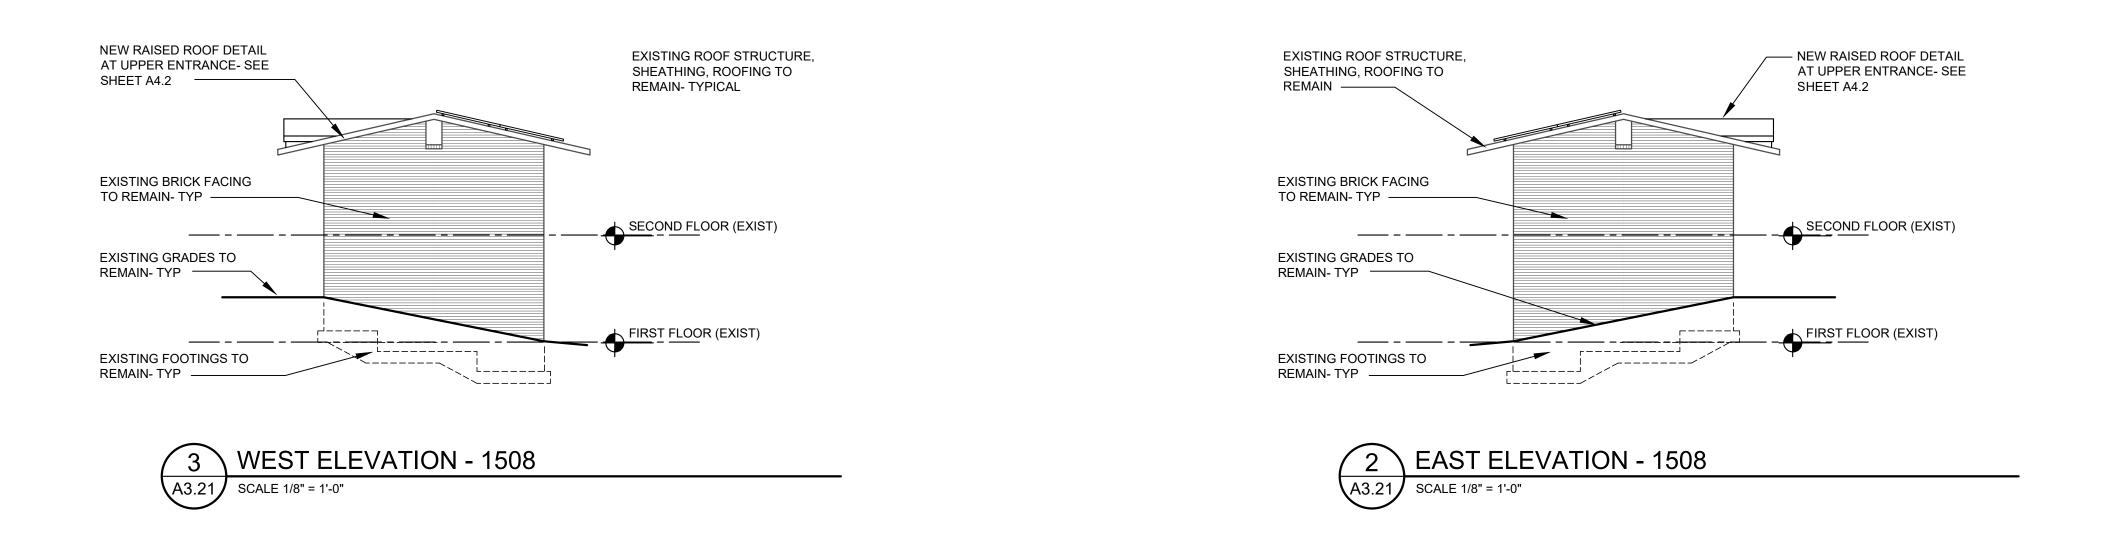

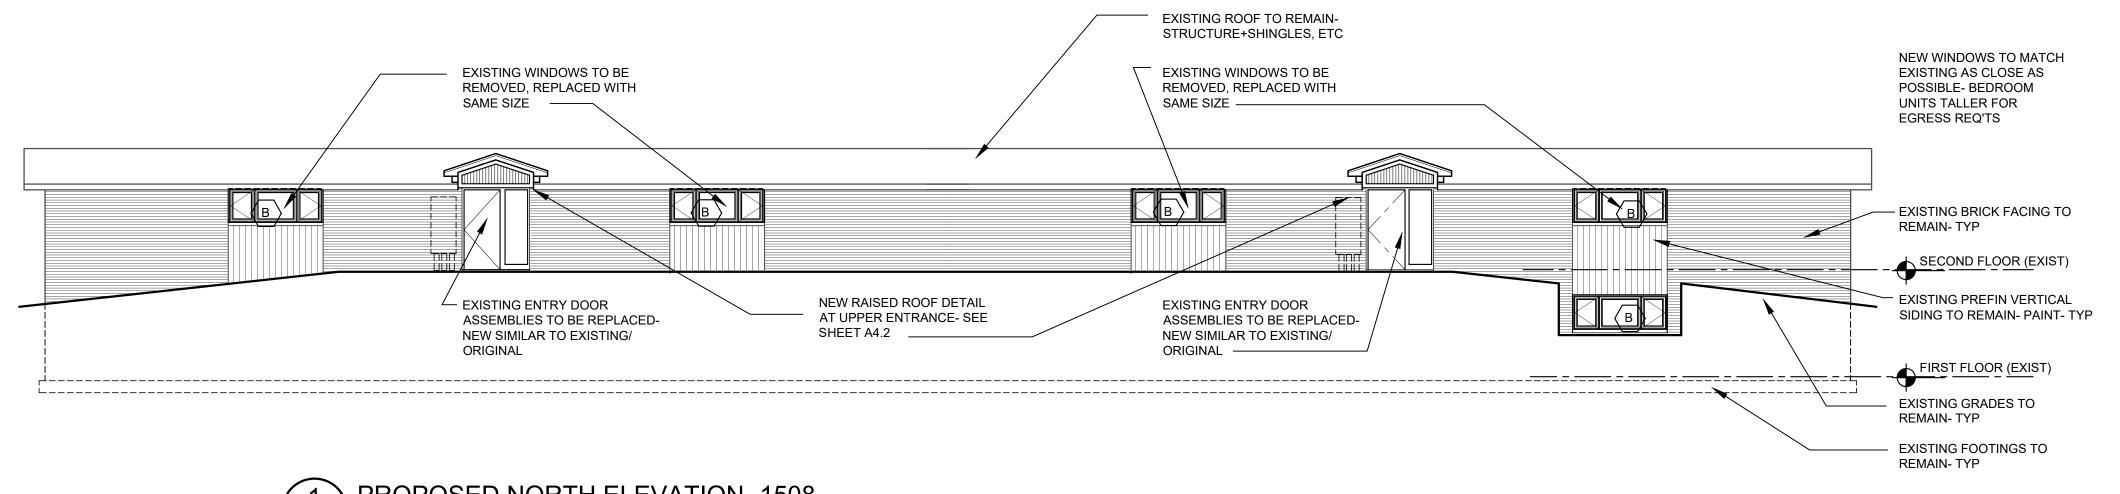



SCALE 1/8" = 1'-0"

No.	Date	Description
	8-15-23	HDC REVIEW
	12.4.23	COST EST
	4-12-24	PERMIT

DRAWN BY DAS/ ARG

FACILITY/CLIENT

BROADWAY TERRACE 1504-1506-1508 BROADWAY STREET ANN ARBOR, MI 48105



PROJECT

1504-1506-1508 REPLACEMENT WINDOWS 1504-1506 INTERIOR RENOVATIONS



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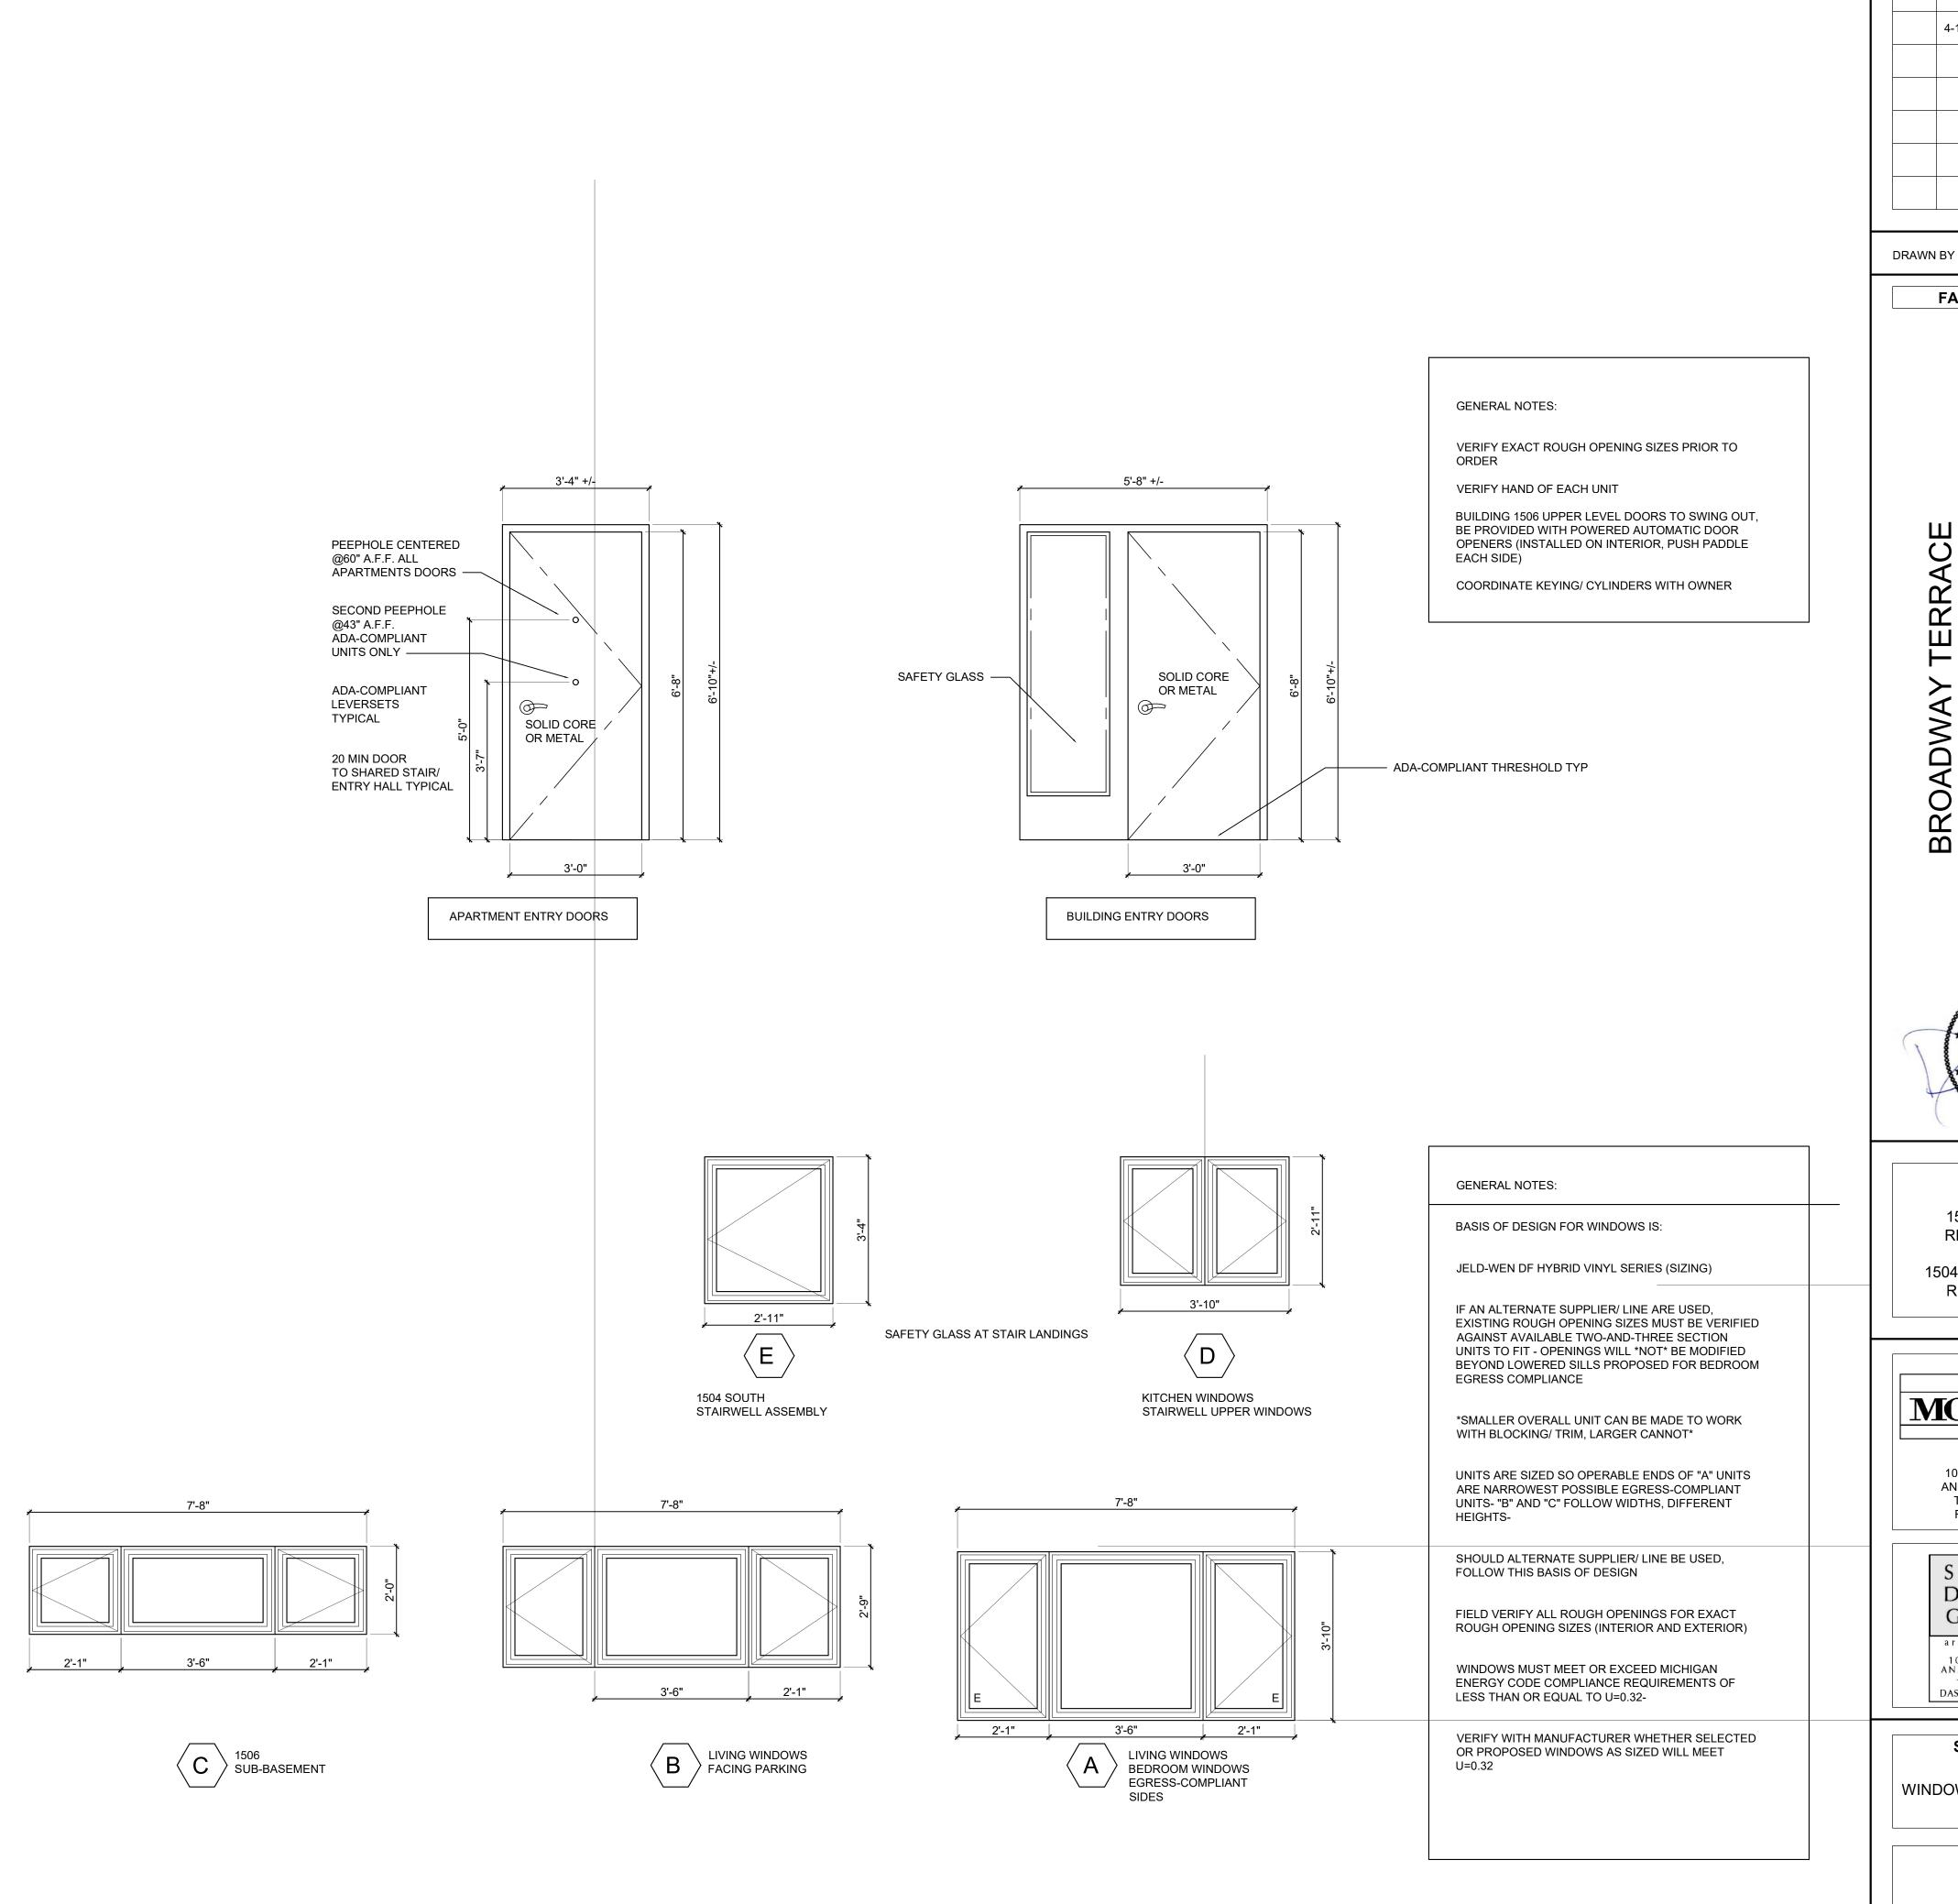
architecture - plc 106 S. MAIN STREET ANN ARBOR, MI 48104 TEL 734.604.8833 DASONNTAG@GMAIL.COM

SHEET TITLE

1508

EXTERIOR ELEVATIONSPROPOSED ALTERATIONS

A3.21



No. Date Description

12.04.23 Cost Est.

4-12-24 PERMIT

DRAWN BY DAS/ ARG

FACILITY/CLIENT

BROADWAY TERRACE 1504-1506-1508 BROADWAY STREE⁻ ANN ARBOR, MI 48105



PROJECT

1504-1506-1508 REPLACEMENT WINDOWS 1504-1506 INTERIOR RENOVATIONS




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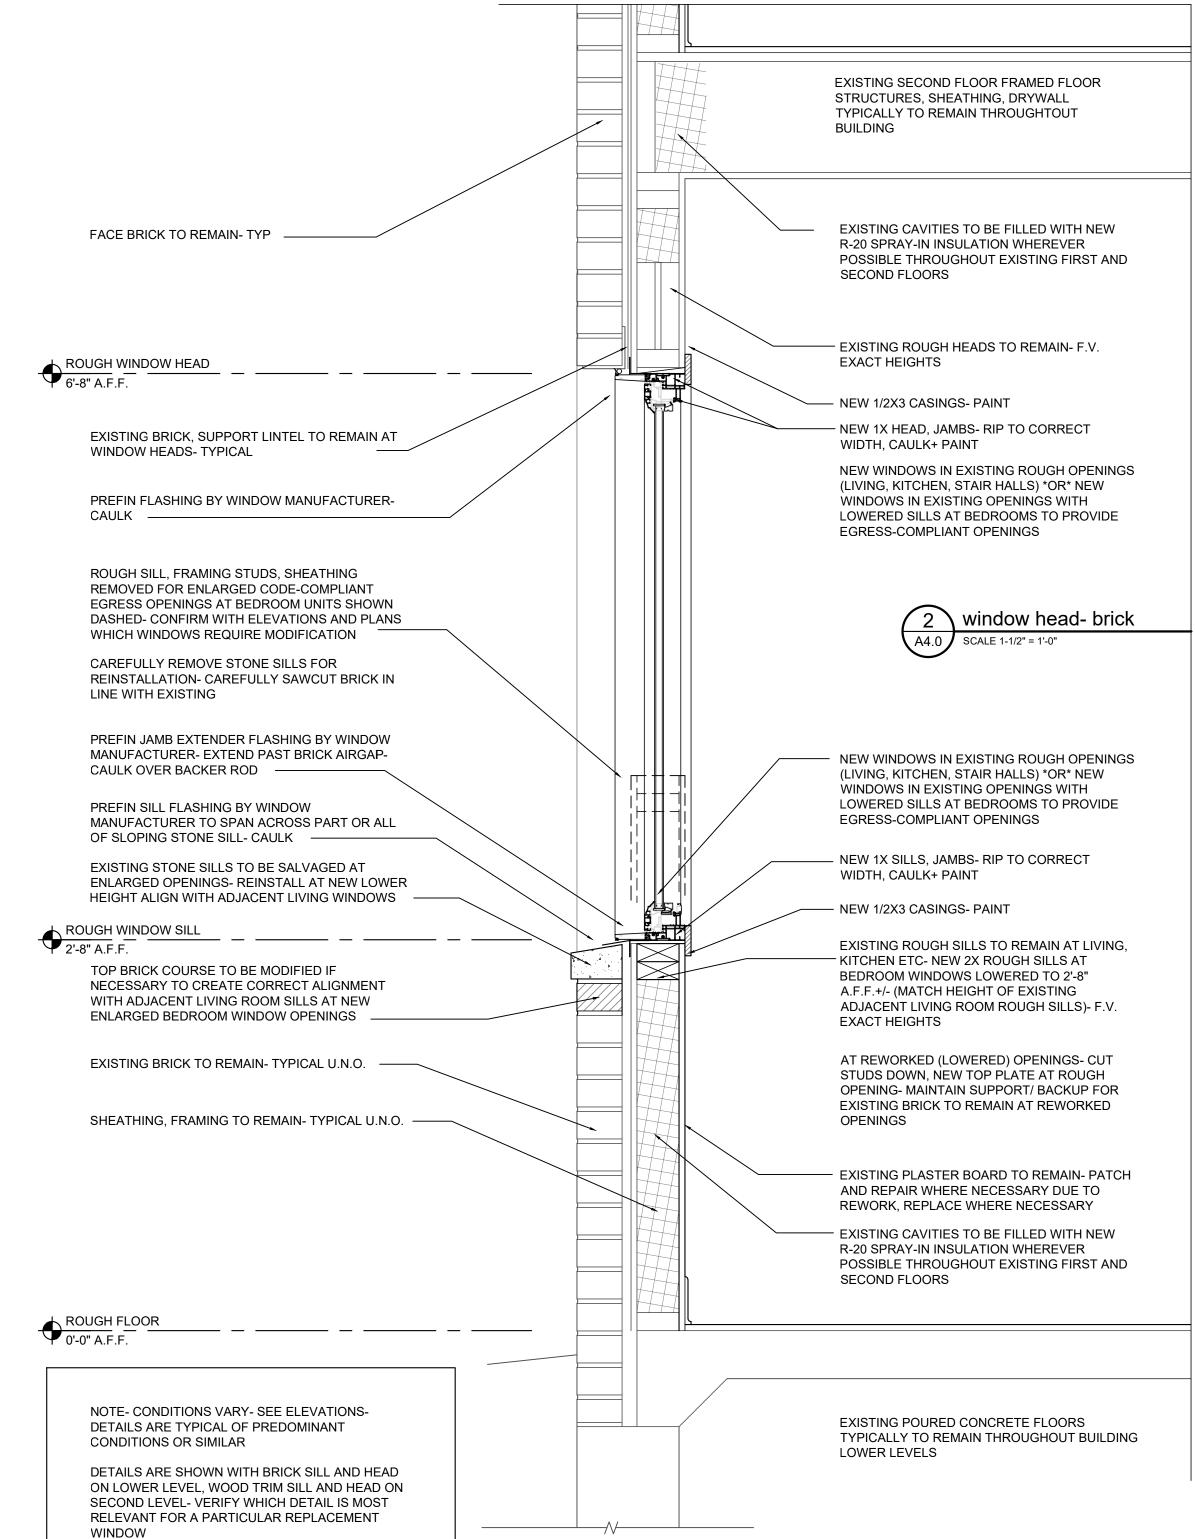
SONNTAG Design Group

architecture - plc 106 S. MAIN STREET ANN ARBOR, MI 48104 TEL 734.604.8833 DASONNTAG@GMAIL.COM

SHEET TITLE

WINDOW AND DOOR INFO



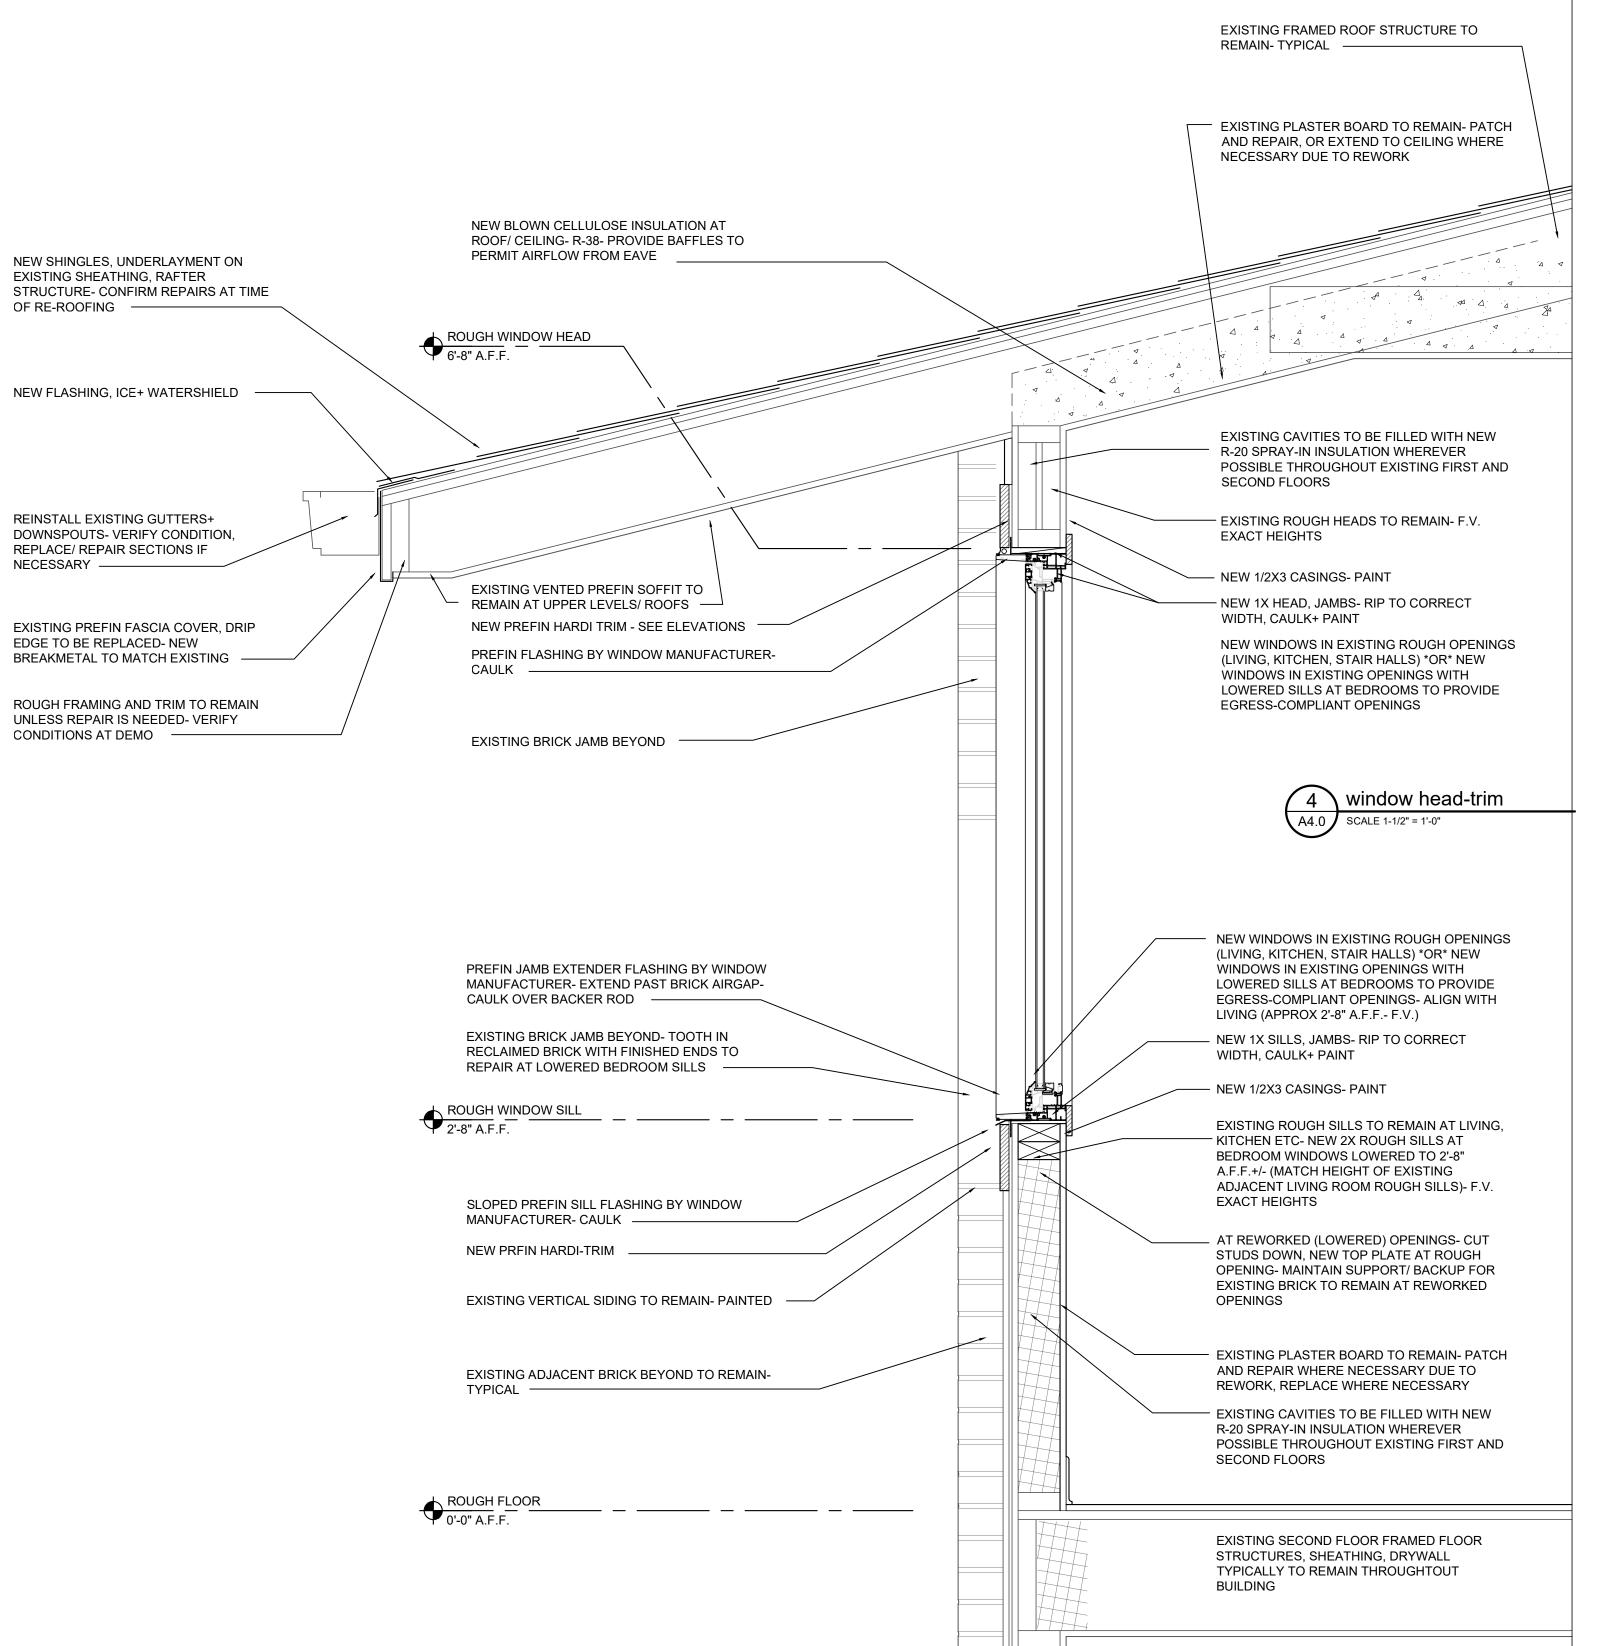

No. Date Description 12.04.23 PERMIT 4-12-24

DAS/ ARG DRAWN BY

FACILITY/CLIENT

IR



PROJECT

1504-1506-1508 REPLACEMENT WINDOWS 1504-1506 INTERIOR RENOVATIONS



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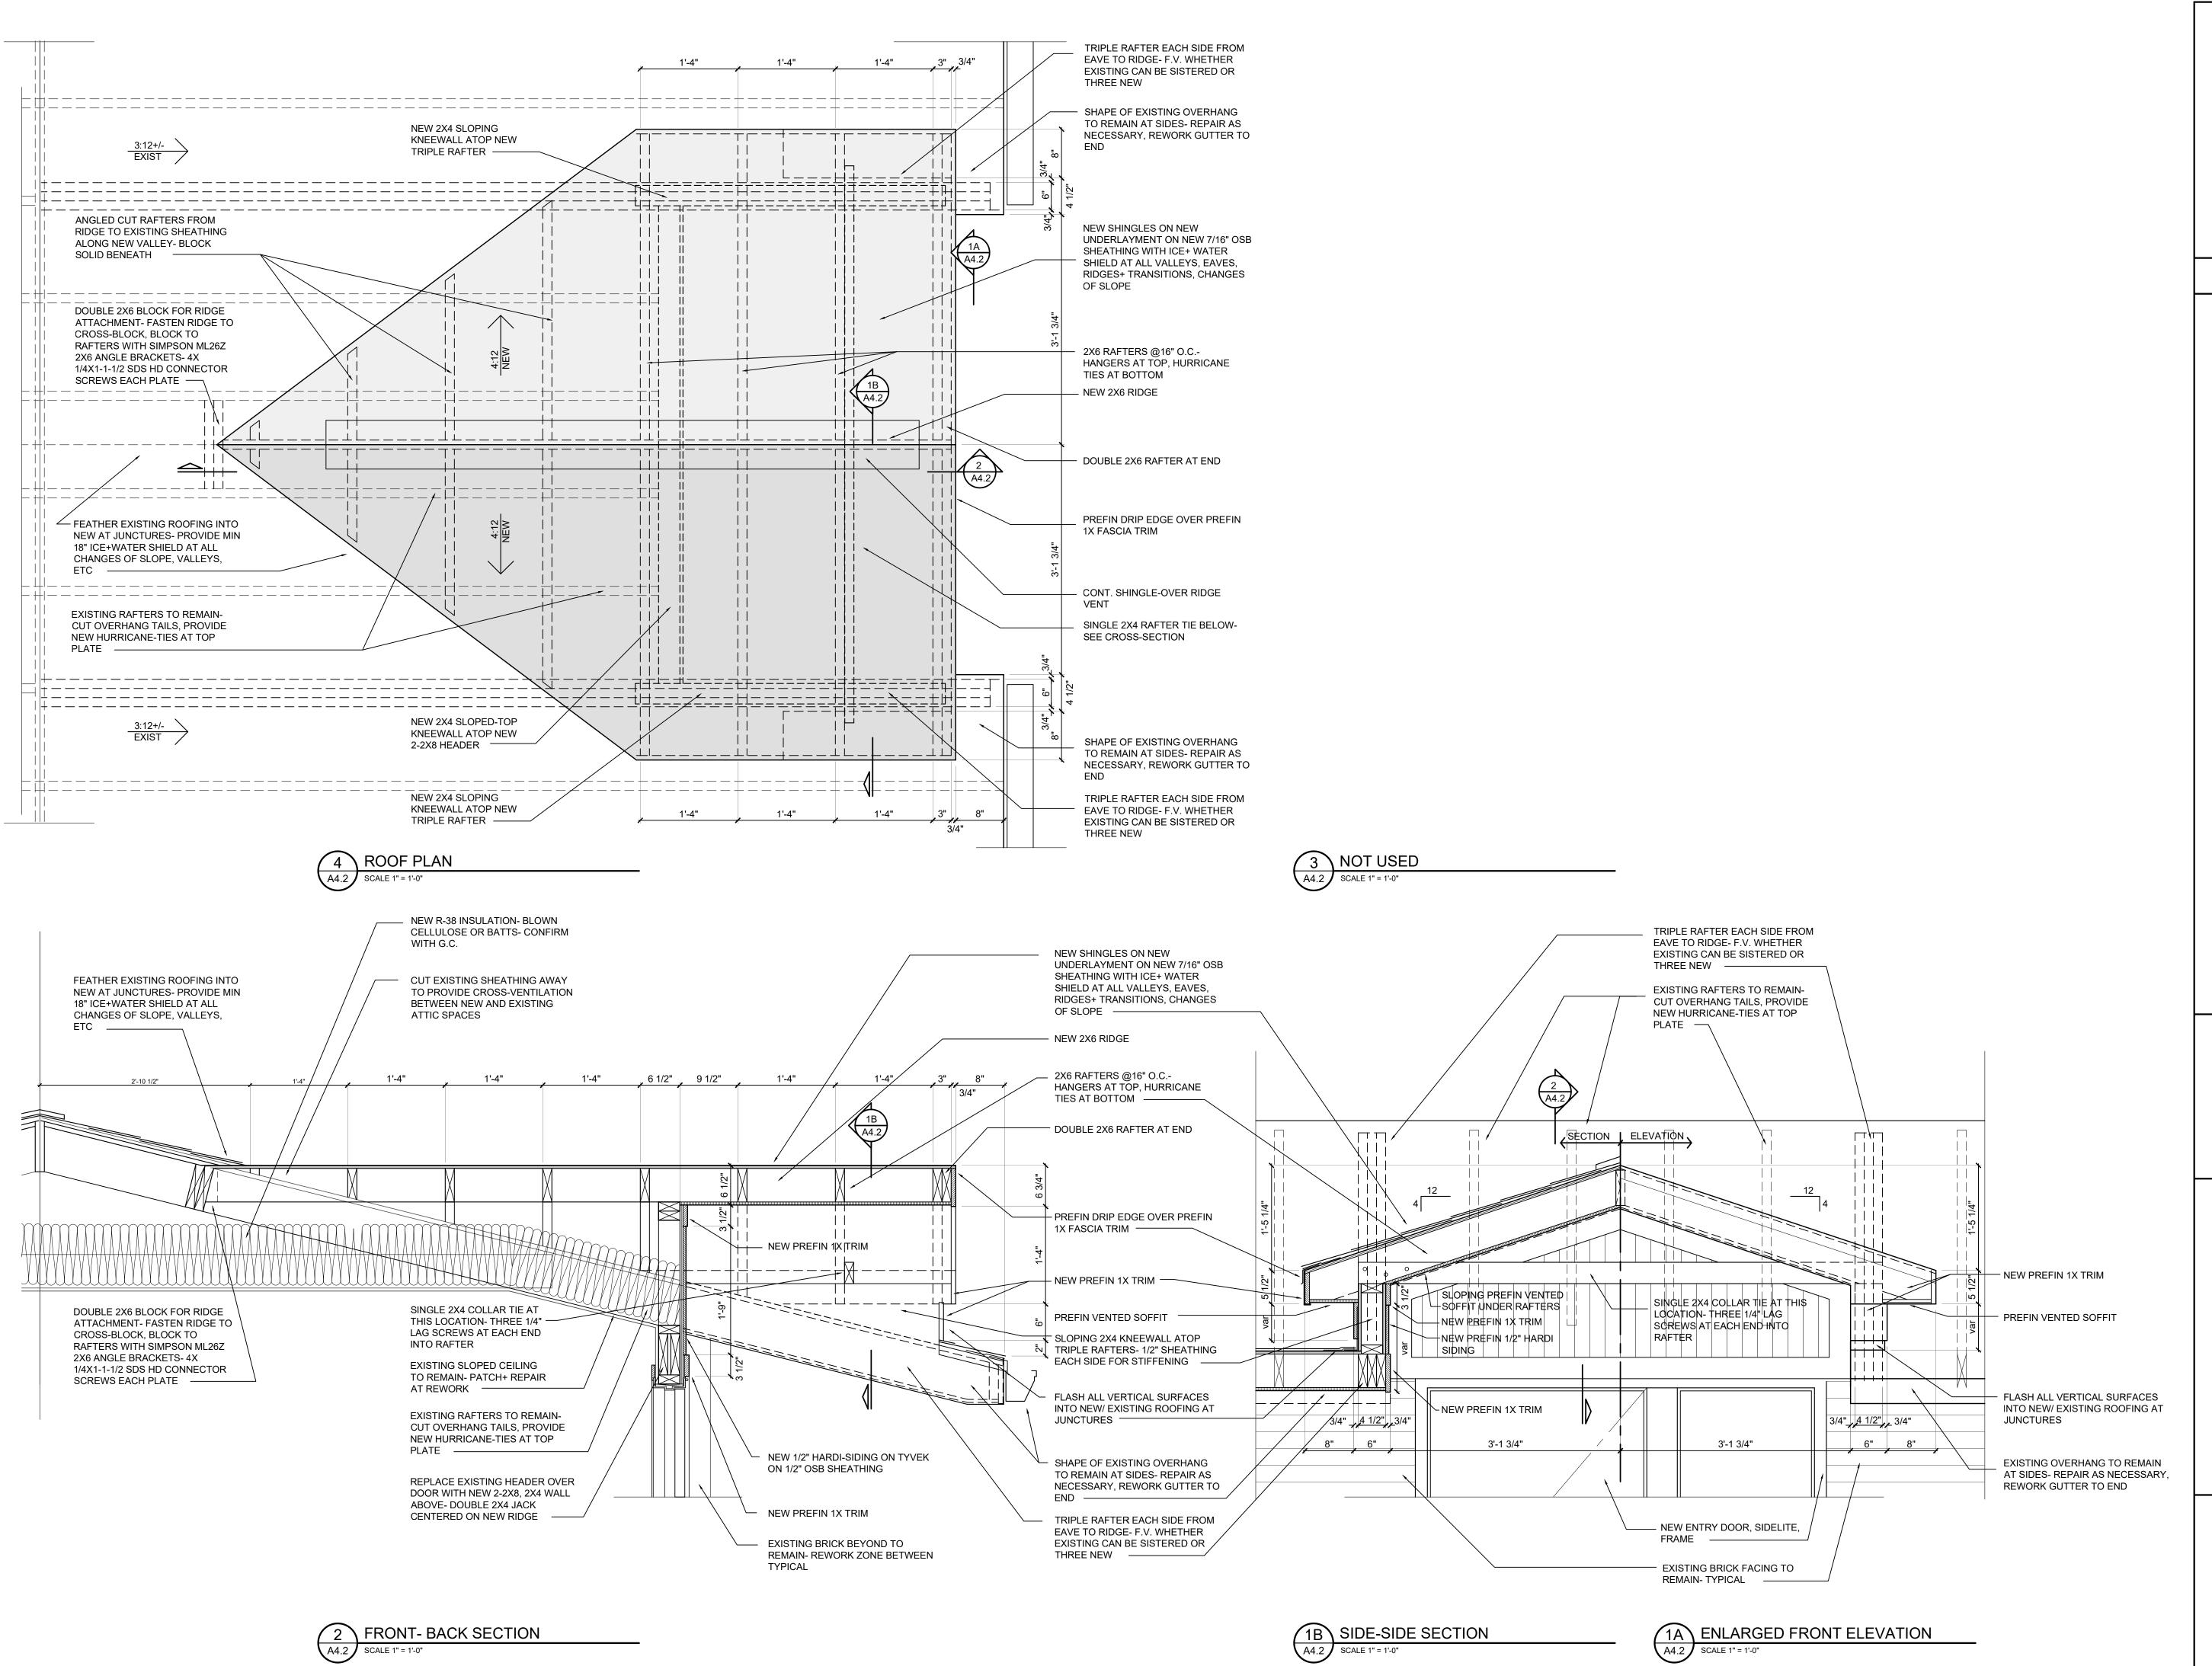
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SHEET TITLE

WALL SECTIONS





No. Date Description

12.04.23 Cost Est.

4-12-24 PERMIT

DRAWN BY DAS/ ARG

FACILITY/CLIENT

BROADWAY TERRACE 504-1506-1508 BROADWAY STREET ANN ARBOR, MI 48105



PROJECT

1504-1506-1508 REPLACEMENT WINDOWS 1504-1506 INTERIOR RENOVATIONS




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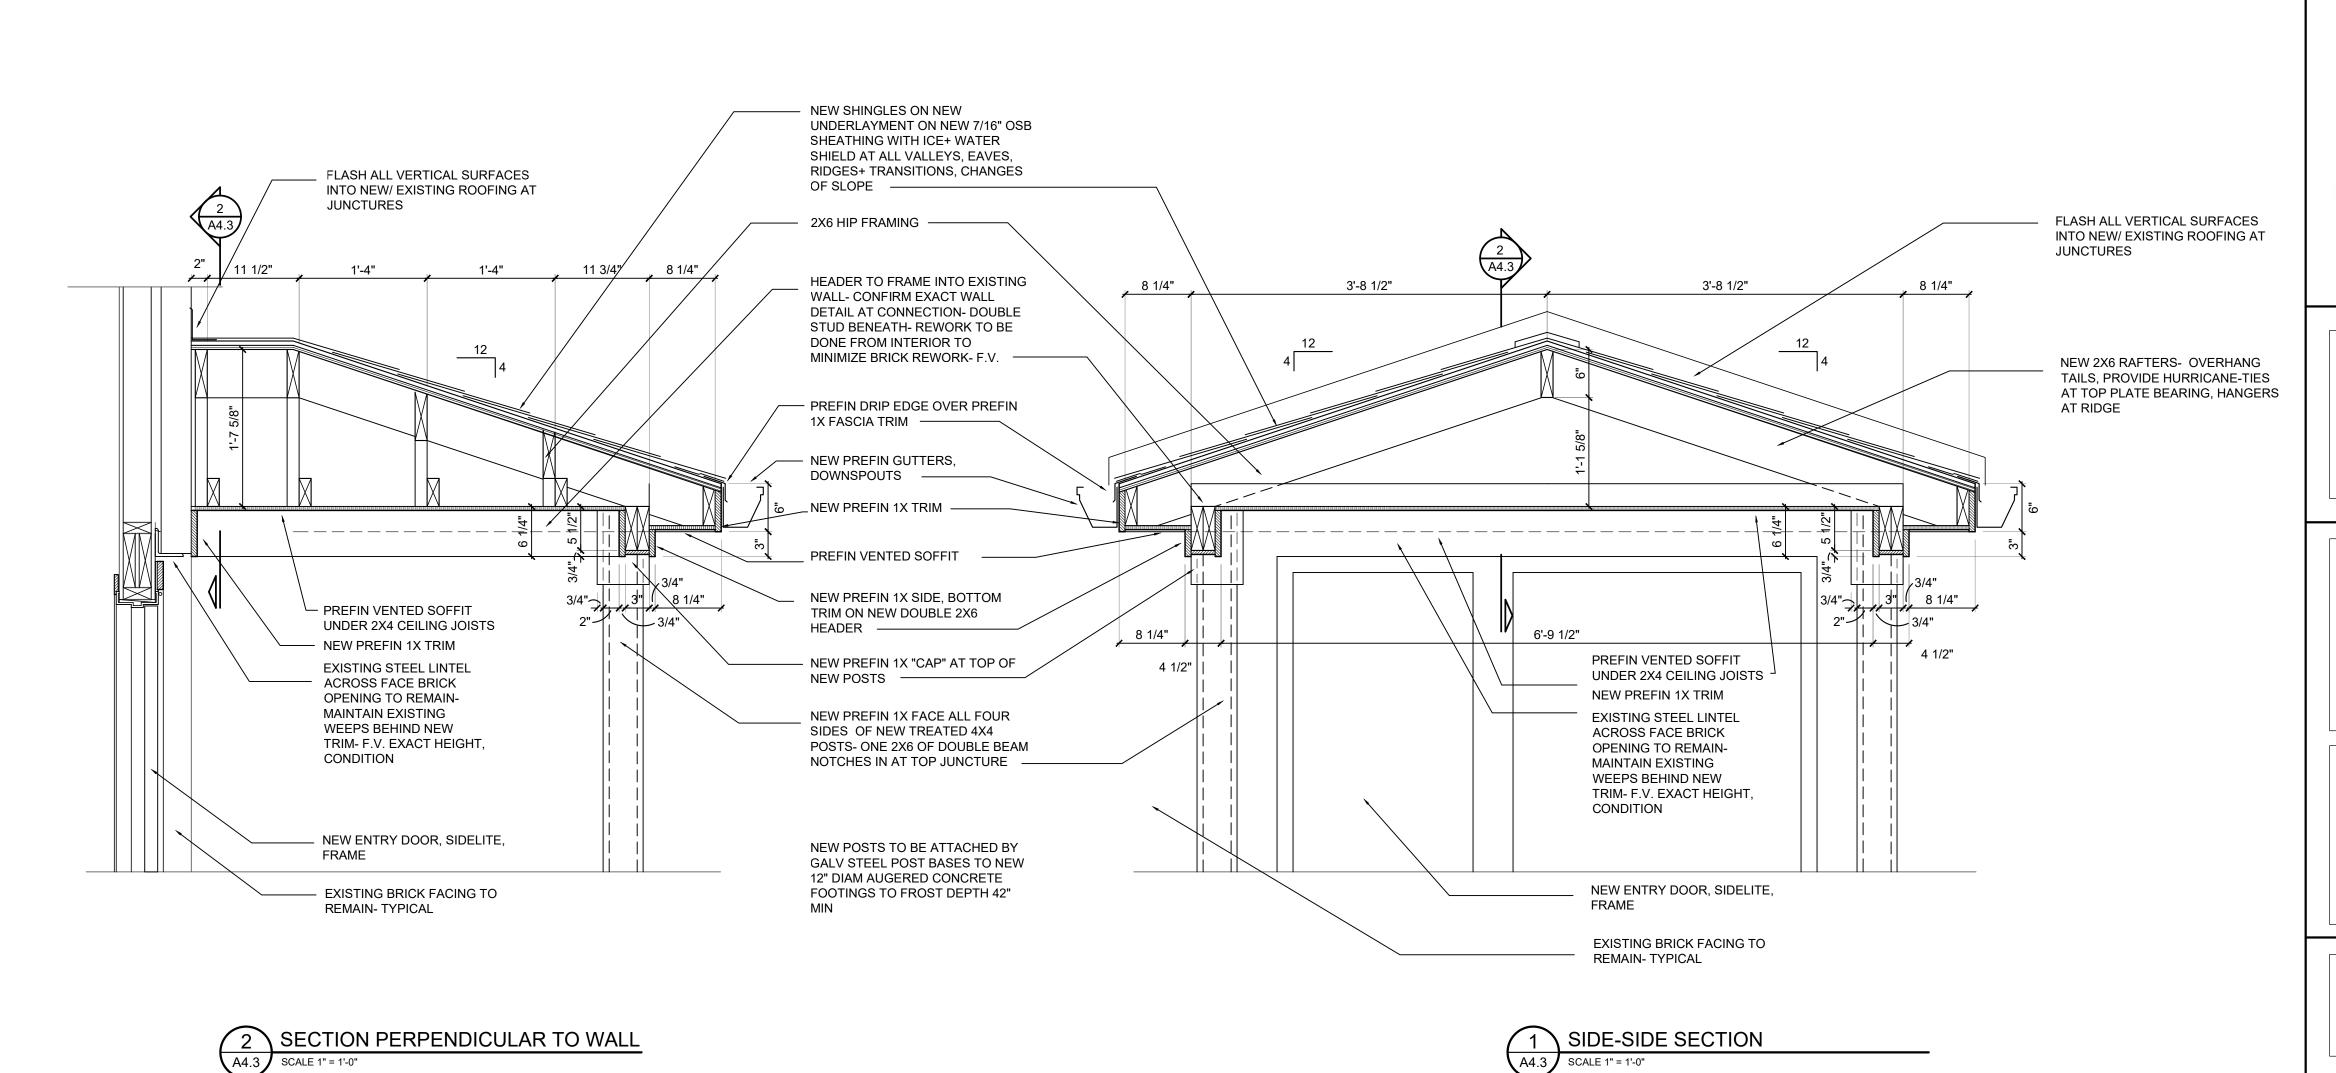
SONNTAG DESIGN GROUP


architecture - plc 106 S. MAIN STREET ANN ARBOR, MI 48104 TEL 734.604.8833 DASONNTAG@GMAIL.COM

SHEET TITLE

SOFFIT REWORK AT ENTRY



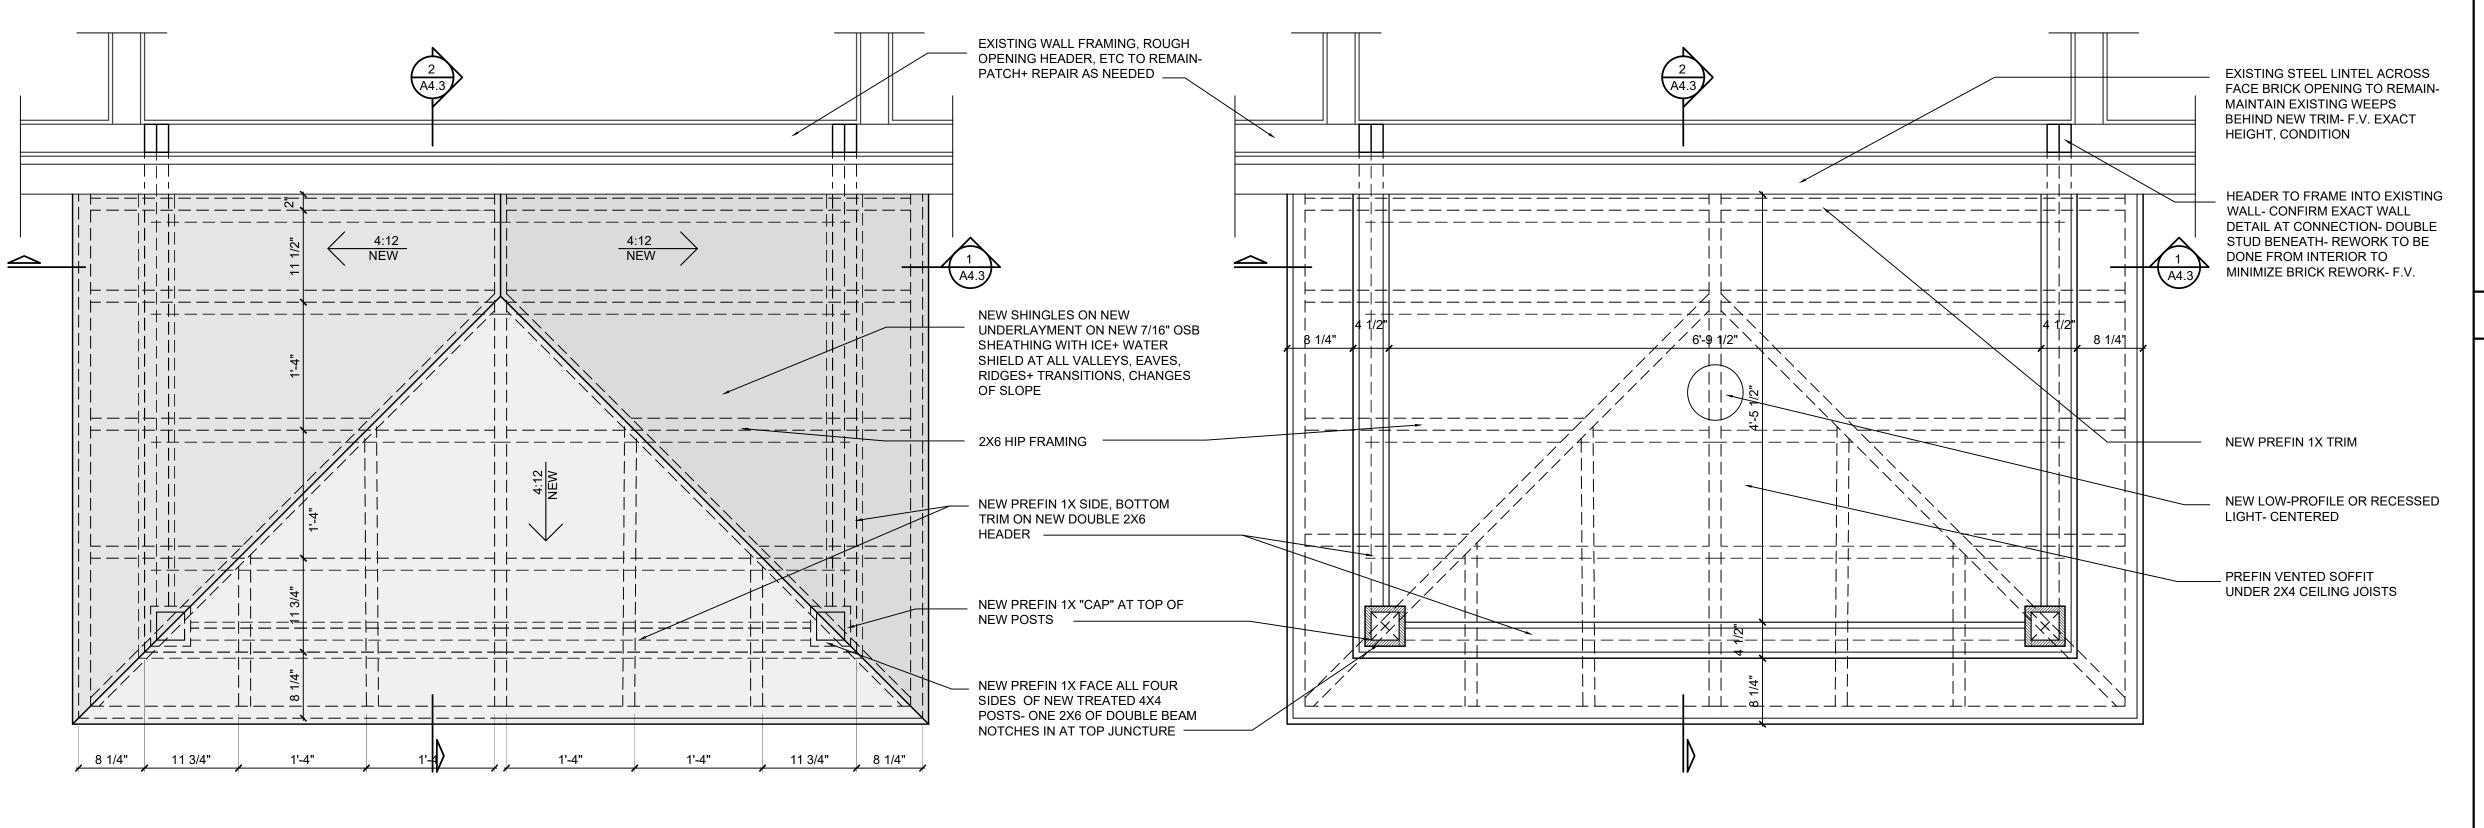

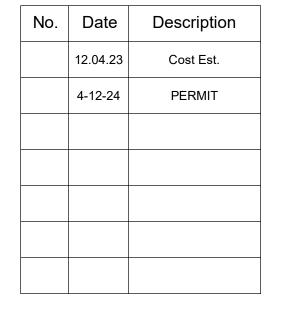

DRAWN BY DAS/ ARG

FACILITY/CLIENT

OADWAY TERRACE -1508 BROADWAY STREE IN ARBOR, MI 48105

OF MICHIECT

DANIELA G

SONNTAG

ARCHITECT

NO.
1301041258

PROJECT

1504-1506-1508

REPLACEMENT

WINDOWS

1504-1506 INTERIOR

RENOVATIONS

MOMUS

106 S. MAIN STREET

ANN ARBOR, MI 48104

TEL. 734.998.0098

S O N N T A G
D E S I G N

GROUP

architecture - plc


106 S. MAIN STREET
ANN ARBOR, MI 48104


TEL 734.604.8833
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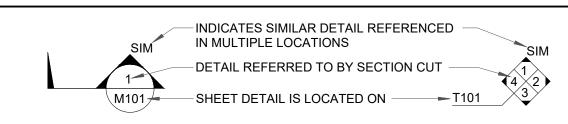
SHEET TITLE

1506 SOUTH ENTRY DETAIL

A4.3



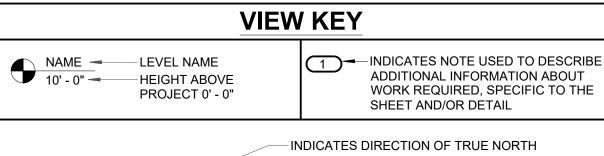

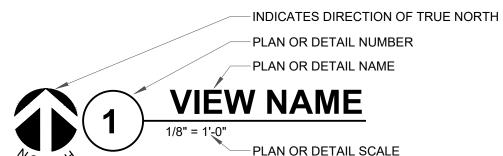

LINE TYPE AND TAG KEY:

NEW WORK BY THIS CONTRACTOR (BOLD, WIDE LINE) NEW

NEW UNDERFLOOR, UNDERGROUND, OR ABOVE (LONG DASHED PATTERN)

EXISTING TO REMAIN OR WORK BY OTHERS (GREY, NARROW LINE) - EXISTING

EXISTING UNDERFLOOR, UNDERGROUND, OR ABOVE (LONG DASHED PATTERN)

HALFTONING DOES NOT MODIFY SCOPE.

V.C. VENTILATION CONTRACTOR


'TAG' (E) TAGS WITH '(E)' INDICATES THE REFERENCED OBJECT IS EXISTING 'TAG' (R) TAGS WITH '(R)' INDICATES THE REFERENCED OBJECT IS RELOCATED

UNDERLINED TEXT INDICATES ADDITIONAL INFORMATION CAN BE FOUND ELSEWHERE IN A SCHEDULE, MATERIAL LIST, OR SYMBOL LIST

INDICATES AN EXISTING SYSTEM'S POINT OF CONNECTION/REMOVAL

CONTRACTOR ABBREVIATION KEY

-	
ABBR:	DESCRIPTION:
A.C.	ASBESTOS ABATEMENT CONTRACTOR
A.V.C.	AUDIO/VISUAL CONTRACTOR
C.C.	CIVIL CONTRACTOR
C.M.	CONSTRUCTION MANAGER
E.C.	ELECTRICAL CONTRACTOR
F.P.C.	FIRE PROTECTION CONTRACTOR
F.S.C.	FOOD SERVICE CONTRACTOR
G.C.	GENERAL CONTRACTOR
H.C.	HEATING CONTRACTOR
M.C.	MECHANICAL CONTRACTOR
N.C.C.	NURSE CALL CONTRACTOR
P.C.	PLUMBING CONTRACTOR
S.C.	SECURITY CONTRACTOR
TAB	TESTING AND BALANCING CONTRACTOR
T.C.	TECHNOLOGY CONTRACTOR
T.C.C.	TEMPERATURE CONTROLS CONTRACTOR

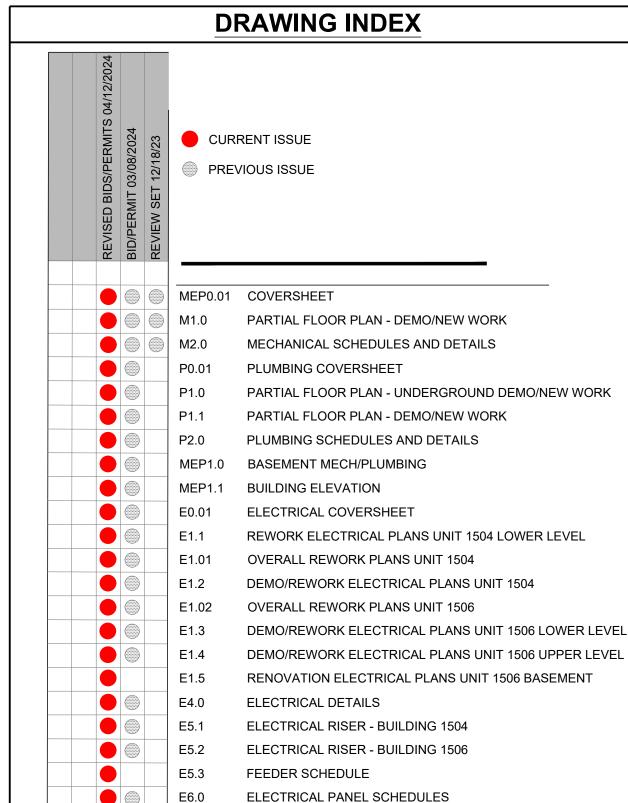

PROJECT DESCRIPTION

THIS IS PROJECT INVOLVES MECHANICAL, ELECTRICAL, AND PLUMBING SCOPE ASSOCIATED WITH EQUIPMENT REPLACEMENTS, ADDITION OF AIR CONDITIONING, LIGHTING REPLACEMENET LIGHTING REPLACEMENT AND RECEPTACLE RELOCATION, BATHROOM REMODEL, ADDITIONAL OF SOLAR ARRAYS, AND ELECTRICAL SERVICE REWORK TO UPGRADE COMPONENTS AND ACCOUNT FOR OTHER SCOPE INCLUDING SOLAR. EXISTING NATURAL GAS FURNACES AND NATURAL GAS TANK WATER HEATERS, WILL BE REPLACED WITH HIGH EFFICIENCY GAS FURNACES AND ELECTRIC TANK WATER HEATERS. ELECTRICAL UTILITY SERVICES WILL ALSO BE INCREASED/MODIFIED TO ACCOMMODATE ESTIMATED LOADS FOR FUTURE FULL ELECTRIFICAITON OF THE BUILDING.

PROJECT DIRECTORY

OWNER: **ANN ARBOR HOUSING** PROJECT MANAGER: DARREN MCKINNON (734) 904-5044 FMAII DMCKINNON@DMC-RES.COM **ENGINEER:** 201 S. ANN ARBOR ST SALINE, MI 48176-1303 PROJECT ENGINEER: DALE W. NIETHAMMER CELL: (734) 678-2605 DALE.W.NIETHAMMER@IMEGCORP.COM EMAIL: PROJECT DESIGNER: RYAN M. O'QUINN (734) 657-1852 RYAN.M.OQUINN@IMEGCORP.COM **EMAIL** ARCHITECT: SONNTAG DESIGN GROUP 106 S. MAIN ST. ANN ARBOR, MI 48104 LEAD ARCHITECT: DAN SONNTAG (734) 998-0098 CELL: DAN@MOMUSINC.COM EMAIL:

APPLICABLE CODES

CONTRACTOR SHALL COMPLY WITH APPLICABLE CODES AND LOCAL AMENDMENTS.

MICHIGAN BUILDING CODE/2015

BUILDING CODE:

MECHANICAL CODE:

MICHIGAN MECHANICAL CODE/2021

PLUMBING CODE:

MICHIGAN PLUMBING CODE/2021

ELECTRICAL CODE:

MICHIGAN ELECTRICAL CODE/2017

FIRE PREVENTION CODE:

APPLICABLE CITY OF ANN ARBOR RULES AND REGULATIONS

HAZARDOUS MATERIALS NOTE

NFPA FIRE CODE/2015

THIS PROJECT AREA MAY CONTAIN HAZARDOUS MATERIALS. IF THE CONTRACTOR SHOULD ENCOUNTER ANY ITEMS SUSPECTED TO CONTAIN ASBESTOS, LEAD, OR MERCURY, CONTACT THE PROJECT CONSTRUCTION MANAGER IMMEDIATELY FOR DIRECTION. DO NOT DISTURB THE MATERIAL IN ITS LOCATION. PROJECT CONSTRUCTION MANAGER SHALL COORDINATE REMOVAL OF ANY ITEMS SUSPECTED OF CONTAINING HAZARDOUS MATERIALS. REMOVAL OF HAZARDOUS MATERIALS SHALL BE IN ACCORDANCE WITH EPA REQUIREMENTS AS WELL AS REQUIREMENTS OF ANY OTHER AGENCIES WITH JURISDICTION OVER SUCH WORK.

SPECIFICATIONS:

PIPING MATERIALS

- NATURAL GAS PIPINO PIPING: BLACK STEEL, SCHEDULE 40, ASTM A53, ERW OR SEAMLESS, GRADE B. FITTINGS: MALLEABLE IRON, 150 LB ASTM A197; UNIONS, 250 LB ASTM A197.
- JOINTS: SCREWED DOMESTIC COLD WATER, HOT WATER - ABOVE GROUND (INCLUDING NON-POTABLE): PIPE: TYPE L COPPER, HARD DRAWN, ASTM B88

FITTINGS: WROUGHT COPPER, ANSI B16.22

- JOINTS: SOLDERED THROUGH 2"
- POTABLE (COLD) WATER 1/2" FIBERGLASS INSULATION WITH FACTORY-APPLIED VAPOR BARRIER JACKET WITH SELF-SEALING LAPS. POTABLE (HOT) WATER (2" AND LESS) 1" FIBERGLASS INSULATION WITH

FACTORY-APPLIED VAPOR BARRIER JACKET WITH SELF-SEALING LAPS.

REFRIGERANT PIPING INSULATION REFRIGERANT PIPING SYSTEMS WITH 5/8" FLEXIBLE CLOSED CELL ELASTOMERIC

INSULATION, ASTM C534, CONDUCTIVITY OF 0.254 @90F, WATER VAPOR PERMEABILITY OF 0.05. COMPOSITE FLAME SPREAD/SMOKE DENSITY OF 25/50. APPROVED MANUFACTURERS: ARMACELL - AP ARMAFLEX 1. SEAL ALL BUTT JOINTS AND SEAMS BY JOINING CUT EDGES WITH ADHESIVE AS

SUPPLIED BY THE INSULATION MANUFACTURER. 2. FOR EXTERIOR PIPING, COAT INSULATION WITH GLASS MESH AND TWO FINISH COATS COMPATIBLE WITH INSULATION.

DUCTWORK MATERIALS

- GALVANIZED STEEL. ASTM A653, A924 MILL GALVANIZED STEEL SHEET PER SMACNA. DUCTS SHALL BE LEAK TESTED PER SMACNA'S BEFORE INSULATED AND SHALL NOT EXCEED LEAKAGE CLASS 3. RESEAL AND RETEST AS REQUIRED TO ACHIEVE LEAKAGE
- ALL DUCTWORK SEALANT SHALL BE NON-ASBESTOS TYPE AND COMPLY WITH UL AND
- 1 1/2" THICK, BLANKET TYPE, FIBERGLASS WITH FACTORY APPLIED VAPOR BARRIER, AND 2" STAPLING AND TAPING FLANGE ALONG ONE EDGE. ASTM C553, DENSITY OF 0.75,
- CONDUCTIVITY OF 0.23 @75F VAPOR BARRIER: LAMINATED WHITE KRAFT PAPER, ALUMINUM FOIL, GLASS FIVER REINFORCEMENT, PERMEANCE OF 0.02, AND PUNCTURE RESISTANCE OF 50 UNITS. COMPOSITE FLAME SPREAD/SMOKE DENSITY OF 25/50.

GENERAL NOTES:

- 1. ALL WORK MUST COMPLY WITH THE REQUIREMENTS OF LOCAL CODES AND ORDINANCES. WHERE INSPECTIONS ARE REQUIRED BY AUTHORITIES HAVING JURISDICTION, WORK WILL NOT BE CONSIDERED COMPLETE UNTIL TESTED, INSPECTED, AND ACCEPTED.
- 2. DRAWINGS ARE BASED ON AVAILABLE DOCUMENTS, SITE INSPECTION AND DESIGN EXPERIENCE. DRAWINGS MAY NOT REFLECT A COMPLETE AS BUILT CONDITION.
- 3. DRAWINGS DIAGRAMMATICALLY INDICATE THE GENERAL WORK SCOPE BUT DO NOT PROVIDE EXACT SCALE OR LOCATIONS. PROPER INSTALLATION OF ALL SYSTEMS, AFTER COORDINATION WITH OTHER TRADES, IS THE CONTRACTORS RESPONSIBILITY.
- 4. FIELD ROUTE DUCTWORK TO AVOID INTERFERENCE, AND ALLOW ADEQUATE CLEARANCES FOR ACCESS AND MAINTENANCE.
- 5. ALL CONTRACTORS TO REVIEW DRAWINGS AND SPECIFICATIONS TO UNDERSTAND THE SCOPE OF WORK FOR THEIR DISCIPLINE.
- 6. REFER TO CONTRACT DOCUMENTS AND PROJECT SPECIFICATIONS FOR ADDITIONAL SCOPE AND INFORMATION.
- 7. CONTRACTOR SHALL USE BID WALK-THROUGH AND FIELD OBSERVATIONS TO ENHANCE PROJECT UNDERSTANDING BEFORE BIDDING ON PROJECT.
- 8. NO DEMOLITION SHALL TAKE PLACE WITHOUT APPROVAL FROM THE OWNER'S
- REPRESENTATIVE.
- MINIMUM 24 HOURS IN ADVANCE. 10. TEMPORARY REMOVAL OF ANY AND ALL EXISTING MISCELLANEOUS ITEMS (I.E. CONDUIT, SMALL PIPING, LIGHTING, ETC.) FOR THE PURPOSE OF PERFORMING THIS

WORK SHALL BE REINSTALLED BACK TO PRE-CONSTRUCTION LEVEL AS PART OF THIS

9. ALL UTILITY SHUTDOWNS ARE TO BE SCHEDULED WITH OWNER'S REPRESENTATIVE

- PROJECT. NO ADDITIONAL FEES WILL BE AWARDED. 11. CONTRACTOR TO TEMPORARILY SUPPORT ALL DUCTWORK AND PIPING DURING THE **DEMOLITION AND CONSTRUCTION PHASES**
- 12. CONTRACTOR TO PROTECT ALL PIPING, PIPE INSULATION, CONDUITS, AND OTHER MISCELLANEOUS ITEMS DURING THE DEMOLITION PHASE. ANY DAMAGE RESULTING FROM THE CONTRACTOR'S OPERATIONS MUST BE REPAIRED OR REPLACED WITH
- 13. MAINTAIN SECURITY, LIFE SAFETY, FIRE AND SMOKE CONSTRUCTION INTEGRITY, FIRE ESCAPES AND EGRESS PATHS AT ALL TIMES.
- 14. PROVIDE ALL REQUIRED ACCESSORIES, INCLUDING MISCELLANEOUS SUPPORT STEEL, REQUIRED FOR PROPER INSTALLATION.

EQUAL AND TO THE OWNER'S SATISFACTION AND AT NO ADDITIONAL COST.

- 15. THE CONTRACT DOCUMENTS REFLECT A SYSTEM DESIGNED AROUND BASE BID PRODUCTS. IF ALTERNATE PRODUCTS ARE SPECIFIED, CONTRACTOR MUST COORDINATE ALL DIFFERENCES, AND INCLUDE ASSOCIATED INSTALLATION COST DIFFERENCES, TO ENSURE NO ADDITIONAL COST TO THE OWNER.
- 16. UNLESS OTHERWISE SHOWN ON CONSTRUCTION DOCUMENTS OR SPECIFIED HEREIN. PRODUCTS USED IN THE WORK SHALL BE INSTALLED IN ACCORDANCE WITH THE MANUFACTURER'S INSTALLATION INSTRUCTIONS AND RECOMMENDATIONS. ANY CHANGES OR MODIFICATIONS PROPOSED WHICH ARE BELIEVED TO IMPROVE THE INSTALLATION SHALL BE APPROVED BY THE OWNER AND/OR ITS REPRESENTATIVE.
- 17. CONTRACTOR WILL BE RESPONSIBLE FOR PROVIDING A COMPLETE AND WORKING SYSTEM.
- 18. CONTRACTOR IS RESPONSIBLE FOR FINAL CLEANING OF PROJECT AREA(S).
- 19. CONTRACTOR SHALL PROVIDE SUBMITTALS ON ALL EQUIPMENT FOR APPROVAL BEFORE PURCHASING.
- 20. PROTECT BUILDING FROM DUST MIGRATION USING APPROPRIATE SEALED BARRIERS TO SEPARATE AND SEGREGATE CONSTRUCTION AREAS FROM ACTIVE TENANT AREAS INCLUDING SHARED CEILING PLENUMS AND MECHANICAL SYSTEMS.

MECHANICAL GENERAL NOTES:

THESE NOTES APPLY TO ALL MECHANICAL SHEETS AND TRADES, INCLUDING BUT NOT LIMITED TO PLUMBING, VENTILATION, AND TEMPERATURE CONTROL.

- DRAWINGS SHOWING LOCATIONS OF EQUIPMENT, DUCTWORK, PIPING, ETC. ARE DIAGRAMMATIC AND MAY NOT ALWAYS REFLECT EXACT INSTALLATION CONDITIONS. DRAWINGS SHOW THE GENERAL ARRANGEMENT OF DUCTWORK, PIPING, EQUIPMENT, ETC., AND MAY NOT INCLUDE ALL OFFSETS AND FITTINGS REQUIRED FOR COMPLETE
- INSTALLATION. THE DRAWINGS SHALL BE FOLLOWED AS CLOSELY AS ACTUAL BUILDING CONSTRUCTION AND THE WORK OF OTHERS WILL PERMIT.
- DO NOT SCALE DRAWINGS. VERIFY ALL DIMENSIONS AND CLEARANCES FROM ARCHITECTURAL, STRUCTURAL, SUBMITTALS, AND OTHER APPROPRIATE DRAWINGS OR PHYSICALLY AT SITE. REVIEW ALL DRAWINGS, INCLUDING THOSE OF OTHER TRADES. COORDINATE ALL WORK WITH ALL OTHER TRADES PRIOR TO INSTALLATION TO PROVIDE CLEARANCES REQUIRED FOR OPERATION, MAINTENANCE, CODE COMPLIANCE, AND TO VERIFY NON-INTERFERENCE WITH OTHER WORK. DO NOT FABRICATE PRIOR TO
- OR CONFLICTS TO THE ATTENTION OF THE ARCHITECT/ENGINEER BEFORE PROCEEDING WITH FABRICATION OR EQUIPMENT ORDERS. REVIEW SPACE REQUIREMENTS OF EQUIPMENT SPECIFIED OR SUBSTITUTED AND MAKE REASONABLE ACCOMMODATIONS IN LAYOUT AND POSITIONING TO PROVIDE PROPER

VERIFICATION OF NECESSARY CLEARANCES FOR ALL TRADES. BRING ANY INTERFERENCES

- ACCESS. ANY CHANGES REQUIRED TO ELIMINATE CONFLICTS OR THAT RESULT FROM A FAILURE TO COORDINATE SHALL BE MADE BY THE CONTRACTOR WITHOUT ADDITIONAL COST OR
- EXPENSE TO OTHERS. EACH CONTRACTOR IS RESPONSIBLE FOR ALL COSTS ASSOCIATED WITH ELECTRICAL CHANGES REQUIRED FOR EQUIPMENT PROPOSED THAT DIFFERS FROM THE BASIS OF
- EACH CONTRACTOR IS RESPONSIBLE FOR DAMAGE CAUSED BY THEIR ACTIONS TO WALLS, FLOORS, CEILINGS, AND ROOFS. THE CONTRACTOR WHOSE WORK CAUSES DAMAGE IS
- RESPONSIBLE FOR PATCHING TO MATCH ORIGINAL CONSTRUCTION, FIRE RATING, AND
- SEAL ALL WALL, AND ROOF PENETRATIONS AIRTIGHT WHERE CONDUITS, PIPING, AND DUCTS PENETRATE. PENETRATIONS THROUGH EXTERIOR WALLS AND ROOF SHALL BE SEALED AIRTIGHT WITH WATERPROOFING MATERIALS RECOMMENDED BY MANUFACTURER FOR OUTDOOR USE.
- CAULK ALL PIPE AND DUCT PENETRATIONS OF FULL HEIGHT NON-FIRE RATED WALL, PARTITION, FLOOR, AND ROOF ASSEMBLIES. THIS IS ESSENTIAL TO PREVENT NOISE
- TRANSMISSION FROM ONE ROOM TO ANOTHER AND TO PROVIDE THE DESIRED NC LEVELS WITHIN ROOMS. EQUIPMENT SIZES AND SERVICE CLEARANCE REQUIREMENTS VARY AMONG DIFFERENT
- MANUFACTURERS. CONSULT APPROVED SHOP DRAWINGS FOR EQUIPMENT SIZES AND REQUIRED SERVICE CLEARANCES. COORDINATE WITH LAYOUT OF EQUIPMENT PADS, PIPING. DUCTWORK, ETC.
- 12. DO NOT BLOCK TUBE PULL OR EQUIPMENT SERVICE CLEARANCES.

MECHANICAL RENOVATION NOTES:

THESE NOTES APPLY TO ALL MECHANICAL SHEETS AND TRADES, INCLUDING BUT NOT LIMITED TO PLUMBING, VENTILATION, AND TEMPERATURE CONTROL.

- EXISTING CONDITIONS ARE SHOWN BASED ON INFORMATION OBTAINED FROM FIELD SURVEYS, EXISTING BUILDING DOCUMENTS, AND STAFF. VERIFY EXISTING CONDITIONS AND
- REPORT ANY CONFLICTS BEFORE PROCEEDING. NOT ALL EXISTING DUCTWORK AND PIPING IS SHOWN. VERIFY EXISTING CONDITIONS
- BEFORE STARTING WORK. NOTIFY ENGINEER OF ANY CONFLICTS WITH NEW WORK. FIELD VERIFY THE AVAILABLE CLEARANCES FOR DUCTWORK AND PIPING BEFORE FABRICATION, RISES AND DROPS MAY BE NECESSARY BECAUSE OF EXISTING FIELD CONDITIONS.
- EACH CONTRACTOR SHALL FIELD VERIFY ACCESSIBILITY TO THE AREA OF HIS/HER WORK AND SHALL NOTIFY THE GC PRIOR TO BIDDING IF OTHER UTILITIES ARE REQUIRED TO BE REMOVED OR RELOCATED TO ALLOW ACCESS TO HIS/HER AREA OF WORK.
- THE GENERAL CONTRACTOR IS RESPONSIBLE FOR CUTTING. REMOVAL AND PATCHING OF ROOFS, WALLS, AND FLOORS ASSOCIATED WITH WORK BY ALL CONTRACTORS. CONTRACTORS SHALL NOTIFY THE GC OF AFFECTED AREAS PRIOR TO BIDDING
- THE GENERAL CONTRACTOR IS RESPONSIBLE FOR REMOVAL AND REPLACEMENT OF CEILINGS. CEILING TILES. AND CEILING GRIDS ASSOCIATED WITH AREAS OF WORK BY ALL CONTRACTORS. NOTIFY THE GENERAL CONTRACTOR OF AFFECTED AREAS PRIOR TO RIDDING
- WHERE EXISTING MECHANICAL SYSTEMS ARE LOCATED IN AREAS THAT CONFLICT WITH NEW EQUIPMENT, PIPING, OR DUCTWORK TO BE INSTALLED, EACH CONTRACTOR SHALL EITHER ARRANGE NEW EQUIPMENT, PIPING, OR DUCTWORK IN SUCH A FASHION THAT IT DOES NOT CONFLICT WITH EXISTING SYSTEMS, OR REWORK EXISTING MECHANICAL SYSTEMS TO ALLOW FOR INSTALLATION OF NEW EQUIPMENT, PIPING, OR DUCTWORK. OBTAIN PERMISSION FROM OWNER BEFORE SHUTTING DOWN ANY SYSTEM FOR ANY
- SYSTEMS ARE INSTALLED. MAINTAIN EXISTING SYSTEM IN SERVICE UNTIL NEW SYSTEM IS COMPLETE AND READY FOR TIE IN AND SWITCHOVER. DRAIN SYSTEM ONLY TO MAKE SWITCHOVERS AND CONNECTIONS. OBTAIN PERMISSION FROM OWNER BEFORE PARTIALLY OR COMPLETELY

REASON. MAINTAIN SERVICE TO ALL COMPONENTS THAT ARE TO REMAIN UNTIL NEW

DRAINING SYSTEM. MAKE CHANGEOVER TO NEW SYSTEMS WITH MINIMUM OUTAGE. 10. DISCONNECT AND REMOVE MECHANICAL DEVICES AND EQUIPMENT SERVING EQUIPMENT THAT HAS BEEN REMOVED.

TAB POST-CONSTRUCTION NOTES:

- AFTER CONSTRUCTION ACTIVITIES ARE COMPLETE, TESTING, ADJUSTING AND BALANCING (TAB) CONTRACTOR SHALL REBALANCE AIR HANDLING UNITS AND EXHAUST FANS AS REQUIRED TO ACHIEVE THE NEW AIRFLOW VALUES SHOWN ON THE CONSTRUCTION
- DRAWINGS IF DUCT TRAVERSE LOCATION AS MARKED ON THE DRAWINGS IS INACCESSIBLE FOR MEASUREMENT, THE TAB CONTRACTOR SHALL PERFORM THE TRAVERSE AT AN ALTERNATE LOCATION OR SHALL TAKE MULTIPLE DUCT TRAVERSES AND/OR GRILLE READINGS AS REQUIRED TO DETERMINE THE FLOW RATE. IN THE EVENT TRAVERSES ARE TAKEN AT AN ALTERNATE LOCATION(S), TAB CONTRACTOR SHALL INCLUDE A DRAWING THAT SHOWS THE LOCATIONS WHERE THE ACTUAL MEASUREMENTS WERE TAKEN.
- A DUCT STATIC PRESSURE READING SHALL BE TAKEN AT EACH LOCATION WHERE A DUCT TRAVERSE READING IS TAKEN AND SHALL BE INCLUDED IN THE FINAL POST-CONSTRUCTION
- TAB CONTRACTOR SHALL COMPILE AND SUBMIT COPIES OF THE FINAL POST-CONSTRUCTION TAB REPORT AS REQUIRED BY SPECIFICATIONS.
- THE FINAL POST CONSTRUCTION REPORT SHALL INCLUDE ALL ITEMS REQUIRED IN THE SPECIFICATIONS.

VENTILATION GENERAL NOTES:

- 1. ALIGN TEMPERATURE SENSORS WITH LIGHT SWITCHES WHEN IN CLOSE PROXIMITY TO
- CONTRACTOR MAY REUSE PORTIONS OF EXISTING DUCT PROVIDED SIZES AND PRESSURE CLASSES ARE CORRECT, DUCT IS THOROUGHLY CLEANED AND FREE OF DEFECTS, AND ALL TRANSVERSE JOINTS, LONGITUDINAL SEAMS, AND DUCT WALL PENETRATIONS ARE SEALED AS SPECIFIED FOR NEW DUCTWORK.

MECHANICAL SYMBOL LIST NOT ALL SYMBOLS MAY APPLY SYMBOL: DESCRIPTION: DIRECTION OF AIR FLOW -**/////** | FLEXIBLE DUCT MANUAL VOLUME DAMPER → R ├ RISE IN DIRECTION OF AIR FLOW

→ D → DROP IN DIRECTION OF AIR FLOW DUCT CAP **DUCT DOWN** SUPPLY AIR DIFFUSER RETURN AIR GRILLE

AIR TERMINAL PROPERTIES SYMBOL NECK SIZE/CFM

/ × / × OPPOSED BLADE DAMPER (REFER TO SCHEDULE) 8 8 8 8 PARALLEL BLADE DAMPER (REFER TO SCHEDULE)

I

XX-Y AIRFLOW MEASUREMENT SYMBOL XX - AHU SYMBOL Y - SEQUENTIAL NUMBER

THERMOSTAT



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SALINE, MI

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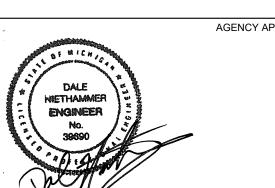


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Revision / Issue **OWNER REVIEW** 12/18/2023 **ISSUED FOR BIDS/PERMITS** 03/12/2024 04/12/2024 **BIDS/PERMITS**


SHEET INFORMATION REVISED BIDS/PERMITS 04/12/2024 23004726.00 J SATTELBERG R OQUINN

D NIETHAMMER

COVERSHEET

SCALE

Approved

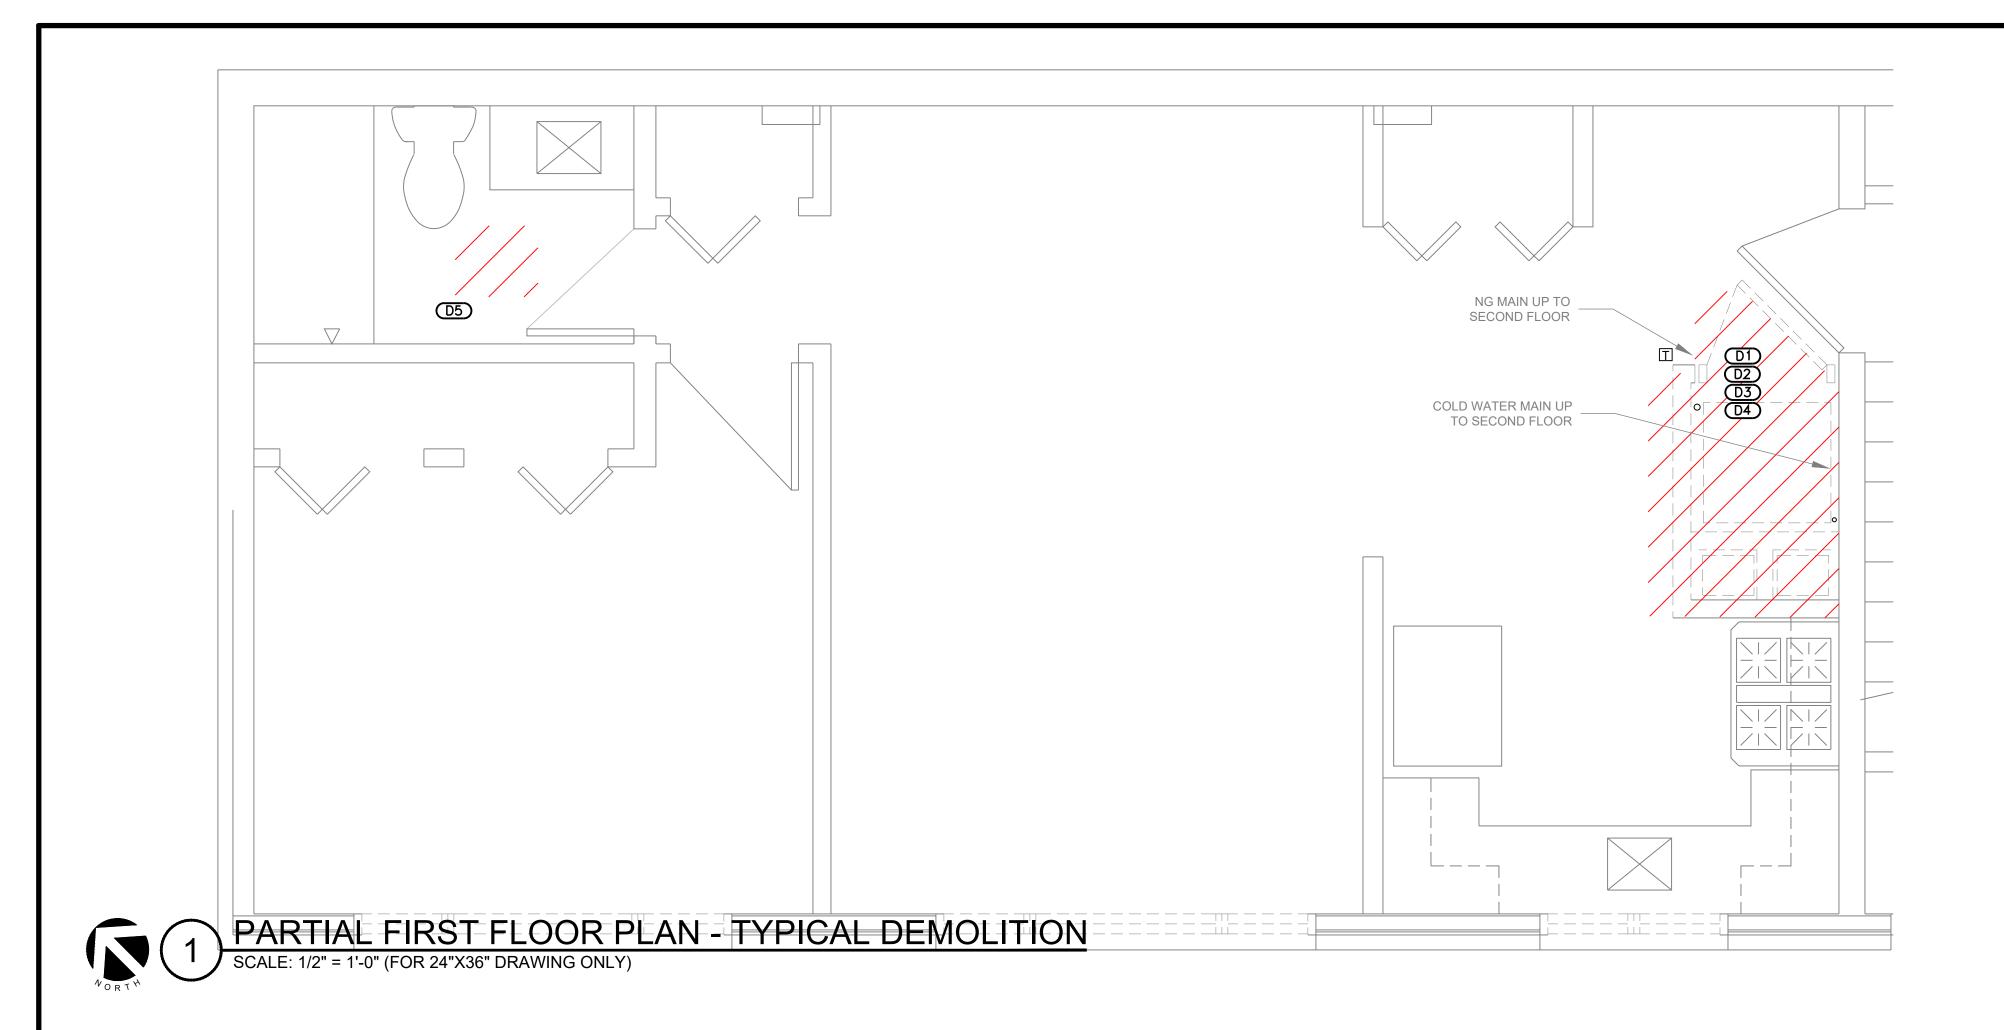

GENERAL NOTES:

- SEE GENERAL NOTES, SPECIFICATIONS, AND ADDITIONAL PROJECT INFORMATION ON GENERAL DRAWINGS.
- NEW WORK SHOWN IN BOLD.
- DRAWINGS DIAGRAMMATICALLY INDICATE THE GENERAL SCOPE OF WORK, BUT DO NOT PROVIDE EXACT SCALE OR LOCATIONS. PROPER INSTALLATION OF ALL SYSTEMS, AFTER COORDINATION WITH OTHER TRADES, IS THE CONTRACTORS RESPONSIBILITY.
- THIS IS A TYPICAL FLOORPLAN SOME DISCREPANCIES MAY ARISE BETWEEN APARTMENTS AND BUILDINGS, NOTIFY ENGINEER. THIS DOES NOT RELIEVE THE CONTRACTOR TO PROVIDE COMPLETE AND WORKING SYSTEMS. REFER TO BUILDING SCHEMATICS FOR ALL EQUIPMENT LOCATIONS.

DEMOLITION KEYNOTES: DX

- SHUTOFF POWER TO FURNACE, AND DISCONNECT UTILITIES (POWER AND NATURAL GAS). DEMOLISH EXISTING FURNACE ALONG WITH FLUE, AND DUCTWORK TO WALL. DISPOSE OF
- SHUTOFF POWER TO WATER HEATER, AND DISCONNECT UTILITIES (POWER AND NATURAL GAS.) DEMOLISH EXISTING WATER HEATER ALONG WITH FLUE, AND PIPING TO WALL. DISPOSE OF PROPERLY.
- REFER TO ARCHITECTURAL PLANS FOR FURTHER DEMOLITION OF WALLS.
- . CONTRACTOR TO DEMOLISH EXISTING FLOOR PLENUM.
- CONTRACTOR TO DEMOLISH EXISTING EXHAUST FAN, LEAVE DUCTWORK IN PLACE.

NEW WORK KEYNOTES: X

- SUPPLY DUCT TO BE CONNECTED IN FIELD TO EXISTING DUCTWORK.
- CONNECT NEW HOT AND COLD WATER TO EXISTING PIPING.
- INSTALL CONCENTRIC VENT FOR COMBUSTION AIR AND FLUE PER MANUFACTURER STANDARDS.
- INSTALL NEW CONDENSING UNITS $\underline{\text{CU-01}}$ THRU $\underline{\text{CU-04}}$ AT LOCATION SHOWN PER MANUFACTURERS RECOMMENDATIONS.
- INSTALL AND INSULATE NEW LIQUID AND SUCTION REFRIGERANT PIPING BETWEEN COOLING COILS AND CONDENSING UNITS. FIRESTOP ALL PENETRATIONS. SEE SPEC ON MEP0.01.
- FOR POWER TO NEW CONDENSING UNITS, REFERENCE ELECTRICAL DRAWINGS.
- CONTRACTOR TO CONNECT CONTROL WIRING BETWEEN THE THERMOSTAT, FURNACE, AND IT'S ASSOCIATED CONDENSING UNIT.
- REFER TO BUILDING ELEVATION FOR CONDENSING UNIT LOCATION.
- REFER TO PLUMBING DRAWING FOR PLUMBING SCOPE. COORDINATE WORK WITH ALL REFER TO BUILDING ELEVATION FOR EQUIPMENT QUANTITIES AND NUMBERS.
- . CONTRACTOR TO INSTALL INSULATION ON VENTILATION/INTAKE PIPING IN UNCONDITIONED
- SPACES WHERE REQUIRED PER MANUFACTURERS RECOMMENDATION. . NEW EXHAUST FAN TO BE TIED INTO EXISTING DUCTWORK. CONTRACTOR TO REPLACE EXISTING WALL CAP WITH THE LISTED OPTIONS ON THE SCHEDULE.



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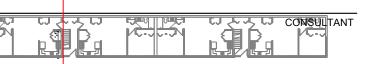
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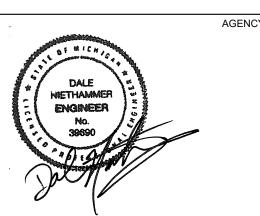


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REVISIONS Revision / Issue 12/18/2023 **OWNER REVIEW BIDS/PERMITS** 03/12/2024


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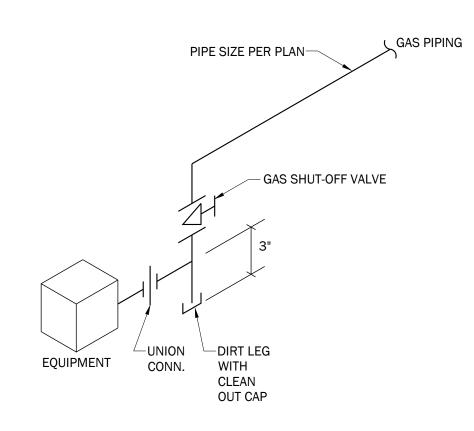
04/12/2024

SHEET INFORMATION BIDS/PERMITS J SATTELBERG D NIETHAMMER


PARTIAL FLOOR PLAN **DEMOLITION/NEW WORK**

M1.0



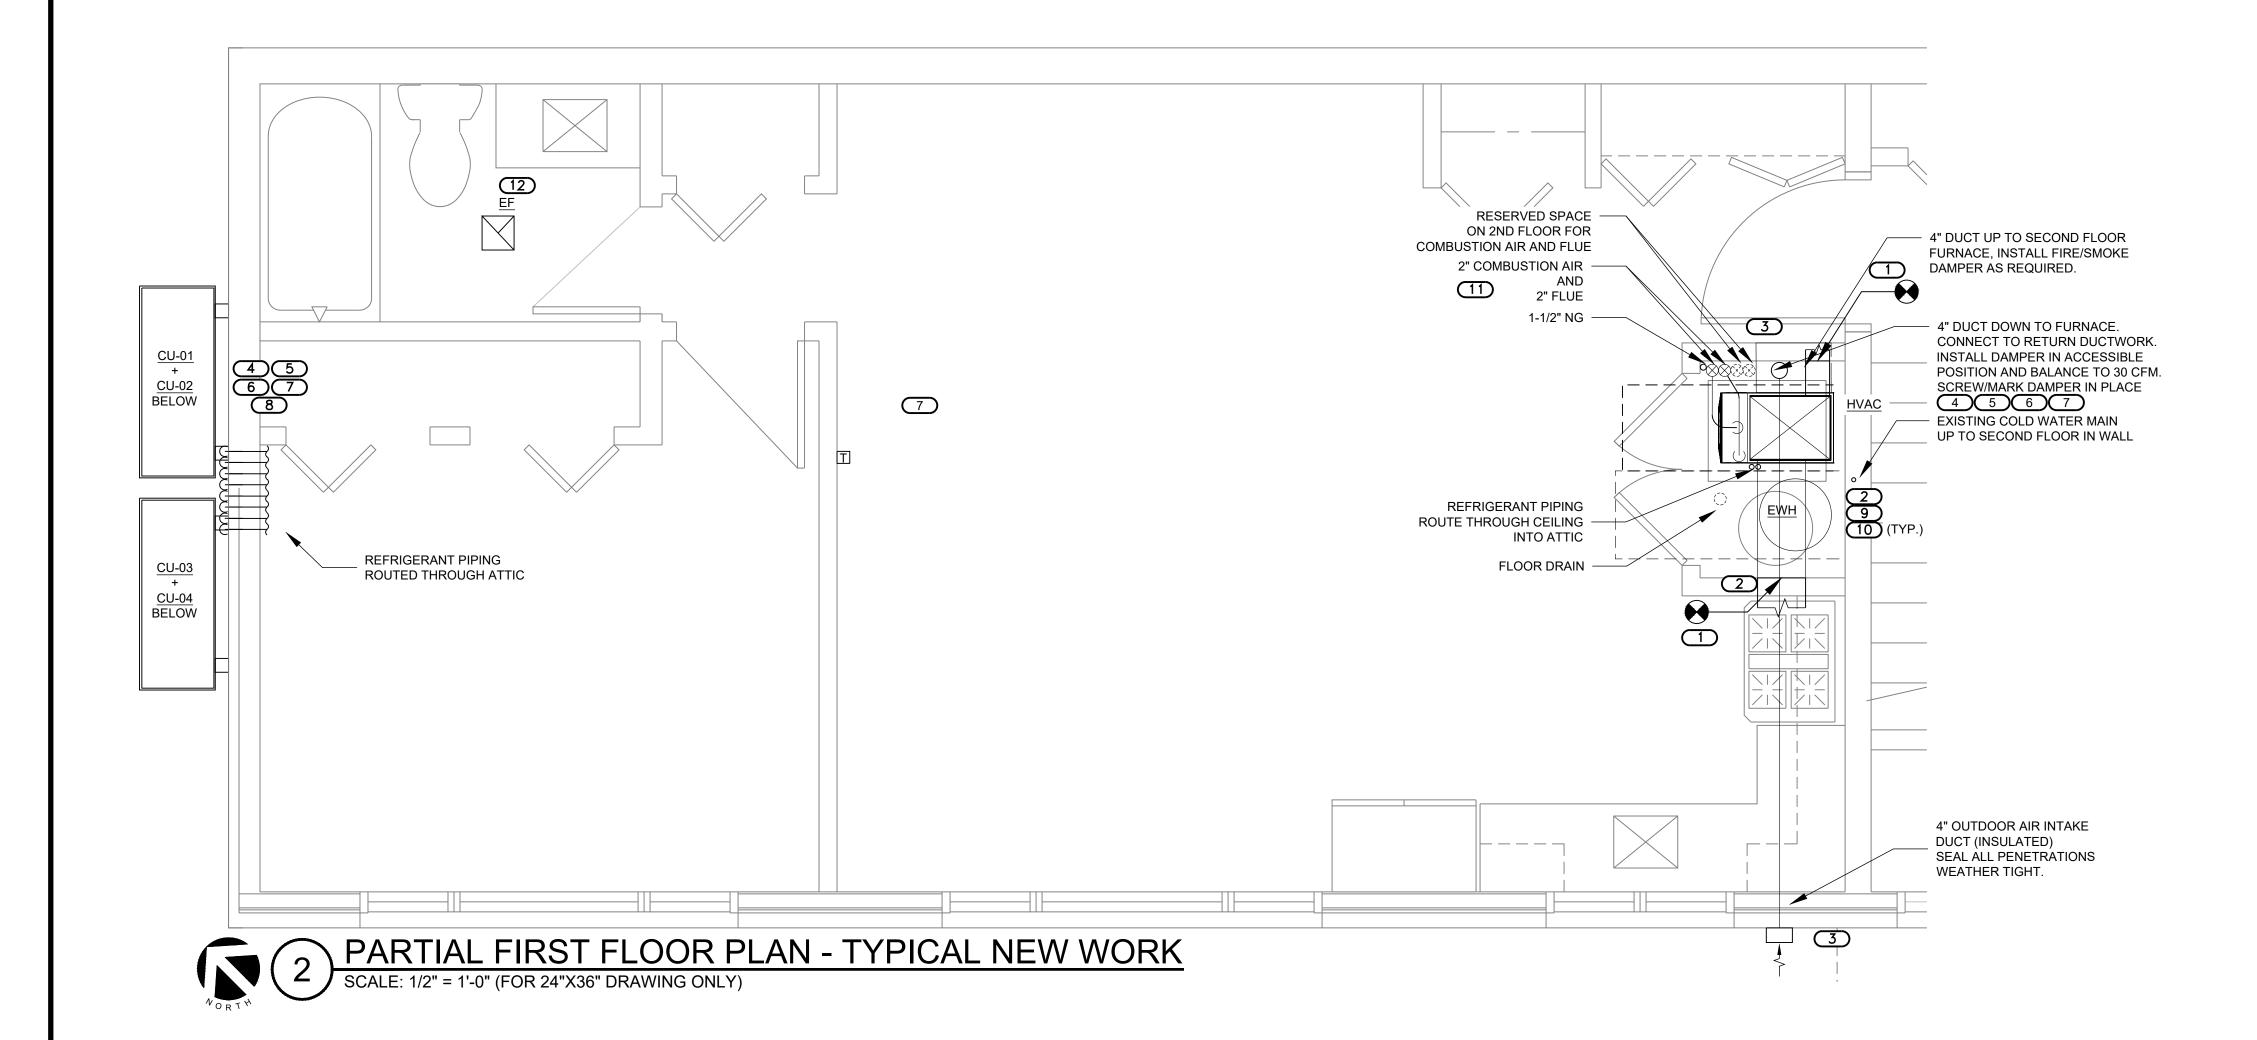


TYPICAL GAS PIPING EQUIPMENT CONNECTION DETAIL

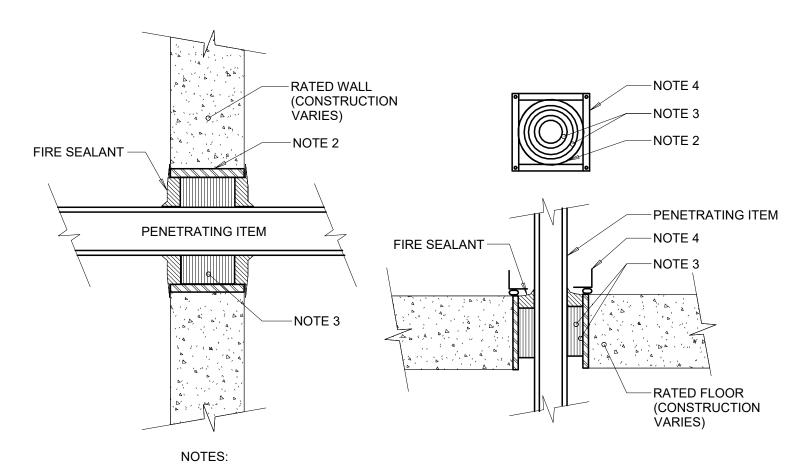

- 1. THIS GENERAL DETAIL APPLIES TO ALL ITEMS PENETRATING FIRE RATED WALLS OR FLOORS. THE INTENT IS TO MAINTAIN THE FIRE RATING AND TO ALLOW LONGITUDINAL MOVEMENT.
- 2. SCHEDULE 5 PIPE SLEEVE EMBEDDED IN WALL OR FLOOR, OR SMOOTH CORE DRILL. EACH CONTRACTOR FURNISHES SLEEVE TO G.C., COORDINATES SLEEVE LOCATIONS AND DEBURS SLEEVE. G.C. BUILDS SLEEVE INTO WALL OR FLOOR ALLOWING NO GAP AROUND SLEEVE. IF SLEEVE IS NOT PROVIDED WHEN WALL OR FLOOR IS BUILT, CONTRACTOR SHALL INSTALL SLEEVE. SLEEVE SIZE SHALL ALLOW ANNULAR
- SPACE REQUIRED BY THE SELECTED FIRE STOP SYSTEM. 3. INSTALL BACKING MATERIAL, SUCH AS MINERAL WOOL SAFING, AS REQUIRED FOR FIRE STOP SYSTEM. INSTALL IN ACCORDANCE WITH FIRE STOP SYSTEM APPLICATION LISTING. SECURE TO WALL OR FLOOR TO ALLOW LONGITUDINAL MOVEMENT OF PENETRATING ITEM WITHOUT MOVEMENT OF
- 4. WATERTIGHT WELDED 1"x1" 20 GAUGE MINIMUM GALVANIZED SHEET METAL ANGLE FRAME, BY CONTRACTOR IN EQUIPMENT ROOMS FOR WATER STOP. PLACE A BEAD OF WATERPROOF SEALANT BETWEEN FLOOR AND BOTTOM OF ANGLE FRAME. SECURE TO FLOOR WITH MASONRY ANCHORS IN CORNERS AND ON 12" MAXIMUM CENTERS. MULTIPLE PENETRATING ITEMS MAY BE ENCLOSED IN ONE FRAME.

FLOOR/WALL PENETRATION -2 RATED FIRE BARRIER
NO SCALE

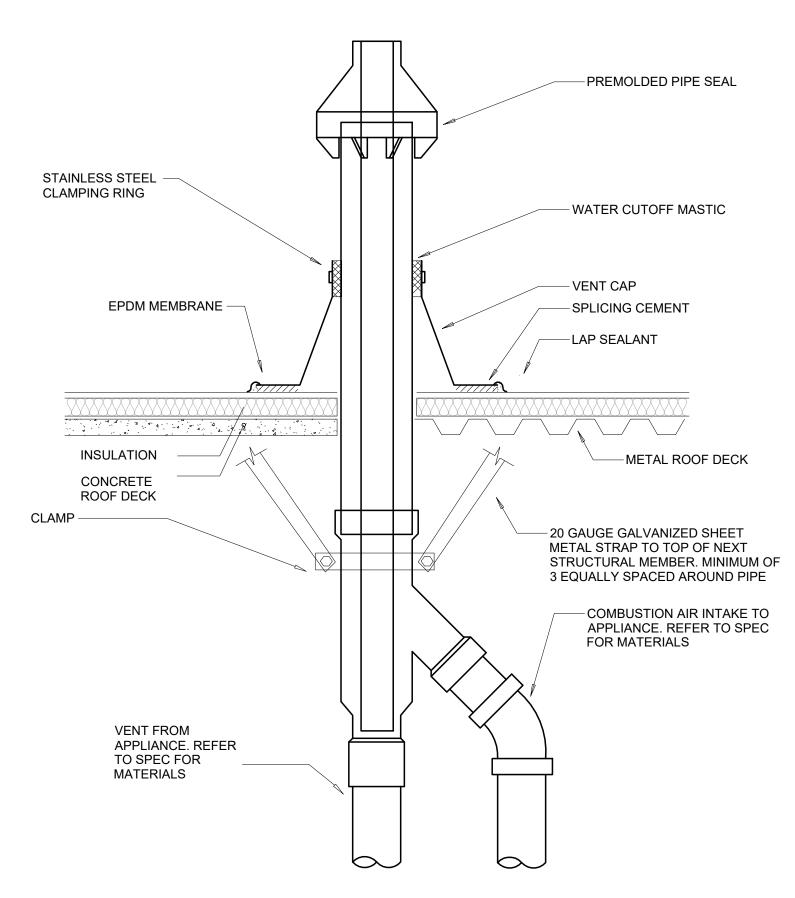

3 FLUE - CONCENTRIC VENT/INTAKE

FURNACE SCHEDULE (HVAC)

	MARK	LOCATION	SERVICE	SUPPLY FAN			HEATING SECTION				MANUFACTURER	
				CFM	ESP	HP	EAT	MBH INPUT	MBH OUTPUT	VOLTS/PH/HZ	MODEL NO NO	NOTES
	HVAC-01 THRU HVAC-13	MECHANICAL CLOSET	SEE PLANS	1100	0.5"	0.5	60°F	40	39	120/1/60	TRANE S9X2B040U3PSBA	ALL

- NOTES:

 1. PROVIDE FURNACE WITH MANUFACTURER ACCESSORIES: CONCENTRIC VENT KIT, EXTERNAL TRAP KIT, AND PROGRAMMABLE THERMOSTAT.
- CONTRACTOR TO PROVIDE FILTER SECTION WITH GASKETED ACCESS DOOR FOR UNIT.
- FURNACE SHALL BE ENERGY STAR RATED.
- FILTER SECTION MUST BE SEALED AIR TIGHT AND ACCESS DOOR TO BE PROVIDED WITH GASKET. PROVIDE FURNACE WITH CONDENSING UNIT AND COOLING COILD INDICATED IN BELOW SCHEDULES.

DX C	DX COOLING COIL SCHEDULE (CC)											
MARK	LOCATION SERVICE	NOM TON	CFM	REFRIG TYPE	SENSIBLE MBH	°F DB	°F WB	MANUFACTURER MODEL NO	REQUIRED OPTIONS	NOTES		
CC-01 THRU CC-12	MECHANICAL CLOSET	1 1/2	812	R410A	18	75	67	TRANE 4TXCA002DS3HCA				
NOTES:	NOTES:							IONS:				

AIR COOLED CONDENSER SCHEDULE (CU)											
MARK LOCATION TONS REFRIG EAT SERVICE (NOM) TYPE SF DB	°F WB MBH	NO w	VOLT/PH/HZ	MCA	NET WT (LBS)	MANUFACTURER MODEL NO	NOTES				
CU-01 THRU SEE PLANS 1 1/2 R410A 95 75 CU-12	67 18	1 86	230/1/60	19	151	TRANE TRUYA024HA70NA	ALL				

1. PROVIDE CONDENSING UNIT REFRIGERANT LINE SET, LOW AMBIENT LOCK OUT, AND VIBRATION ISOLATION. 2. CONDENSING UNIT SHALL BE ENERGY STAR RATED.

3. PROVIDE CONDENSING UNIT WALL MOUNT KIT (MODEL # QSWBSS) FROM MANUFACTURER.

EXH	IAUST FA	AN SCHE	DUL	.E (E	EF)								
MARK	LOCATION	FAN TYPE	FLOW		FAN	DRIVE	ROUGH OPENING (IN)		ELECTF	RIC	MANUFACTURER	REQUIRED OPTIONS	NOTES
IVIAIXIX	SERVICE	FAN ITPE	(CFM)		RPM	TYPE		HP	FLA	V/PH/HZ	MODEL NO		
EF-01 THRU EF-11	BATHROOM	CENTRIFUGAL	70	-	-	DIRECT	8"x8.25"	-	2.0	120/1/60	BROAN 679	ALL	ALL

NOTES:
1. PROVIDE MISCELLANEOUS MOUNTING HARDWARE AS REQUIRED TO INSTALL FAN.

A. BACKDRAFT DAMPER

B. ROUND DUCT CONNECTORS (INLET/OUTLET) C. HOODED WALL CAP WITH BIRDSCREEN



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Revision / Issue 12/18/2023 OWNER REVIEW BIDS/PERMITS 03/12/2024 04/12/2024 BIDS/PERMITS

SHEET INFORMATION BIDS/PERMITS 04/12/2024 23004726.00 J SATTELBERG R OQUINN D NIETHAMMER **MECHANICAL SCHEDULES**

AND DETAILS

M2.0

	PLUMBING SYMBOL LIST
	NOT ALL SYMBOLS MAY APPLY.
SYMBOL:	DESCRIPTION:
cw	COLD WATER - POTABLE
——D——	DRAIN
——HW——	HOT WATER - POTABLE
—HWC—	HOT WATER CIRCULATING - POTABLE
——SAN——	SANITARY DRAINAGE
	VENT
——NG ——	NATURAL GAS
	PIPE CONTINUATION
	PIPE CAP
>	PIPE DOWN
	PIPE UP OR UP/DOWN
—— o	PIPE SERVING FIXTURE ON FLOOR ABOVE (EXAMPLE: FD = FLOOR DRAIN)
	DIRECTION OF FLOW IN PIPE
──	SHUTOFF VALVE NORMALLY OPEN
— GPM	BALANCING VALVE (NUMBER INDICATES GPM)
	CHECK VALVE

	PLUMBING ABBREVIATION KEY							
	PLUMBING ABBREVIATION RET							
ABBR:	DESCRIPTION:							
AD	ACCESS DOOR							
AFF	ABOVE FINISHED FLOOR							
BFP	BACKFLOW PREVENTER							
CO	CLEANOUT							
CS	CLINICAL SINK							
Е	EXISTING							
EE	EMERGENCY EYEWASH							
FCO	FLOOR CLEANOUT							
FD	FLOOR DRAIN							
FS	FLOOR SINK							
LAV	LAVATORY							
MB	MOB BASIN							
SK	SINK							
TYP	TYPICAL							
WC	WATER CLOSET							
WCO	WALL CLEANOUT							

MECHANICAL RENOVATION NOTES:

THESE NOTES APPLY TO ALL MECHANICAL SHEETS AND TRADES, INCLUDING BUT NOT LIMITED TO, FIRE PROTECTION, PLUMBING, VENTILATION, PIPING AND TEMPERATURE CONTROL.

- 1. EXISTING CONDITIONS ARE SHOWN BASED ON INFORMATION OBTAINED FROM FIELD SURVEYS, EXISTING BUILDING DOCUMENTS, AND STAFF. VERIFY EXISTING CONDITIONS AND REPORT ANY CONFLICTS BEFORE PROCEEDING.
- 2. NOT ALL EXISTING DUCTWORK AND PIPING IS SHOWN. VERIFY EXISTING CONDITIONS BEFORE STARTING WORK. NOTIFY ENGINEER OF ANY CONFLICTS WITH NEW WORK. 3. FIELD VERIFY THE AVAILABLE CLEARANCES FOR DUCTWORK AND PIPING BEFORE
- FABRICATION. RISES AND DROPS MAY BE NECESSARY BECAUSE OF EXISTING FIELD CONDITIONS. 4. EACH CONTRACTOR SHALL FIELD VERIFY ACCESSIBILITY TO THE AREA OF THEIR WORK AND
- SHALL NOTIFY THE CONSTRUCTION MANAGER PRIOR TO BIDDING IF OTHER UTILITIES ARE REQUIRED TO BE REMOVED OR RELOCATED TO ALLOW ACCESS TO THEIR AREA OF WORK. 5. THE GENERAL CONTRACTOR IS RESPONSIBLE FOR CUTTING, REMOVAL AND PATCHING OF ROOFS, WALLS, AND FLOORS ASSOCIATED WITH WORK BY ALL CONTRACTORS.
- CONTRACTORS SHALL NOTIFY THE GC OF AFFECTED AREAS PRIOR TO BIDDING. 6. THE GENERAL CONTRACTOR IS RESPONSIBLE FOR REMOVAL AND REPLACEMENT OF CEILINGS, CEILING TILES, AND CEILING GRIDS ASSOCIATED WITH AREAS OF WORK BY ALL CONTRACTORS. NOTIFY THE GENERAL CONTRACTOR OF AFFECTED AREAS PRIOR TO
- . WHERE EXISTING MECHANICAL SYSTEMS ARE LOCATED IN AREAS THAT CONFLICT WITH NEW EQUIPMENT, PIPING, OR DUCTWORK TO BE INSTALLED, EACH CONTRACTOR SHALL EITHER ARRANGE NEW EQUIPMENT, PIPING, OR DUCTWORK IN SUCH A FASHION THAT IT DOES NOT CONFLICT WITH EXISTING SYSTEMS, OR REWORK EXISTING MECHANICAL SYSTEMS TO ALLOW FOR INSTALLATION OF NEW EQUIPMENT, PIPING, OR DUCTWORK. 8. PROVIDE TEMPORARY CONNECTIONS TO MAINTAIN EXISTING SYSTEMS IN SERVICE DURING

CONSTRUCTION. MAINTAIN ACCESS TO EXISTING MECHANICAL INSTALLATIONS THAT

- 9. OBTAIN PERMISSION FROM OWNER BEFORE SHUTTING DOWN ANY SYSTEM FOR ANY REASON. MAINTAIN SERVICE TO ALL COMPONENTS THAT ARE TO REMAIN UNTIL NEW SYSTEMS ARE INSTALLED.
- 10. MAINTAIN EXISTING SYSTEM IN SERVICE UNTIL NEW SYSTEM IS COMPLETE AND READY FOR TIE IN AND SWITCHOVER. DRAIN SYSTEM ONLY TO MAKE SWITCHOVERS AND CONNECTIONS. OBTAIN PERMISSION FROM OWNER BEFORE PARTIALLY OR COMPLETELY DRAINING SYSTEM. MAKE CHANGEOVER TO NEW SYSTEMS WITH MINIMUM OUTAGE.
- 11. DISCONNECT AND REMOVE MECHANICAL DEVICES AND EQUIPMENT SERVING EQUIPMENT THAT HAS BEEN REMOVED.

PLUMBING GENERAL NOTES:

- 1. THE SYMBOLS AND THE MATERIAL LIST ARE FOR THE CONVENIENCE OF THE CONTRACTOR. CONTRACTOR SHALL VERIFY QUANTITIES AND FURNISH ALL MATERIALS REQUIRED FOR FULLY OPERATIONAL SYSTEMS, WHETHER SPECIFIED OR NOT.
- 2. CATALOG NUMBERS SHALL NOT BE CONSIDERED COMPLETE, BUT ARE GIVEN AS AN AID TO THE CONTRACTOR AND TO INDICATE THE QUALITY REQUIRED. CONTRACTOR IS RESPONSIBLE FOR A COMPLETE DESCRIPTION OF MATERIAL ON THESE DRAWINGS AND IN THE SPECIFICATIONS BEFORE ORDERING. THE DESCRIPTION OF THE MATERIAL TAKES PRECEDENCE OVER THE CATALOG NUMBER. THE FIRST MANUFACTURER LISTED IS THE BASIS OF DESIGN.
- 3. CONTRACTOR SHALL VERIFY THAT FIXTURES SUPPLIED ARE APPROVED PER ALL
- APPLICABLE STATE. LOCAL AND GOVERNING AUTHORITIES. ALL FIXTURES SHALL CONFORM TO FEDERAL ACT S.3874
- 5. REFER TO THE PLUMBING ROUGH-IN SCHEDULE FOR THE SIZES OF BRANCH PIPES TO PLUMBING FIXTURES.
- 6. FOR CLARITY, NOT ALL VALVES HAVE BEEN SHOWN. PROVIDE SHUTOFF VALVES IN DOMESTIC WATER PIPING SERVING EACH ROOM WITH FIXTURES. ANGLE STOPS SHALL NOT BE CONSIDERED SHUTOFF VALVES.
- 7. EXISTING CONDITIONS ON DEMOLITION PLANS ARE PROVIDED TO INDICATE THE GENERAL SCOPE OF ITEMS TO BE REMOVED. REFER TO SPECIFICATION SECTION 22 05 05 FOR ADDITIONAL DEMOLITION INFORMATION.
- 8. P.C. SHALL CUT AND PATCH EXISTING AS REQUIRED FOR NEW OR DEMOLITION WORK UNLESS NOTED OTHERWISE. REFER TO SPECIFICATION SECTION 22 05 05 FOR ADDITIONAL INFORMATION.

MECHANICAL GENERAL NOTES:

THESE NOTES APPLY TO ALL MECHANICAL SHEETS AND TRADES, INCLUDING BUT NOT LIMITED TO, FIRE PROTECTION, PLUMBING, VENTILATION, PIPING AND TEMPERATURE CONTROL.

- 1. DRAWINGS SHOWING LOCATIONS OF EQUIPMENT, DUCTWORK, PIPING, ETC, ARE DIAGRAMMATIC AND MAY NOT ALWAYS REFLECT EXACT INSTALLATION CONDITIONS. DRAWINGS SHOW THE GENERAL ARRANGEMENT OF DUCTWORK, PIPING, EQUIPMENT, ETC., AND MAY NOT INCLUDE ALL OFFSETS AND FITTINGS REQUIRED FOR COMPLETE INSTALLATION. THE DRAWINGS SHALL BE FOLLOWED AS CLOSELY AS ACTUAL BUILDING CONSTRUCTION AND THE WORK OF OTHERS WILL PERMIT.
- 2. DO NOT SCALE DRAWINGS. VERIFY ALL DIMENSIONS AND CLEARANCES FROM ARCHITECTURAL, STRUCTURAL, SUBMITTALS, AND OTHER APPROPRIATE DRAWINGS OR PHYSICALLY AT SITE. REVIEW ALL DRAWINGS, INCLUDING THOSE OF OTHER TRADES.
- 3. COORDINATE ALL WORK WITH ALL OTHER TRADES PRIOR TO INSTALLATION TO PROVIDE CLEARANCES REQUIRED FOR OPERATION, MAINTENANCE, CODE COMPLIANCE, AND TO VERIFY NON-INTERFERENCE WITH OTHER WORK. DO NOT FABRICATE PRIOR TO VERIFICATION OF NECESSARY CLEARANCES FOR ALL TRADES. BRING ANY INTERFERENCES OR CONFLICTS TO THE ATTENTION OF THE ARCHITECT/ENGINEER BEFORE PROCEEDING WITH FABRICATION OR EQUIPMENT ORDERS.
- 4. REVIEW SPACE REQUIREMENTS OF EQUIPMENT SPECIFIED OR SUBSTITUTED AND MAKE REASONABLE ACCOMMODATIONS IN LAYOUT AND POSITIONING TO PROVIDE PROPER
- 5. ANY CHANGES REQUIRED TO ELIMINATE CONFLICTS OR THAT RESULT FROM A FAILURE TO COORDINATE SHALL BE MADE BY THE CONTRACTOR WITHOUT ADDITIONAL COST OR EXPENSE TO OTHERS.
- 6. EACH CONTRACTOR IS RESPONSIBLE FOR ALL COSTS ASSOCIATED WITH ELECTRICAL CHANGES REQUIRED FOR EQUIPMENT PROPOSED THAT DIFFERS FROM THE BASIS OF
- 7. REFER TO ARCHITECTURAL REFLECTED CEILING PLAN, ELECTRICAL, TECHNOLOGY AUDIO/VISUAL, AND OTHER MECHANICAL PLANS FOR EXACT LOCATIONS OF ALL CEILING MOUNTED DEVICES, OTHER THAN SPRINKLERS.
- 8. THE CONTRACTOR WHOSE WORK CAUSES DAMAGE IS RESPONSIBLE FOR PATCHING TO MATCH ORIGINAL CONSTRUCTION, FIRE RATING, AND FINISH.
- 9. IN AREAS WITH DRYWALL CEILINGS COORDINATE LOCATIONS OF ACCESS PANELS WITH THE GC FOR ACCESS TO VALVES, DUCTWORK ACCESSORIES, DAMPERS, ETC. COORDINATE PANEL TYPE AND COLOR WITH ARCHITECT. NOTIFY THE GC OF THE REQUIRED ACCESS PANELS PRIOR TO BIDDING.
- 10. SEAL ALL WALL PENETRATIONS AIRTIGHT WHERE CONDUITS, PIPING, AND DUCTS PENETRATE.
- 11. CAULK ALL PIPE AND DUCT PENETRATIONS OF FULL HEIGHT NON-FIRE RATED WALL, PARTITION, FLOOR, AND ROOF ASSEMBLIES. THIS IS ESSENTIAL TO PREVENT NOISE TRANSMISSION FROM ONE ROOM TO ANOTHER AND TO PROVIDE THE DESIRED NC LEVELS
- 12. EQUIPMENT SIZES AND SERVICE CLEARANCE REQUIREMENTS VARY AMONG DIFFERENT MANUFACTURERS. CONSULT APPROVED SHOP DRAWINGS FOR EQUIPMENT SIZES AND REQUIRED SERVICE CLEARANCES. COORDINATE WITH LAYOUT OF EQUIPMENT PADS.
- PIPING, DUCTWORK, ETC 13. DO NOT BLOCK EQUIPMENT SERVICE CLEARANCES.
- 14. MAINTAIN A MINIMUM WORKING CLEARANCE OF 3 '-6" IN FRONT OF ALL ELECTRICAL EQUIPMENT REQUIRING MAINTENANCE, INSPECTION, AND TESTING INCLUDING BUT NOT LIMITED TO PANELS, DISTRIBUTION PANELS, SWITCHBOARDS, MOTOR CONTROL CENTERS. TRANSFORMERS, EQUIPMENT DISCONNECTS AND STARTERS
- 15. DO NOT SUPPORT EQUIPMENT, PIPING, OR DUCTWORK FROM METAL DECKING OR OTHER NON-STRUCTURAL BUILDING ELEMENTS. ANCHORS EMBEDDED IN CONCRETE SHALL BE CRACKED CONCRETE APPROVED IN ACCORDANCE WITH SPECIFICATIONS.

PLUMBING SLOPE REQUIREMENTS:

SANITARY WASTE:

DOMESTIC WATER:

≤2-1/2"ø=1/4" PER FOOT ≥3"ø = 1/8" PER FOOT

≥8"ø = 1/16" PER FOOT

NO SPECIFIC PITCH, PITCH TO FIXTURES

STORM (GRAVITY): **CONDENSATE AND INDIRECT DRAINAGE**

1/8" PER FOOT 1/8" PER FOOT NO SPECIFIC PITCH, PITCH TO FIXTURES **SANITARY VENT:**



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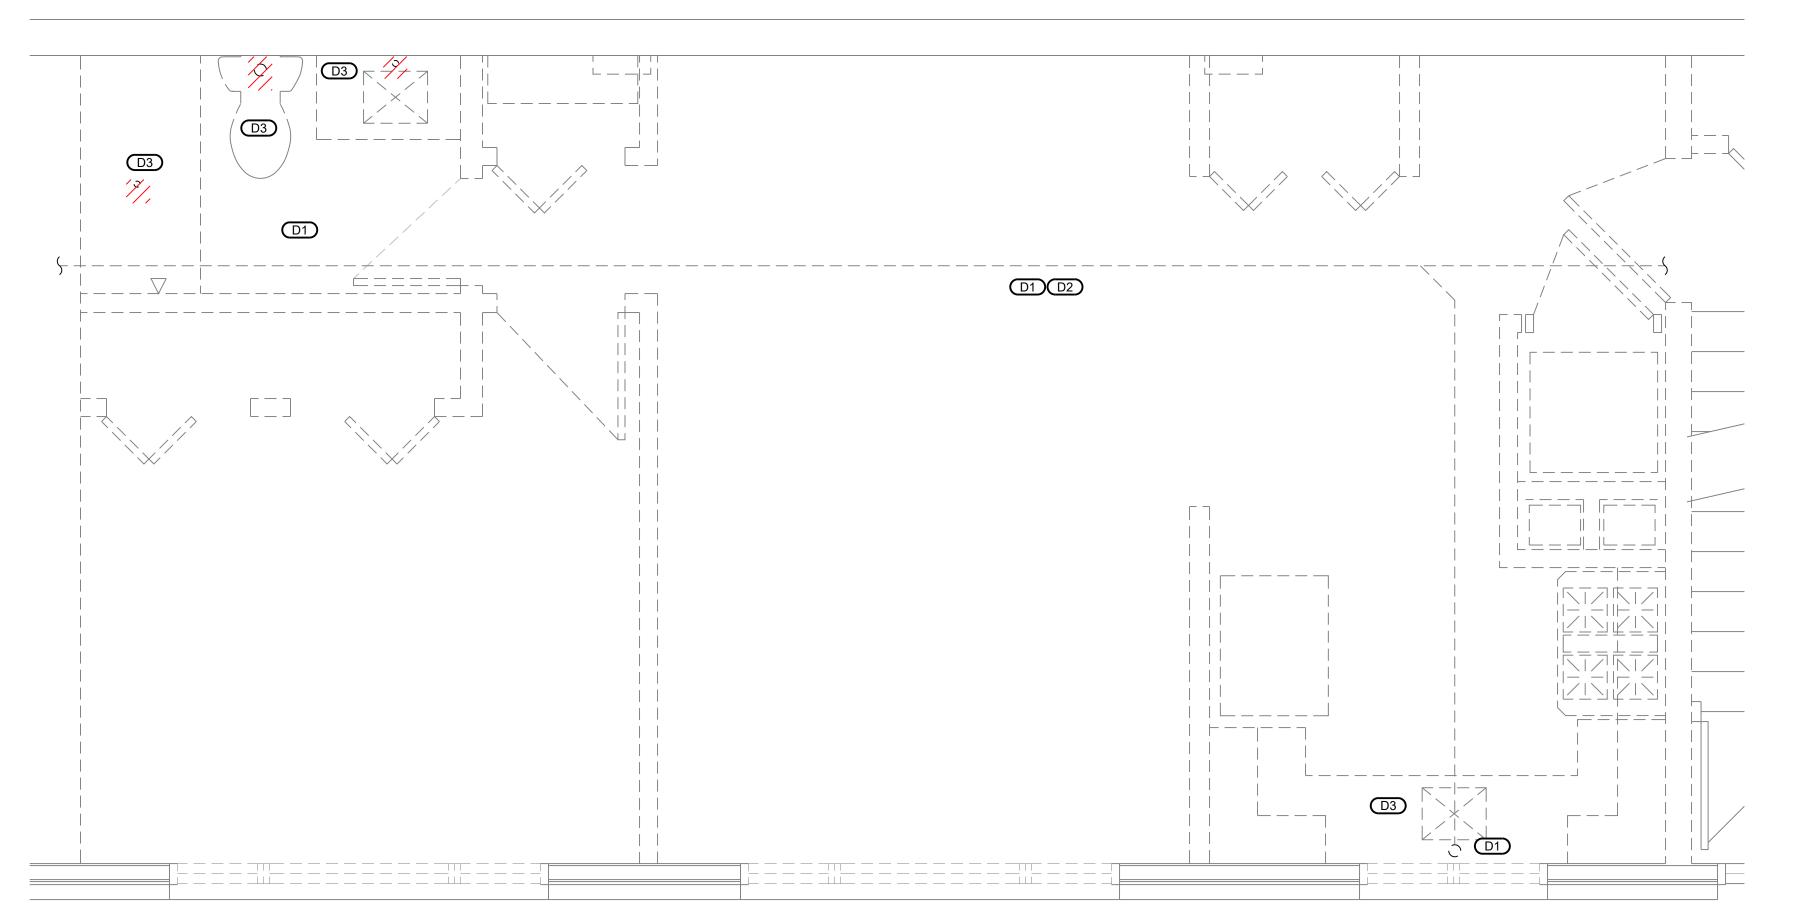
04/12/2024

SHEET INFORMATION BIDS/PERMITS 23004726.00 **J SATTELBERG** R OQUINN D NIETHAMMER

PLUMBING COVERSHEET

SCALE NONE

SHEET NUMBER



PARTIAL UNDERGROUND FLOOR PLAN - NEW WORK SCALE: 1/2" = 1'-0" (FOR 24"X36" DRAWING ONLY)

GENERAL NOTES:


- SEE GENERAL NOTES, SPECIFICATIONS, AND ADDITIONAL PROJECT INFORMATION ON GENERAL DRAWINGS.
- RED HATCHING INDICATES DEMOLITION.
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- SCHEMATICS FOR ALL EQUIPMENT LOCATIONS. THERE IS NO PLUMBING SCOPE IN THE LAUNDRY/OFFICE UNITS LOCATED IN BUILDING

DEMOLITION KEYNOTES:

- CONTRACTOR TO IMAGE FLOOR TO DETERMINE LOCATION OF EXISTING CAST IRON PIPING. CONTRACTOR TO NOTIFY ENGINEER OF ANY DISCREPANCIES WITH EXISTING SANITARY SEWER AND VENTING AFTER DEMOLITION OF THE WALLS AND CEILING, PRIOR TO PLUMBING DEMOLITION AND NEW WORK.
- DEMOLISH SANITARY PIPING TO FIXTURES AS REQUIRED FOR NEW WORK.

NEW WORK KEYNOTES: X

- INSTALL PIPING AS SHOWN, BACKFILL TRENCHES AND REPAIR CONCRETE AS REQUIRED.
- CONTRACTOR TO TIE IN NEW FIXTURES TO EXISTING SANITARY PIPING.

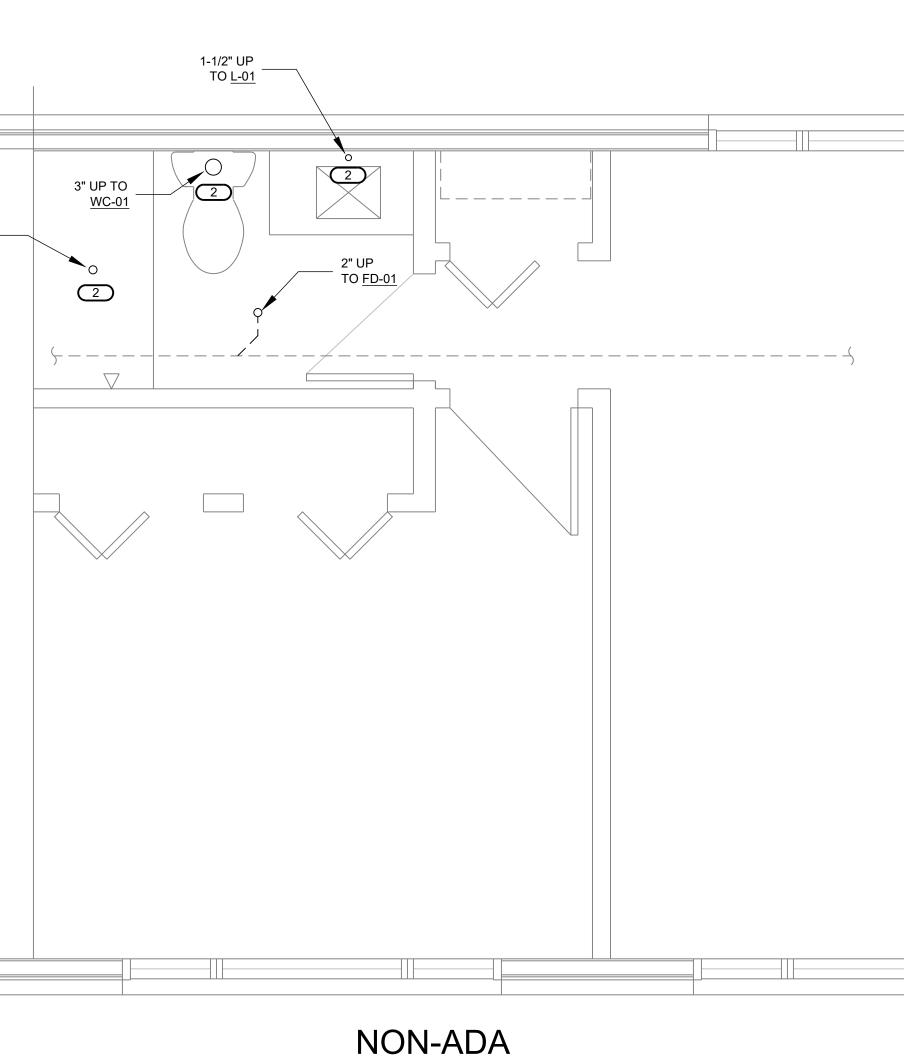

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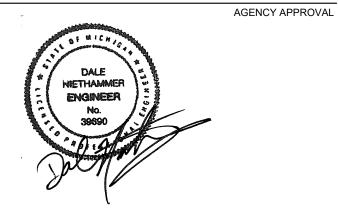
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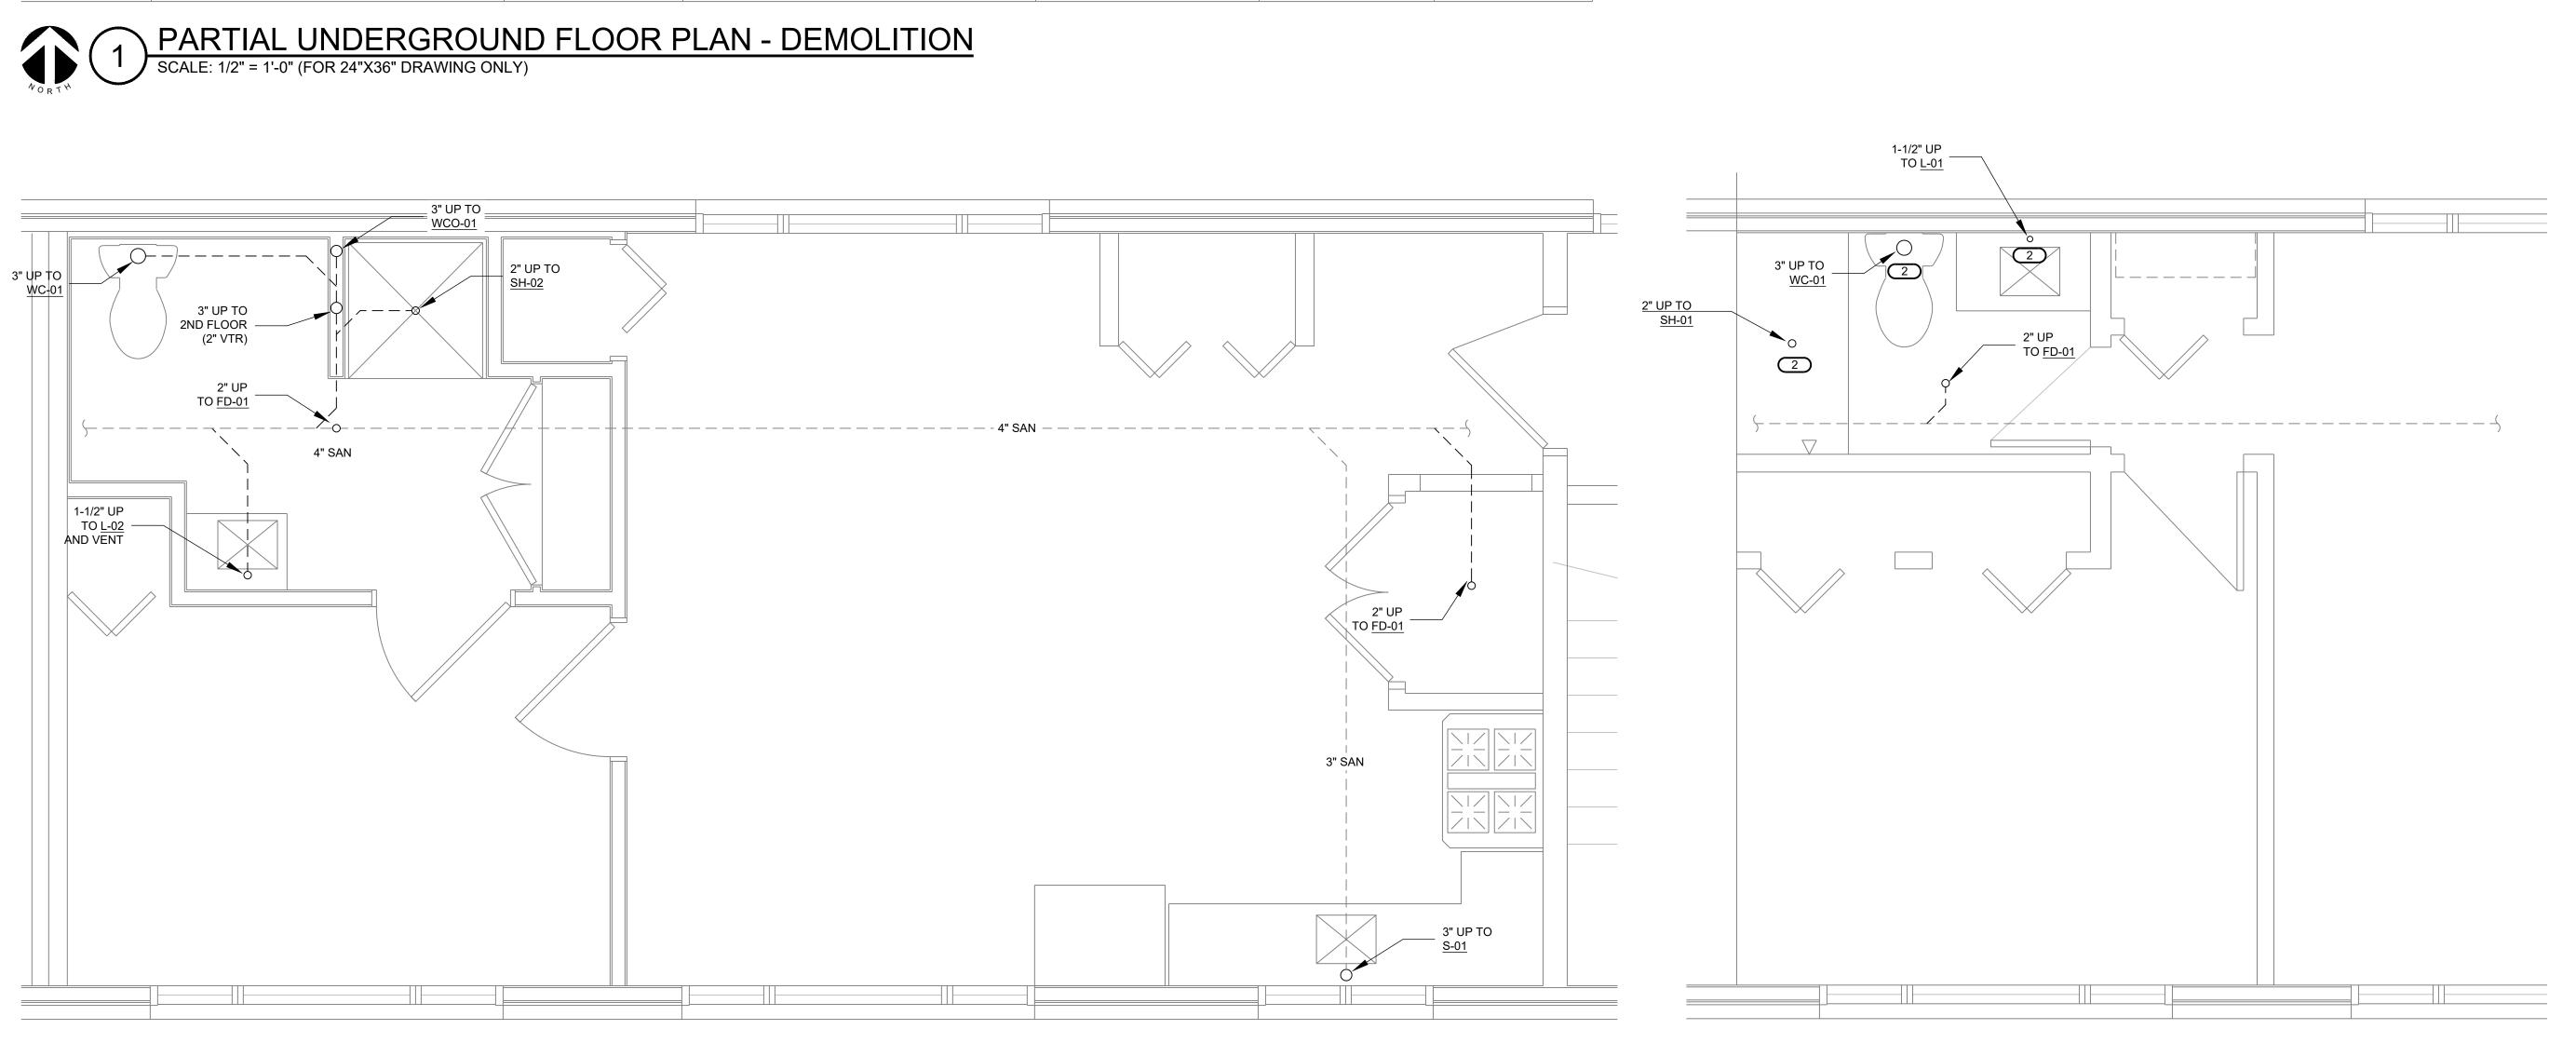
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В	03/12/2024	BIDS/PERMITS	
С	04/12/2024	BIDS/PERMITS	


D NIETHAMMER

PARTIAL FLOOR PLAN **UNDERGROUND DEMO/NEW WORK**

P1.0



ADA UNIT

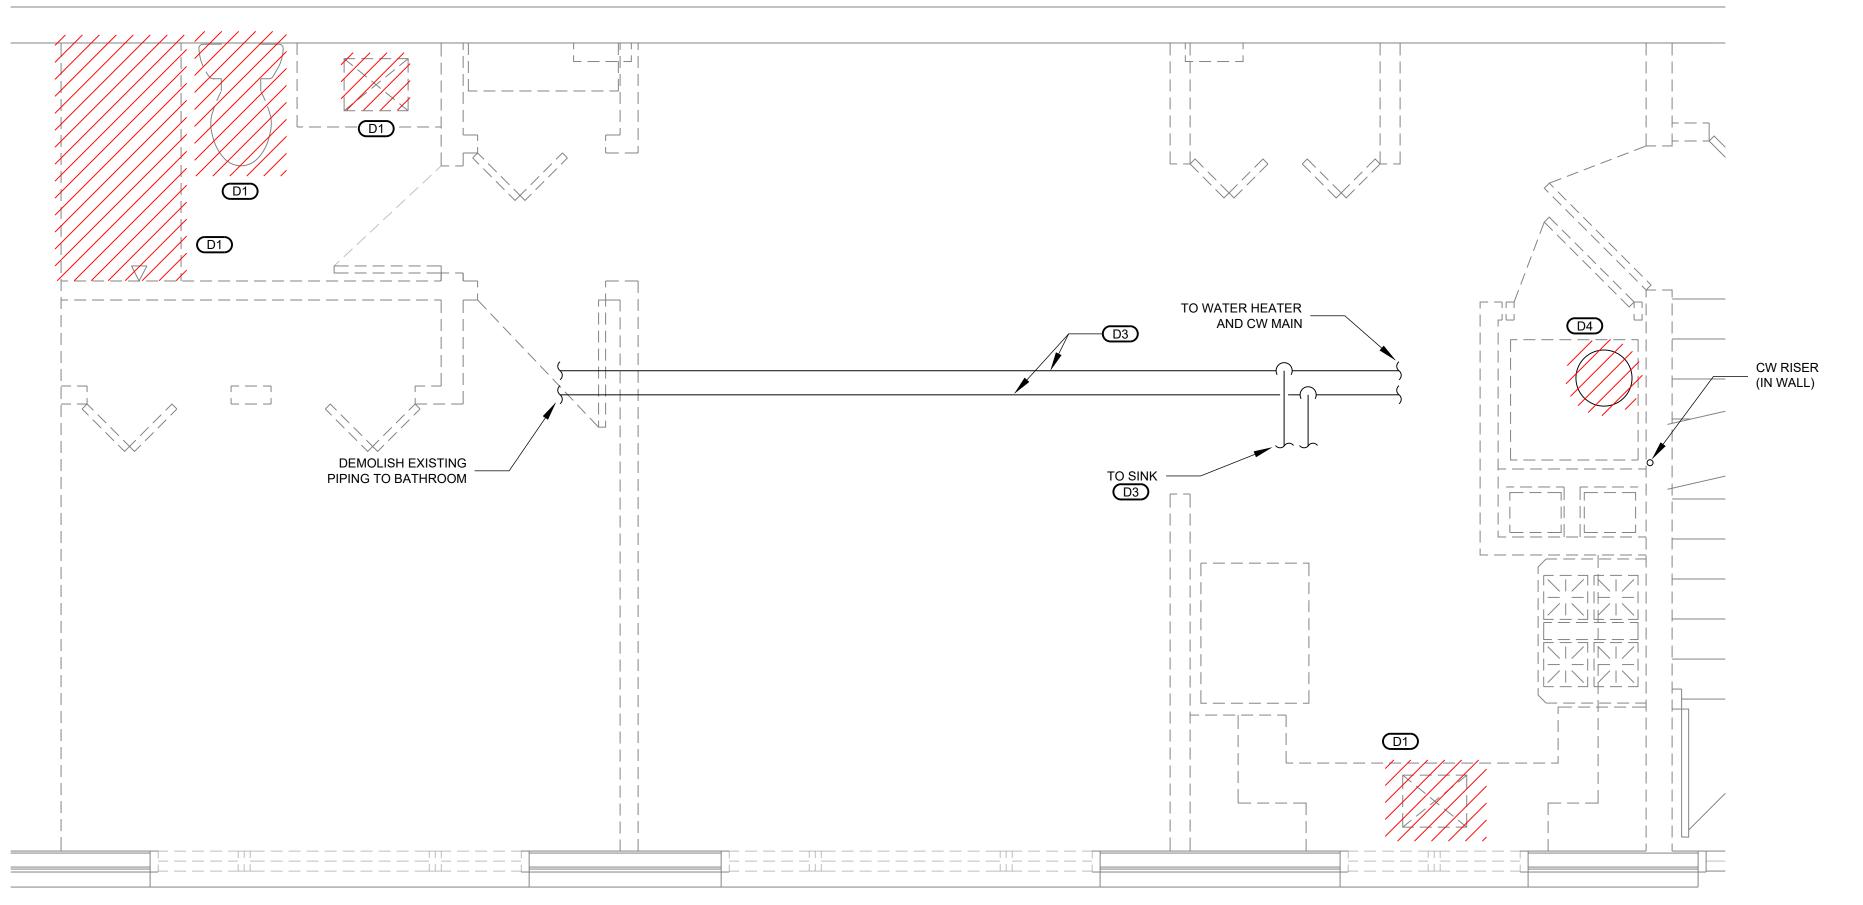

GENERAL NOTES:

- SEE GENERAL NOTES, SPECIFICATIONS, AND ADDITIONAL PROJECT INFORMATION ON
- GENERAL DRAWINGS.
 2. RED HATCHING INDICATES DEMOLITION.
- 3. NEW WORK SHOWN IN BOLD.
- 4. DRAWINGS DIAGRAMMATICALLY INDICATE THE GENERAL SCOPE OF WORK, BUT DO NOT PROVIDE EXACT SCALE OR LOCATIONS. PROPER INSTALLATION OF ALL SYSTEMS, AFTER COORDINATION WITH OTHER TRADES, IS THE CONTRACTORS RESPONSIBILITY.
- 5. THIS IS A TYPICAL FLOORPLAN SOME DISCREPANCIES MAY ARISE BETWEEN APARTMENTS AND BUILDINGS, NOTIFY ENGINEER. THIS DOES NOT RELIEVE THE CONTRACTOR TO PROVIDE COMPLETE AND WORKING SYSTEMS. REFER TO BUILDING
- SCHEMATICS FOR ALL EQUIPMENT LOCATIONS.

 THERE IS NO PLUMBING SCOPE IN THE LAUNDRY/OFFICE UNITS LOCATED IN BUILDING


DEMOLITION KEYNOTES: DX

- 1. DEMOLISH EXISTING PLUMBING (SANITARY, COLD WATER SUPPLY, HOT WATER SUPPLY, AND VENTING) BACK TO BRANCH.
- CONTRACTOR TO NOTIFY ENGINEER OF ANY DISCREPANCIES WITH EXISTING PIPING AFTER DEMOLITION OF THE WALLS AND CEILING, PRIOR TO PLUMBING DEMOLITION AND NEW
- . CONTRACTOR TO FIELD VERIFY EXISTING PIPE SIZES AND NOTIFY ENGINEER DURING DEMOLITION PHASE.
- 4. PLUMBING CONTRACTOR TO DISCONNECT NG AND REMOVE EXISTING WATER HEATER.

NEW WORK KEYNOTES: X

- CONTRACTOR TO FIELD ROUTE PIPING FROM DRAIN PAN, AND FURNACE CONDENSATE TO FLOOR DRAIN.
- 2. INSTALL THERMOSTATIC MIXING VALVE (TMV-01) AT SINKS AND LAVATORIES.
- 3. INSTALL AIR ADMITTANCE VALVE ON DRAIN FOR KITCHEN SINK.
- ROUTE PIPING TO WATER CLOSET ON INSIDE OF EXISTING WALL. NO WATER PIPING SHALL BE ROUTED IN EXTERIOR WALL.
- CONTRACTOR TO FIELD VERIFY EXISTING PIPE SIZES AND NOTIFY ENGINEER DURING DEMOLITION PHASE.
- 6. PLUMBING CONTRACTOR TO INSTALL AND PIPE EWH AND ELECTRICAL CONTRACTOR TO WIRE NEW EWH.



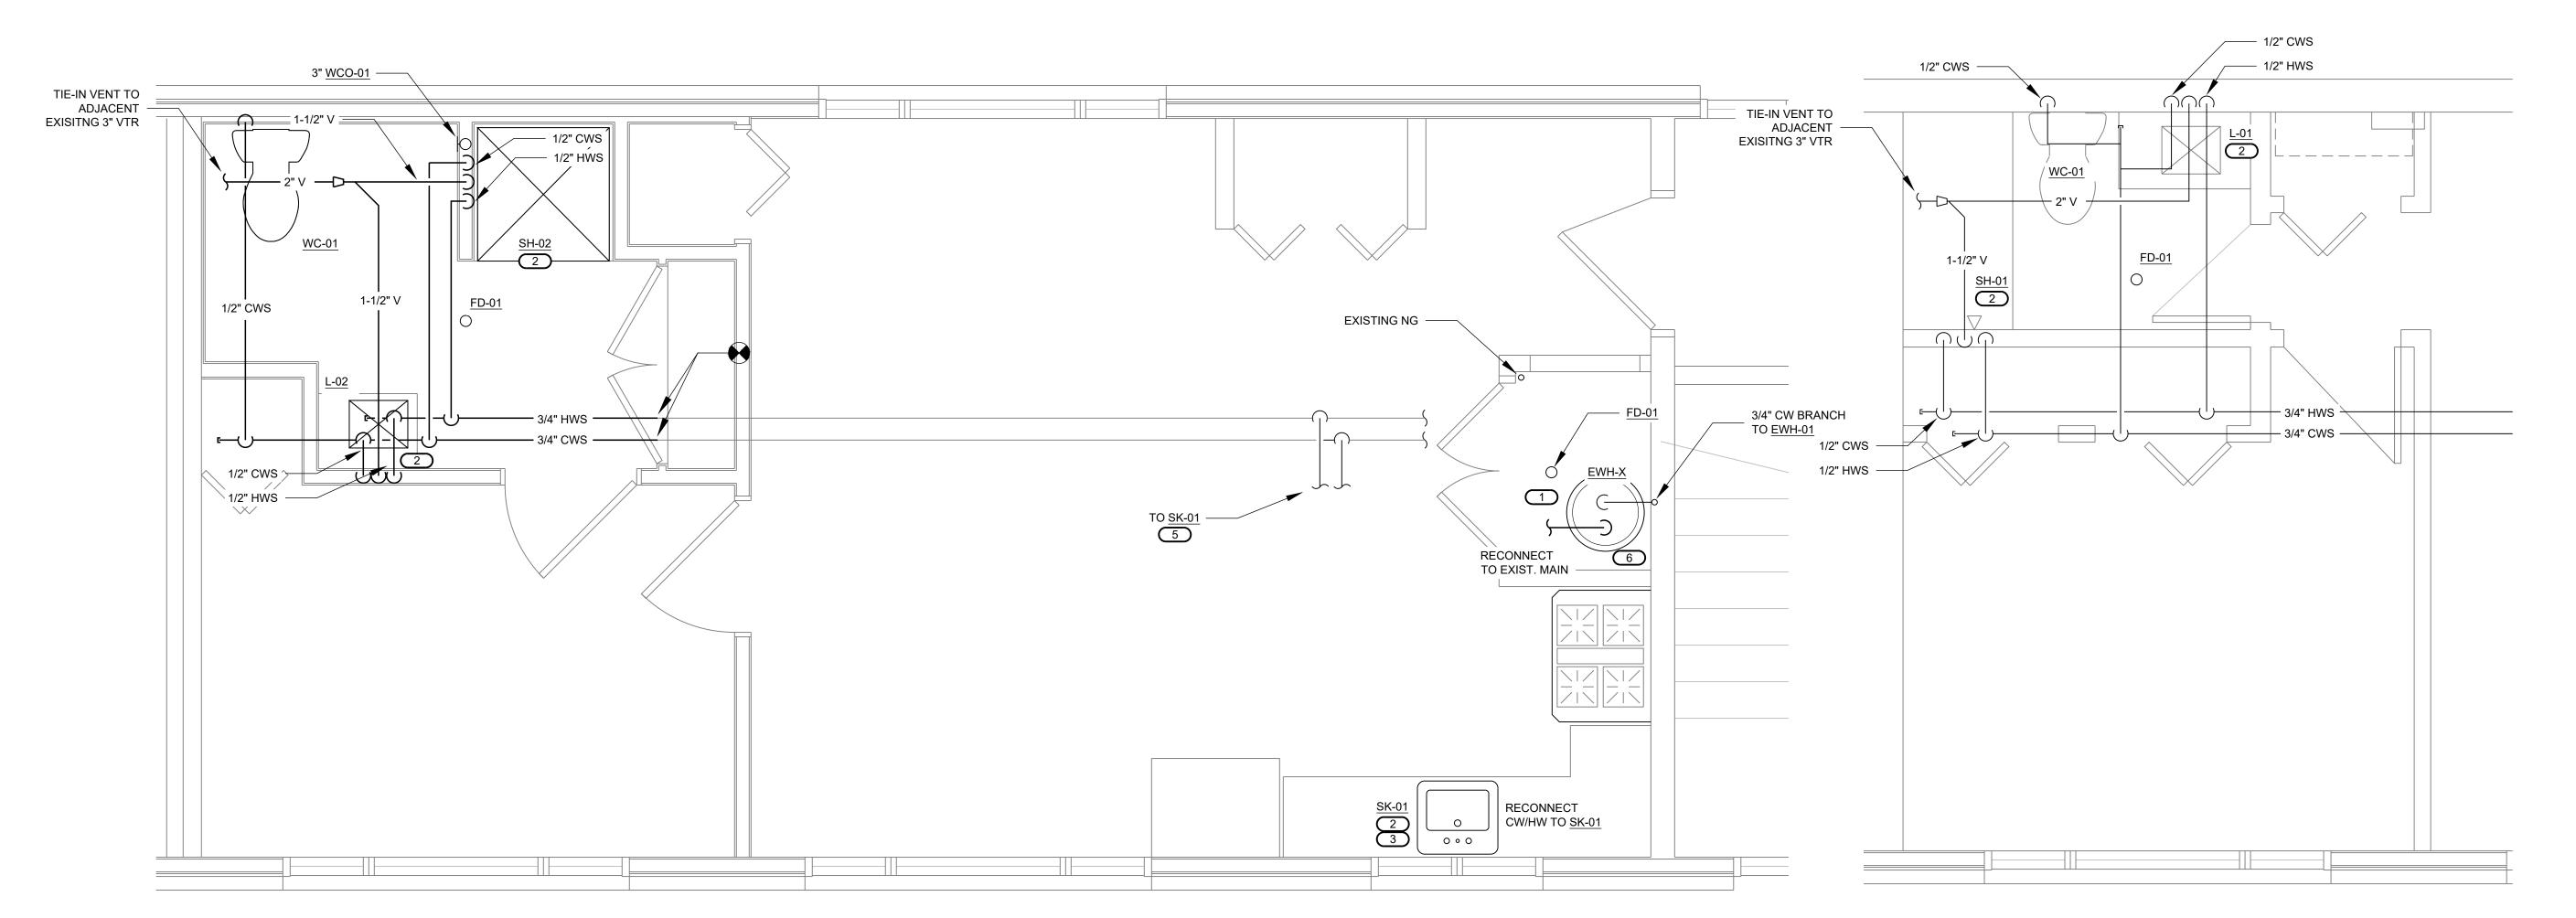

PARTIAL ABOVE GROUND FLOOR PLAN - NEW WORK

SCALE: 1/2" = 1'-0" (FOR 24"X36" DRAWING ONLY)

ADA UNITS

NON-ADA




ANN ARBOR HOUSING BROADWAY TERRACE

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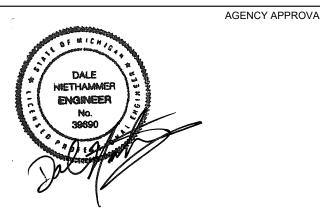


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No.	Date	Revision / Issue	
Α	12/18/2023	OWNER REVIEW	
В	03/12/2024	BIDS/PERMITS	
С	04/12/2024	BIDS/PERMITS	


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Issue	BIDS/PERMITS
Date	04/12/2024
Job Number	23004726.00
Drawn	J SATTELBERG
Checked	R OQUINN
Approved	D NIETHAMMER
	SHEET TITL
	PARTIAL FLOOR PLAN

PARTIAL FLOOR PLAN DEMO/NEW WORK

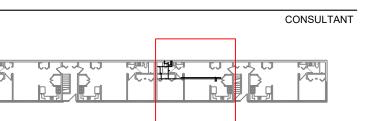
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P1.1



TYPICAL THERMOSTATIC MIXING VALVE DETAIL

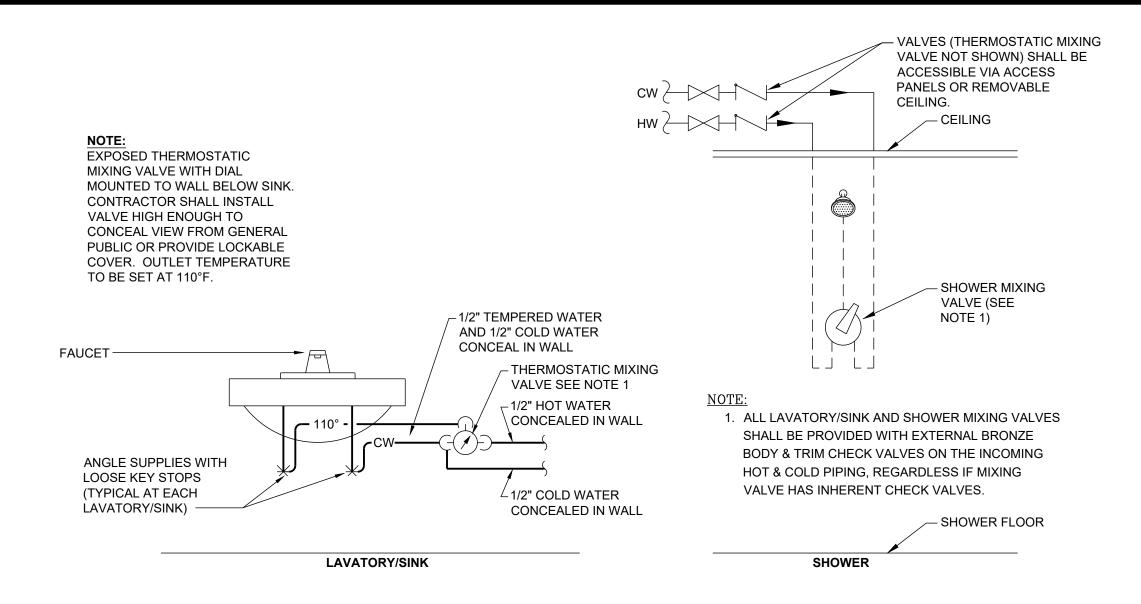

TYPICAL ELECTRIC WATER HEATER DETAIL
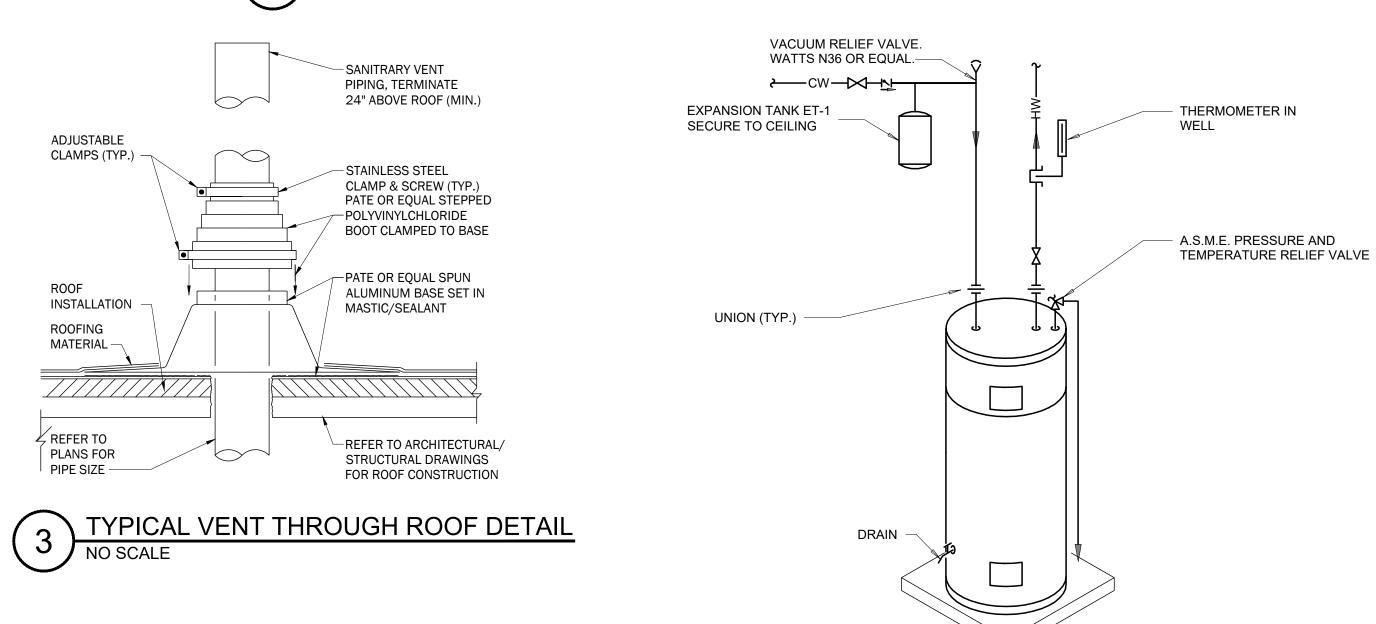
| ELECTRIC WATER HEATER SCHEDULE (EWH)

TAG NO.	LOCATION	TYPE	GPH @90° RISE	CW CONNECTION	TURN DN		ELECTRI	С	SHIP WEIGHT (LBS)	MANUFACTURER MODEL NO	REQUIRED OPTIONS	NOTES
EWH-01 THRU EWH-12	SEE PLANS	TANK 30 GAL. CAP.	21	3/4"	5:1	240	1	1500 - 6000	95	LOCHINVAR LET-30 DAK		ALL

1. ALL COMPONENTS SHALL BE OF THE MANUFACTURER AND MODEL

- NUMBER AS SCHEDULED OR APPROVED EQUAL. 2. INSTALLATION OF ALL COMPONENTS SHALL BE IN ACCORDANCE WITH MANUFACTURER'S REQUIREMENTS.
- 3. PROVIDE WATER HEATER WITH DRAIN PAN.

OPTIONS:

EXPANSION	TANK	SCHEDUL	_E (ET

				TANK		CONN SIZE					
TAG NO.	LOCATION SERVICE	TYPE	TANK VOL (GAL)	ACCEPT VOL (GAL)	SIZE (DIA x HEIGHT)	SHIP WT (LBS)	FILL	SYS	MANUFACTURER MODEL NO	REQUIRED OPTIONS	NOTES
ET-01 THRU ET-12	MECH CLOSET	VERTICAL BLADDER	2	0.9	8" x 14"	10	3/4"		AMTROL ST-5C-DD	-	1,2

NOTES:

1. ALL COMPONENTS SHALL BE OF THE MANUFACTURER AND MODEL NUMBER AS SCHEDULED OR

APPROVED EQUAL. 2. INSTALLATION OF ALL COMPONENTS SHALL BE IN ACCORDANCE WITH MANUFACTURER'S

PLUMBING COMPONENT SCHEDULE (AS NOTED)

TAG NUMBER	LOCATION SERVICE	CONN SIZE	DESCRIPTION	MANUFACTURER MODEL NO	REQUIRED OPTIONS	NOTES
TMV-01	SEE PLANS L-01, SK-01, SH-01	VARIES	THERMOSTATIC MIXING VALVE, 0.25 TO 2.25 GPM CAPACITY, ASSE STANDARD 1070, IAPMO CUPC LISTED, BRASS BODY, LEAD FREE.	WATTS LFUSG-B-M2		1,2,3
WCO-01	SEE PLANS	VARIES SEE PLANS	CLEANOUT TEE, DURA-COATED CAST IRON BODY, GAS AND WATERTIGHT ABS TAPERED THREAD PLUG, AND ROUND, SMOOTH STAINLESS STEEL WALL ACCESS COVER WITH SECURING SCREW.	ZURN Z1446		1,2,3
FD-01	SEE PLANS	VARIES SEE PLANS	FLOOR DRAIN, ADJUSTABLE COLLAR WITH SEEPAGE SLOTS, LEVELING STRAINER, TOP ASSEMBLY, DURA-COATED CAST IRON BODY WITH BOTTOM OUTLET, TRAP SEAL PROTECTION DEVICE (Z1072), POLISHED BRONZE GRATE.	ZURN Z415-BZ1		1,2,3,
. 04	DATUDOOMO	3/8" CW	22 3/4"x18"x5" DROP-IN RECTANGULAR BASIN, 4" CENTERS, VITREOUS CHINA	KOHLER K-2337-4	С	1,2,3
L-01	BATHROOMS 3/8" HW		LAVATORY FAUCET, MANUAL SINGLE HANDLE, 3 HOLE 4" CENTERSET DECK MOUNTED, MAX 1.2 GPM, POLISHED CHROME PLATED FINISH, METAL POP-UP DRAIN, INTEGRATED SUPPLY LINES.	DELTA 520-MPU-DST		1,2,3
	ADA	3/8" CW	22 3/4"x18"x5" DROP-IN RECTANGULAR BASIN, 4" CENTERS, VITREOUS CHINA	KOHLER K-2337-4	C,G,H	1,2,
L-02	BATHROOMS 3/8" HW		LAVATORY FAUCET, MANUAL SINGLE HANDLE, 3 HOLE 4" CENTERSET DECK MOUNTED, MAX 1.2 GPM, POLISHED CHROME PLATED FINISH, METAL POP-UP DRAIN, INTEGRATED SUPPLY LINES.	DELTA 520-MPU-DST	G	1,2,
SV 04	SEE DI ANIS	3/8" CW 3/8" HW	19 1/2"x13 1/2"x5 1/2" SINGLE BOWL, DROP-IN, 20 GAUGE 304 STAINLESS STEEL (SS) WITH BRUSHED FINISH, 3 1/2" REAR LEFT DRAIN, SS BODY STRAINER, BASKET RUBBER SEAL AND TAILPIECE (LK99), 3 HOLE 4" CENTERSET, QUICK CLIP MOUNTING SYSTEM, ADA COMPLIANT.	ELKAY PSRADQ191955L		1,2,
SK-01	SEE PLANS	3-1/2" D 1-1/2" V	MANUAL SINGLE HANDLE GOOSENECK 180° ROTATIONAL SPOUT, 3 HOLE 4" CENTERS, TOP MOUNT.	DELTA DSP-K-100-DST		1,2,
011.04		1/2" CW	SHOWER BASIN AND ASSEMBLY BY ARCHITECT	SPEC BY ARCH		1,2,
SH-01	BATHROOMS	1/2" HW 2" SAN	POLISHED CHROME SHOWER HEAD AND HANDLE, 1.5 GPM, PRESSURE BALANCED, FIELD ADJUSTABLE HANDLE ROTATION, INTEGRAL MIXING VALVE.	DELTA R10000-UN DELTA T13H132		1,2,
CI 1 02	ADA	1/2" CW	SHOWER BASIN AND ASSEMBLY BY ARCHITECT	SPEC BY ARCH	G	1,2,
SH-02	BATHROOMS	1/2" H/M		MOEN T12H323-20	G	1,2,
WC 04	DATUDOOMO	2.4/01.0451	1.6 GPF FLOOR MOUNT WATER CLOSET FLUSH TANK WITH ELONGATED STANDARD BOWL, PRESSURE FLUSH ASSIST, VITREOUS CHINA, WHITE FINISH.	KOHLER K-3493	G	1,2,
WC-01 BATHROOMS			QUIET CLOSE ELONGATED TOILET SEAT, 5 1/2" MOUNTING HOLES, SOLID WHITE FINISH.	KOHLER K-20110	G	1,2,

1. ALL COMPONENTS SHALL BE OF THE MANUFACTURER AND MODEL NUMBER AS

WITH OTHER TRADES, ARCHITECTURAL AND VENDOR DRAWINGS, PRIOR TO POURING

- SCHEDULED OR APPROVED EQUAL. 2. INSTALLATION OF ALL COMPONENTS SHALL BE IN ACCORDANCE WITH
- MANUFACTURER'S REQUIREMENTS. 3. DIAGRAMMATICALLY INDICATE THE GENERAL LOCATIONS OF DRAINAGE FIXTURES AND DO NOT PROVIDE EXACT SCALE OR LOCATIONS. PROPER INSTALLATION, AFTER COORDINATION
- CONCRETE, IS THE CONTRACTORS RESPONSIBILITY. 4. PROVIDE MECHANICAL TRAP SEAL (SURESEAL OR APPROVED EQUAL)

A. MOUNTING BRACKET B. UNION CONNECTIONS

- C. QUARTER TURN BALL VALVES D. STRAINER
- E. AIR GAP DRAIN FITTING

COMPLIANT REMOVABLE COVER (TRUEBRO)

F. PRESSURE FLUSH ASSIST BLADDERG. G. FIXTURE AND INSTALLATION TO BE ADA COMPLIANT

H. PROVIDE WITH CHROME PLATED P-TRAP AND ADA

SHEET NUMBER

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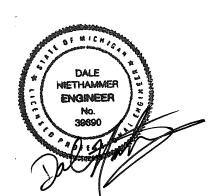
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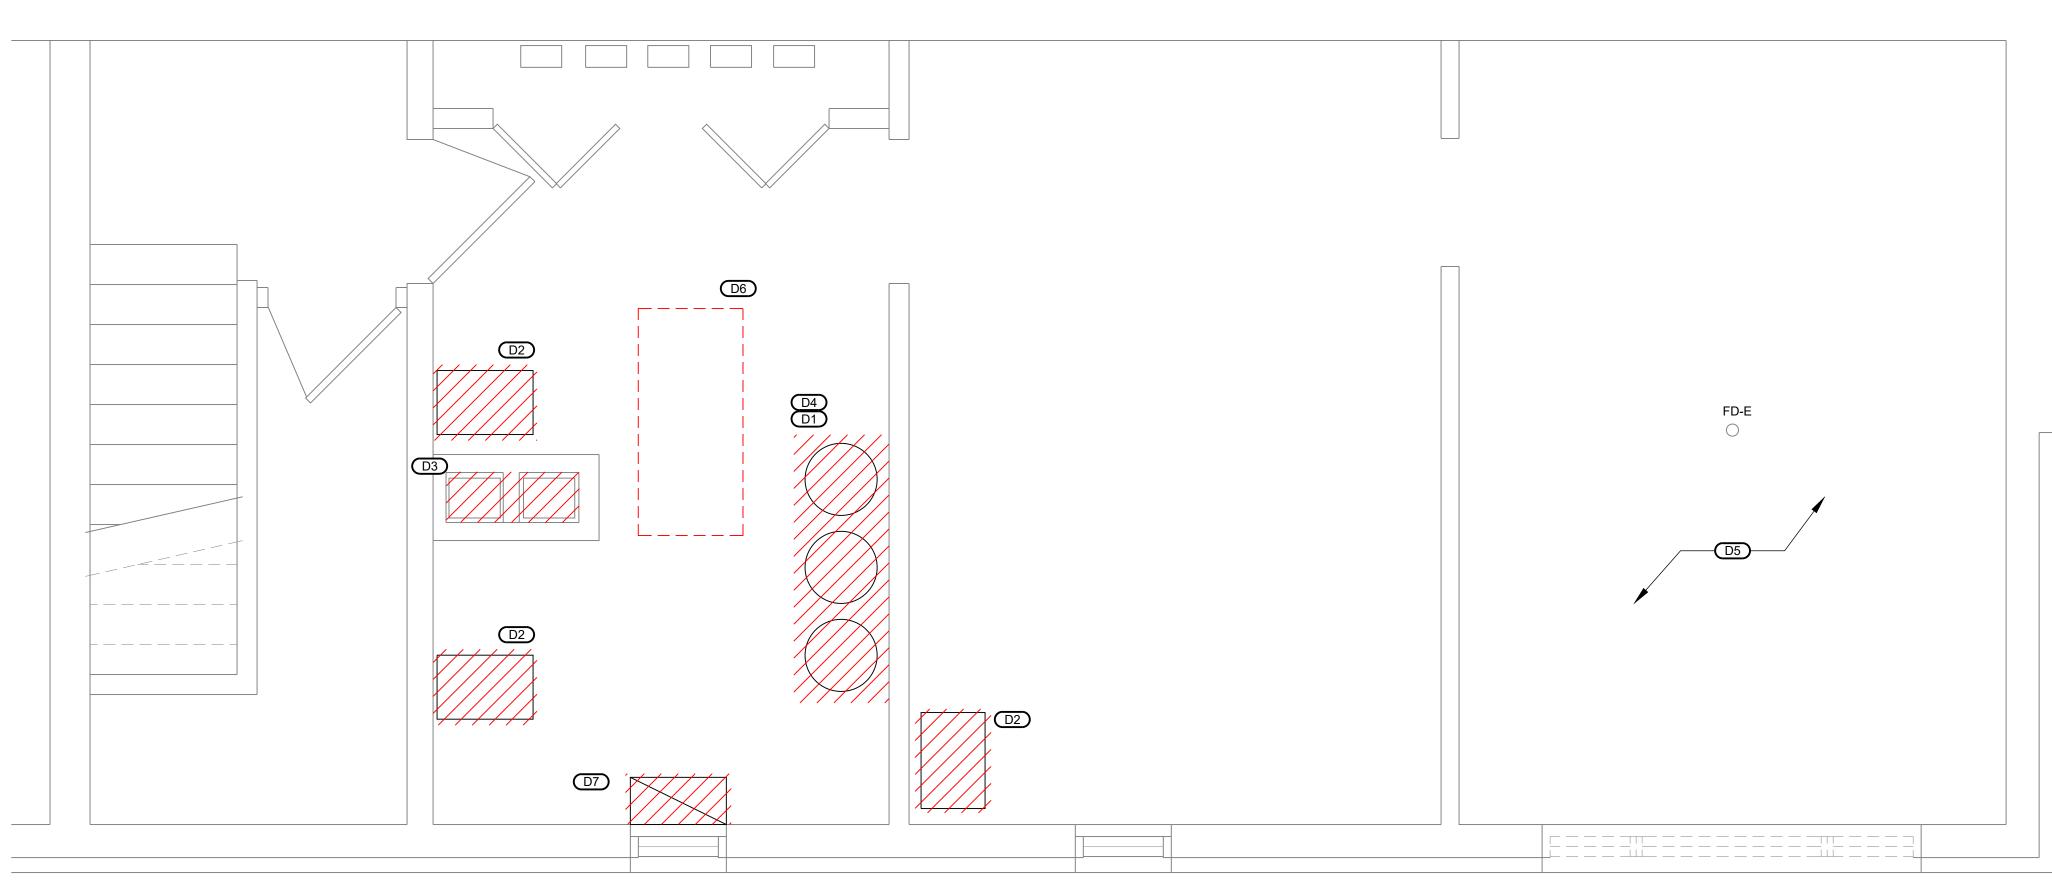
REVISIONS

Revision / Issue 12/18/2023 OWNER REVIEW BIDS/PERMITS 04/12/2024 **BIDS/PERMITS**

SHEET INFORMATION BIDS/PERMITS 04/12/2024 23004726.00 J SATTELBERG R OQUINN D NIETHAMMER


PLUMBING SCHEDULES AND **DETAILS**

P2.0



BASEMENT FLOOR PLAN - DEMOLITION

SCALE: 1/2" = 1'-0" (FOR 24"X36" DRAWING ONLY)

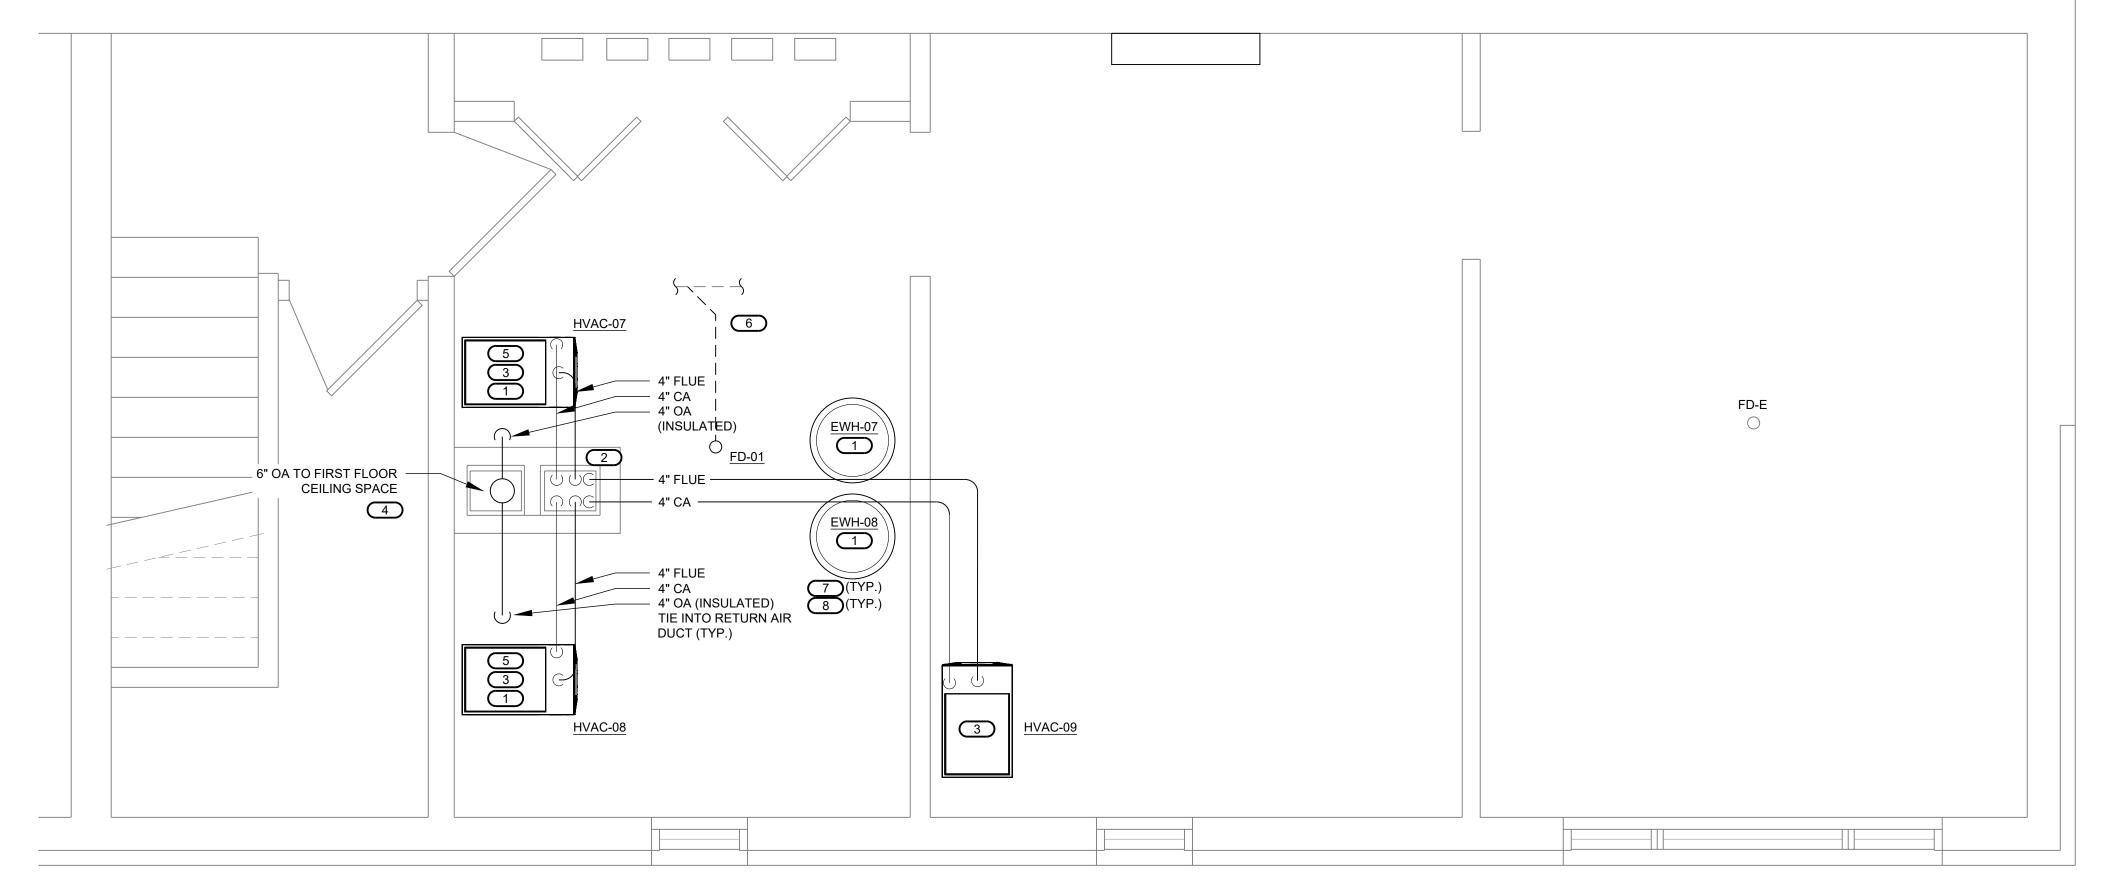

GENERAL NOTES:

- SEE GENERAL NOTES, SPECIFICATIONS, AND ADDITIONAL PROJECT INFORMATION ON
- GENERAL DRAWINGS.
 2. NEW WORK SHOWN IN BOLD.
- B. DRAWINGS DIAGRAMMATICALLY INDICATE THE GENERAL SCOPE OF WORK, BUT DO NOT PROVIDE EXACT SCALE OR LOCATIONS. PROPER INSTALLATION OF ALL SYSTEMS, AFTER COORDINATION WITH OTHER TRADES, IS THE CONTRACTORS RESPONSIBILITY.

DEMOLITION KEYNOTES: DX

- 1. DEMOLISH EXISTING WATER HEATER, LEAVE EXISTING COLD WATER, AND HOT WATER TO BE RECONNECTED TO NEW EWH. DEMOLISH EXISTING NATURAL GAS LINE BACK TO MAIN
- DEMOLISH EXISTING FURNACE, LEAVE ALL EXISTING DUCTWORK AND NATURAL GAS SUPPLY
- TO BE RECONNECTED TO NEW FURNACE.

 3. CONTRACTOR TO DEMOLISH EXISTING CHASE.
- 5. CONTRACTOR TO DEMOCION EXISTING GNASE.
- 4. EXISTING EQUIPMENT PAD UNDER WATER HEATERS TO REMAIN.5. CONTRACTOR TO REMOVE EXISTING DRYERS AND TURN OVER TO OWNER
- 6. CONTRACTOR TO LOCATE EXISTING SANITARY PIPING. ONCE LOCATED CONTRACTOR TO SAWCUT FLOORING TO EXPOSE SANITARY PIPING FOR INSTALLATION OF NEW FLOOR DRAIN.
- REMOVE EXISTING COMBUSTION AIR DUCT AND SEAL EXISTING WALL OPENING.

NEW WORK KEYNOTES: X

- 1. CONTRACTOR TO FIELD ROUTE PIPING FROM DRAIN PAN, AND FURNACE CONDENSATE TO FD-01.
- 2. ALL FLUE AND COMBUSTION AIR TO BE ROUTED THROUGH EXISTING CHASE AREA THROUGH ROOF. CONTRACTOR TO COORDINATE WITH ARCHITECT FOR ANY FURRING NECESSARY TO FIT PIPES IN THIS SPACE.
- 3. CONTRACTOR TO TIE NEW DUCTWORK INTO EXISTING.
- 4. OUTDOOR AIR TO BE ROUTED UP TO FIRST FLOOR CEILING SPACE AND THROUGH SOUTH EXTERIOR WALL AS SHOWN ON BUILDING ELEVATION.
- 5. CONTRACTOR TO FIELD ROUTE ALL REFRIGERANT PIPING FROM COOLING COILS TO CONDENSING UNITS.
- 6. INSTALL FLOOR DRAIN, AND SANITARY PIPING. BACKFILL TRENCH AND INSTALL CONCRETE.
- 7. ALL WATER HEATERS TO BE INSTALLED WITH DRAIN PANS.
- 8. PLUMBING CONTRACTOR TO INSTALL AND PIPE EWH AND ELECTRICAL CONTRACTOR TO WIRE NEW EWH.




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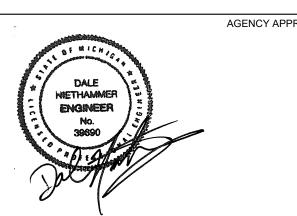


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Date Revision / Issue

03/12/2024 BIDS/PERMITS

04/12/2024 BIDS/PERMITS

 SHEET INFORMATION

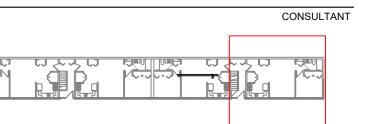 SSUE
 BIDS/PERMITS

 Date
 04/12/2024

 Job Number
 23004726.00

 Drawn
 J SATTELBERG

 Checked
 R OQUINN

 Approved
 D NIETHAMMER

SHEET TITLE
BASEMENT MECH/PLUMBING


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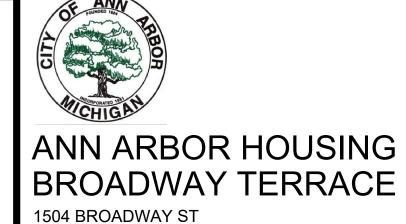
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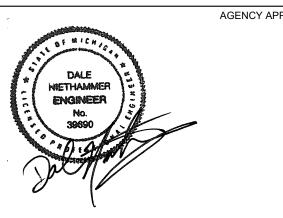


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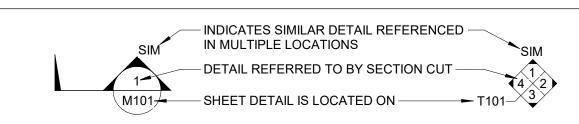
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Α	12/18/2023	OWNER REVIEW	
В	03/12/2024	BIDS/PERMITS	
С	04/12/2024	BIDS/PERMITS	

	SHEET INFORMATION
Issue	BIDS/PERMITS
Date	04/12/2024
Job Number	23004726.00
Drawn	J SATTELBERG
Checked	R OQUINN
Approved	D NIETHAMMER
	SHEET TITLE
	BUILDING ELEVATION

SCALE

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INDICATES DIRECTION OF TRUE NORTH

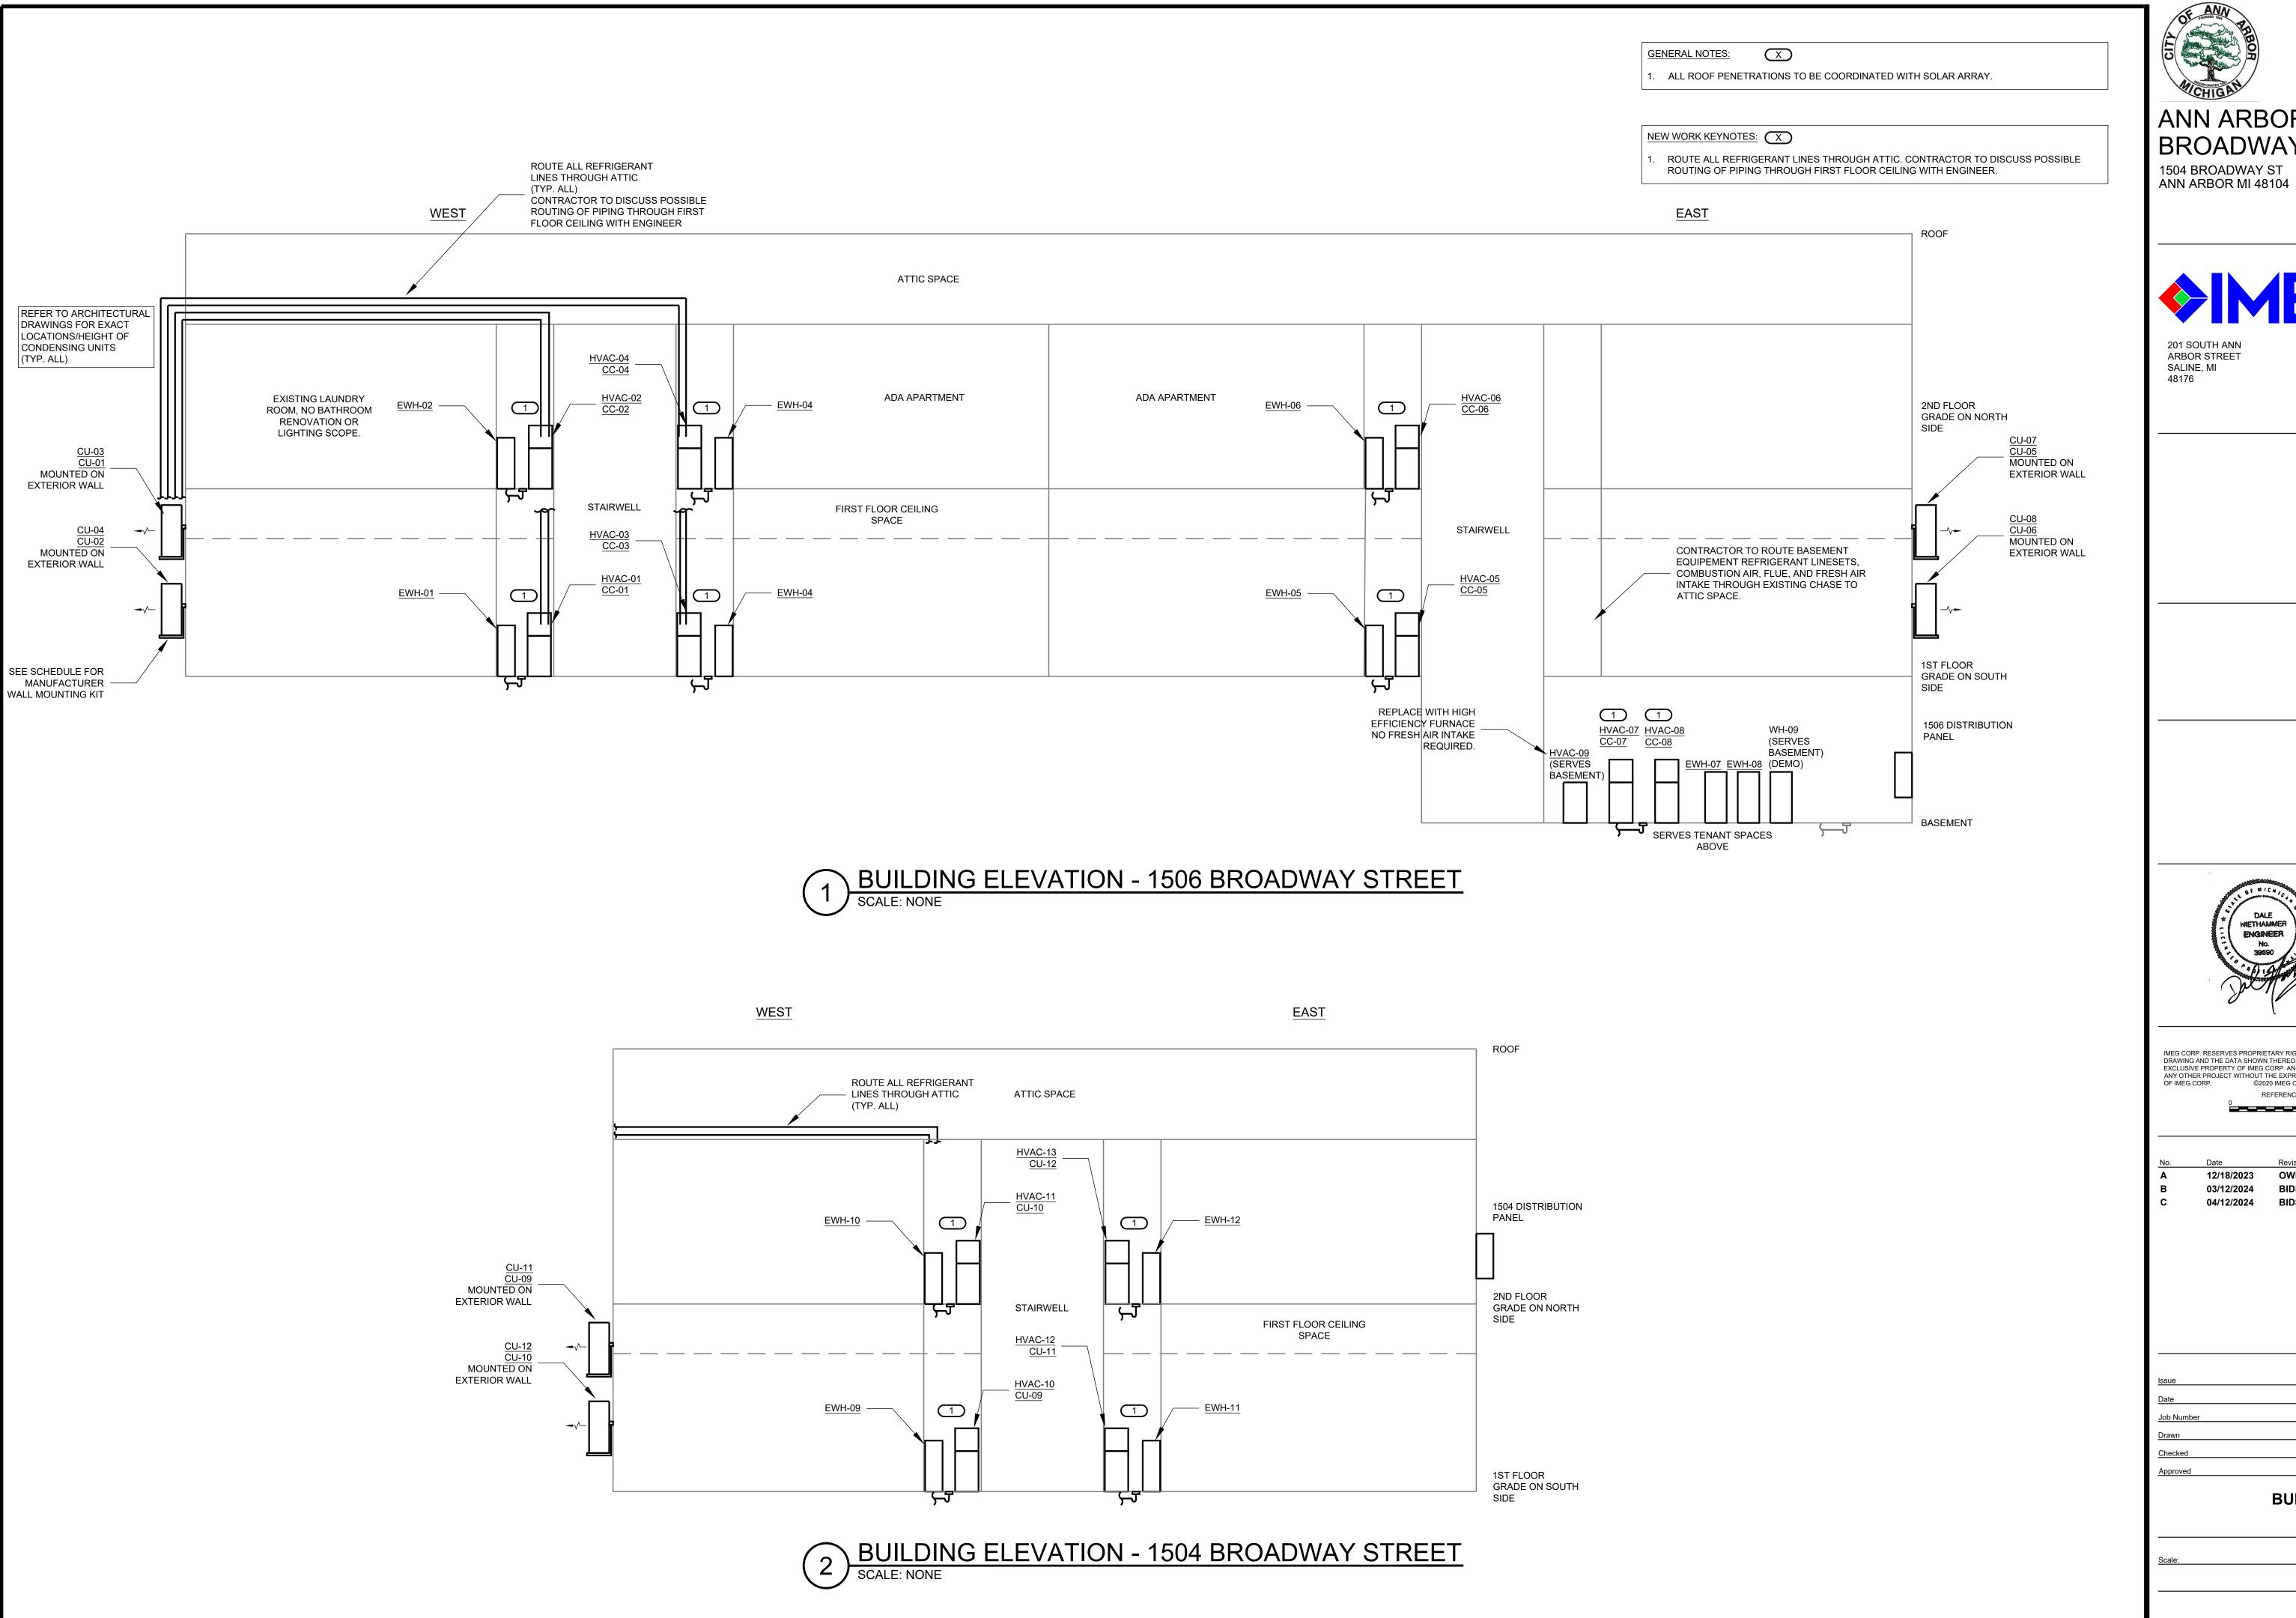

LINE TYPE AND TAG KEY:

NEW WORK BY THIS CONTRACTOR (WIDE LINE)

----- EXISTING TO BE REMOVED (SHORT DASHED PATTERN) — — NEW UNDERFLOOR OR UNDERGROUND (LONG DASHED PATTERN)

EXISTING TO REMAIN OR WORK BY OTHERS (NARROW LINE) — EXISTING

---- EXISTING TO BE REMOVED BY OTHERS (SHORT DASHED PATTERN) — — EXISTING UNDERFLOOR OR UNDERGROUND (LONG DASHED PATTERN)

HALFTONING DOES NOT MODIFY SCOPE.

V.C. VENTILATION CONTRACTOR

'TAG'-E TAGS WITH DASH 'E' INDICATES THE REFERENCED OBJECT IS EXISTING

UNDERLINED TAG INDICATES OBJECT IS IN-SCOPE. IF NEW, ADDITIONAL INFORMATION IS AVAILABLE IN A SCHEDULE, MATERIAL LIST, OR SYMBOL LIST

INDICATES AN EXISTING SYSTEM'S POINT OF CONNECTION/REMOVAL

CONTRACTOR ABBREVIATION KEY

ABBR:	DESCRIPTION:
A.C.	ASBESTOS ABATEMENT CONTRACTOR
A.V.C.	AUDIO/VISUAL CONTRACTOR
C.C.	CIVIL CONTRACTOR
C.M.	CONSTRUCTION MANAGER
E.C.	ELECTRICAL CONTRACTOR
F.P.C.	FIRE PROTECTION CONTRACTOR
F.S.C.	FOOD SERVICE CONTRACTOR
G.C.	GENERAL CONTRACTOR
H.C.	HEATING CONTRACTOR
M.C.	MECHANICAL CONTRACTOR
N.C.C.	NURSE CALL CONTRACTOR
P.C.	PLUMBING CONTRACTOR
S.C.	SECURITY CONTRACTOR
T.C.	TECHNOLOGY CONTRACTOR
T.C.C.	TEMPERATURE CONTROLS CONTRACTOR

	ELECTRICAL ABBREVIATION KEY
ABBR:	DESCRIPTION:
ABV	ABOVE
AFC	ABOVE FINISHED CEILING
AFF	ABOVE FINISHED FLOOR
AFG	ABOVE FINISHED GRADE
ASR	ARCHITECTURAL SURFACE RACEWAY
ВС	BELOW COUNTER
С	CONDUIT (BRANCH CIRCUIT OR FEEDER CONTEXT)
CO	CONDUIT AND BOX ROUGH-IN ONLY (ROUGH-IN ONLY)
EG	EQUIPMENT GROUND
EGC	EQUIPMENT GROUNDING CONDUCTOR
EOL	END OF LINE
EPO	EMERGENCY POWER OFF
GFR	GROUND FAULT REMOTE
НОА	HAND/OFF/AUTO
ITR	IT RACK MOUNTED RECEPTACLE
NC	NORMALLY CLOSED
NEMA#	NEMA RATING
NIC	NOT IN CONTRACTED SCOPE
NO	NORMALLY OPEN
ROOF	EQUIPMENT LOCATED ON ROOF ABOVE
SM	SURFACE MOUNTED
TYP	TYPICAL
UG	UNDERGROUND
UON	UNLESS OTHERWISE NOTED

ELECTRICAL RENOVATION NOTES:

THESE NOTES APPLY TO ALL ELECTRICAL SHEETS AND TRADES, INCLUDING BUT NOT LIMITED TO, LIGHTING, POWER, FIRE ALARM, AND OTHER LOW VOLTAGE SYSTEMS.

1. EXISTING CONDITIONS ARE SHOWN BASED ON INFORMATION OBTAINED FROM FIELD SURVEYS, EXISTING BUILDING DOCUMENTS. CONTRACTOR SHALL REVIEW EXISTING

CONDITIONS AND REPORT CONFLICTS. 2. NOT ALL EXISTING EQUIPMENT, LUMINAIRES, AND CONDUIT ARE SHOWN. CONTRACTOR

SHALL REVIEW EXISTING CONDITIONS AND REPORT CONFLICTS. 3. CONTRACTOR SHALL REVIEW EXISTING CONDITIONS PRIOR TO FABRICATION OF CABLE TRAY, BUSWAY, CONDUIT RACKS, AND OTHER SYSTEMS. RISES AND DROPS MAY BE

NECESSARY BECAUSE OF EXISTING FIELD CONDITIONS. 4. ELECTRICAL CONTRACTOR SHALL REVIEW EXISTING CONDITIONS TO VERIFY ACCESSIBILITY TO THE AREAS OF THEIR WORK INCLUDING WALLS, FLOOR, CEILINGS, CEILING TILES/GRID, AND ROOF. ELECTRICAL CONTRACTOR IS RESPONSIBLE TO PROVIDE CUTTING, REMOVAL. PATCHING, AND REINSTALLATION OF AFFECTED AREAS ASSOCIATED WITH THEIR WORK BY

COORDINATING WITH THE GENERAL CONTRACTOR OR QUALIFIED CONTRACTOR. 5. WHERE EXISTING ELECTRICAL SYSTEMS ARE LOCATED IN AREAS THAT CONFLICT WITH NEW EQUIPMENT, PIPING, OR DUCTWORK TO BE INSTALLED, EACH CONTRACTOR SHALL EITHER ARRANGE NEW EQUIPMENT, CONDUIT, OR DUCTWORK IN SUCH A FASHION THAT IT DOES NOT CONFLICT WITH EXISTING SYSTEMS, OR REWORK EXISTING ELECTRICAL SYSTEMS TO ALLOW FOR INSTALLATION OF NEW EQUIPMENT, PIPING, OR DUCTWORK.

ELECTRICAL INSTALLATION NOTES:

- 1. THE COMPLETE INSTALLATION SHALL BE IN ACCORDANCE WITH THE ADA STANDARDS FOR ACCESSIBLE DESIGN. REFER TO THE ADA GUIDELINES FOR ALL CONFIGURATION DETAILS ON THIS PAGE FOR ADDITIONAL INFORMATION.
- 2. CIRCUIT NUMBERS ARE SHOWN FOR CIRCUIT IDENTIFICATION. CIRCUITING SHALL AGREE WITH NUMBERING ON THE PANEL PROVIDED. COMMON NEUTRALS MAY NOT BE USED FOR BRANCH CIRCUITS. BALANCE THE LOAD ON PANEL AS EVENLY AS POSSIBLE BETWEEN EACH
- 3. FLUSH MOUNT ALL LIGHTING CONTROL DEVICES AT +42" FROM FLOOR (CENTERLINE DIMENSION), EXCEPT WHERE OTHERWISE NOTED.
- 4. FLUSH MOUNT ALL DUPLEX RECEPTACLES AND TECHNOLOGY OUTLETS AT +18" FROM FLOOR (CENTERLINE DIMENSION), EXCEPT WHERE OTHERWISE NOTED. RECEPTACLES AND OUTLETS MAY BE SURFACE MOUNTED WHEN CONDUIT IS SPECIFIED EXPOSED. MOUNT EXTERIOR LOCATED RECEPTACLES WITH WHILE-IN-USE COVERS AT +20" FROM FINISHED GRADE (CENTER DIMENSIONS) TO MAINTAIN INSTALLATION ADA COMPLIANCE.
- 5. ALL MATERIALS USED TO SEAL PENETRATIONS OF FIRE RATED WALLS AND FLOORS SHALL BE TESTED AND CERTIFIED AS A SYSTEM PER ASTM E814 STANDARDS FOR FIRE TESTS OF THROUGH-PENETRATION FIRESTOPS. REFER TO [27 05 03 AND 28 05 03] [DIVISION 7] [26 05 03] FOR ADDITIONAL INFORMATION AND REQUIREMENTS SPECIFIC TO FIRESTOPPING.
- 6. CONNECTION FOR ELECTRIC WATER COOLERS (EWC) SHALL BE A JUNCTION BOX CONCEALED BEHIND WATER COOLER ACCESS PLATE OR BE A GFI RECEPTACLE LOCATED DIRECTLY BELOW AND CENTERED ON EWC. CONTRACTOR SHALL VERIFY TYPE OF EWC TO
- BE INSTALLED. MOUNT ALL FIRE ALARM PULL STATIONS AT +42" FROM FLOOR (CENTERLINE DIMENSION)
- EXCEPT WHERE OTHERWISE NOTED. 8. INSTALL ALL WALL MOUNTED FIRE ALARM NOTIFICATION DEVICES AT 90" ABOVE FINISHED FLOOR OR 6" BELOW THE CEILING, WHICHEVER IS LOWER, EXCEPT WHERE OTHERWISE
- NOTED. HEIGHT SHALL BE MEASURED TO THE TOP OF THE DEVICE. 9. CONTRACTOR SHALL COORDINATE THE LOCATION OF ALL CEILING MOUNTED DEVICES AND EQUIPMENT WITH LUMINAIRES, SPRINKLER, AND CEILING DIFFUSERS. CENTER ALL DEVICES IN CEILING TILE PATTERN. SMOKE DETECTORS, CARBON MONOXIDE DETECTORS, AND OCCUPANCY/VACANCY SENSORS SHALL BE LOCATED NO CLOSER THAN 3 FEET TO AN AIR SUPPLY DIFFUSER OR RETURN GRILLE. CARBON MONOXIDE DETECTORS SHALL BE LOCATED
- 10 PLUS FT FROM FIRE PLACES, COOKING, AND SIMILAR FUEL-BURNING APPLIANCES. 10. CONTRACTOR SHALL VERIFY ALL FURNITURE, MODULAR FURNITURE, AND EQUIPMENT LOCATIONS WITH ARCHITECTURAL PLANS, ELEVATIONS, AND REVIEWED SHOP DRAWINGS. PRIOR TO MAKING THE ACTUAL ELECTRICAL INSTALLATION, THIS CONTRACTOR SHALL ADJUST RECEPTACLES, OUTLETS, OR CONNECTION LOCATIONS TO ACCOMMODATE FURNITURE AND/OR EQUIPMENT.
- 11. ELECTRICAL AND TECHNOLOGY EQUIPMENT SHALL BE MOUNTED TO AVOID IMPEDANCE OF, OPERATION OF, AND/OR ACCESS TO ELECTRICAL AND MECHANICAL EQUIPMENT. ALL MOUNTING OF ELECTRICAL AND TELECOMMUNICATIONS EQUIPMENT, ON EQUIPMENT SUPPLIED BY ANOTHER CONTRACTOR, SHALL BE APPROVED IN ADVANCE BY THE OTHER CONTRACTOR.
- 12. CONTRACTOR SHALL BE RESPONSIBLE FOR ALL OPENINGS REQUIRED IN WALLS. ALL OPENINGS SHALL BE REPAIRED TO MATCH EXISTING BY A QUALIFIED CONTRACTOR AT THE EXPENSE OF THIS CONTRACTOR. ALL CONDUITS THROUGH WALLS SHALL BE GROUTED OR
- SEALED INTO OPENINGS. 13. EACH CONTRACTOR IS RESPONSIBLE FOR DAMAGE CAUSED BY THEIR ACTIONS TO THE WALLS, FLOORS, CEILINGS, AND ROOFS. THE CONTRACTOR WHOSE WORK CAUSES DAMAGE IS RESPONSIBLE FOR PATCHING TO MATCH ORIGINAL CONSTRUCTION, FIRE RATING, AND
- 14. REFER TO ARCHITECTURAL REFLECTED CEILING PLAN, ELECTRICAL, TECHNOLOGY AUDIO/VISUAL, AND OTHER ELECTRICAL PLANS FOR EXACT LOCATIONS OF ALL CEILING
- MOUNTED DEVICES. OTHER THAN SPRINKLERS. 15. ELECTRICAL IDENTIFICATION. REFER TO SPECIFICATION SECTION 26 05 53 FOR COLOR/LABEL

1	ELEC		SYMBOL LIST
SYMBOL:	TAG:	SPEC SECTION:	DESCRIPTION:
;; (S)	<u>FA-122</u>	28 31 00	FIRE ALARM DUCT SMOKE DETECTOR
			# = EQUIP OR SYSTEM
(S) ^{AS}	ASSD-#	28 31 50	FIRE ALARM AIR SAMPLING SMOKE DETECTION
F F F	<u>FA-210</u>	28 31 00	AUDIO HORN/CHIME ALARM DEVICE, CEILING OR WALL MOUNTED
			M = MINI-HORN S = SLEEPING / PATIENT ROOM
	<u>FA-211</u>	28 31 00	COMBINATION AUDIO HORN/CHIME AND VISUAL ALARM DEVICE, CEILING OR WALL MOUNTED
			# = CANDELA RATING CD = CANDELA RATING SELECTED BY NICET DESIGNER
S ◀ S ◀	FA-220	28 31 00	AUDIO (SPEAKER) ALARM DEVICE, CEILING (WALL MOUNTED
# #	<u>FA-221</u>	28 31 00	COMBINATION AUDIO (VOICE) AND VISUAL ALARM DEVICE, CEILING OR WALL MOUNTED
			# = CANDELA RATING CD = CANDELA RATING SELECTED BY NICET DESIGNER

ELECTRICAL SYMBOL LIST SPEC DESCRIPTION. CVMDOL

SYMBOL:	TAG:	SECTION:	DESCRIPTION:
GB	<u>GB</u>	26 05 26	GROUND BUS
IBT	<u>IBT</u>	26 05 26	INTERSYSTEM BONDING TERMINATION
E E	<u>ECONN</u>	26 05 33	ELECTRICAL CONNECTION
0-	<u>JB</u>	26 05 33	JUNCTION BOX
	<u>FB-#</u> or <u>PT-#</u>	26 27 26	FLOOR BOX or POKE THROUGH
DEM	<u>DEM</u>	26 09 13	ENERGY METER
DPM	<u>DPM</u>	26 09 13/ 26 24 13	DIGITAL POWER METER
EEM	<u>EEM</u>	26 09 13	EXTERNAL ENERGY METER
PQM	<u>PQM</u>	26 09 13	POWER QUALITY METER
	PANEL '###'	26 24 16	PANELBOARD - RECESS MOUNT
	PANEL '###'	26 24 16	PANELBOARD - SURFACE MOUNT
	MX-#/MS-# /CB-#/CS-#	26 24 19	MANUAL SWITCH / STARTER / COMBINATION STARTER/ CIRCUIT BREAKER. REFER TO DISC/STA SCHEDULE
	<u>IPP-#</u>	26 24 21	ISOLATED POWER PANEL
	<u>CB-#</u>	26 28 16	CIRCUIT BREAKER - SURFACE MOUNTED. REFER TO DISC/STA SCHEDULE
ㅁ	<u>CB-#</u>	26 28 16	CIRCUIT BREAKER - FLUSH MOUNTED. REFER TO DISC/STA SCHEDULE
	DS-#/FDS-#/DSS-#	26 28 16	DISCONNECT. REFER TO DISC/STA SCHEDULE
	MD-SD-#	26 28 16	MOBILE DIAGNOSTICS SERVICE DISCONNECT. REFER TO DISC/STA SCHEDULE
⇒	REC-DUP	26 27 26	DUPLEX RECEPTACLE, 125V
* ♥	REC-DUP-GFI	26 27 26	DUPLEX GFI RECEPTACLE, 125V
₩	REC-DUP-WP	26 27 26	DUPLEX GFI WEATHERPROOF RECEPTACLE 12
⇒	REC-ARC	26 27 26	ARC FAULT CIRCUIT INTERRUPTER RECEPT 12
₩ AF	REC-AFGF	26 27 26	REC AFCI, GFCI, TAMPER RESISTANT
- - 	REC-TAMP	26 27 26	DUPLEX RECEPTACLE, TAMPER RESISTANT, 12
≒⊜ >	REC-TAMP-GFI	26 27 26	GFI DUPLEX RECEPTACLE,

	ELEC	TRICAL	SYMBOL LIST		
SYMBOL:	TAG:	SPEC SECTION:	DESCRIPTION:		
			LINEAR LUMINAIRES		
			TROFFER		
			WALL SCONCE LUMINAIRE		
0			DOWNLIGHT LUMINAIRE		
(0			AIMABLE OR WALL WASH LUMINAIRE		
•	REFER TO LU		INDUSTRIAL LUMINAIRE		
오모	SCHED	ULE	WALL BRACKET LUMINAIRE		
□			POLE MOUNTED LUMINAIRE		
			SINGLE FACE EXIT SIGN		
			DOUBLE FACE EXIT SIGN		
**			WALL/CEILING EMERGENCY EXIT SIGN		

II - ANSI/IES TYPE 2...

III - ANSI/IES TYPE 3..

IV - ANSI/IES TYPE 4.

RE - RECESSED

SU - SURFACE

EB - ELECTRONIC

O - OTHER (SEE DESCRIPTION)

ELV - ELECTRONIC LOW...

ACCESSORIES TO BE ORDERED. THE FIRST MANUFACTURER LISTED IS THE BASIS OF DESIGN.

WL - WALL

DMX - DIGITAL MULTIPLEX EM - EMERGENCY BATTERY

LED LUMINAIRE SCHEDULE

RS - REGRESSED STEEL V - ANSI/IES TYPE 5...

CFSA - COLOR-FINISH SELECTION BY ARCHITECT

FR - FLANGED RECESSED UC - UNDER CABINET

DESCRIPTION

CL - CEILING SURFACE SP - SUSPENDED

(DESC) DOOR:

FINISH:

(MTG) MOUNTING:

CV - COVE

PL - POLE YPE) DRIVER:

OTHERWISE...

P - PERIMETER

DALI - DIGITAL..

0-10V - 0-10V DIMMING

4' LED STRIP LIGHT

WM WALL WASH TUBE

ROUND LOW PROFILE FLUSH LED

BATHROOM EXHAST FAN WITH LED LIGHT

LED UNDERCABINET LIGHTING

WALL LIGHT WITH PULLSTRING

FA - FLAT ALUMINUM

FS - FLAT STEEL

RA - REGRESSED...

PAF - PAINT AFTER...

EMERGENCY UNIT

BEAMWIDTH:

SP - SPOT

MD - MEDIUM

VWD - VERY WIDE

WW - WALL WASH

HL - HIGH/LOW (100%/50%)..

LINE - LINE VOLTAGE..

CATALOG NUMBER SHALL NOT BE CONSIDERED COMPLETE AND MATERIAL SHALL NOT BE ORDERED BY MANUFACTURER AND CATALOG NUMBER ONLY. THE COMPLETE DESCRIPTION AND THE SPECIFICATION SHALL BE COORDINATED WITH THE CATALOG NUMBER TO DETERMINE THE EXACT MATERIAL AND

VERIFY AND COORDINATE ALL CEILING TYPES WITH LUMINAIRE MOUNTING AND TRIM REQUIREMENTS PRIOR TO THE RELEASE OF THE LUMINAIRE ORDER.

UNLESS INDICATED ON LIGHTING PLANS OR BELOW, REFER TO ARCHITECTURAL AND INTERIOR DESIGN ELEVATIONS, SECTIONS AND DETAILS FOR ALL..

INTERIOR CORRELATED COLOR TEMPERATURE [2700, 3000, 3500, 4000/4100]K, COLOR RENDERING INDEX (CRI) AT OR ABOVE [80, 85, 90], UNLESS NOTED

REFER TO SPECIFICATION SECTIONS [LED LIGHTING 26 51 19] [AND EMERGENCY LIGHTING INVERTER 26 52 15] FOR ADDITIONAL INFORMATION AND

MTG WATTS TYPE QTY

SU 26 W LED

RE | 15 W | LED |

SU 100 W LED

SU 10 W LED

LED

WL 50 W

CONFIRM ALL COLORS AND FINISHES OF ALL LUMINAIRE COMPONENTS WITH ARCHITECT AND INTERIOR DESIGNER PRIOR TO THE RELEASE OF THE LUMINAIRE

DELIVERED LUMENS

1 LUMENS

1 LUMENS

1 LUMENS

ML - MULTI-LEVEL.

WD - WIDE

TAMPER RESISTANT, 125V

ELECTRICAL GENERAL NOTES:

- 1. {L###} INDICATES THE LIGHTING SEQUENCE OF OPERATION FOR THE SPACE. REFER TO THE LIGHTING SEQUENCE OF OPERATION MATRIX ON SHEET E/###.
- 2. SHADED LUMINAIRE OR DEVICE INDICATES LUMINAIRE OR DEVICE IS CONNECTED TO AN EMERGENCY CIRCUIT.
- 3. { B#} PUSH BUTTON REFERS TO SCENE QUANTITY. CONTROL STATION SHALL BE CAPABLE OF IRAISE/LOWER ANDI SWITCHING ON/OFF FOR MULTIPLE SCENES AS INDICATED ON SHEETS AND THE LIGHTING SEQUENCE OF OPERATIONS {L##}. COORDINATE QUANTITIES OF BUTTONS FOR CONTROL STATIONS WITH LIGHTING CONTROL MANUFACTURER. REFER TO
- 4. { Z###} INDICATES THE LIGHTING ZONES FOR THE SPACE. PROVIDE SEPARATE CONTROL OF EACH CONTROLLED ZONE. LUMINAIRES ASSOCIATED WITH THE SAME ZONE SHALL OPERATE TOGETHER WITHIN THE SAME PROGRAMMED SCENE. REFER TO SHEET E-XXX.
- REFER TO SHEET E-XXX FOR LIGHTING CONTROL ONE-LINE DIAGRAM.

LUMINAIRE KEY

<u>F1</u> = FIXTURE TAG 1 = CIRCUIT NUMBER LUMINAIRE a = SWITCH DESIGNATION

6. REFER TO SHEET E-XXX FOR LUMINAIRE SCHEDULE.

"NL" INDICATES LUMINAIRE IS UNSWITCHED FOR NIGHT LIGHT. "SE" INDICATES LUMINAIRE IS SWITCHED/CONTROLLED DURING NORMAL OPERATION AND OPERATES FROM **[EMERGENCY BATTERY (EXTEND** UNSWITCHED CIRCUIT LEG TO BATTERY)] [EMERGENCY CIRCUIT] UPON LOSS OF

*IF LABEL IS ORIENTED HORIZONTALLY A SLASH WILL SEPARATE THIS INFORMATION, EX: F1 / 1 / a / NL

DEVICE KEY:

= MOUNTING (IF APPLICABLE) DEVICE₽ 1 = CIRCUIT NUMBER

*IF LABEL IS ORIENTED HORIZONTALLY A SLASH WILL SEPARATE THIS

INFORMATION. EX: A / 1

- ELECTRICAL MOUNTING SUBSCRIPT KEY:

 A MOUNT AT +6" TO CENTERLINE ABOVE COUNTER OR BACKSPLASH
- MOUNT AT CEILING (DEVICE OR ROUGH-IN CONTEXT) MOUNT ORIENTED HORIZONTALLY
- MOUNT IN CASEWORK
- MOUNT IN MODULAR FURNITURE
- WIRING DEVICE. OCCUPANCY CONTROLLED MOUNT IN SURFACE RACEWAY

K19 - KSH19 .156" ACRYLIC

M - MATTE DIFFUSE CLEAR

R - HIGH IMPACT DR ACRYLIC

SS - SEMI-SPECULAR CLEAR

O - OTHER (SEE DESCRIPTION

[DESIGN SPECIFIC BLANKS]

RGB - COLOR CHANGING LED

RGBA - COLOR CHANGING +.

O - OTHER (SEE DESCRIPTION

RLED - RETROFIT LED

MV - MULTI-VOLTAGE...

REM - REMOTE

TYPE | MANUFACTURER AND MODEL

CLX-L48-4800-SEF-FDL-120-GX10-4 0K-80CRI-WH(OR EQUIVALENT

0-10V LITHONIA LIGHTING /

0-10V GLOBALUX LIGHTING /

0-10V TBD

RDL-7-15-120D-940-**

0-10V LITHONIA LIGHTING / RLNK24

0-10V | SEE MECHANICAL DRAWINGS

0-10V | LEVITON 9852-LED WH GU 24 PULLCH LEDLAMPH BASE/GUARD/BULB

P - POLYCARBONATE

- SURFACE MOUNTED WEATHERPROOF WIRING DEVICE, NEMA 3R WHILE-IN-USE COVER, WR LISTED
- WIRE GUARD WG WEATHERPROOF

GRAND TOTAL: 13

(WATT) PER: FIX - FIXTURE, FT - FOOT, LAMP

LED - LIGHT EMITTING DIODE RGBW - COLOR CHANGING +.

DLED - DYNAMIC TUNABLE LED WLED - WARM DIM LED

(L/L) LENS/LOUVER:

B - BAFFLE/LOUVER

F - FROSTED ACRYLIC

G - TEMPERED GLASS

K - KSH12 .125" ACRYLIC

TLED - TUBULAR LED LAMP

DRIVER

120 V

120 V

OLED - ORGANIC LED

C - CLEAR ALZAK

NSP - VERY NARROW SPOT | A - .125" ACRYLIC

	ELECTRICAL SHEET INDEX
	LLLOTRIOAL OTTLLT INDLA
E0.01	ELECTRICAL COVERSHEET
E1.1	REWORK ELECTRICAL PLANS UNIT 1504 LOWER LEVEL
E1.01	OVERALL REWORK PLANS UNIT 1504
E1.2	DEMO/REWORK ELECTRICAL PLANS UNIT 1504
E1.02	OVERALL REWORK PLANS UNIT 1506
E1.3	DEMO/REWORK ELECTRICAL PLANS UNIT 1506 LOWER LEVEL
E1.4	DEMO/REWORK ELECTRICAL PLANS UNIT 1506 UPPER LEVEL
E1.5	RENOVATION ELECTRICAL PLANS UNIT 1506 BASEMENT
E4.0	ELECTRICAL DETAILS
E5.1	ELECTRICAL RISER - BUILDING 1504
E5.2	ELECTRICAL RISER - BUILDING 1506
E5.3	FEEDER SCHEDULE
E6.0	ELECTRICAL PANEL SCHEDULES



BROADWAY TERRACE 1504 BROADWAY ST **ANN ARBOR MI 48104**



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REF. SCALE IN INCHES PROJECT #YY######.## Revision / Issue


SHEET INFORMATION **REVISED BIDS/PERMITS** 23004726.00

D. NIETHAMMER


ELECTRICAL COVERSHEET

As indicated


KEYED NEW WORK NOTES: 1. CONDENSING UNIT LOCATIONS ARE SHOWN FOR REFERENCE ONLY. CONFIRM THE EXACT LOCATION ON THE MECHANICAL DRAWINGS.

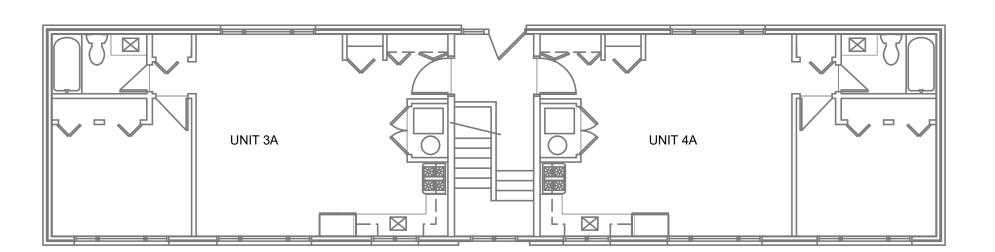



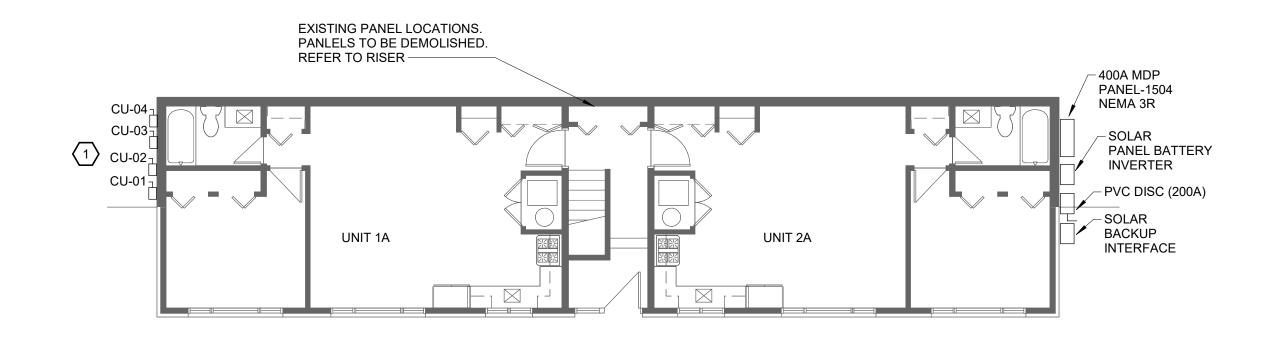




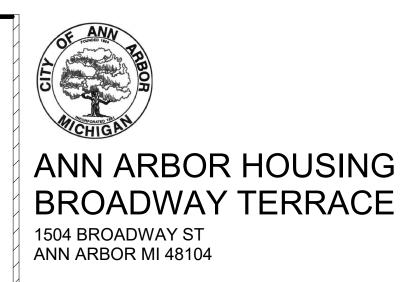



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REF. SCALE IN INCHES

SHEET INFORMATION REVISED BIDS/PERMITS 23004726.00

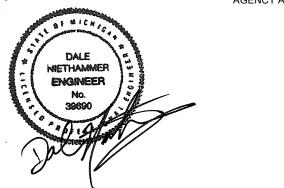D. NIETHAMMER

SHEET TITLE **OVERALL REWORK PLANS UNIT 1504**

SHEET NUMBER

E1.01


SCALE

1/8" = 1'-0"


KEYED NEW WORK NOTES:

1. CONDENSING UNIT LOCATIONS ARE SHOWN FOR REFERENCE ONLY. CONFIRM THE EXACT LOCATION ON THE MECHANICAL DRAWINGS.

2. HVAC AND WATER HEATER FOR THIS UNIT SHALL BE LOCATED IN THE BASEMENT. SEE BASEMENT PLANS.

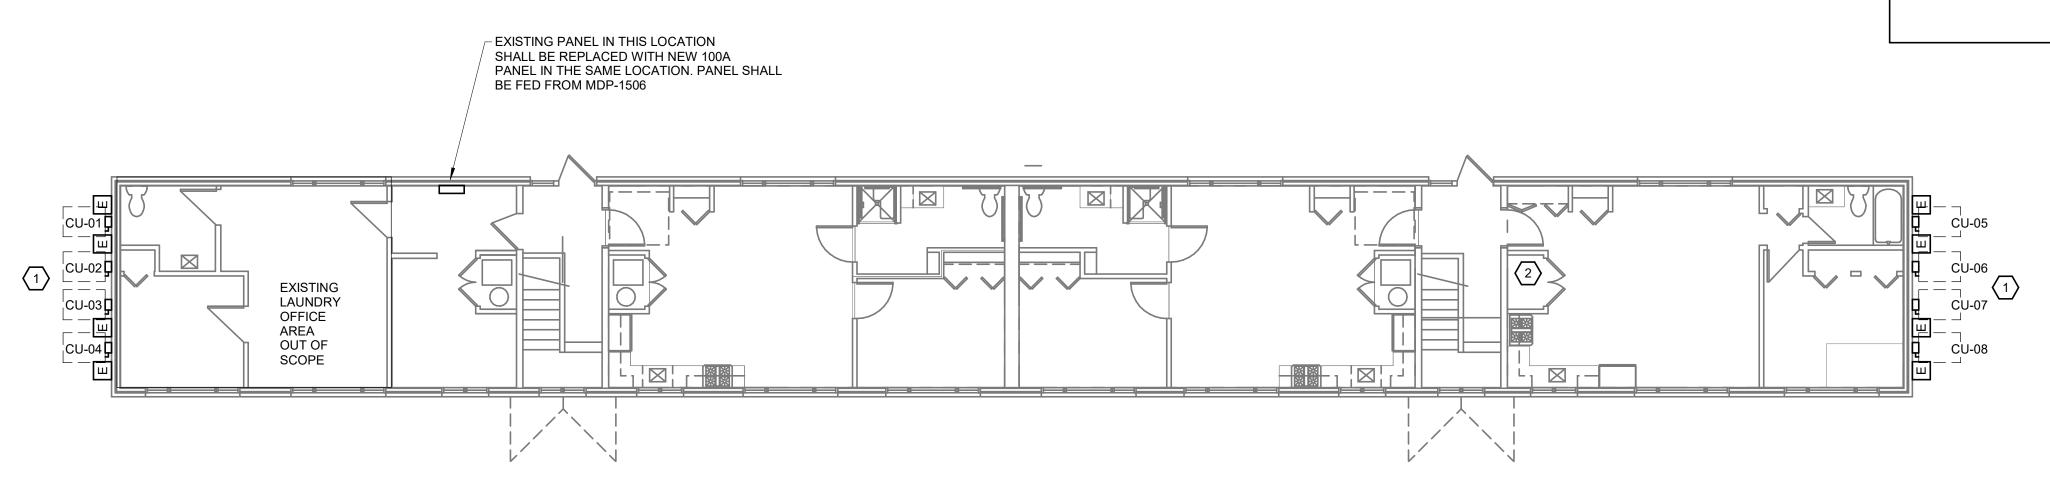

OVERALL U.L. REWORK PLAN - UNIT 1506 - ELECTRICAL

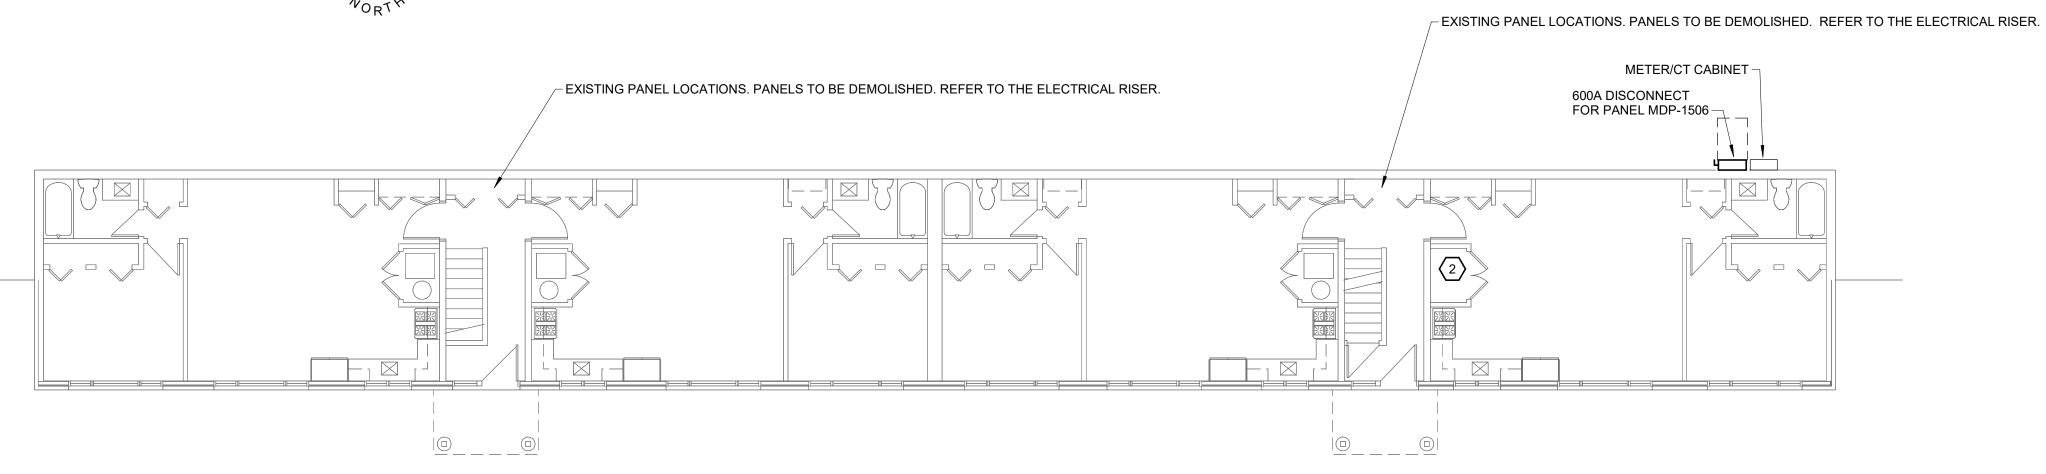

OVERALL L.L REWORK PLAN - UNIT 1506 - ELECTRICAL

1/8" = 1'-0"





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<u>____</u> REF. SCALE IN INCHES

SHEET INFORMATION 23004726.00

OVERALL REWORK PLANS UNIT 1506

1/8" = 1'-0"


D. NEITHAMMER


E1.02

KEYED DEMOLITION NOTES:

- 1. SELECTIVE DEMOLITION TO REMOVE ALL EXISTING POWER IN DEMOLISHED WALLS. REWORK EXISTING WIRING AS REQUIRED TO MAINTAIN POWER TO ANY DOWNSTREAM DEVICES AND TO REFEED NEW DEVICES ON RENOVATION PLAN. COORDINATE DEMOLITION WITH GENERAL CONTRACTOR BEFORE BEGINNING WORK. REFER TO ENLARGED UNIT
- 2. DEMOLISH POWER FOR EXISTING FURNACE AND WATER HEATER COMPLETE. REFER TO RENOVATION PLANS FOR ADDITIONAL INFORMATION.

DEMOLITION PLAN - 1504 LOWER LEVEL

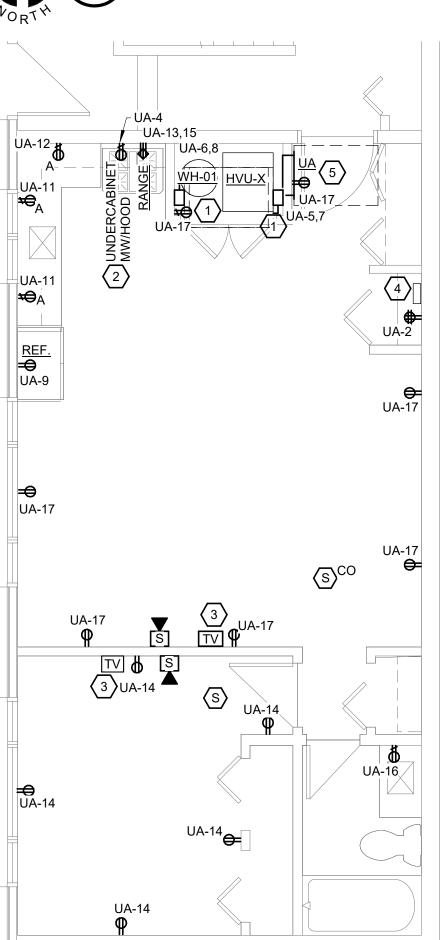

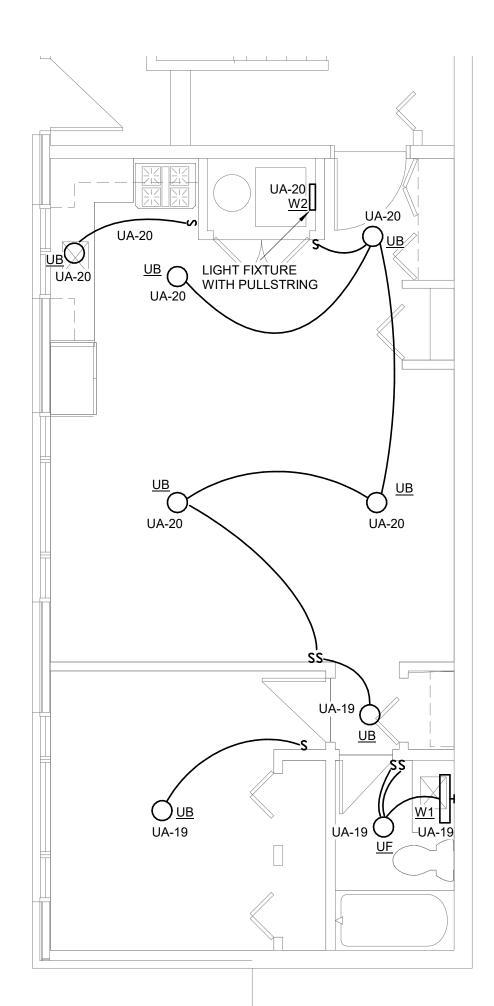

ELECTRICAL GENERAL NOTES:

- A. INSTALL THE SMALL APPLIANCE CIRCUITS IN ACCORDANCE WITH NATIONAL ELECTRICAL CODE SECTION 210.52(B). ELECTRICAL CONTRACTOR TO PROVIDE A TYPICAL WIRING PLAN FOR ALL UNITS TO REVIEW DURING THE SUBMITTAL PHASE OF THE PROJECT. PROVIDE GFI RECEPTACLES ON APPLIANCE CIRCUIT IN DINING ROOM OF ALL UNITS WHERE NECESSARY.
- B. TO COORDINATE TV OUTLET BOX WITH ARCHITECT/OWNER BEFORE INSTALLATION.
- C. ARC FAULT CIRCUIT INTERRUPTER PROTECTION SHALL BE PROVIDED IN ACCORDANCE
- D. WALL OUTLETS SHALL NOT OCCUR IN SAME WALL CAVITY OF ADJACENT SLEEPING UNIT (TYPICAL).
- E. COORDINATE BATHROOM EXHAUST LOCATION WITH MECHANICAL DRAWINGS.
- F. DATA DEVICES SHALL BE MOUNTED AT THE SAME MOUNTING HEIGHT AS ADJACENT RECEPTACLE.
- G. PROVIDE RECEPTACLE IN CABINET SPACE ABOVE RANGE FOR MICROWAVE. COORDINATE LOCATION WITH MILLWORK.
- H. EC SHALL PROVIDE CIRCUIT BREAKER LOCKS AT THE UNIT LOAD CENTER FOR AHU/EWH.
- I. RECEPTACLE FOR RANGE (LABELED AS RANGE). PROVIDE NEMA 14-50R RECEPTACLE. PROVIDE MATCHING CORD & PLUG. RANGE CONDUCTORS SHALL BE COPPER ONLY.
- J. TAMPER-RESISTANT RECEPTACLES SHALL BE INSTALLED IN ALL AREAS OF THE DWELLING UNIT IN ACCORDANCE WITH NEC ARTICLE 406.12.
- K. IN ALL ACCESSIBLE UNITS, MOUNT PANEL SO THAT THE CENTERLINE OF THE TOP-MOST OPERABLE BREAKER IS +48" AFF.
- L. EC TO COORDINATE OUTLET LOCATIONS AT FINISHED END CABINETS W/ MILLWORK CONTRACTOR.
- M. COUNTER HEIGHT RECEPTACLES ABOVE KITCHEN BACKSPLASH SHALL BE MOUNTED HORIZONTALLY.
- N. SWITCHES AND RECEPTACLES LOCATED OVER COUNTER OR SIMILAR OBSTRUCTIONS SHALL BE INSTALLED A MAXIMUM OF 46" A.F.F. TO THE HIGHEST USABLE PORTION OF THE SWITCH OR RECEPTACLE.
- O. AT COUNTER LOCATIONS, NO SWITCHES ARE PERMITTED TO BE LOCATED IN THE CORNER DEFINED BY THE INTERSECTION OF THE COUNTERTOPS. ONLY ONE RECEPTACLE IS PERMITTED TO BE IN THE INACCESSIBLE CORNER WHILE OTHER RECEPTACLES SHALL BE LOCATED OUTSIDE OF THE CORNER. IF ONLY ONE RECEPTACLES IS PROVIDED, IT MUST BE LOCATED COMPLETELY OUTSIDE OF THE CORNER. REFER TO DETAIL 5 ON SHEET E0.06a.
- P. ALL RECEPTACLES WITHIN 6'-0" OF WET LOCATION SHALL BE GFI PROTECTED.
- Q. COORDINATE THE LOCATION OF GFI RECEPTACLES IN THE BATHROOMS WITH THE ARCHITECTURAL INTERIOR ELEVATIONS.
- R. INSTALL LIGHT FIXTURES AS SHOWN ON DRAWINGS AND DESCRIBED BELOW. FINAL CONFIRMATION OF ALL LOCATIONS TO BE DETERMINED BY OWNER AT TIME OF BOX WALK.
- a. CENTER ISLAND PENDANTS ACROSS THE WIDTH OF THE ISLAND.
- b. SEE ARCHITECTURE FOR SPACING ALONG THE LENGTH.c. CENTER CLOSET LIGHTS WITHIN CLOSETS.
- d. CENTER LIGHTS ABOVE SHOWERS/TUBS.
 e. LOCATE BATHROOM EXHAUST OVER TOILET.
- A. ALL RECEPTACLES ABOVE VANITY COUNTERS TO BE INSTALLED HORIZONTALLY.
- B. SWITCHES AND RECEPTACLES LOCATED OVER COUNTERS OR SIMILAR OBSTRUCTIONS SHALL BE INSTALLED A MAXIMUM OF 46" A.F.F. TO THE HIGHEST USABLE PORTION OF THE SWITCH OR RECEPTACLE.
- C. VERIFY ALL DOOR SWINGS BEFORE INSTALLING LIGHT SWITCHES. ALL LIGHT SWITCHES ARE TO BE INSTALLED ON STRIKE SIDE OF DOOR.
- D. LIGHT SWITCH SHALL BE MOUNTED CLOSE TO DOOR OPENING.

ELECTRICAL KEYED NOTES:

- 1. COORDINATE MECHANICAL EQUIPMENT DISCONNECT WITH MECHANICAL SCHEDULE. CONTRACTOR SHALL FIELD COORDINATE PLACEMENT OF DISCONNECT IN ORDER TO ADHERE TO NFPA ART. 110.26.
- 2. MICROWAVE SHALL BE INSTALLED IN CABINET (NON-ADA UNITS). COORDINATE WITH ARCHITECT AND MILLWORK FOR RECEPTACLE MOUNTING LOCATION. PROVIDE DEDICATED CIRCUIT.
- PROVIDE MEDIA OUTLET(CAT 6) FOR TV. COORDINATE MOUNTING HEIGHT WITH INTERIOR DESIGNER. FINAL DMARC LOCATION TO BE COORDINATE IN THE FIELD.
- 4. PROVIDE UNIT MEDIA DISTRIBUTION PANEL. BASIS OF DESIGN: LEVITON 14" WIRELESS ENCLOSURE WITH VENTED COVER (49605-14). INCLUDED WITH COMBO PANEL WITH 1X4 PHONE, DATA AND 1X6 VIDEO PANEL, (47603-DP6), NON-SURGE J-BOX KIT (47605-CAN), UNIVERSAL SHELF BRACKET (49605-AUB), GIGAMAX CAT 5E PATCH CORD, 3 FEET, BLUE (5G460-03L), AND SADDLE TIE KIT (49605-AST). COORDINATE WITH SERVICE PROVIDERS.

 A. COORDINATE OUTLET HEIGHT WITH ENCLOSURE. PROVIDE DUPLEX RECEPTACLE, DATA AND COAXIAL CABLE MANAGEMENT AND DISTRIBUTION BLOCKS / SPLITTERS WITHIN.
- B. CONNECTIONS SHALL BE SUFFICIENT FOR ALL OUTLETS AND DEVICES.
 C. ENCLOSURES SHALL NOT BE MOUNTED IN A FIRE-RATED WALL.
- 5. UNIT LOAD CENTER.
- 6. PROVIDE REMOTE MOUNTED SWITCHES FOR HOOD LIGHT AND FAN (INDIVIDUALLY CONTROLLED ADA UNITS ONLY). SWITCH FOR LIGHT SHALL BE MOUNTED TO THE OTHER EDGE OF RANGE. COORDINATE MOUNTING LOCATION WITH ARCHITECT PRIOR TO ROUGH-



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KEY PLAN

DALE DALE



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0	1	2	3
REF. SCALE IN	INCHES	PROJEC1	「#YY######.##
			DEVIO

No. Date Revision / Issue

SHEET INFORMATION

REVISED BIDS/PERMITS

04/12/2024

23004726.00

J. WRIGHT

D. NIETHAMMER
SHEET TITLE
REWORK ELECTRICAL PLANS UNIT
1504 LOWER LEVEL

SCALE
Scale: As indicated

SHEET NUMBER


REWORK LIGHTING FLOOR PLAN - 1504 LOWER LEVEL


KEYED DEMOLITION NOTES:

SELECTIVE DEMOLITION TO REMOVE ALL EXISTING POWER IN DEMOLISHED WALLS. REWORK EXISTING WIRING AS REQUIRED TO MAINTAIN POWER TO ANY DOWNSTREAM DEVICES AND TO REFEED NEW DEVICES ON RENOVATION PLAN. COORDINATE DEMOLITION WITH GENERAL CONTRACTOR BEFORE BEGINNING WORK. REFER TO ENLARGED UNIT

DEMOLISH POWER FOR EXISTING FURNACE AND WATER HEATER COMPLETE. REFER TO RENOVATION PLANS FOR ADDITIONAL INFORMATION.


DEMOLITION PLAN - 1504 UPPER LEVEL

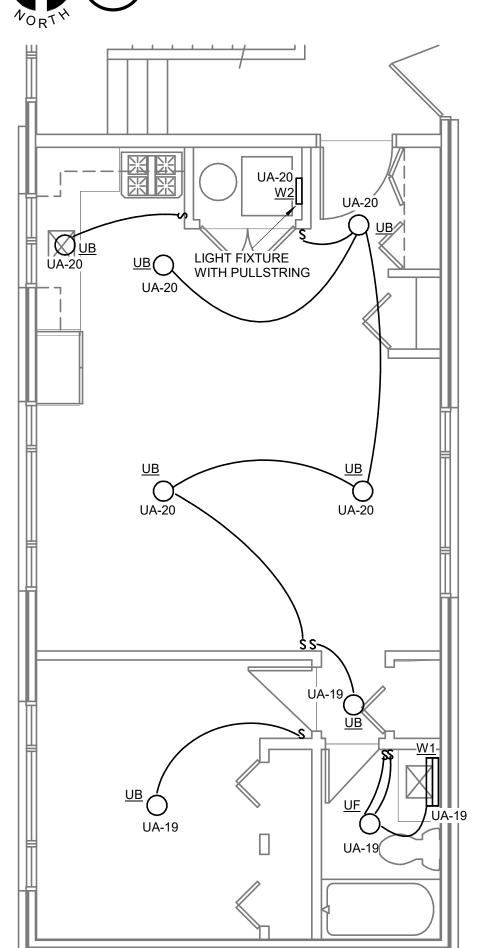

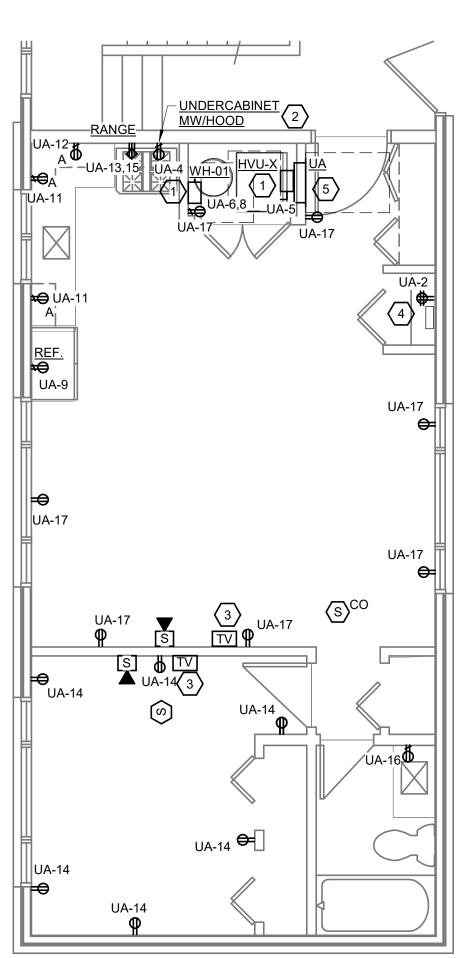


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- B. TO COORDINATE TV OUTLET BOX WITH ARCHITECT/OWNER BEFORE INSTALLATION.
- C. ARC FAULT CIRCUIT INTERRUPTER PROTECTION SHALL BE PROVIDED IN ACCORDANCE WITH NEC 210.12.
- D. WALL OUTLETS SHALL NOT OCCUR IN SAME WALL CAVITY OF ADJACENT SLEEPING UNIT (TYPICAL).
- E. COORDINATE BATHROOM EXHAUST LOCATION WITH MECHANICAL DRAWINGS.
- F. DATA DEVICES SHALL BE MOUNTED AT THE SAME MOUNTING HEIGHT AS ADJACENT RECEPTACLE.
- G. PROVIDE RECEPTACLE IN CABINET SPACE ABOVE RANGE FOR MICROWAVE. COORDINATE LOCATION WITH MILLWORK.
- H. EC SHALL PROVIDE CIRCUIT BREAKER LOCKS AT THE UNIT LOAD CENTER FOR AHU/EWH.
- RECEPTACLE FOR RANGE (LABELED AS RANGE). PROVIDE NEMA 14-50R RECEPTACLE. PROVIDE MATCHING CORD & PLUG. RANGE CONDUCTORS SHALL BE COPPER ONLY.
- J. TAMPER-RESISTANT RECEPTACLES SHALL BE INSTALLED IN ALL AREAS OF THE



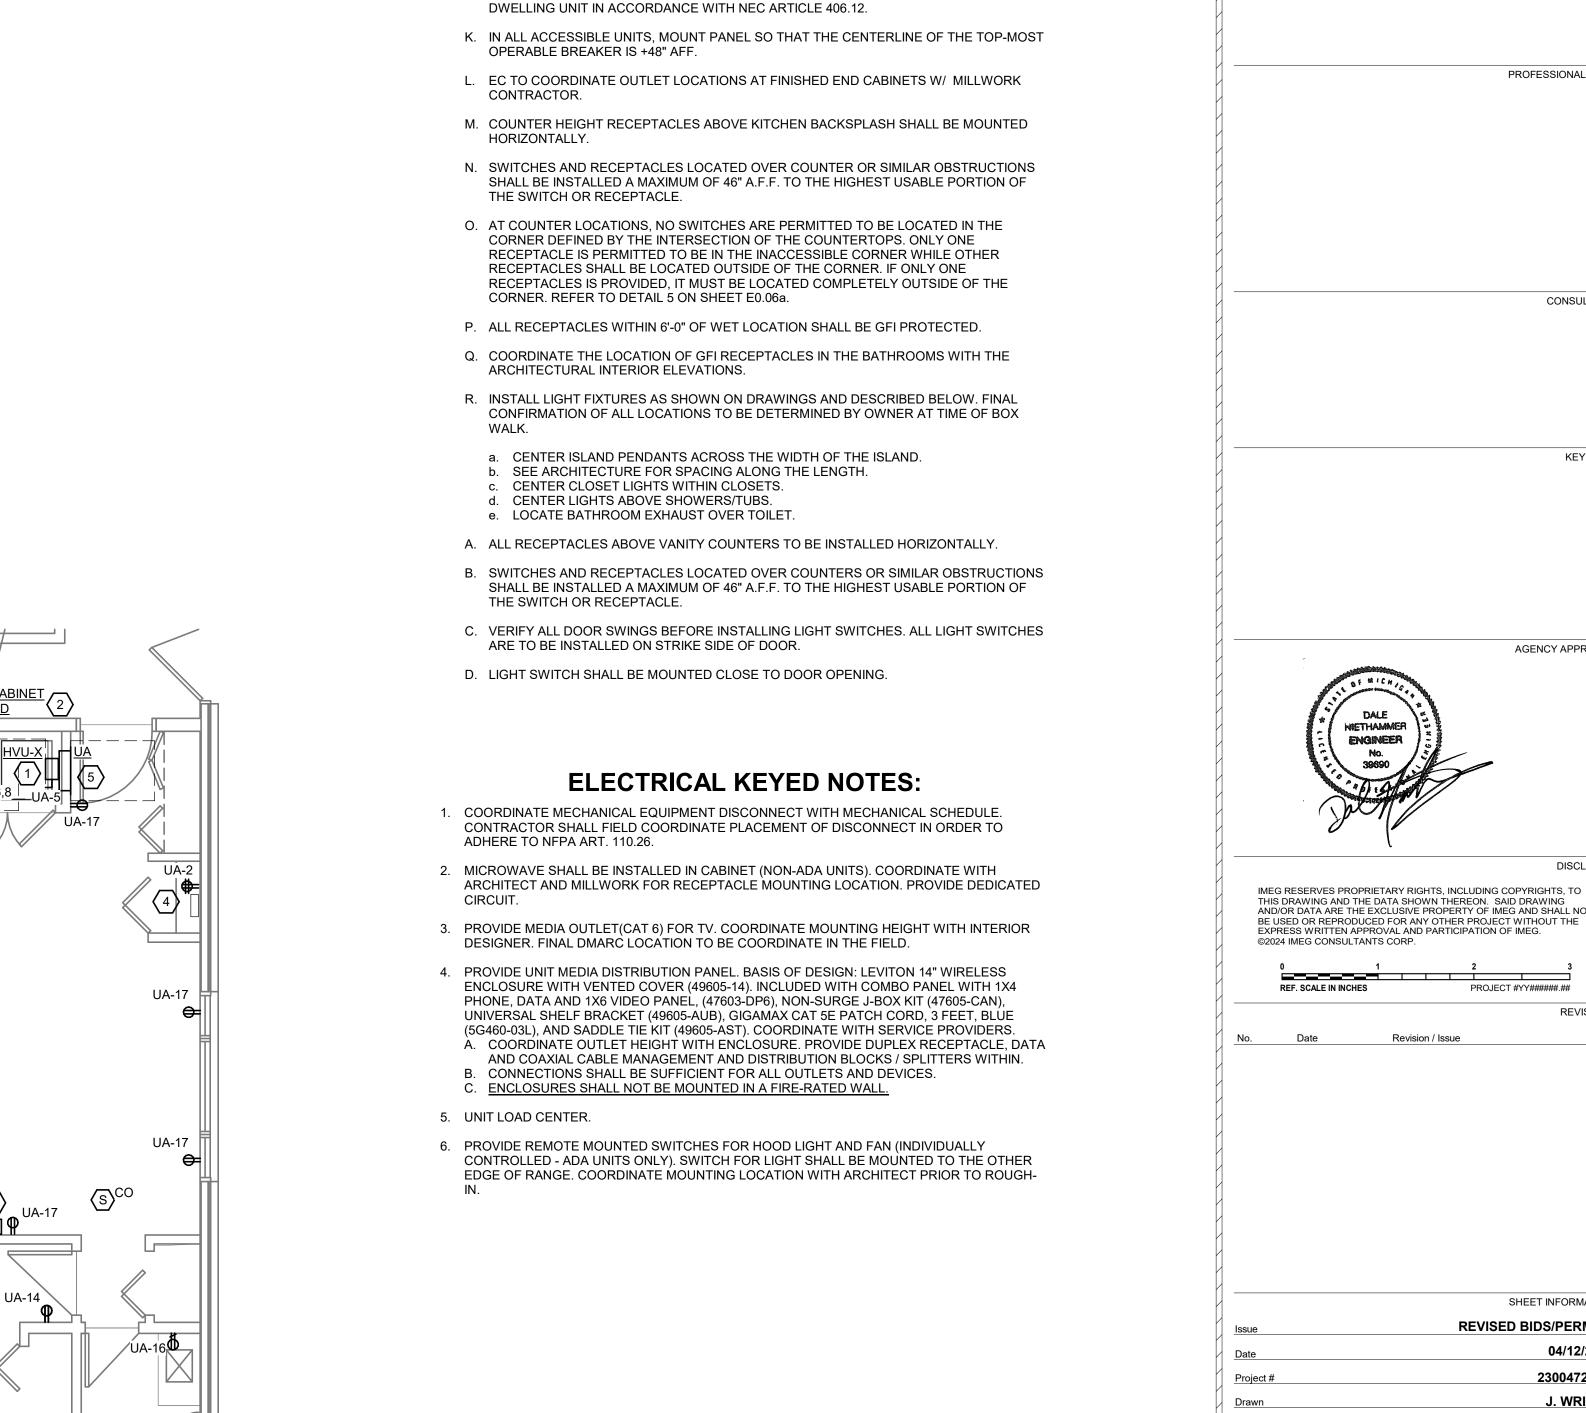

REWORK LIGHTING FLOOR PLAN - 1504 UPPER LEVEL

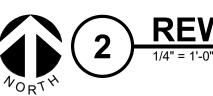

REWORK POWER PLAN - 1504 UPPER LEVEL

ANN ARBOR HOUSING **BROADWAY TERRACE**

1504 BROADWAY ST

ANN ARBOR MI 48104


SALINE, MI 48176

P: 734.429.8900

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DEMO/REWORK ELECTRICAL PLANS UNIT 1504

As indicated


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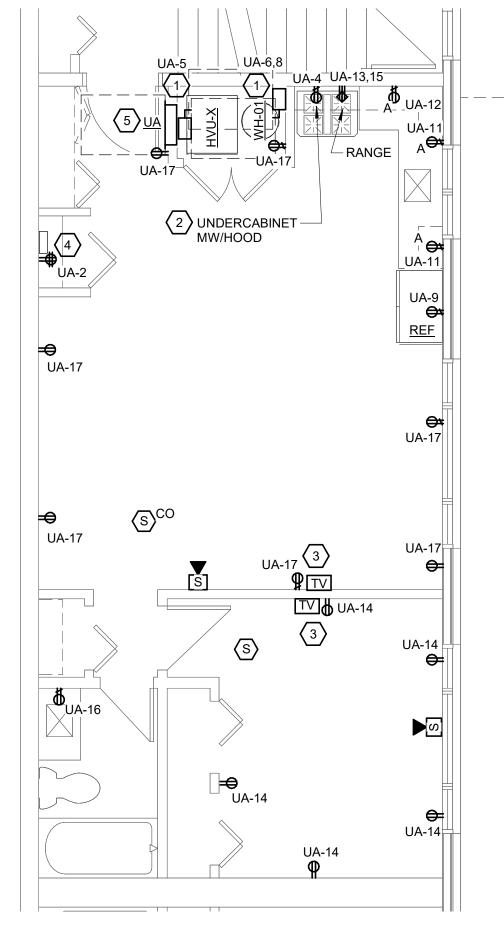
D. NIETHAMMER

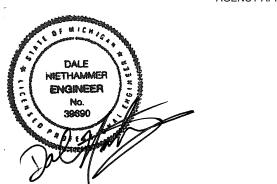KEYED DEMOLITION NOTES:

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- DEMOLISH POWER FOR EXISTING FURNACE AND WATER HEATER COMPLETE. REFER TO RENOVATION PLANS FOR ADDITIONAL INFORMATION.

DEMOLITION PLAN - 1506 LOWER LEVEL



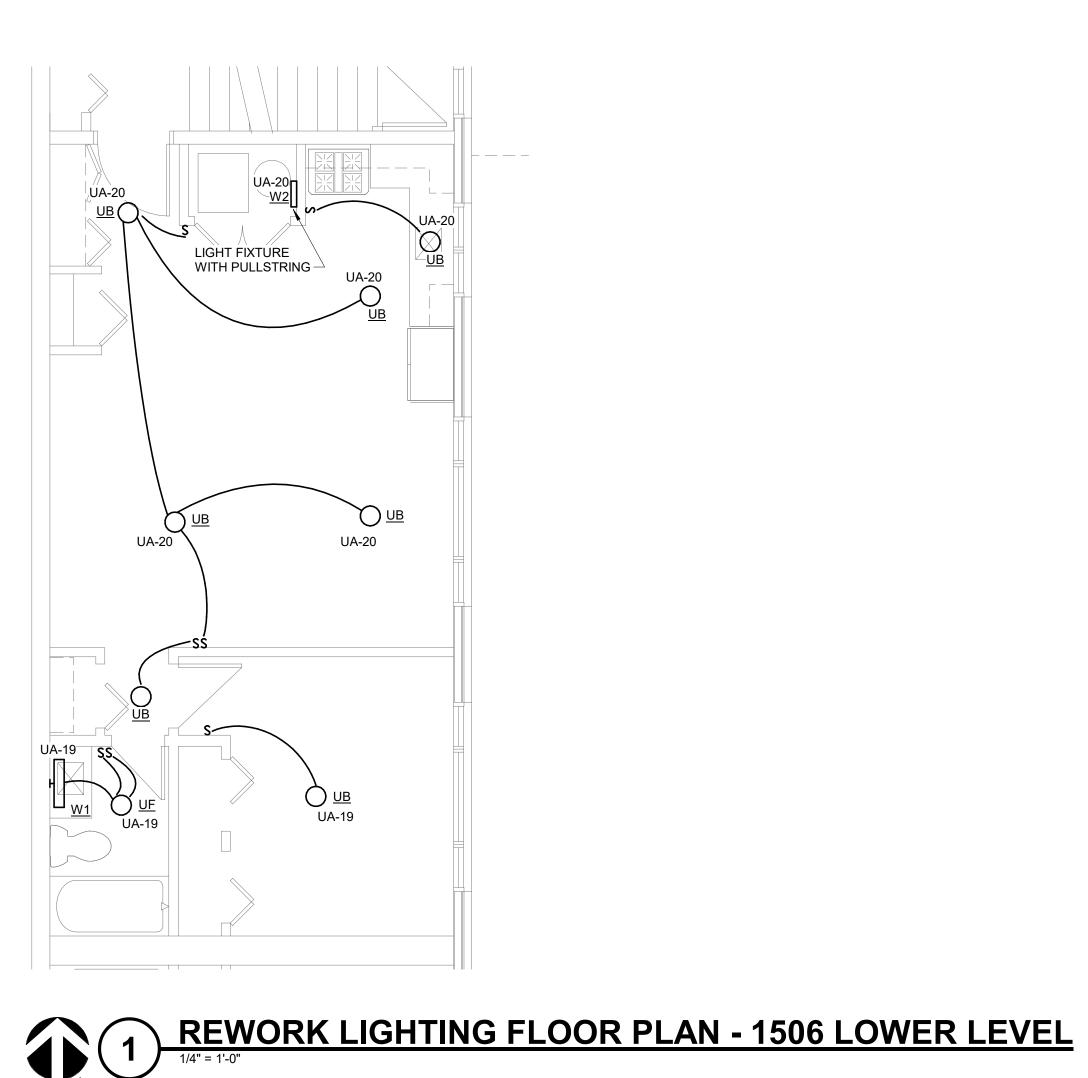


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- B. TO COORDINATE TV OUTLET BOX WITH ARCHITECT/OWNER BEFORE INSTALLATION.
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- D. WALL OUTLETS SHALL NOT OCCUR IN SAME WALL CAVITY OF ADJACENT SLEEPING UNIT
- E. COORDINATE BATHROOM EXHAUST LOCATION WITH MECHANICAL DRAWINGS.
- F. DATA DEVICES SHALL BE MOUNTED AT THE SAME MOUNTING HEIGHT AS ADJACENT RECEPTACLE.
- G. PROVIDE RECEPTACLE IN CABINET SPACE ABOVE RANGE FOR MICROWAVE. COORDINATE LOCATION WITH MILLWORK.
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- I. RECEPTACLE FOR RANGE (LABELED AS RANGE). PROVIDE NEMA 14-50R RECEPTACLE. PROVIDE MATCHING CORD & PLUG. RANGE CONDUCTORS SHALL BE COPPER ONLY.
- J. TAMPER-RESISTANT RECEPTACLES SHALL BE INSTALLED IN ALL AREAS OF THE DWELLING UNIT IN ACCORDANCE WITH NEC ARTICLE 406.12.
- K. IN ALL ACCESSIBLE UNITS, MOUNT PANEL SO THAT THE CENTERLINE OF THE TOP-MOST OPERABLE BREAKER IS +48" AFF.
- L. EC TO COORDINATE OUTLET LOCATIONS AT FINISHED END CABINETS W/ MILLWORK
- M. COUNTER HEIGHT RECEPTACLES ABOVE KITCHEN BACKSPLASH SHALL BE MOUNTED
- N. SWITCHES AND RECEPTACLES LOCATED OVER COUNTER OR SIMILAR OBSTRUCTIONS SHALL BE INSTALLED A MAXIMUM OF 46" A.F.F. TO THE HIGHEST USABLE PORTION OF THE SWITCH OR RECEPTACLE.
- O. AT COUNTER LOCATIONS, NO SWITCHES ARE PERMITTED TO BE LOCATED IN THE CORNER DEFINED BY THE INTERSECTION OF THE COUNTERTOPS. ONLY ONE RECEPTACLE IS PERMITTED TO BE IN THE INACCESSIBLE CORNER WHILE OTHER RECEPTACLES SHALL BE LOCATED OUTSIDE OF THE CORNER. IF ONLY ONE RECEPTACLES IS PROVIDED, IT MUST BE LOCATED COMPLETELY OUTSIDE OF THE CORNER. REFER TO DETAIL 5 ON SHEET E0.06a.
- P. ALL RECEPTACLES WITHIN 6'-0" OF WET LOCATION SHALL BE GFI PROTECTED.
- Q. COORDINATE THE LOCATION OF GFI RECEPTACLES IN THE BATHROOMS WITH THE ARCHITECTURAL INTERIOR ELEVATIONS.
- R. INSTALL LIGHT FIXTURES AS SHOWN ON DRAWINGS AND DESCRIBED BELOW. FINAL CONFIRMATION OF ALL LOCATIONS TO BE DETERMINED BY OWNER AT TIME OF BOX
- a. CENTER ISLAND PENDANTS ACROSS THE WIDTH OF THE ISLAND.
- b. SEE ARCHITECTURE FOR SPACING ALONG THE LENGTH. c. CENTER CLOSET LIGHTS WITHIN CLOSETS.
- d. CENTER LIGHTS ABOVE SHOWERS/TUBS. e. LOCATE BATHROOM EXHAUST OVER TOILET.
- A. ALL RECEPTACLES ABOVE VANITY COUNTERS TO BE INSTALLED HORIZONTALLY.
- B. SWITCHES AND RECEPTACLES LOCATED OVER COUNTERS OR SIMILAR OBSTRUCTIONS SHALL BE INSTALLED A MAXIMUM OF 46" A.F.F. TO THE HIGHEST USABLE PORTION OF THE SWITCH OR RECEPTACLE.
- C. VERIFY ALL DOOR SWINGS BEFORE INSTALLING LIGHT SWITCHES. ALL LIGHT SWITCHES ARE TO BE INSTALLED ON STRIKE SIDE OF DOOR.
- D. LIGHT SWITCH SHALL BE MOUNTED CLOSE TO DOOR OPENING.

ELECTRICAL KEYED NOTES:

- 1. COORDINATE MECHANICAL EQUIPMENT DISCONNECT WITH MECHANICAL SCHEDULE. CONTRACTOR SHALL FIELD COORDINATE PLACEMENT OF DISCONNECT IN ORDER TO ADHERE TO NFPA ART. 110.26.
- 2. MICROWAVE SHALL BE INSTALLED IN CABINET (NON-ADA UNITS). COORDINATE WITH ARCHITECT AND MILLWORK FOR RECEPTACLE MOUNTING LOCATION. PROVIDE DEDICATED
- 3. PROVIDE MEDIA OUTLET(CAT 6) FOR TV. COORDINATE MOUNTING HEIGHT WITH INTERIOR DESIGNER. FINAL DMARC LOCATION TO BE COORDINATE IN THE FIELD.
- 4. PROVIDE UNIT MEDIA DISTRIBUTION PANEL. BASIS OF DESIGN: LEVITON 14" WIRELESS ENCLOSURE WITH VENTED COVER (49605-14). INCLUDED WITH COMBO PANEL WITH 1X4 PHONE, DATA AND 1X6 VIDEO PANEL, (47603-DP6), NON-SURGE J-BOX KIT (47605-CAN), UNIVERSAL SHELF BRACKET (49605-AUB), GIGAMAX CAT 5E PATCH CORD, 3 FEET, BLUE (5G460-03L), AND SADDLE TIE KIT (49605-AST). COORDINATE WITH SERVICE PROVIDERS. A. COORDINATE OUTLET HEIGHT WITH ENCLOSURE. PROVIDE DUPLEX RECEPTACLE, DATA
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- 5. UNIT LOAD CENTER.
- 6. PROVIDE REMOTE MOUNTED SWITCHES FOR HOOD LIGHT AND FAN (INDIVIDUALLY CONTROLLED - ADA UNITS ONLY). SWITCH FOR LIGHT SHALL BE MOUNTED TO THE OTHER EDGE OF RANGE. COORDINATE MOUNTING LOCATION WITH ARCHITECT PRIOR TO ROUGH-

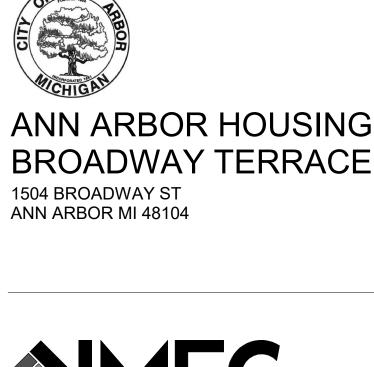

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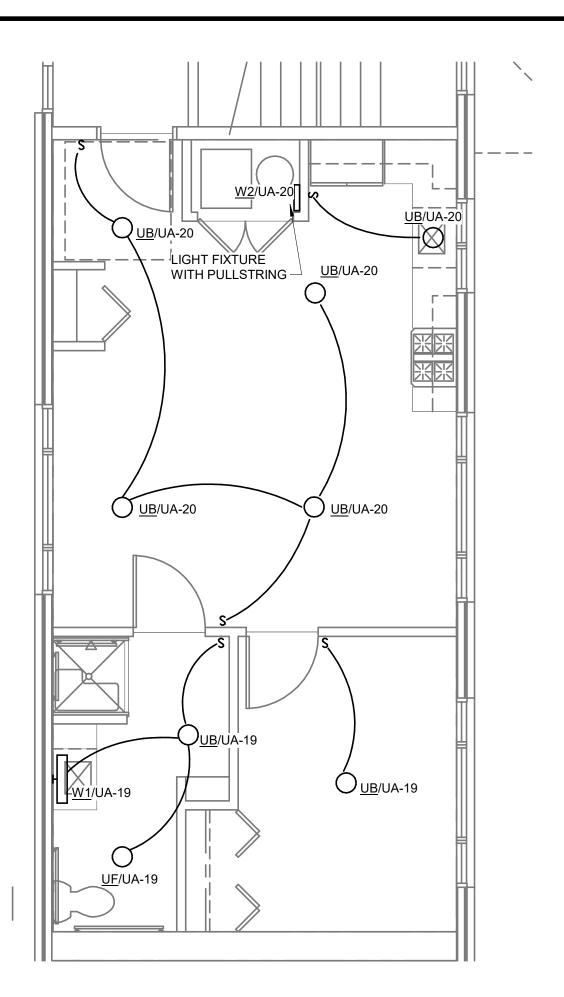
D. NIETHAMMER

DEMO/REWORK ELECTRICAL PLANS UNIT 1506 LOWER LEVEL

SHEET NUMBER


As indicated

REWORK POWER PLAN - 1506 LOWER LEVEL




REWORK LIGHTING FLOOR PLAN - 1506 UPPER LEVEL (ADA)

REWORK POWER PLAN - 1506 UPPER LEVEL(ADA)

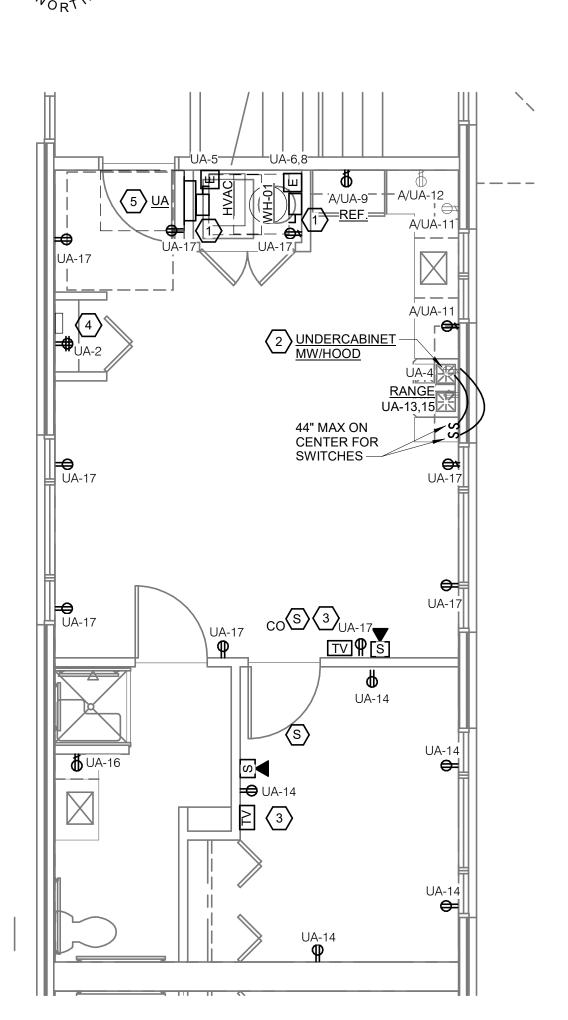


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PLANS.

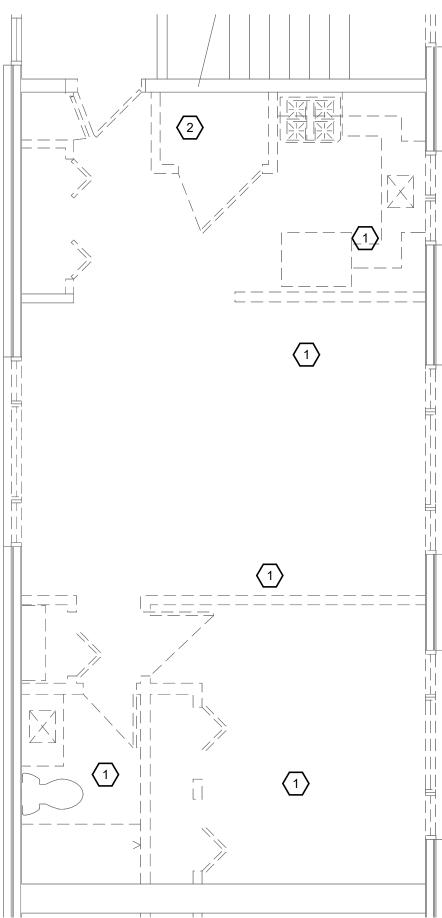


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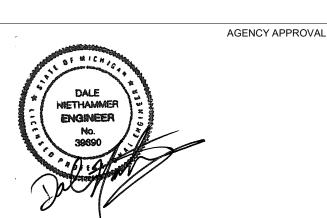
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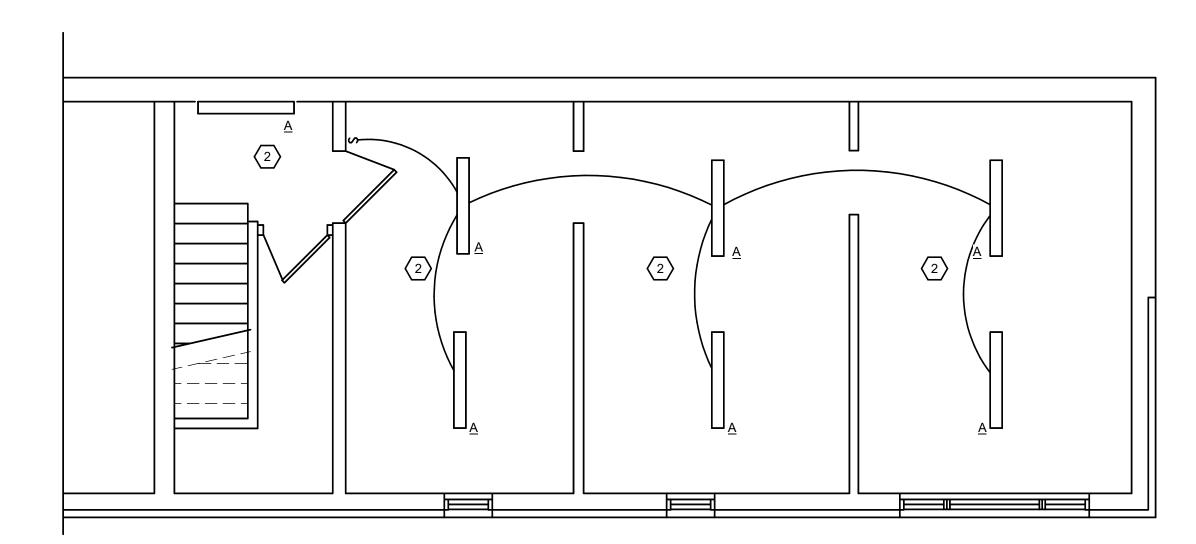
DEMO/REWORK ELECTRICAL PLANS UNIT 1506 UPPER LEVEL

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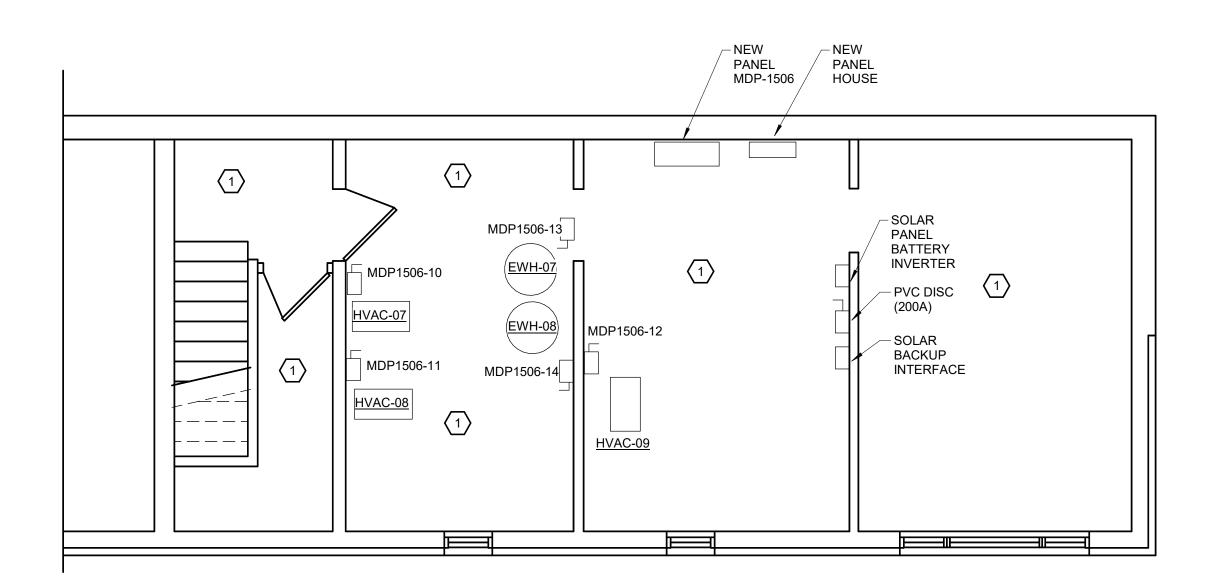
As indicated

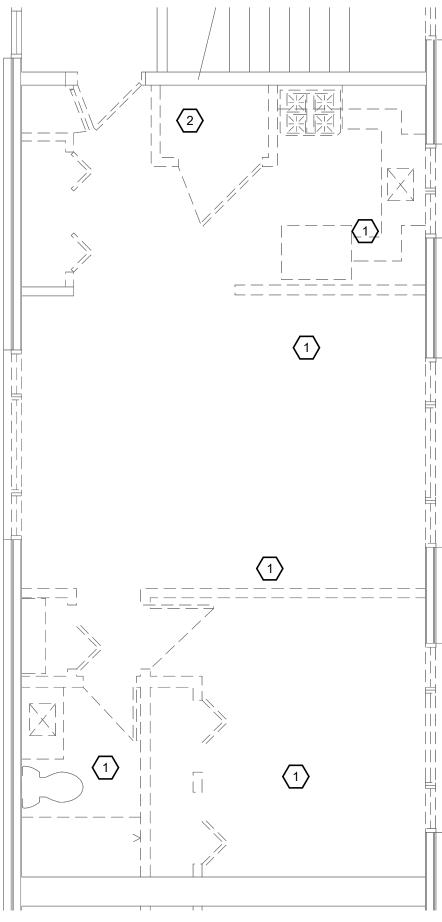D. NIETHAMMER

3 DEMOLITION PLAN - 1506 UPPER LEVEL (ADA)

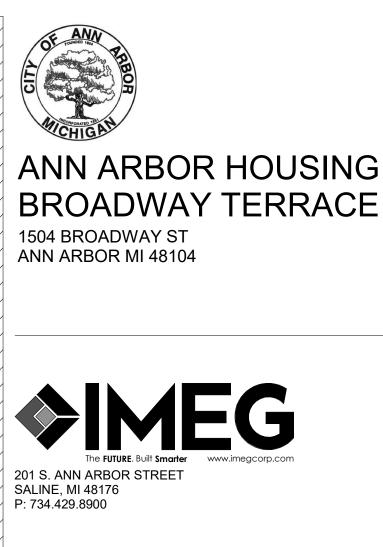

BASEMENT FLOOR PLAN - UNIT 1506 - LIGHTING



1 BASEMENT FLOOR PLAN - UNIT 1506 - POWER





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KEY PLAN

DALE
HIETHAMMER
ENGINEER
No.
39690

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REF. SCALE IN INCHES PROJECT #YY###########

No. Date Revision / Issue

KEYED NEW WORK NOTES:

TO THE NEW PANEL MDP-1506.

1. EXISTING WALL RECEPTACLES SHALL BE EXISTING TO

REMAIN. ALL ELECTRICAL ITEMS IN THE BASEMENT LEVEL

TO HAVE BRANCH CIRCUITS REWORKED AND EXTENDED

2. NEW LIGHT FIXTURES IN THE BASEMENT SHALL BE CONNECTED TO PANEL MPD. MAINTAIN THE EXISTING ELECTRICAL CIRCUITS AND REWORK AND EXTEND TO THE EXISTING CONTROLS SERVING THIS AREA.


RENOVATION ELECTRICAL PLANS UNIT
1506 BASEMENT

SHEET NUMBER


1/4" = 1'-0"

14726.00 4/12/202⁴




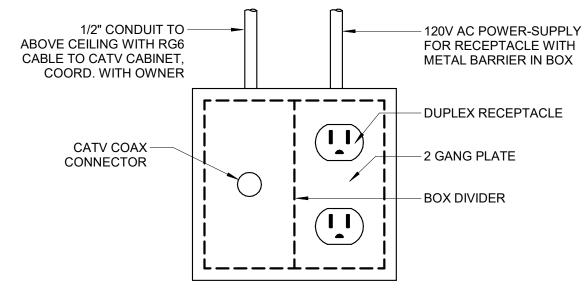



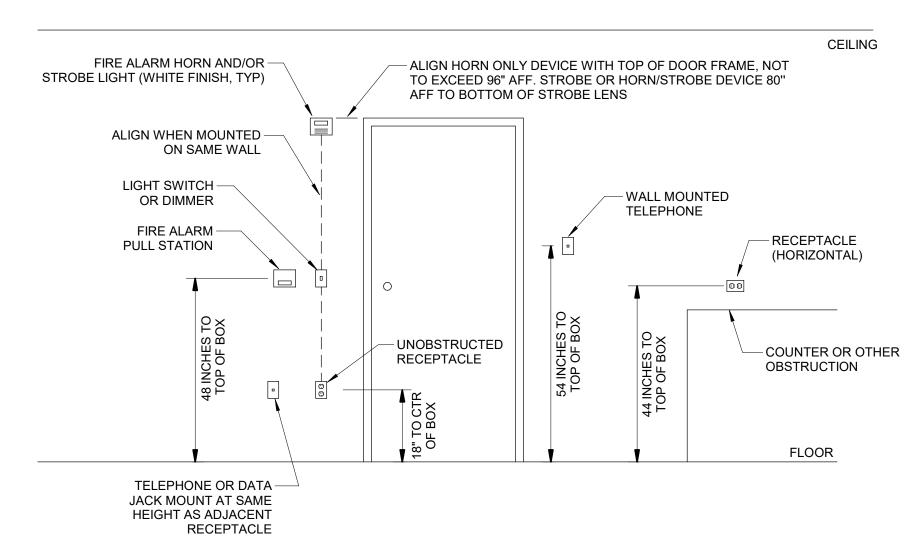

MOUNTING HEIGHT DIAGRAM

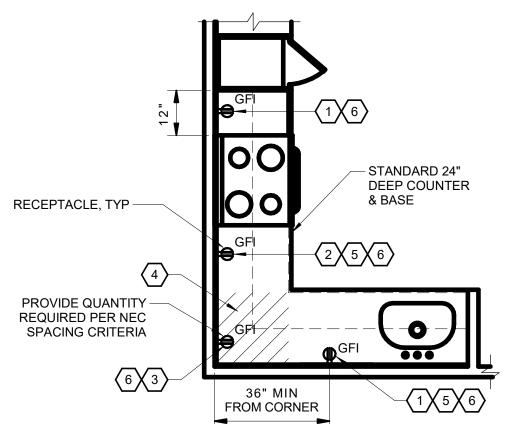

- 1. A RECEPTACLE OUTLET SHALL BE INSTALLED FOR EACH COUNTERTOP SPACE THAT IS 12" OR WIDER. RECEPTACLE OUTLETS SHALL BE INSTALLED SO THAT NO POINT ALONG THE WALL LINE IS MORE THAN 24", MEASURED HORIZONTALLY, FROM A RECEPTACLE OUTLET IN THAT COUNTERTOP SPACE.
- 2. ONE RECEPTACLE OUTLET MUST BE LOCATED 36" CLEAR FROM THE CORNER ON ONE WALL FOR ACCESSIBILITY. WHERE ONE OF THE WALLS INCLUDES A RANGE, LOCATE THE RECEPTACLE OUTLET ON THE RANGE WALL.
- 3. TO MEET RECEPTACLE OUTLET SPACING CODE REQUIREMENTS, ONE RECEPTACLE OUTLET IS ALLOWED TO BE LOCATED ON THE WALLS WITHIN THE HATCHED AREA.
- 4. NO SWITCHES ARE ALLOWED TO BE LOCATED ON THE WALLS WITHIN THE HATCHED AREA.
- 5. ALL RECEPTACLE OUTLETS LOCATED 6'-0" OR LESS FROM SINK'S EDGE SHALL BE OF THE GFI TYPE.
- 6. THE LOCATIONS OF RECEPTACLE OUTLETS SHOWN IN THIS DETAIL ARE DIAGRAMMATIC. THE ELECTRICAL CONTRACTOR SHALL PROVIDE THE QUANTITY OF RECEPTACLE OUTLETS AS REQUIRED TO ACHIEVE CODE COMPLIANCE.
- 7. IF A USB TYPE OUTLETS IS PROVIDED IN A SINGLE OUTLET LOCATION, THAT OUTLET MAY NOT BE LOCATED WITHIN 36" OF

- NOTES:

 1. ONE ELECTRICAL RECEPTACLE IN EACH AREA OVER COUNTER MUST BE A MINIMUM OF 36"

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 1. ONE ELECTRICAL RECEPTACLE RECEP FROM A CORNER PER FAIR HOUSING ACT FOR WHEELCHAIR ACCESSIBILITY. FHA GUIDELINES
- 2. ELECTRICAL CONTRACTOR TO PROVIDE ADDITIONAL RECEPTACLES AS NECESSARY TO ACHIEVE REQUIRED SPACING, WHETHER OR NOT INDICATED ON UNIT LAYOUT.







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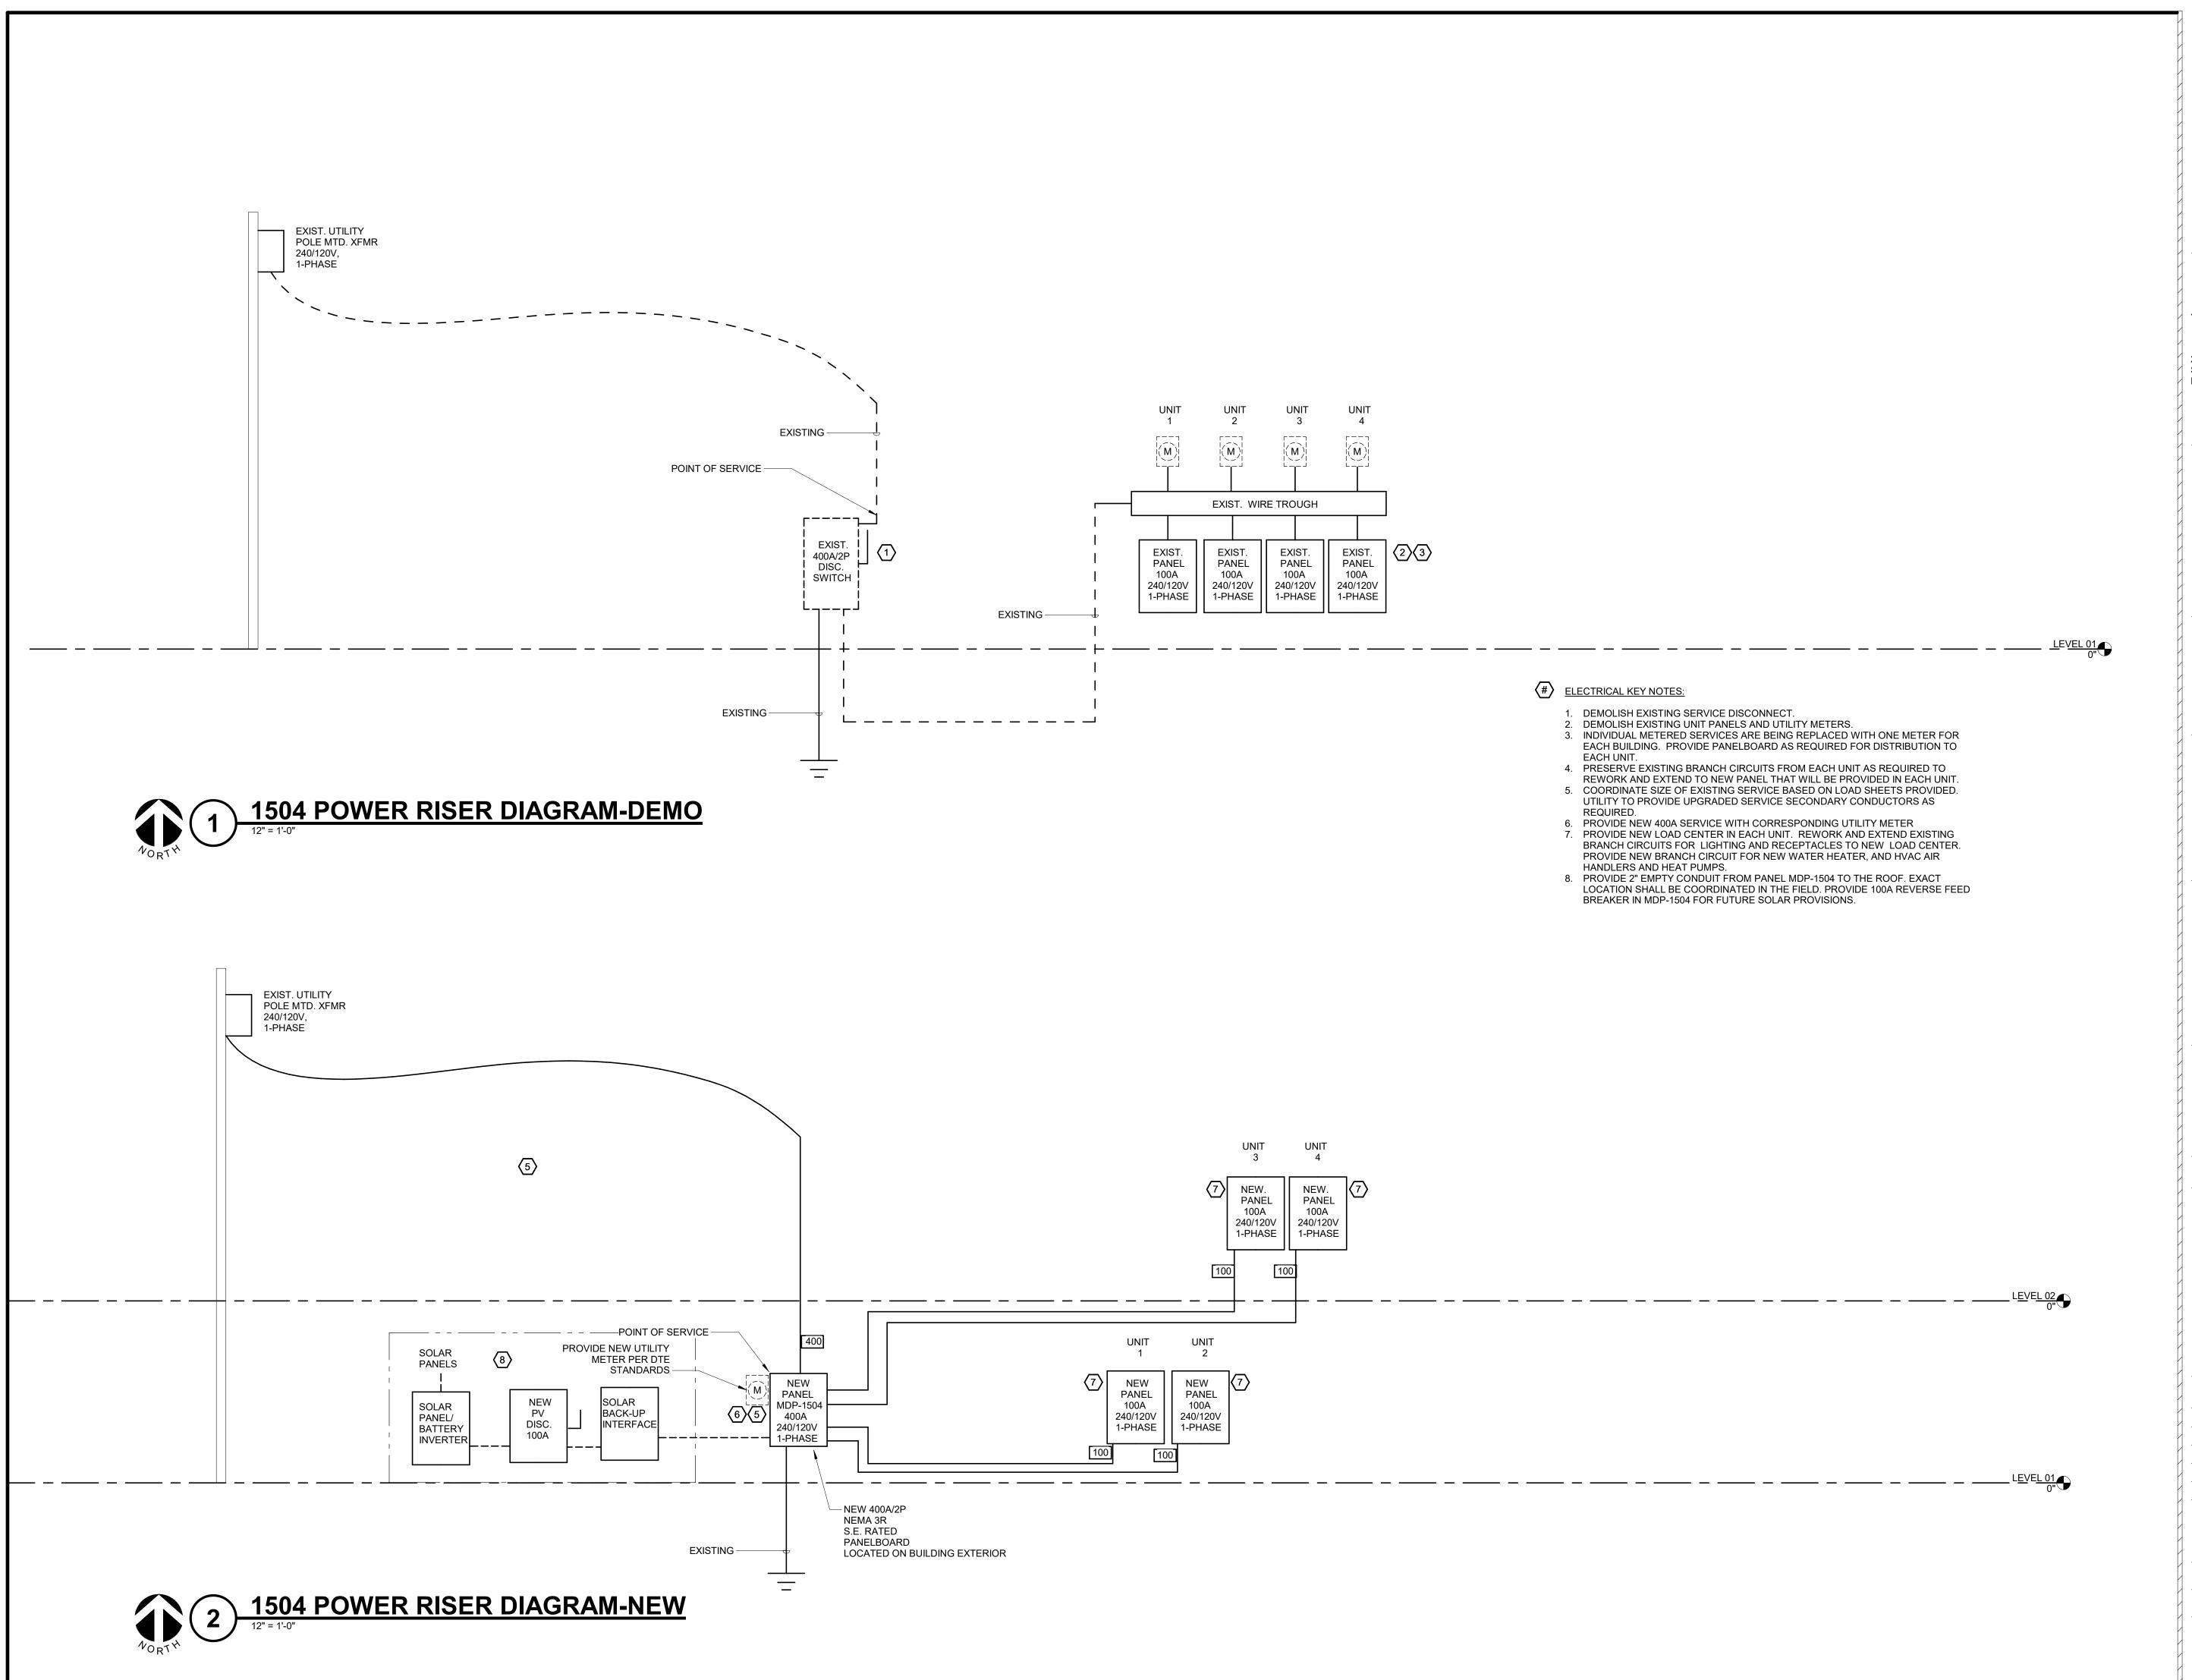
SHEET INFORMATION **REVISED BIDS/PERMITS**

23004726.00 D. NIETHAMMER

ELECTRICAL DETAILS

As indicated

E4.0







PROFESSIONAL SEAL

CONSULTANT

KEY PLAN

DALE
HIETHAMMER
ENGINEER
No.
39690

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04/12/2024

ect # 23004726.00

// J. WRIGHT

kked L. WOODS


SHEET TITLE
ELECTRICAL RISER - BUILDING 1504

SCALE 12" = 1'-0"

SHEET NUMBER

D. NIETHAMMER

E5.1

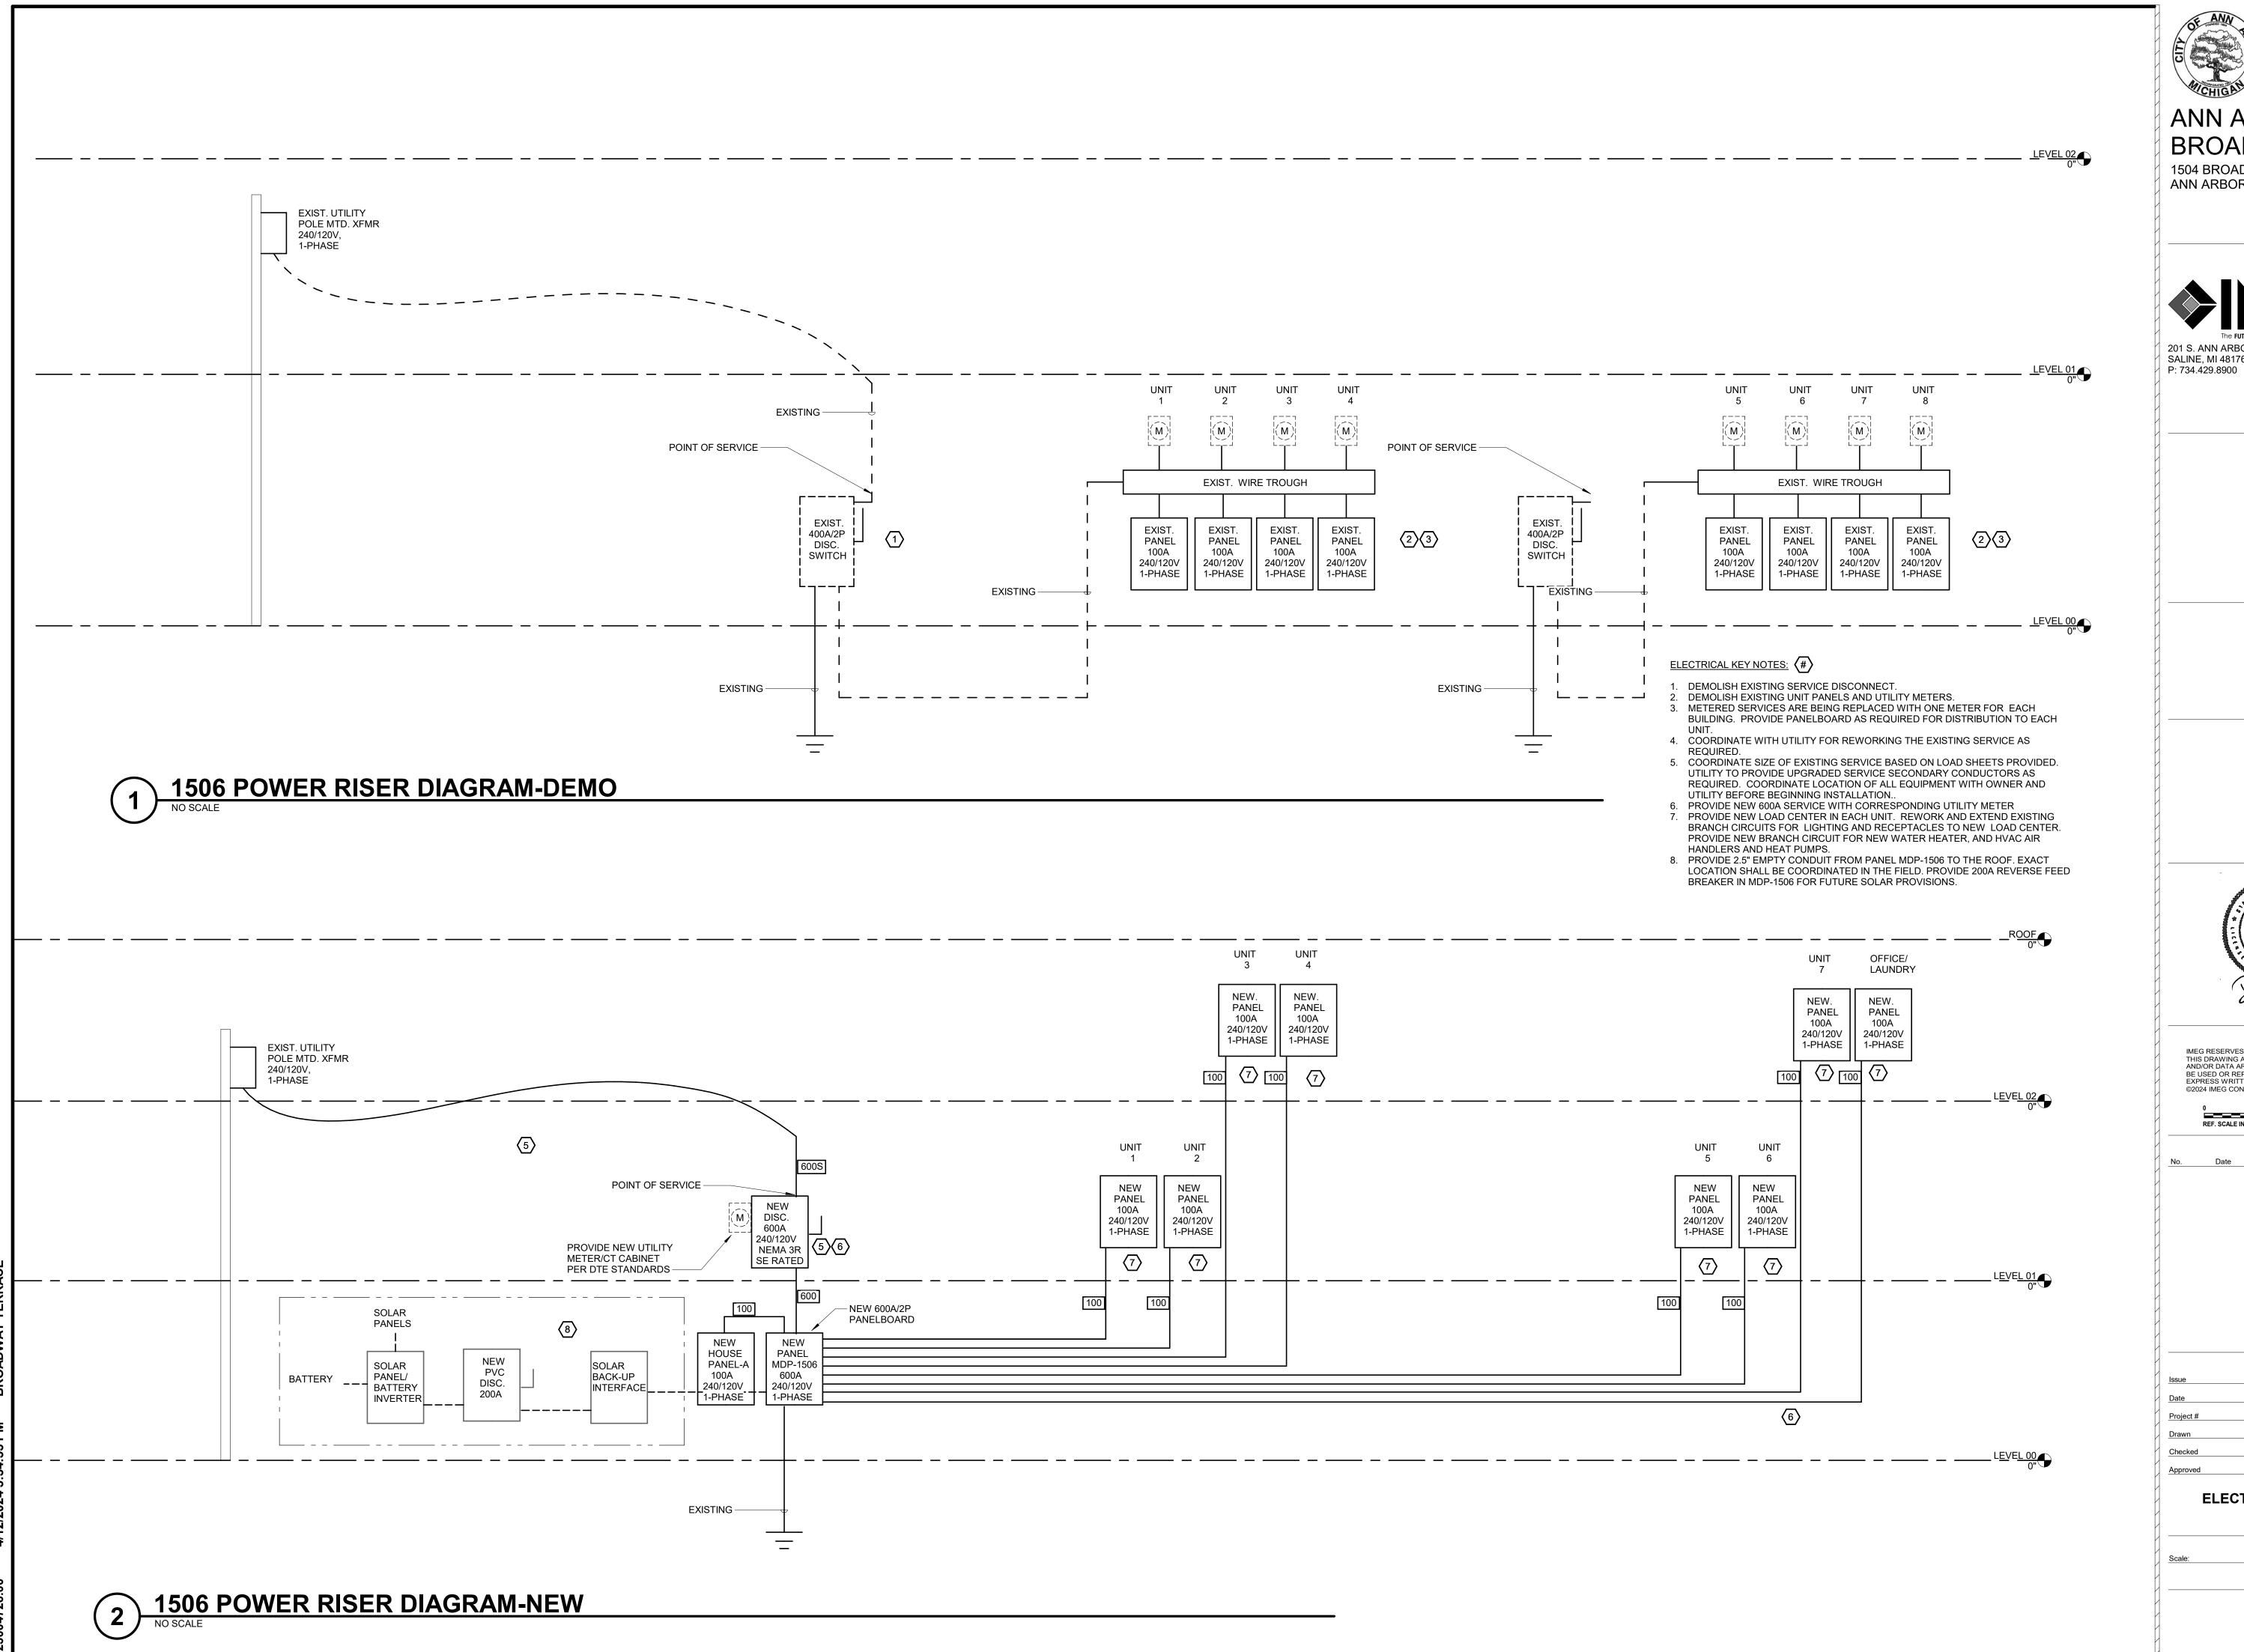





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REF. SCALE IN INCHES

SHEET INFORMATION D. NIETHAMMER

ELECTRICAL RISER - BUILDING 1506

12" = 1'-0"

E5.2

	FEE	DER SCHE	DULE		DERIVED SYSTEM GROUNDING ELE	CTRODE SIZING
	MIDE CIZES (CORRER)	CONDUIT		CONDIUT	30 KVA (OR LESS), 480-120/208V XFMR	#8 AWG CU
###	WIRE SIZES (COPPER)	CONDUIT	WIRE SIZES (ALUMINUM)	CONDUIT	45 KVA, 480-120/208V XFMR	#6 AWG CU
30	4#10, #10 GND	3/4"	4#10, #10 GND	3/4"	75 KVA, 480-120/208V XFMR	#2 AWG CU
100	4#4, #8GND	2"	4-#2, #8GND	2"	112.5 KVA, 480-120/208V XFMR	#2 AWG CU
200S	4#3/0	2"	4-250KCMIL	2 1/2"	150 KVA, 480-120/208V XFMR	#2/0 AWG CU
200i	4#3/0, #6 GND, #6 ISO GND	2 1/2"	N/A	N/A	225 KVA, 480-120/208V XFMR	#3/0 AWG CU
200ni	5#3/0, #6 GND, #6 ISO GND	3"	N/A	N/A	300 KVA (OR MORE), 480-120/208V XFMR	#3/0 AWG CU
225	4#4/0, #4 GND	2 1/2"	4-300KCMIL, #2 GND	2 1/2"	TVSS CONDUCTOR SIZ	ING
250	4-250KCMIL, #4 GND	2 1/2"	4-350KCMIL, #2 GND	3"		
300	4-350KCMIL, #4 GND	3"	4-500KCMIL, #2 GND	3"	30SS	5#10, 3/4"C
300S	4-350KCMIL	3"	4-500KCMIL	3"	60SS	5#6, 1"C
350	2 SETS 4#2/0, #3 GND	(2) 2"	2 SETS 4#4/0, #1 GND	(2) 2 1/2"	NOTE:	
400	2 SETS 4#3/0, #3 GND	(2) 2"	2 SETS 4-250KCMIL, #1 GND	(2) 2 1/2"	CONDUCTORS LENGTH SHALL BE LIMITED TO N	NOT MORE THAN 18".
400S	2 SETS 4#3/0	(2) 2"	2 SETS 4-250KCMIL	(2) 2 1/2"		
450	2 SETS 4#4/0, #2 GND	(2) 2 1/2"	2 SETS 4-300KCMIL, #1/0 GND	(2) 2 1/2"		
500	2 SETS 4-250KCMIL, #2 GND	(2) 2 1/2"	2 SETS 4-350KCMIL, #1/0 GND	(2) 3"		
500S	2 SETS 4-250KCMIL	(2) 2 1/2"	2 SETS 4-350KCMIL	(2) 3"		
600	2 SETS 4-350KCMIL, #1 GND	(2) 3"	2 SETS 4-500KCMIL, #2/0 GND	(2) 3 1/2"		
600S	2 SETS 4-350KCMIL	(2) 3"	2 SETS 4-500KCMIL	(2) 3 1/2"		
800	2 SETS 4-600KCMIL, #1/0 GND	(2) 3 1/2"	3 SETS 4-400KCMIL, #3/0 GND	(3) 3"		
800S	2 SETS 4-600KCMIL	(2) 3 1/2"	3 SETS 4-400KCMIL	(3) 3"		
1000	3 SETS 4-400KCMIL, #2/0 GND	(3) 3"	3 SETS 4-600KCMIL, #4/0 GND	(3) 3 1/2"		
1000S	3 SETS 4-400KCMIL	(3) 3"	4 SETS 4-350KCMIL	(4) 3"		
1200	4 SETS 4-350KCMIL, #3/0 GND	(4) 3"	4 SETS 4-500KCMIL, 600KCMIL GND	(4) 3 1/2"		
1200S	4 SETS 4-350KCMIL	(4) 3"	4 SETS 4-500KCMIL	(4) 3 1/2"		
1600	5 SETS 4-400KCMIL, #4/0 GND	(5) 3 1/2"	5 SETS 4-600KCMIL, 600KCMIL GND	(5) 3 1/2"		
1600S	5 SETS 4-400KCMIL	(5) 3 1/2"	5 SETS 4-600KCMIL	(5) 3 1/2"		
2000	6 SETS 4-400KCMIL, 250KCMIL GND	(6) 3 1/2"	6 SETS 4-600KCMIL, 600KCMIL GND	(6) 3 1/2"		
2000S	6 SETS 4-400KCMIL	(6) 4"	6 SETS 4-600KCMIL	(6) 4"		
2500	7 SETS 4-500KCMIL, 350KCMIL GND	(7) 4"	8 SETS 4-600KCMIL, 600KCMIL GND	(8) 4"		
2500S	7 SETS 4-500KCMIL	(7) 4"	8 SETS 4-600KCMIL	(8) 4"		
3000	8 SETS 4-500KCMIL, 400KCMIL GND	(8) 4"	9 SETS 4-600KCMIL, 600KCMIL GND	(9) 4"		
3000S	8 SETS 4-500KCMIL	(8) 4"	9 SETS 4-600KCMIL	(9) 4"		
4000	11 SETS 4-500KCMIL, 500KCMIL GND	(11) 4"	12 SETS 4-600KCMIL, 600KCMIL GND	(12) 4"		
4000S	11 SETS 4-500KCMIL	(11) 4"	12 SETS 4-600KCMIL	(12) 4"		

NC	<u>)TES:</u>
1.	NEUTRAL WIRES NOT REQ'D FOR TRANSFORMER PRIMARIES.

- 2. SEE RISER DIAGRAM FOR SERVICE GROUNDING ELECTRODE CONDUCTOR SIZING IN LIEU OF GROUND INDICATED (COPPER ROUNDS IN ALL CASES).
- . "S" INDICATES SERVICE FEEDERS.
- 4. "C" INDICATES FEEDERS COMPENSATED FOR CONTINUOUS LOAD.
- 5. "+" INDICATES FEEDERS COMPENSATED FOR VOLTAGE DROP.
- 6. "n" INDICATES AN ADDITIONAL NEUTRAL.

PA	NELBOA	ARD MDP 4 UN	IIT
	DEMAND	LOAD SUMMARY	
	52.115.115	20/10/00/11/11/11	
		<u>UNIT</u>	SUBTOTAL
		CONNECTED	CONNECTED
UNIT TYPE	QTY.	LOAD (kVA)	LOAD (kVA):
1B	1	30.3	30.3 kVA
2B	1	30.3	30.3 kVA
3B	1	30.3	30.3 kVA
4B	1	30.3	30.3 kVA
T	OTAL UNITS:	4	
	TOTAL UNIT	CONNECTED LOAD:	121.2 kVA
DEMAND	FACTOR, NF	PA 70, TABLE 220.84:	45%
	TOTAL	UNIT DEMAND LOAD:	54.5 kVA
HOUSE PANE	EL LOAD (SEE	PANEL SCHEDULE):	0.0 kVA
	SER	VICE DEMAND LOAD	55 kVA
	TOTAL A	MPS AT 240/120V, 1¢	227 AMPS
	SERVICE	E SIZE (100% RATED)	400 AMPS
NOTES:			

		UNIT	SUBTOTAL
		CONNECTED	CONNECTED
UNIT TYPE	QTY.	LOAD (kVA)	LOAD (kVA):
1B	1	30.3	30.3 kVA
28	1	30.3	30.3 kVA
3B	1	30.3	30.3 kVA
4B	1	30.3	30.3 kVA
5B	1	30.3	30.3 kVA
68	1	30.3	30.3 kVA
7B	1	30.3	30.3 kVA
8B	1	30.3	30.3 kVA
	TOTAL UNITS:	8	
	TOTAL UNIT	CONNECTED LOAD:	242.4 kVA
DEMAN		PA 70, TABLE 220.84:	
	TOTAL	UNIT DEMAND LOAD:	104.2 kVA
HOUSE PA	NEL LOAD (SE	E PANEL SCHEDULE):	0.0 kVA
	SER	RVICE DEMAND LOAD	104 kVA
	TOTAL A	MPS AT 240/120V, 1¢	434 AMPS
	SERVIC	E SIZE (100% RATED)	600 AMPS





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Revision / Issue

SHEET INFORMATION REVISED BIDS/PERMITS 23004726.00 D. NIETHAMMER SHEET TITLE FEEDER SCHEDULE

1/8" = 1'-0"

SHEET NUMBER

FED FROM:100A/2P @ MDP - 1504 and MDP - 1506 **LOCATION**: EACH UNIT

UA SINGLE TUB **SOLID NEUTRAL GROUND BUS**

MAIN: 100 A MLO **VOLTS:** 120/240 Single PHASE: 1 WIRE: 3 SCCR: 10 kA ISC: 10.00 kA

	NOTES:

	1	1			_				1		1		1	_				1				
K	CKT		OCF			WIRI SIZE	•	VD		A		В	С	VD		WIR SIZI	•		CPD		СКТ	
Υ	NO.	LOAD DESCRIPTION	AMPS	P	Н	N	G	%						%	G	N	Н	Р	AMPS	LOAD DESCRIPTION	NO.	Y
	1	CONDENSING UNIT	25 A	2					1.83	0.5								1	20 A	MEDIA PANEL-ARC	2	
	3										1.83	1.2						1	20 A	MICROWAVE/HOOD-ARC/GFCI	4	
	5	FURNACE	20 A	1					1.18	3								2	40 A	WATER HEATER	6	
	7	SPACE		1								3									8	
	9	ABOVE COUNTER REC-ARC/GFCI	20 A	1					0.5									1		SPACE	10	
	11	ABOVE COUNTER REC-ARC/GFCI	20 A	1							1	0.18						1	20 A	ABOVE COUNTER REC-ARC/GFCI	12	
	13	RANGE	40 A	2					0.88	0.9								1	20 A	BEDROOM RECS-ARC	14	
	15										0.88	0.18						1	20 A	RESTROOM REC - ARC/GFCI	16	
	17	LIVING RM RECS-ARC	20 A	1					2.44									1		SPACE	18	
	19	BEDROOM/RR LIGHTS-ARC	20 A	1							0.17	0.14						1	20 A	LIVING ROOM LIGHTS-ARC	20	
	21	SPACE		1														1		SPACE	22	
	23	SPACE		1														1		SPACE	24	
						To	otal l	Load:	11.22	2 kVA	8.57	kVA	0.00 kVA						•			
						То	tal A	mps:	93	.47	71	.38	0.00									

LOAD SUMMARY

LOAD CLASSIFICATION

SEE LOAD SUMMARY

*TOTAL DEMAND CALCS SUBTRACT ANY REDUNDANT LOAD AND THE SMALLER OF ANY NONCOINCIDENT HVAC LOADS. THIS CALC IS DONE AT EACH PANEL. CIRCUIT KEY NOTES: **MANUFACTURER SURGE PROTECTION SHALL BE PROVIDED FOR EACH UNIT LOAD CENTER**

DISTRIBUTION PANEL MDP - 1504

ENCLOSURE: NEMA 1 FED FROM: UTILITY TRANSFORMER **LOCATION:** BUILDING EXTERIOR

SOLID NEUTRAL **GROUND BUS**

MAIN: 400 A MCB **VOLTS:** 120/240 Single PHASE: 1 WIRE: 3

SCCR: 22kAIC ISC UNKNOWN 22kAIC.

NOTES:	
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Receptacles

СКТ	LOAD DESCRIPTION	Load	POLES	FRAME	TRIP	TYPE	ACC.	WIRE AND RACEWAY	CIRCUIT KEY
1	UNIT PANEL - UNIT 1	19.78 kVA	2	100 A	100 A			SEE RISER DIAGRAM	
2	UNIT PANEL - UNIT 2	19.71 kVA	2	100 A	100 A			SEE RISER DIAGRAM	
3	UNIT PANEL - UNIT 3	19.71 kVA	2	100 A	100 A			SEE RISER DIAGRAM	
4	UNIT PANEL - UNIT 4	19.71 kVA	2	100 A	100 A			SEE RISER DIAGRAM	
5									
6									
7									
8									
9									
10									
11									
12									

LOAD CLASSIFICATION

SEE LOAD SUMMARY

LOAD SUMMARY (INCLUDES ALL TUBS IN THIS PANEL)

*TOTAL DEMAND CALCS SUBTRACT ANY REDUNDANT LOAD AND THE SMALLER OF ANY NONCOINCIDENT HVAC LOADS. THIS CALC IS DONE AT EACH PANEL.

CIRCUIT KEY NOTES:

Receptacles

DISTRIBUTION PANEL MDP - 1506

ENCLOSURE: NEMA 1 FED FROM: UTILITY TRANSFORMER **LOCATION: BASEMENT LEVEL**

SOLID NEUTRAL **GROUND BUS**

MAIN: 600 A MCB VOLTS: 120/240 Single PHASE: 1 WIRE: 3 SCCR: 22kAIC ISC UNKNOWN 22kAIC

NOTES:

СКТ	LOAD DESCRIPTION	Load	POLES	FRAME	TRIP	TYPE	ACC.	WIRE AND RACEWAY	CIRCUIT KEY
1	UNIT PANEL - UNIT 1	19.71 kVA	2	100 A	100 A			SEE RISER DIAGRAM	
2	UNIT PANEL - UNIT 2	19.71 kVA	2	100 A	100 A			SEE RISER DIAGRAM	
3	UNIT PANEL - UNIT 3	19.71 kVA	2	100 A	100 A			SEE RISER DIAGRAM	
4	UNIT PANEL - UNIT 4	19.71 kVA	2	100 A	100 A			SEE RISER DIAGRAM	
5	UNIT PANEL - UNIT 5	19.71 kVA	2	100 A	100 A			SEE RISER DIAGRAM	
6	UNIT PANEL - UNIT 6	19.71 kVA	2	100 A	100 A			SEE RISER DIAGRAM	
7	UNIT PANEL - UNIT 7	19.71 kVA	2	100 A	100 A			SEE RISER DIAGRAM	
8	UNIT PANEL - OFFICE/LAUNDRY	19.71 kVA	2	100 A	100 A			SEE RISER DIAGRAM	
9	HOUSE	6.96 kVA	2	100 A	100 A			SEE RISER DIAGRAM	
10	HVAC-07	0.53 kVA	1	20 A	20 A			2#12,1#12G, 3/4"C.	
11	HVAC-08	0.53 kVA	1	20 A	20 A			2#12,1#12G, 3/4"C.	
12	HVAC-09	0.53 kVA	1	20 A	20 A			2#12,1#12G, 3/4"C.	
13	EWH-7	6 kVA	2	40 A	40 A			3#6,1#10G, 3/4"C.	
14	EWH-8	6 kVA	2	40 A	40 A			3#6,1#10G, 3/4"C.	
15									
16									
17									
18									
19									
20									
21									
22									
23									
24									
	1	LC	AD SUMN	ARY (INC	CLUDES A	ALL TUBS IN	THIS PANEL	<u>)</u>	1

LOAD CLASSIFICATION	CONNECTED LOAD	DEMAND FACTOR	ESTIMATED DEMAND	TOTALS*				
HVAC	13.584 kVA	100.00%	13.584 kVA	IOTALS				
Lighting	4.8 kVA	100.00%	4.8 kVA	TOTAL CONNECTED LOAD:	178.22 kVA			
Power	157.68 kVA	100.00%	157.68 kVA	TOTAL ESTIMATED DEMAND LOAD:	178.224 kVA			
Recept.	2.16 kVA	100.00%	2.16 kVA	TOTAL CONNECTED AMPS:	742.60 A			
				TOTAL ESTIMATED DEMAND AMPS:	742.6 A			
*TOTAL DEMAND OALOO OUDTDAOT AND	/ DED!	A N I D T I I E ON A A I I E D A	0E 448/4404400BENE					

*TOTAL DEMAND CALCS SUBTRACT ANY REDUNDANT LOAD AND THE SMALLER OF ANY NONCOINCIDENT HVAC LOADS. THIS CALC IS DONE AT EACH PANEL. **CIRCUIT KEY NOTES:**

PANEL HOUSE

MOUNTING: SURFACE **ENCLOSURE**: NEMA 1 **FED FROM:** 100A/2P@ MDP - 1506 **LOCATION:** BASEMENT LEVEL

SOLID NEUTRAL GROUND BUS

MAIN: 100 A MLO VOLTS: 120/240 Single PHASE: 1 WIRE: 3 **ISC:** 22.00 kA

NOTES:

CIRCUIT KEY NOTES:

K E Y	CKT NO.	LOAD DESCRIPTION	OCP AMPS		WIRE SIZE N		10		А В		С	VD %	WIRE SIZE G N H		OCPD P AMPS		S LOAD DESCRIPTION	CKT NO.	K E Y	
		EX. BASEMENT RECS	20 A	1			1.2	0.6								1		EX. BASEMENT LIGHTING	2	-
	3	EX. STAIR LIGHTING	20 A	1					0.6	1.2						1	20 A	EX. BASEMENT LIGHTING	4	
	5	EX. BASEMENT RECS	20 A	1			1.2	0.96								1	20 A	EX. BASEMENT RECS	6	
	7	EX. EXTERIOR LIGHTING(PC/TC)	20 A	1					1.2							1		SPACE	8	
	9	SPACE		1	 											1		SPACE	10	
	11	SPACE		1	 											1		SPACE	12	
	13	SPACE		1	 											1		SPACE	14	
	15	SPACE		1	 											1		SPACE	16	
	17	SPACE		1	 											1		SPACE	18	
	19	SPACE		1	 											1		SPACE	20	
	21	SPACE		1	 											1		SPACE	22	
	23	SPACE		1	 											1		SPACE	24	
	25	SPACE		1	 											1		SPACE	26	
	27	SPACE		1	 											1		SPACE	28	
	29	SPACE		1	 											1		SPACE	30	
						otal Load: tal Amps:		8.00		kVA .00	0.00 kVA 0.00						•			

LOAD SUMMARY												
CONNECTED LOAD	DEMAND FACTOR	ESTIMATED DEMAND	TOTAL C*									
4.8 kVA	100.00%	4.8 kVA	TOTALS									
2.16 kVA	100.00%	2.16 kVA	TOTAL CONNECTED LOAD:	6.96 kVA								
			TOTAL ESTIMATED DEMAND LOAD:	6.96 kVA								
			TOTAL CONNECTED AMPS:	29.00 A								
			TOTAL ESTIMATED DEMAND AMPS:	29 A								
	4.8 kVA	CONNECTED LOAD DEMAND FACTOR 4.8 kVA 100.00%	CONNECTED LOAD DEMAND FACTOR ESTIMATED DEMAND 4.8 kVA 100.00% 4.8 kVA	CONNECTED LOAD DEMAND FACTOR ESTIMATED DEMAND 4.8 kVA 100.00% 4.8 kVA 2.16 kVA 100.00% 2.16 kVA TOTAL CONNECTED LOAD: TOTAL ESTIMATED DEMAND LOAD: TOTAL CONNECTED AMPS:								

ANN ARBOR HOUSING BROADWAY TERRACE 1504 BROADWAY ST

ANN ARBOR MI 48104



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Revision / Issue

SHEET INFORMATION REVISED BIDS/PERMITS 23004726.00 D. NIETHAMMER

ELECTRICAL PANEL SCHEDULES