City of Ann Arbor

2024 Water Treatment Plant Filter 18/20 Underdrain Improvements

Ann Arbor, Michigan

Issued for Bids and Construction July 25, 2024

Project Number: 231370

ITB Number: 4752

C2R2 Project Number: C2A-018

GENERAL

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DEMOLITION

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PROCESS

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P101 HYDRAULIC PROFILE

P201 FILTER PLANS SECTIONS

P401 PROJECT DETAILS P402 PROJECT DETAILS

Ann Arbor, MI. 48103 BL 194;US 23 BUS

GENERAL ABBREVIATIONS

CONC CONCRETE

DIA DIAMETER

CONST CONSTRUCTION

CONT CONTINUOUS

DOWN

DOWNSPOUT

ACM ALUMINUM COMPOSITE MATERIAL AFF ABOVE FINISHED FLOOR AHU AIR HANDLING UNIT ALUMINUM ALTERNATE BARRIER FREE BEARING CONTROL JOINT CENTERLINE CURTAINWALL CLG CEILING CMU CONCRETE MASONRY UNIT CO CLEANOUT

EXHAUST FAN ELEVATION EXPANSION JOINT EQUAL ELECTRIC WATER COOLER FLOOR DRAIN FIRE RETARDANT TREATED FOOT/FEET GUAGE/GAGE GALV GALVANIZED GENERAL CONTRACTOR HOSE BIBB HIGH POINT HORIZ HORIZONTAL HEATING VENTILATING AIR

CONDITIONING

INSIDE DIAMETER

IMP INSULATED METAL PANEL

INVERT ELEVATION

IN INCH/INCHES INSUL INSULATION LAV LAVATORY LIGHT EMITTING DIODE LLH LONG LEG HORIZONTAL LONG LEG VERTICAL LOW POINT MANUFACTUREF MAX MAXIMUM MEZZ MEZZANINE MINIMUM MASONRY OPENING MOUNTED NOT APPLICABLE NOISE CRITERIA NOT IN CONTRACT

MIN

NUMBER


NOISE REDUCTION COEFFICIENT NOT TO SCALE ON CENTER OUTSIDE DIAMETER OVERHEAD OPPOSITE OVERFLOW ROOF DRAIN OUTSIDE PERP PERPENDICULAR PLATE POUNDS PER SQUARE FOOT POUNDS PER SQUARE INCH POLYVINYL CHLORIDE RADIUS REQD REQUIRED ROOF DRAIN SCHEDULE

SQUARE FOOT

SGT STRUCTURAL GLAZED TILE SIM SIMILAR SPACE/SPACING SQUARE STAINLESS STEEL STD STANDARD TANGENT **TYPICAL** UNDERWRITER'S LABORATORY UNO UNLESS NOTED OTHERWISE VERT VERTICAL VENT THROUGH ROOF VTR WC WATER CLOSET WATER HEATER W/O WITHOUT WP WEATHERPROOF WT WEIGHT

SECTION CUT LINE ELEVATION, SECTION, AND DETAIL DESIGNATION PLAN DESIGNATION SCALE: 1/8" = 1'-0"

GRAPHIC SYMBOLS

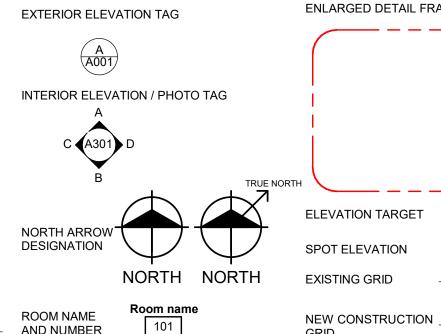

919 Sunset Rd

ENLARGED DETAIL FRAME SIGNAGE TAG FINISH TAG BULLETIN IDENTIFICATION ADDENDUM IDENTIFICATION A SKETCH IDENTIFICATION **ELEVATION TARGET** BARRIER FREE LOCATION SPOT ELEVATION NEW CONSTRUCTION EXISTING GRID KEY NOTE

DEMOLITION

LOCATION MAP

SCALE: NOT TO SCALE

SEAL

REVISIONS

7/25/2024 BIDS AND CONSTRUCTION Drawn By RS2 Designer ANW

Reviewer MTP

Manager BP

Hard copy is intended to be 24"x36" when plotted. Scale(s) indicated and graphic quality may not be accurate for any other size

> PROJECT NO. 231370

> > SHEET NO.

SYMBOLS LEGEND

AREA NOT TO BE BLOCKED

AREAS ALLOWED FOR EQUIPMENT STAGING

CLARIFIER NO. 5 RECYCLE PUMP STATION ADMINISTRATIVE BUILDING EQ TANKS WORK AREA FILTERS 18 & 20 BUILDING CLEARWELLS RESERVOIR FLOCCULATION BASIN NO. 5 FILTER BUILDING FLOCCULATION BASIN NO. 4 FLOCCULATION FLOCCULATION BASIN NO. 1 BASIN NO. 2 THICKENER SEDIMENTATION THICKENER **BASINS** NO. 2 CLARIFIER NO. 4 CLARIFIER NO. 3



REVISIONS

7/25/2024 BIDS AND CONSTRUCTION

Drawn By RS2 Designer ANW

Reviewer MTP


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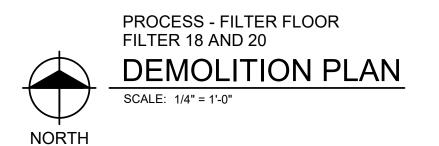
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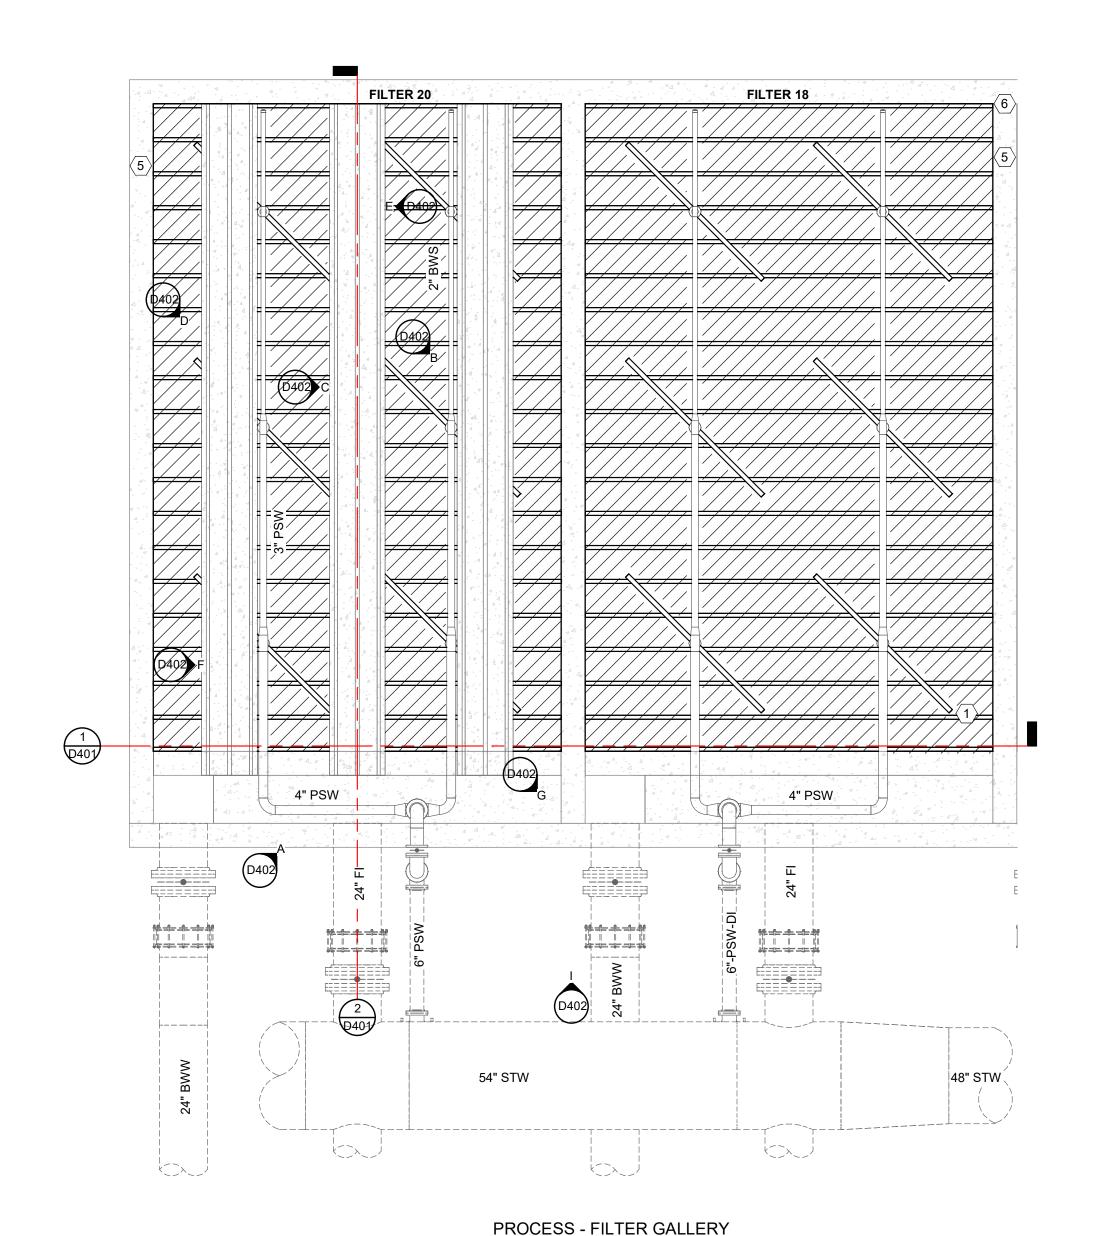
G102



FILTER 18 AND 20 SECTION SCALE: 1/4" = 1'-0"

FILTER 20 FILTER 18 lablacciacolacciaciacolacciacolacciac |aaaaa|aaa|aaa|aaa|aaa|aaa| *Idada da para da para* 4 18" FE 18" FE 0000 Q401 24" BWW 24" BWW 6" PSW _6" PSW_



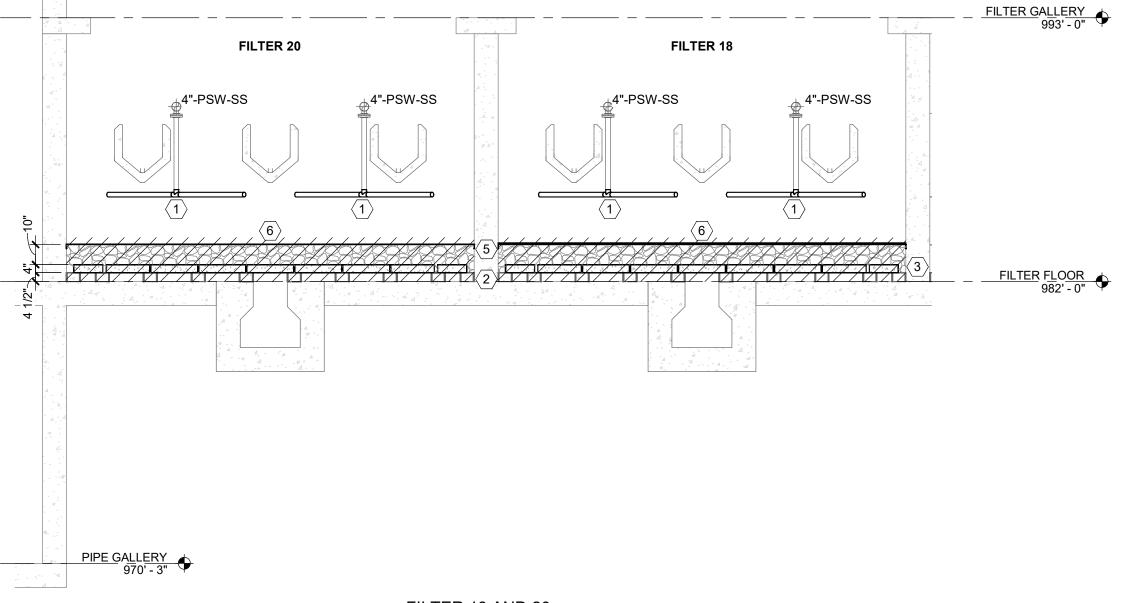

FILTER 18 AND 20 **DEMOLITION PLAN** SCALE: 1/4" = 1'-0" **NORTH**

SYMBOLS LEGEND

EQUIPMENT AND PIPING TO BE DEMOLISHED GRAVEL TO BE DEMOLISHED

PROCESS DEMOLITION NOTES

- 1. REMOVE ALL PORTIONS OF WORK IDENTIFIED BY CROSS HATCHING UNLESS NOTED OTHERWISE.
- 2. DEMOLITION NOTES AND PLANS DO NOT FULLY REPRESENT ALL DEMOLITION WORK REQUIRED TO INSTALL NEW WORK IN ACCORDANCE WITH CONTRACT DOCUMENTS. BUT ARE INTENDED TO SERVE AS GENERAL DEMOLITION GUIDELINES.
- 3. GRAPHICAL REPRESENTATION OF EXISTING SYSTEMS WERE OBTAINED FROM PREVIOUS CONSTRUCTION AND/OR RECORD DRAWINGS MAY NOT FULLY REPRESENT EXISTING CONDITIONS AND IS FOR REFERENCE ONLY. CONTRACTOR TO FIELD VERIFY EXISTING CONDITIONS TO DETERMINE EXTENT
- 4. COORDINATE PHASING AND SEQUENCING OF DEMOLITION IN ACCORDANCE WITH PLANS AND SPECIFICATIONS AND WITH OTHER CONTRACTORS IN ORDER TO MAINTAIN CONTINUING OPERATIONS FOR OWNER. ALSO, TO MAINTAIN BUILDING SECURITY AND WEATHER TIGHTNESS.
- 5. COORDINATE ITEMS, IF ANY TO BE TURNED OVER TO THE OWNER PRIOR TO BEGINNING DEMOLITION. CONTRACTOR TO REMOVE, PROTECT AND RELOCATE ITEMS TO BE TURNED OVER TO THE OWNER.

NOTES

- 1. FILTER 18 AND FILTER 20 WALKWAY HIDDEN FROM FILTER GALLERY PLAN FOR CLARITY OF BACKWASH TROUGHS AND SURFACE WASH ARMS.
- 2. FILTER 18 BACKWASH TROUGHS HIDDEN FROM FILTER GALLERY PLAN FOR CLARITY OF SURFACE WASH ARMS
- 3. FILTER 18 UNDERDRAIN MODULES HIDDEN FROM FILTER FLOOR PLAN FOR CLARITY OF CONCRETE SUPPORT COLUMNS.

(#) DEMOLITION KEY NOTES

- 1 REMOVE, SERVICE, AND REINSTALL SURFACE WASH ARMS. TYPICAL OF 6 PER FILTER. TYPICAL OF FILTER 18 AND FILTER 20.
- 2 DEMOLISH CONCRETE SUPPORT COLUMNS (7" D X 4.5" H) ON FILTER FLOOR. TYPICAL OF FILTER 18 AND FILTER 20.
- 3 DEMOLISH UNDERDRAIN MODULES, INCLUDING CONCRETE BLOCKS AND CERAMIC SPHERES. TYPICAL OF FILTER 18 AND FILTER 20.
- 4 REMOVE, PAINT, AND REINSTALL FW/BWS PIPE, STEEL WALL PLATE, AND FITTINGS. TYPICAL OF FILTER 18 AND
- FILTER 20. 5 DEMOLISH GRAVEL AND STAINLESS STEEL #8 MESH RETAINING SCREEN. TYPICAL OF FILTER 18 AND FILTER 20.
- GRAVEL HIDDEN IN PLAN VIEW FOR CLARITY.
- 6 DEMOLISH STEEL HOLD-DOWN STRAPS AND ANGLES. 7 RESTORE CONCRETE AT WALL PLATE. SEE DETAIL.

REVISIONS

1

C

7/25/2024 BIDS AND CONSTRUCTION

Drawn By RS2

Designer ANW Reviewer MTP

Manager BP Hard copy is intended to be

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City

REVISIONS

Designer ANW Reviewer MTP

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231370

PROJECT NO.

SHEET NO.

D402

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SYMBOLS LEGEND



(#) DEMOLITION KEY NOTES

- REMOVE, SERVICE, AND REINSTALL SURFACE WASH ARMS. TYPICAL OF 6 PER FILTER. TYPICAL OF FILTER 18 AND FILTER
- 2 PROTECT SURROUNDING INSTRUMENTATION, ETC. 3 REMOVE, PAINT, AND REINSTALL FW/BWS PIPE, STEEL WALL PLATE, AND FITTINGS. TYPICAL OF FILTER 18 AND FILTER 20.
- 4 DEMOLISH STEEL HOLD-DOWN STRAPS AND ANGLES. 5 DEMOLISH GRAVEL AND STAINLESS STEEL #8 MESH RETAINING SCREEN. TYPICAL OF FILTER 18 AND FILTER 20. GRAVEL HIDDEN IN PLAN VIEW FOR CLARITY.
- 6 REPAIR BACKWASH TROUGH CONCRETE. SEE CONCRETE RESTORATION DETAIL.
- RESTORE CONCRETE AT WALL PLATE. SEE DETAIL.
- 8 RESTORE CONCRETE AT FILTER WALL. SEE DETAIL. 9 REMOVE, STORE, AND REINSTALL RAILING AS NEEDED.
- 10 PROTECT FILTER CONTROL CONSOLE.
- 11 PROTECT EXISTING PIPING, VALVES, ETC.
- 12 PROTECT FLOORS WHERE WORKERS ARE PRESENT. PROVIDE RUBBER MAT, MINIMUM THICKNESS 1/4". PROVIDE FELT BARRIER BETWEEN FLOOR AND RUBBER MAT.
 CONTRACTOR RESPONSIBLE FOR DAMAGE TO FLOORING.

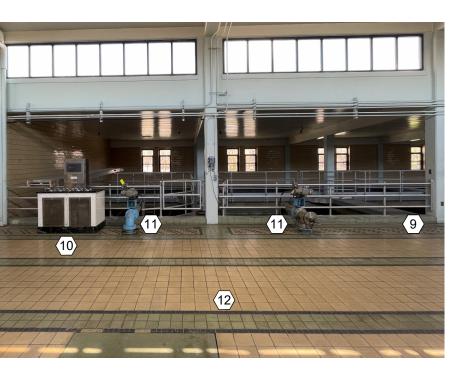


PHOTO
SCALE: NOT TO SCALE







PHOTO
SCALE: NOT TO SCALE

A PHOTO
SCALE: NOT TO SCALE



F PHOTO SCALE: NOT TO SCALE





PHOTO
SCALE: NOT TO SCALE

D PHOTO
SCALE: NOT TO SCALE



G PHOTO
SCALE: NOT TO SCALE

C PHOTO
SCALE: NOT TO SCALE



SCREENED LINE DENOTES EXISTING PIPING OR EQUIPMENT


SCREENED DASHED LINE DENOTES EXISTING BELOW PIPING

NOTES


- 1. THE WALL PIPE SCHEDULE IS PROVIDED AS AN AID, BUT DOES NOT INCLUDE ALL THE PROJECT PENETRATIONS. SPECIFICALLY PENETRATIONS SMALLER THAN 4 INCH NOMINAL SIZE. VERIFY ALL PENETRATION REQUIREMENTS
 AND PROVIDE PENETRATIONS FOR A COMPLETELY OPERABLE SYSTEM.
- CONTACT ENGINEER FOR ABBREVIATIONS AND SYMBOLS USED BUT NOT SHOWN ON THIS DRAWING.


WALL PIPE SCHEDULE					
TAG	DETAIL TYPE	PIPE SIZE	SERVICE	END CONNECTIONS	NOTES
WP-1-1	WP-1	6"	AIR SCOUR	FLGxFLG	316 STAINLESS STEEL
WP-1-2	WP-1	6"	AIR SCOUR	FLGxFLG	316 STAINLESS STEEL

LEGEND: "WP" =WALL PIPE

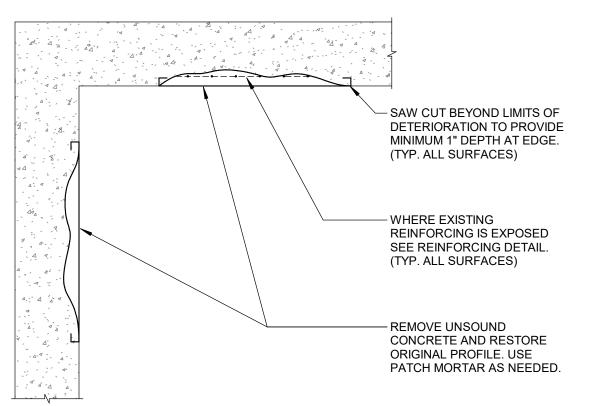



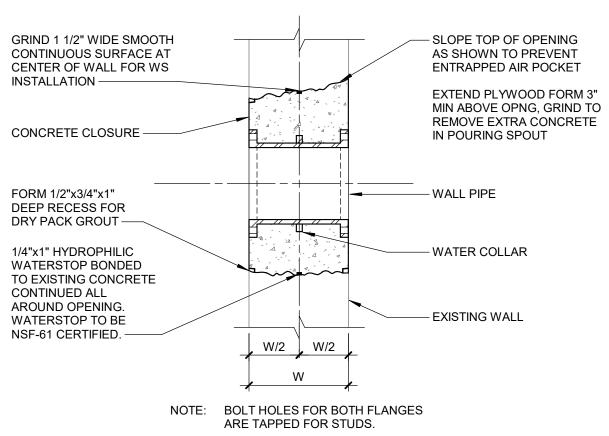

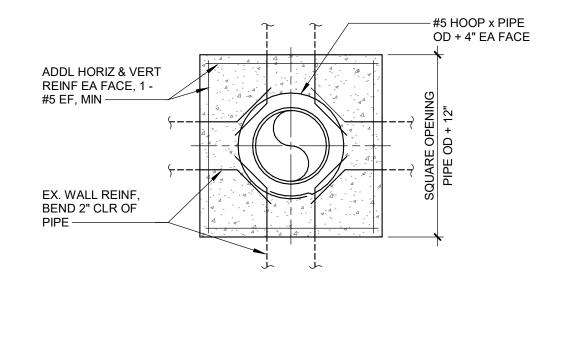

<u>WP-1</u> WALL PIPE - FLG x FLG

PROCESS GENERAL ABBREVIATIONS

Α	AIR	DEG	DEGREE	GPD
AB	ANCHOR BOLT	DEMO	DEMOLITION	GPM
ABAN	ABANDON/ABANDONED	DET	DETAIL	GR
ADJ	ADJACENT	DIA	DIAMETER	HB
AFF	ABOVE FINISHED FLOOR	DIF	DIFFUSER	HDPE
AG	ABOVE GRADE	DIM	DIMENSION	HDWL
AGGR	AGGREGATE	DISCH	DISCHARGE	HGR
AL	ALUMINUM	DIST	DISTANCE	HGL
ALT	ALTERNATE/ALTERNATIVE	DIR	DIRECTION	HORIZ
AMT	AMOUNT	DMS	DIAPHRAGM SEAL	HP
APPROX	APPROXIMATE	DN	DOWN	HP
	ASSEMBLY	DP	DEEP/DEPTH	HT
AVG	AVERAGE	DWG	DRAWING	HVAC
В	BEND			HW
B/B	BACK TO BACK	E	EAST	HWL
BCKR	BACKER BOARD	E/E	END TO END	HYD
BF	BLIND FLANGE	EA	EACH	HZ
BFG	BELOW FINISHED GRADE	ECC	ECCENTRIC	I.E.
BFP	BACKFLOW PREVENTER	ED	EQUIPMENT DRAIN	I.D.
BLDG	BUILDING	EHT	ELECTRICALLY HEAT-TRACED	IN
	BULKHEAD	EJ	EXPANSION JOINT	INS
	BLOWDOWN	EL	DRAIN-WASTE-VENT EAST END TO END EACH ECCENTRIC EQUIPMENT DRAIN ELECTRICALLY HEAT-TRACED EXPANSION JOINT ELEVATION ELEVATION	INCL
BM	BENCHMARK	ELEV	ELEVATION	INSTR
BMC	BOLTED MECHANICAL COUPLING	ELL	ELBOW	INT
BOT	BOTTOM		EMBEDMENT	INV
BRG	BEARING	ENGR	ENGINEER	IPS
BSMT	BASEMENT	EQ	EQUAL	IR
BTU	BRITISH THERMAL UNITS	EQUIP	EQUIPMENT	JT
BTWN	BETWEEN	ES	EACH SIDE	LAB
C/C	CENTER TO CENTER	ESEW	EMERGENCY SHOWER AND EYE WASH	LAT
CB	CATCH BASIN	EW	EACH WAY	LB
CF	CUBIC FEET	EXC	EXCAVATE (ION)	LF
CFS	CUBIC FEET PER SECOND	EX	EXISTING	LGTH
CFM	CUBIC FEET PER MINUTE	EXIST	EXISTING	LH
CHAM	CHAMFER	EXP	EXPOSED	LIQ
CHEM	CHEMICAL	EXT	EXTERIOR	LLWL
CHKPL	CHECKERPLATE	F/F	FACE TO FACE	LONG
CL	CENTERLINE	FAB	FABRICATED	LP
CLR	CLEARANCE	FD	FLOOR DRAIN	LR
CO	CLEANOUT	FF	FINISHED FLOOR	LWL
COMP	COMPANION	FIG	FIGURE	М
CONC	CONCRETE	FIN	FINISHED	MAINT
CONC	CONCENTRATED	FLR	FLOOR	MATL
CONC	CONCENTRIC	FM	FORCE MAIN	MAX
CONCT	CONCEDUCTION	CDD.	FIDERCLACC DEINICORCED DI ACTIC	MECE

FRP FSP FTG

FIBERGLASS REINFORCED PLASTIC

GRANULATED ACTIVATED CARBON

MJ MECHANICA MTD MOUNTED MTL METAL

FABRICATED STEEL PIPE

F.V. FIELD VERIFY
GA GAUGE/GAGE
GAC GRANULATED ACTIVATED CARB
GFA GROOVED FLANGE ADAPTER
GPC GROOVED PIPE COUPLING

FITTING

- RESTORE ORIGINAL WALL

OR TROUGH PROFILE

- WIRE BRUSH OR BLAST

CLEAN EX. REINFORCING;

COAT REINFORCING W/ (2)

COATS OF ZINC RICH PRIMER

- WHERE CROSS SECTIONAL LOSS

IS GREATER THAN 10%, SPLICE

ADDITIONAL REINFORCING

MATCHING ORIGINAL SIZE

TYPICAL REINFORCING DETAIL

GPD	GALLONS PER DAY	N	NORTH
GPM	GALLONS PER MINUTE	NA	NOT APPLICABLE
GR	GRADE	NIC	NOT IN CONTRACT
HB	HOSE BIBB	NO.	NUMBER
HDPE	HIGH DENSITY POLYETHYLENE EXTRUSION	NPT	AMERICAN NATIONAL TAPER PIPE THREAD
HDWL	HEADWALL	NTS	NOT TO SCALE
HGR	HANGER	O.C.	ON CENTER
HGL	HYDRAULIC GRADE LINE	O.D.	OUTSIDE DIAMETER
HORIZ	HORIZONTAL	O.D. OE	OVERHEAD ELECTRICAL
HP	HIGH POINT	OPNG	
		-	OPENING
HP	HORSEPOWER	OPP	OPPOSITE
HT	HEIGHT	ORIG	ORIGINAL
HVAC	HEATING, VENTILATING AND AIR CONDITIONING	OVHD	OVERHEAD
HW	HOT WATER	P	PUMP, PUMPING
HWL	HIGH WATER LEVEL	P&ID	PROCESS AND INSTRUMENTATION DIAGRAM
HYD	HYDRAULIC	PE	PLAIN END
HZ	HERTZ	PERF	PERFORATED
I.E.	INVERT ELEVATION	PL	PLATE
I.D.	INSIDE DIAMETER	PNL	PANEL
IN	INCH	PPM	PARTS PER MILLION
INS	INSULATION, INSULATE	PR	PAIR
INCL	INCLUDE	PROP	PROPOSED
INSTR	INSTRUMENT, INSTRUMENTATION	PS	PUMP STATION
INT	INTERIOR	PSF	POUNDS PER SQUARE FOOT
INV	INVERT	PSI	POUNDS PER SQUARE INCH
IPS	IRON PIPE SIZE	PTD	PAINTED
IR	ISOLATION RING	Q	FLOW
JT	JOINT	QTY	QUANTITY
LAB	LABORATORY	R	RADIUS
LAT	LATERAL	RD	ROOF DRAIN
LB	POUND	RECIRC	RECIRCULATE/RECIRCULATING/RECIRCULATION
LF	LINEAL FOOT	RED	REDUCER/REDUCING
LGTH	LENGTH	REF	REFERENCE
LH	LEFT HAND	REHAB	REHABILITATION
LIQ	LIQUID	REINF	REINFORCE/REINFORCING
LLWL	LOW LOW WATER LEVEL	REQD	REQUIRED
LONG	LONGITUDINAL	RES	RESERVOIR
LP	LOW POINT	RESIL	RESILIENT
LR	LONG RADIUS	REV	REVISION
LWL	LOW WATER LEVEL	RFA	RESTRAINED FLANGE ADAPTER
M	MOTOR	RH	RIGHT HAND
MAINT	MAINTENANCE	RJ	RESTRAINED JOINT
MATL	MATERIAL	RM	ROOM
MAX	MAXIMUM	RO	ROUGH OPENING
MFGR	MANUFACTURER	RPM	REVOLUTIONS PER MINUTE
MGD	MILLION GALLONS PER DAY	RSR	RISER
MH	MANHOLE	RUB	RUBBER
MIN	MINIMUM	S	SOUTH
MISC	MISCELLANEOUS	SAN	SANITARY
MJ	MECHANICAL JOINT	SCH	SCHEDULE
MTD	MOUNTED	SCRN	SCREEN
MTL	METAL	SED	SEDIMENTATION
IVIIL		ULU	

SED SEDIMENTATION

ON	SL SP SP SPEC SRP SQ. FT. SQ. YD. SR SS STA STD STG STL SUBM SUCT SUSP SW SYS TDH TEMP THK TPG UL UTIL UV V VAC VB VERT VOL VTR W/W/O WGT	SHEET/SHEETING SIMILAR SLOPE SAMPLE POINT STATIC PRESSURE SPECIFICATION/SPECIFIED SPARE SQUARE FOOT SQUARE YARD SHORT RADIUS STAINLESS STEEL STATION STANDARD STORAGE STEEL SUBMERGED SUCTION SURFACE SUSPENDED SOCKET WELDED SYSTEM TOTAL DYNAMIC HEAD TEMPERATURE THICK TOPPING TYPICAL UNDERGROUND UNDERWRITERS LABORATORY UTILITY ULTRAVIOLET DISINFECTION VOLTS VACUUM VALVE BOX VERTICAL VOLUME VENT TO ROOF WEST WITH WITHOUT WEIGHT WALL HYDRANT WATER LEVEL WEATHERPROOF WATERSTOP WATERSTOP WATERSTOP WATER SURFACE ELEVATION EXPLOSION PROOF YARD HYDRANT
----	----------------------------------------------------------------------------------------------------------------------------------------------------------------------------------------------------------------------------------------	----------------------------------------------------------------------------------------------------------------------------------------------------------------------------------------------------------------------------------------------------------------------------------------------------------------------------------------------------------------------------------------------------------------------------------------------------------------------------------------------------------------------------------------------------------------------

BWR BWS BWW CA CLP CLS D/DR DC DG DSL EFF FECL FLT FW FTW HFS HYPO IA INFL LIME LO	FILTERED WATER FILTER TO WASTE HYDROFLUOROSILICIC ACID SODIUM HYPOCHLORITE INSTRUMENT AIR INFLUENT LIME LUBRICATION OIL	PIW PLR POLY PSW PU PUW PW RAS RW SAN SBD SL SN SPL SODA SPD SLR STR STW SW TSL	PLANT RECYCLE POLYMER PLANT SERVICE WATER PNEUMATIC UNLOADING PLANT UTILITY WATER POTABLE/FINISHED WATER RETURN ACTIVATED SLUDGE RAW WATER SANITARY SODIUM BISULFITE SLUDGE SUPERNATANT SAMPLE LINE SODA ASH SUMP PUMP DISCHARGE SLUDGE RECIRCULATION SLUDGE TRANSFER SETTLED/CLARIFIED WATER THICKENED SLUDGE
LPG ME NA NG NH	LIQUIFIED PETROLEUM GAS METHANOL CAUSTIC NATURAL GAS AMMONIA	TSL TW V VC W WAS	THICKENED SLUDGE TEMPERED WATER VENT VACUUM WASTE WASTE ACTIVATED SLUDGE
NPW OF OX PA PAC	NON-POTABLE WATER OVERFLOW OXYGEN PLANT AIR POWDERED ACTIVATED CARBON	WF WF WTR WW WWS	WARM FLARE WATER WASTE WATER

PIPE CONTENT ABBREVIATIONS

CI CPVC CS CU DI FRP GALV HDPE PCCP	CAST IRON CHLORINATED POLYVINYL CHLORIDE CARBON STEEL COPPER DUCTILE IRON FIBERGLASS REINFORCED PLASTIC GALVANIZED STEEL HIGH-DENSITY POLYETHYLENE PRESTRESSED CONCRETE CYLINDER PIPE	PE PP PTFE PVC PVDF RCP 316SS TT	POLYETHYLENE POLYPROPYLENE TEFLON PIPE POLYVINYL CHLORIDE POLYVINYLIDENE FLUORIDE (KYNAR) REINFORCED CONCRETE PIPE STAINLESS STEEL (NUMERIC INDICATES GRADE TITANIUM

ANALYTICAL ABBREVIATIONS

ALK CH4	ALKALINITY METHANE	O3 ORP	OZONE OXIDATION/REDUCTION POTENTIAL
CL2 COMB	CHLORINE COMBUSTIBLE GAS	PC PH	PARTICLE COUNTER HYDROGEN ION CONCENTRATION
CON	CONDUCTIVITY	PO4	PHOSPHATE
DO F	DISSOLVED OXYGEN FLUORIDE	SC SO2	STREAMING CURRENT SULFURE DIOXIDE
г IR	INFRARED	TEMP	TEMPERATURE
H2S	HYDROGEN SULFIDE	TH	TOTAL HARDNESS
METH	METHANOL	TSS	TOTAL SUSPENDED SOLIDS
NH3 NO3	AMMONIA NITRATE	TURB UV	TURBIDITY ULTRAVIOLET
02	OXYGEN		

PROCESS EQUIPMENT ABBREVIATIONS

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7/25/2024 BIDS AND CONSTRUCTION

Drawn By ANW Designer ANW

Reviewer MTP Manager BP

4 Water Treatment Plant /20 Underdrain Improvements ABBREVIATIONS, SCHEDULE AND DETAILS

202 r 18/

REVISIONS

Filte GEN

Arbo

C

PROJECT NO. 231370

SHEET NO.

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CONST CONSTRUCTION

CONTROL

COLD WATER

CUBIC YARD

CHLORINATED POLYVINYL CHLORIDE

COORD COORDINATE

COR CORRUGATED

CPLG COUPLING

CW

DE)


FILTER PROFILE

SCALE: HORIZONTAL N.T.S VERTICAL 1" = 1'



- 1. FIELD VERIFY EXISTING ELEVATIONS. 2. PROPOSED FILTER PROFILE SHOWN FOR REFERENCE ONLY. SEE PROCESS SECTIONS FOR DETAILS.

3. DEMOLISH FILTER UNDERDRAIN AND GRAVEL SHOWN IN EXISTING FILTER PROFILE. SEE PROCESS DEMOLITION FOR DETAILS.

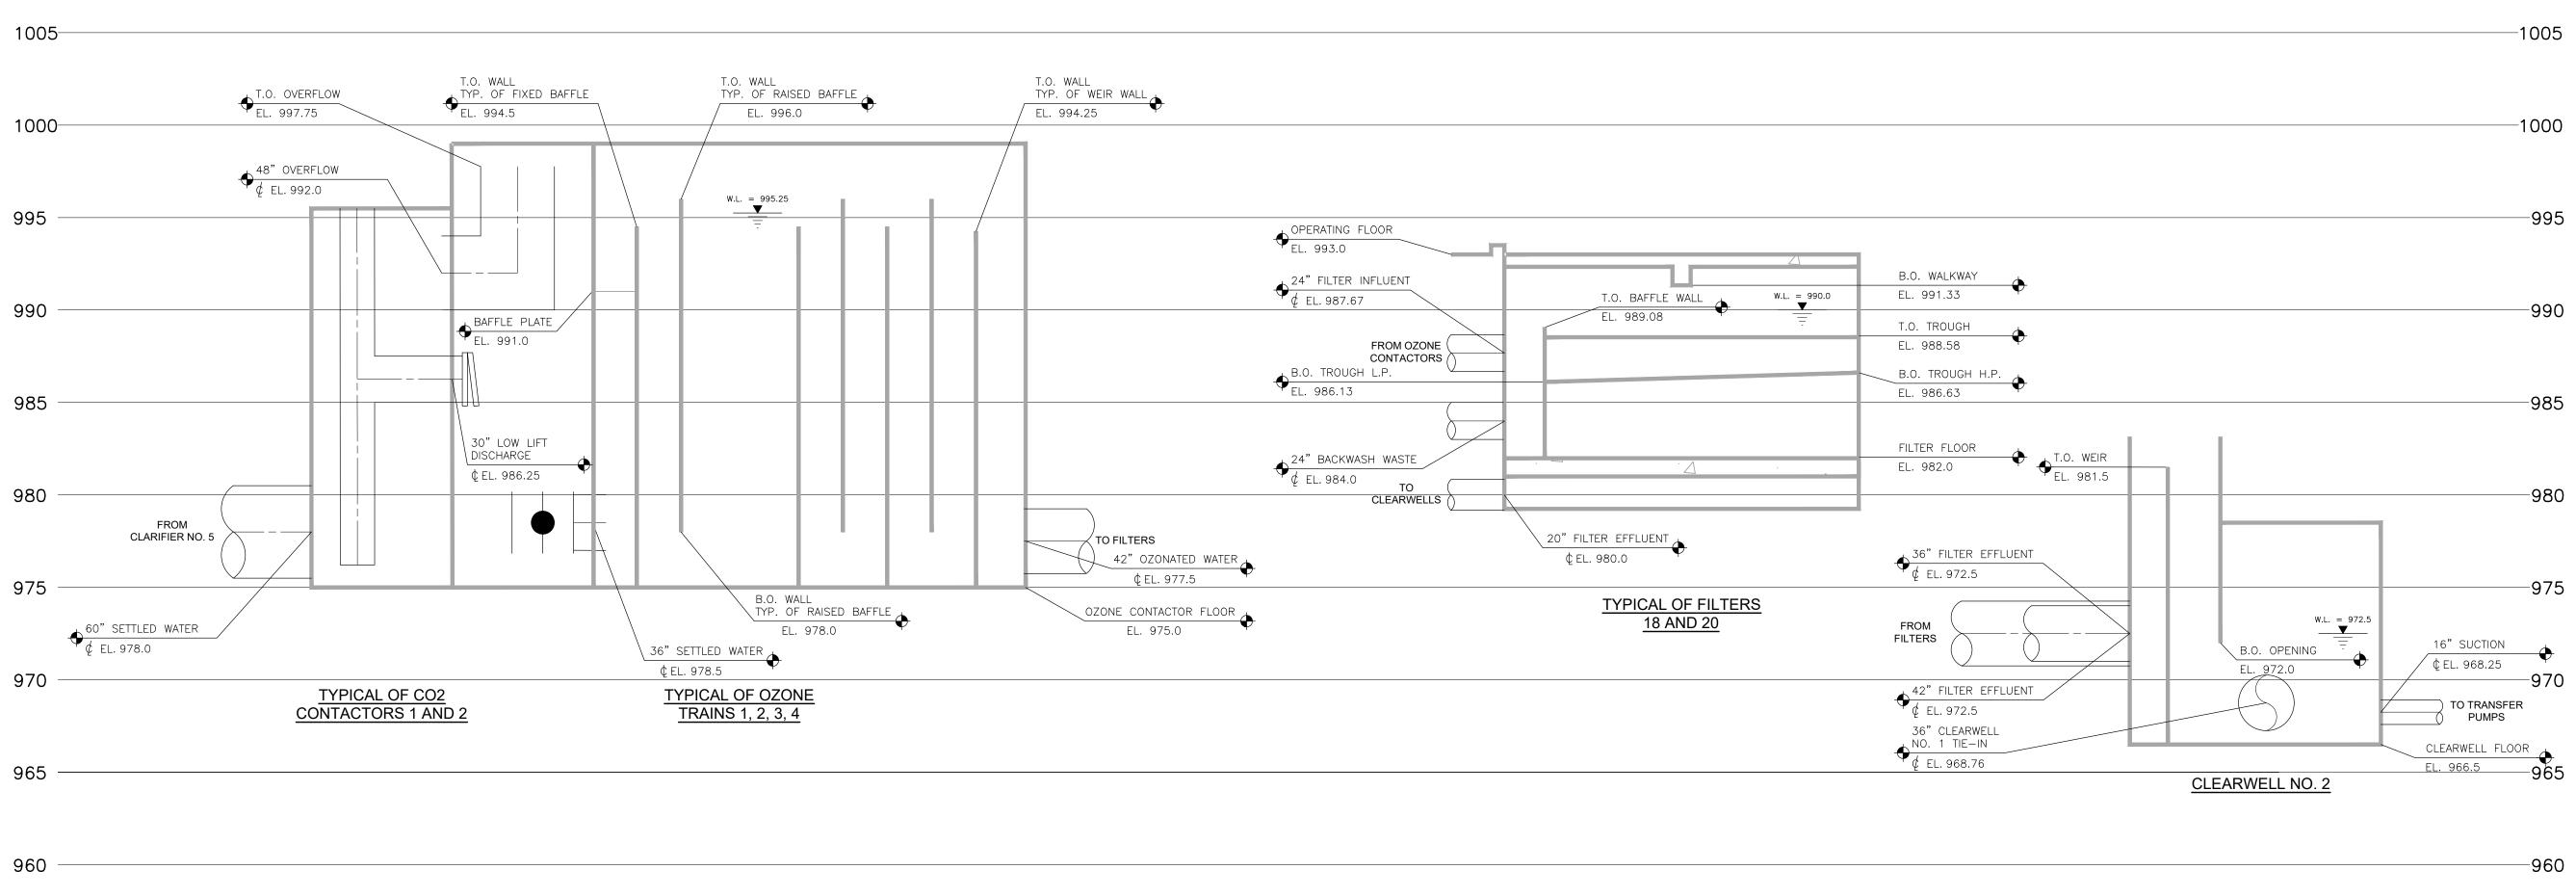

FILTER BUILDING MAIN BUILDING

HYDRAULIC PROFILE

SCALE: HORIZONTAL N.T.S VERTICAL 1" = 5'

OZONE BUILDING

2024 Water Treatment Plant r 18/20 Underdrain Improvements Arbor of City

Filte

REVISIONS

7/25/2024 BIDS AND CONSTRUCTION Drawn By ANW


Designer Reviewer MTP Manager BP

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PROCESS GENERAL NOTES

- 1. THE FOLLOWING NOTES APPLY TO ALL PROCESS SHEETS.
- 2. NOTES, SYMBOLS, LEGENDS AND ABBREVIATIONS SHOWN ON PROCESS DRAWINGS MAY NOT BE ALL INCLUSIVE, ONLY APPLY TO PROCESS DRAWINGS (P### SHEETS) AND, ALSO WHEN PRESENT, PROCESS DEMOLITION (D4## SHEETS).
- GRAPHICAL REPRESENTATION OF EXISTING SYSTEMS IS BASED ON PREVIOUS CONSTRUCTION AND/OR RECORD DRAWINGS AND MAY NOT FULLY REPRESENT EXISTING CONDITIONS, AND IS FOR REFERENCE ONLY. FIELD VERIFY EXISTING CONDITIONS TO DETERMINE EXTENT OF WORK.
- 4. FIELD VERIFY ALL DIMENSIONS SHOWN.

NOTES

- FILTER 18 AND FILTER 20 WALKWAY HIDDEN FROM FILTER GALLERY PLAN FOR CLARITY OF BACKWASH TROUGHS AND SURFACE WASH ARMS.
- FILTER 18 AND FILTER 20 MEDIA HIDDEN FROM PLANS FOR CLARITY.
- FILTER 18 BACKWASH TROUGHS HIDDEN FROM FILTER GALLERY PLAN FOR CLARITY OF SURFACE WASH ARMS.

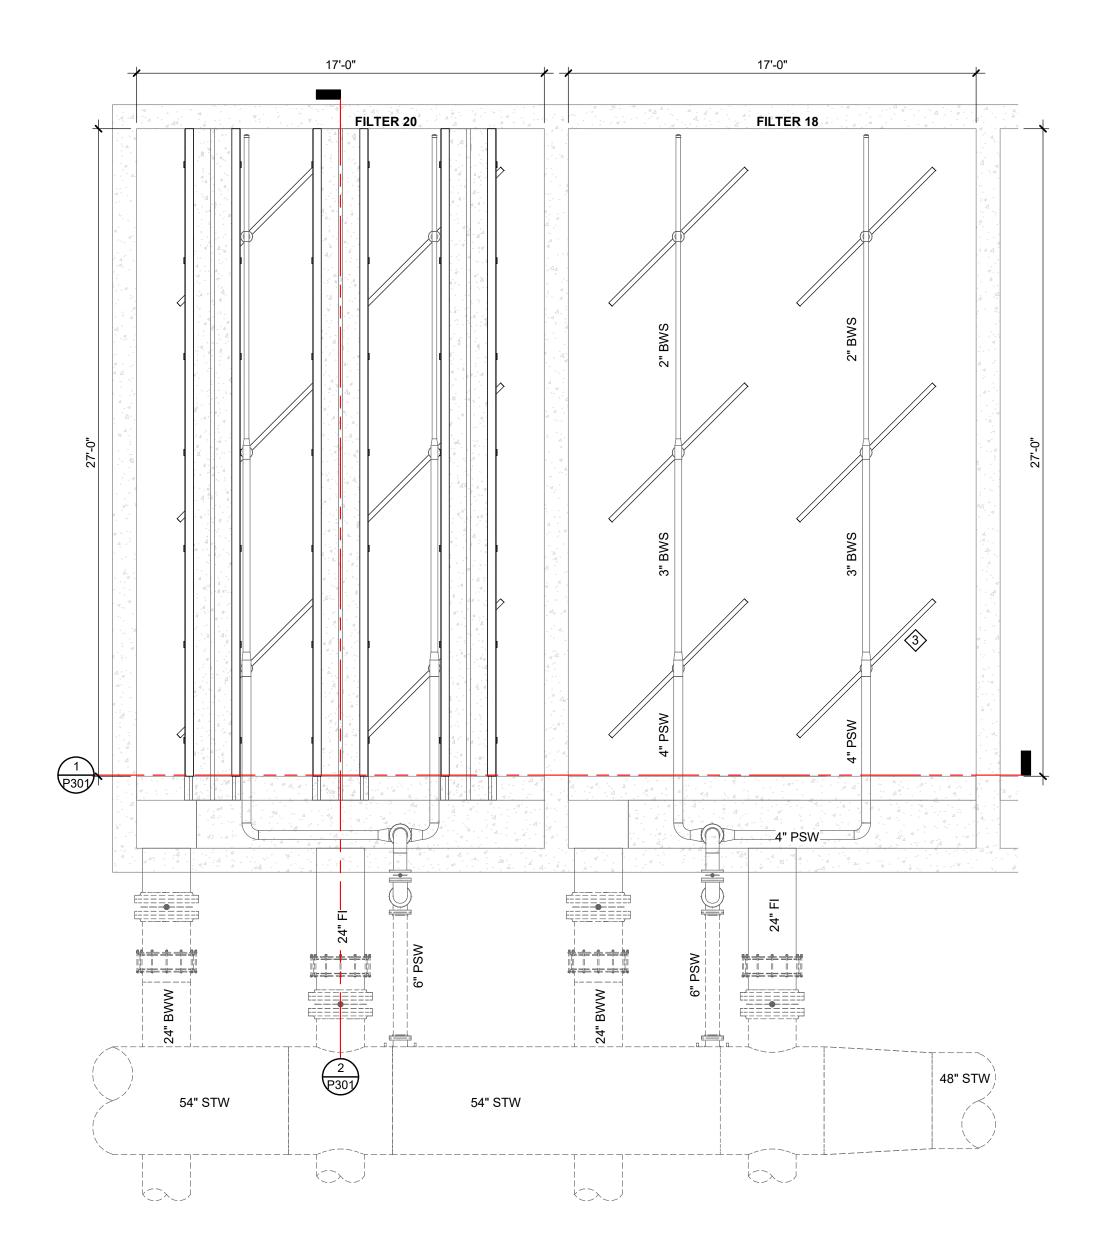- 1 INSTALL NEW SEAL WITHIN FW/BWS PIPE AND NEW GASKET AT WALL PLATE. SEE DETAIL. TYPICAL OF FILTER 18 AND FILTER 20.
- 2 REINSTALL FW/BWS PIPE, STEEL WALL PLATE, AND FLANGED COUPLING ADAPTER. TYPICAL OF FILTER 18 AND FILTER 20.
- 3 REINSTALL FW/BWS PIPE, STEEL WALL PLATE, AND FLANGED COUPLING ADAPTER. TYPICAL OF FILTER 18 AND FILTER 20.
- 4 INSTALL BLIND FLANGE AT WALL PIPE.
- 5 INSTALL 6" SS AIR SCOUR HEADER. PROVIDED BY FILTER UNDERDRAIN SUPPLIER.
- 6 INSTALL U-BOLT AIR SCOUR PIPE STAND. PROVIDED BY FILTER UNDERDRAIN SUPPLIER. (TYP)

City of Ann Arbo

Ann Arbor, M

2024 Water Treatment Plant Filter 18/20 Underdrain Improvements

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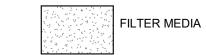
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SHEET NO.


P201



- 1 INSTALL NEW SEAL WITHIN FW/BWS PIPE AND NEW GASKET AT WALL PLATE. SEE DETAIL. TYPICAL OF FILTER 18 AND FILTER 20.
- 2 REINSTALL FW/BWS PIPE, STEEL WALL PLATE, AND FLANGED COUPLING ADAPTER. TYPICAL OF FILTER 18 AND FILTER 20. 3 FILTER GAC TO BE FURNISHED AND INSTALLED BY FILTER
- GAC SUPPLIER. TYPICAL OF FILTER 18 AND FILTER 20. 4 REINSTALL SURFACE WASH ARMS. TYPICAL OF 6 PER
- FILTER. TYPICAL OF FILTER 18 AND FILTER 20. 5 INSTALL UNDERDRAIN LATERALS. SEE DETAILS.
- INSTALL MEDIA RETENTION BAFFLE. SEE DETAIL. INSTALL 6" SS AIR SCOUR HEADER. PROVIDED BY FILTER
- UNDERDRAIN SUPPLIER. 8 INSTALL BLIND FLANGE AT WALL PIPE.
- 9 INSTALL U-BOLT AIR SCOUR PIPE STAND. PROVIDED BY FILTER UNDERDRAIN SUPPLIER. (TYP)

30'-0" FILTER GALLERY 993' - 0" T.O. BAFFLE EL. 988' - 10 1/2" 4" PSW EL. 989' - 3 1/2" 3" PSW 2" PSW T.O. TROUGH

EL. 988' - 6 1/2" 24" FI
EL. 987' - 8"
B.O. TROUGH L.P.
EL. 986' - 1 1/2" B.O. TROUGH H.P. EL. 986' - 7 1/2" 24" BWW EL. 984' - 0" 20" BWS/FE EL. 980' - 0" PIPE GALLERY 970' - 3"

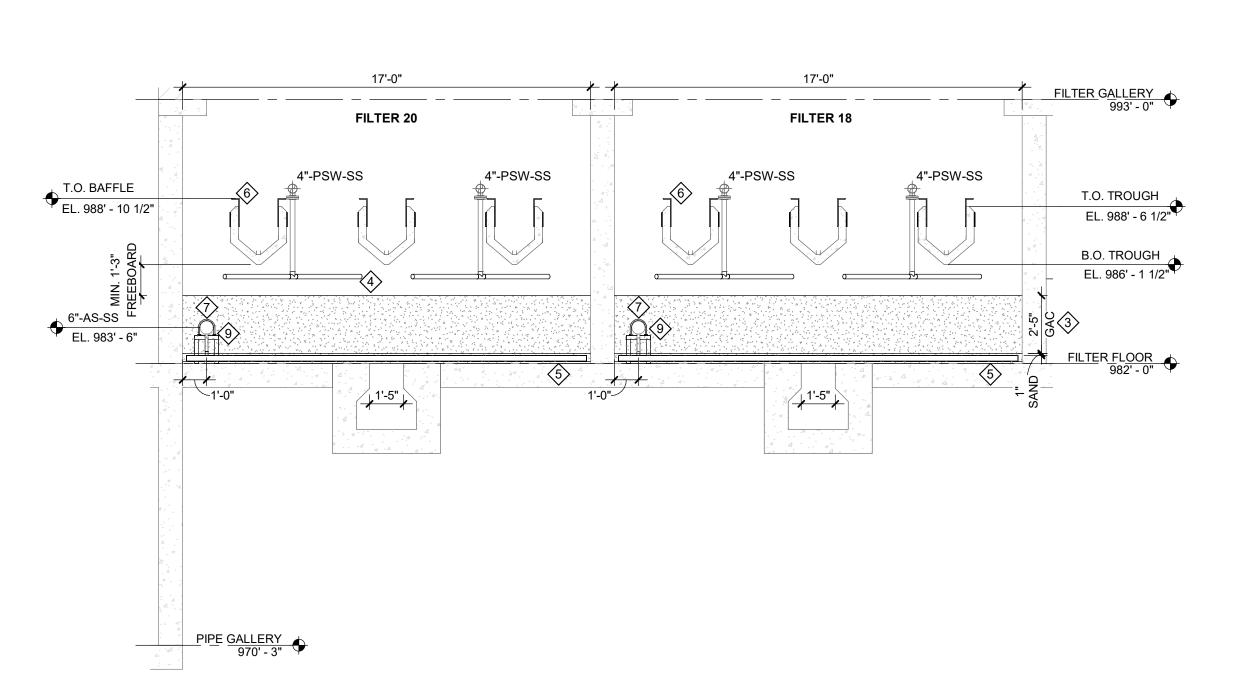

FILTER 20
SECTION

SCALE: 1/4" = 1'-0"

FILTER 18 AND 20 SECTION

SCALE: 1/4" = 1'-0"

REVISIONS

202² Filter 18/

7/25/2024 BIDS AND CONSTRUCTION

Drawn By RS2 Designer ANW Reviewer MTP


Manager BP Hard copy is intended to be 24"x36" when plotted. Scale(s) indicated and graphic quality may not be accurate for any other size.

> PROJECT NO. 231370

SHEET NO.

P301

FILTER UNDERDRAIN GROUT DETAIL NO SCALE NOTE: PROVIDE LEVEL GROUT STRIP, MINIMUM THICKNESS OF 1/2"

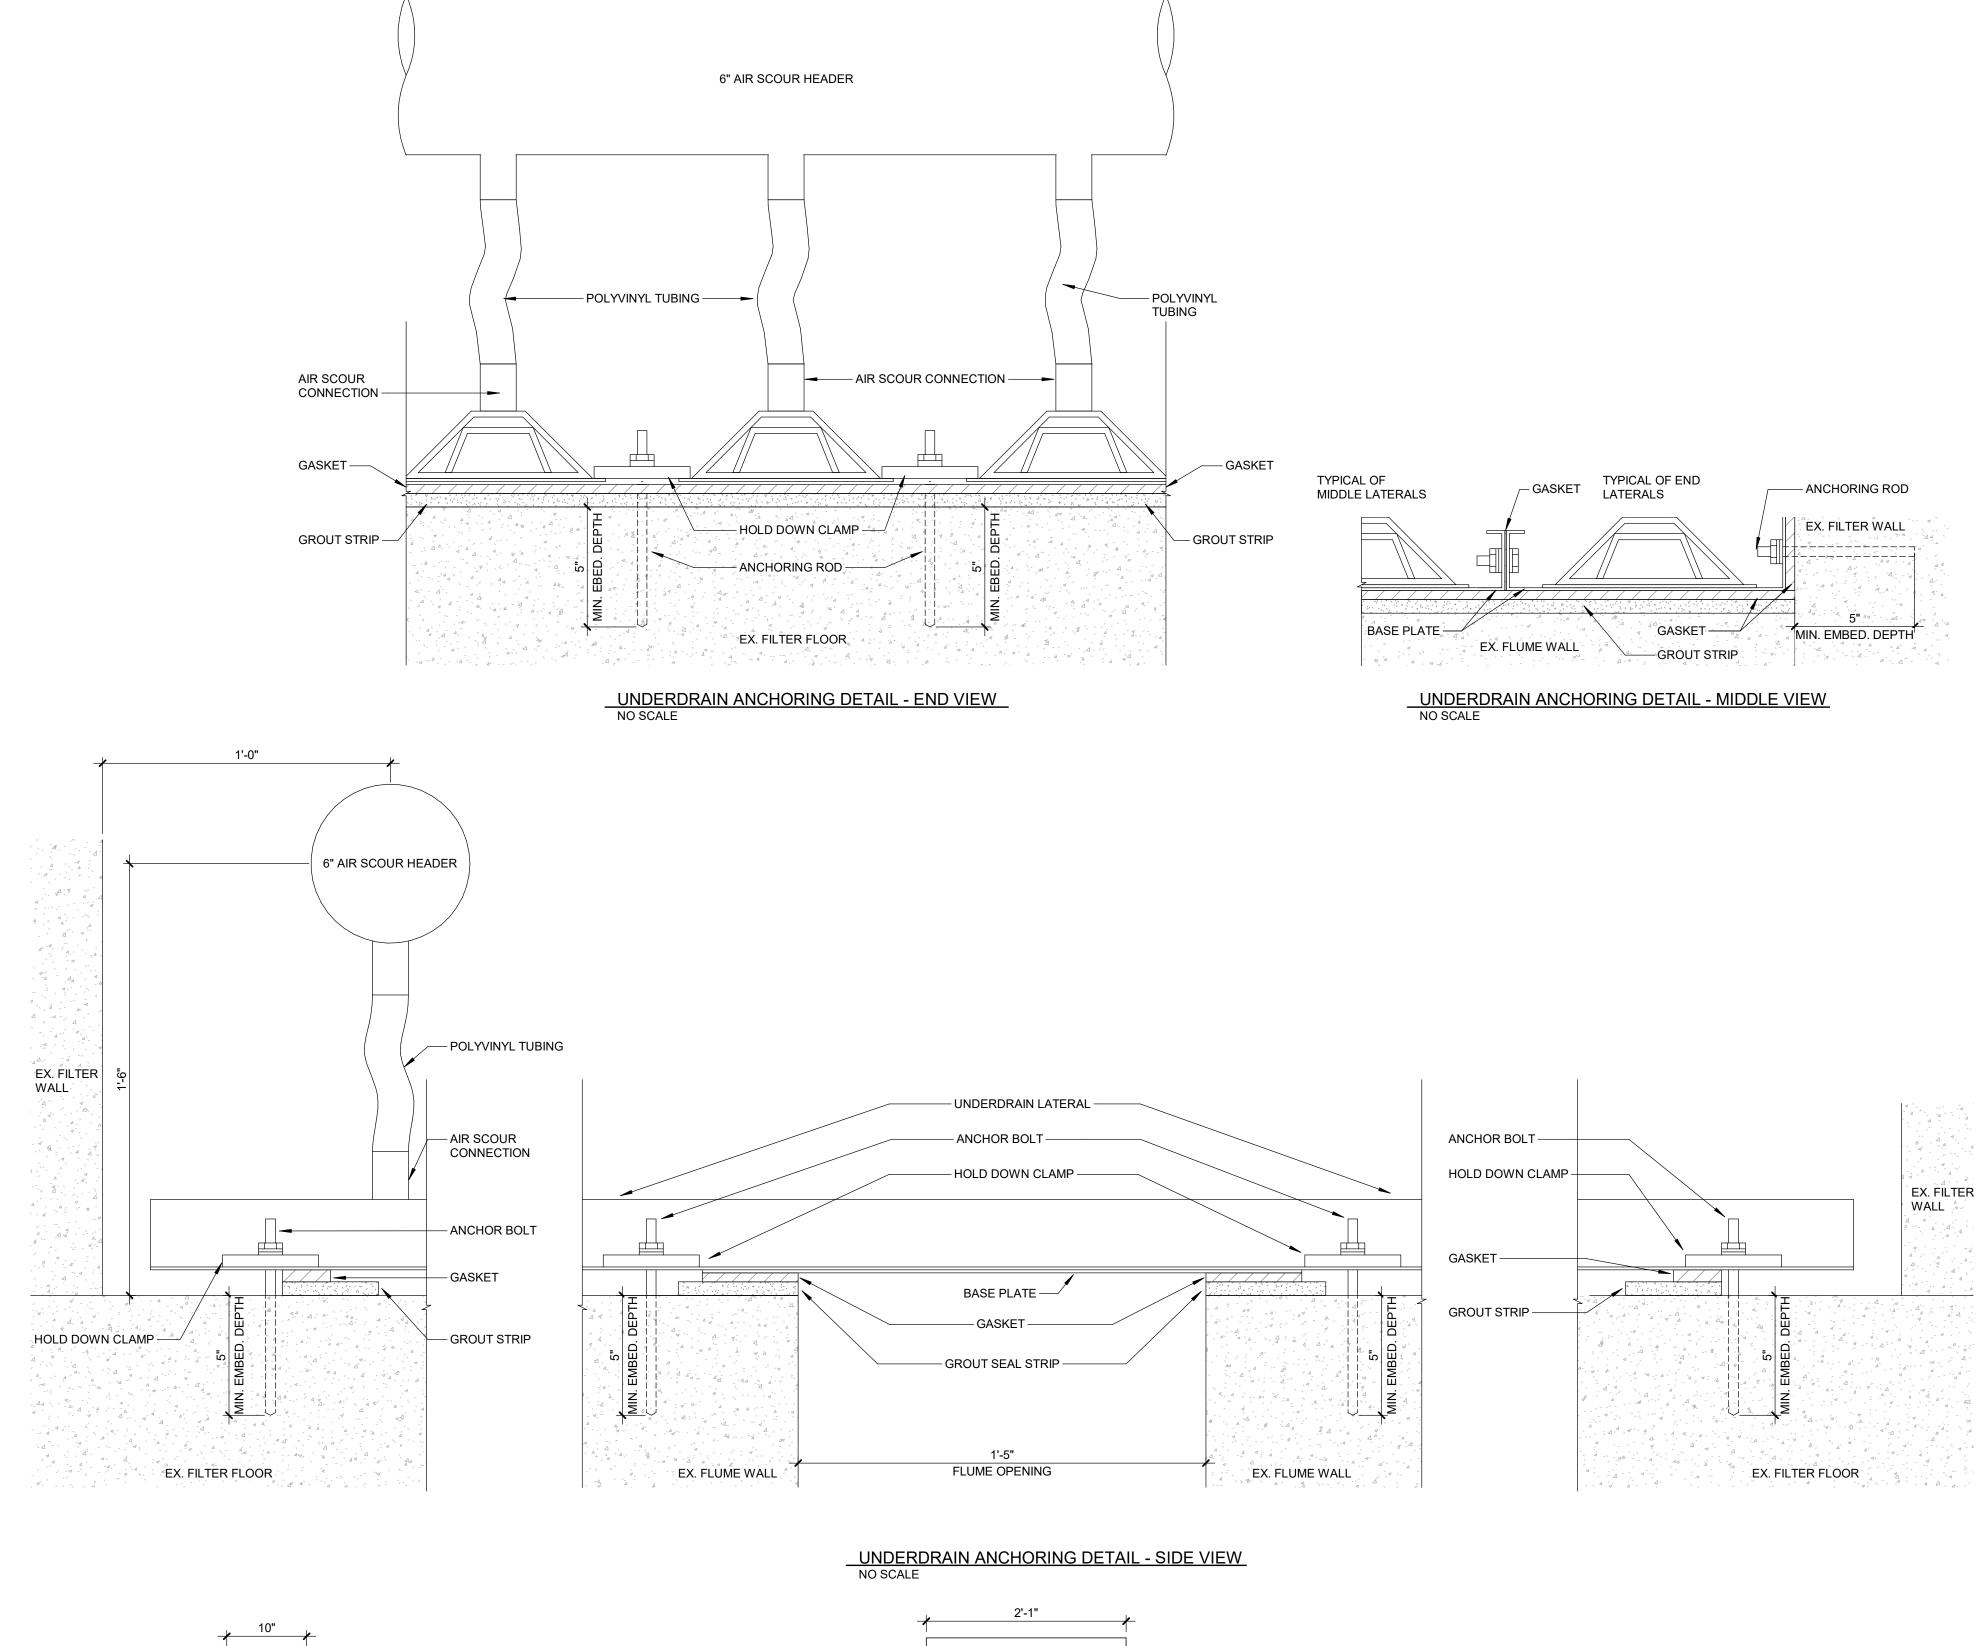

— BASE PLATE

UNDERDRAIN PLAN VIEW DETAIL NO SCALE

AIR CONNECTION

- UNDERDRAIN LATERAL

2024 Water Treatment Plant Filter 18/20 Underdrain Improvements

REVISIONS

7/25/2024 BIDS AND CONSTRUCTION


Drawn By RS2 Designer ANW Reviewer MTP

Manager BP


Hard copy is intended to be 24"x36" when plotted. Scale(s) indicated and graphic quality may not be accurate for any other size.

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SHEET NO.

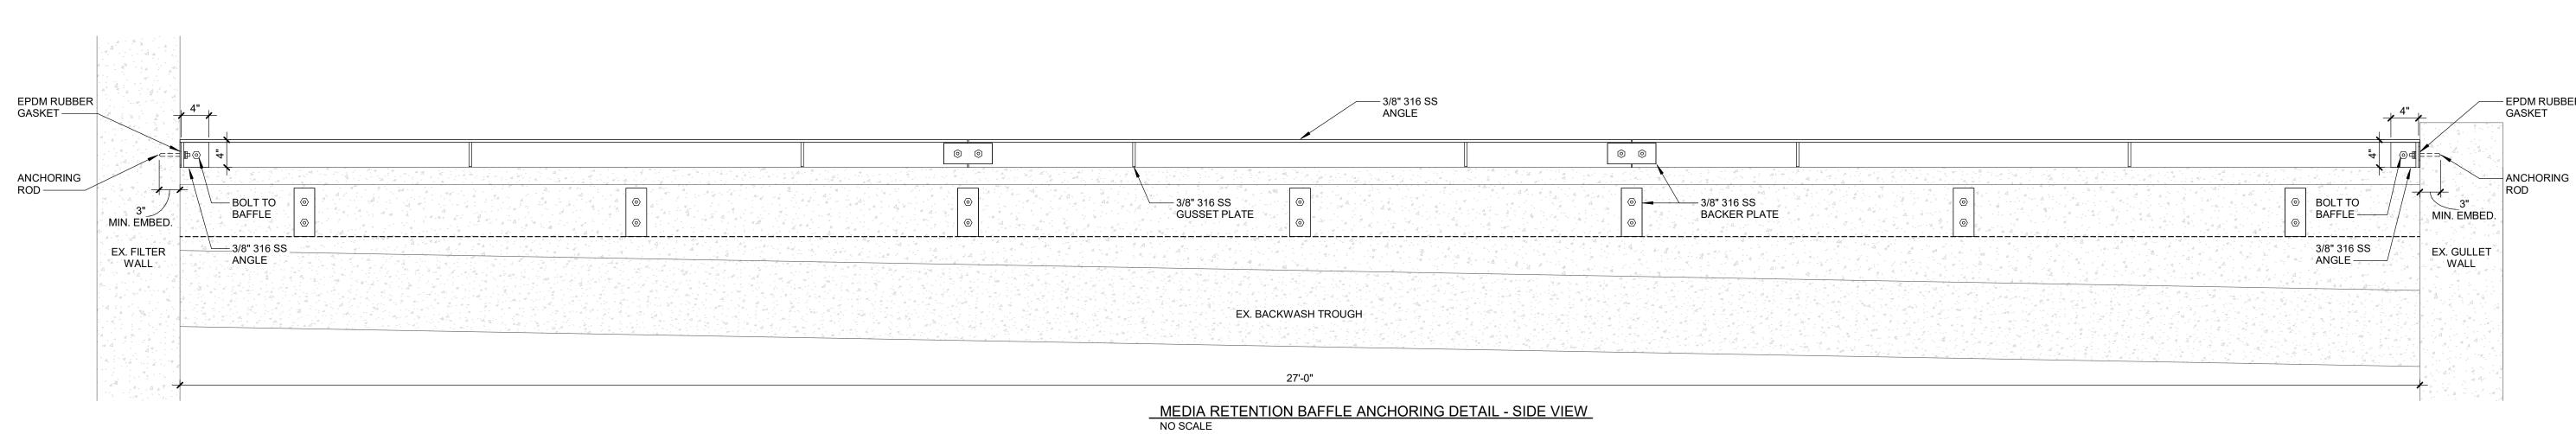

NOTES: TYPICAL OF (3) BACKWASH TROUGHS PER FILTER

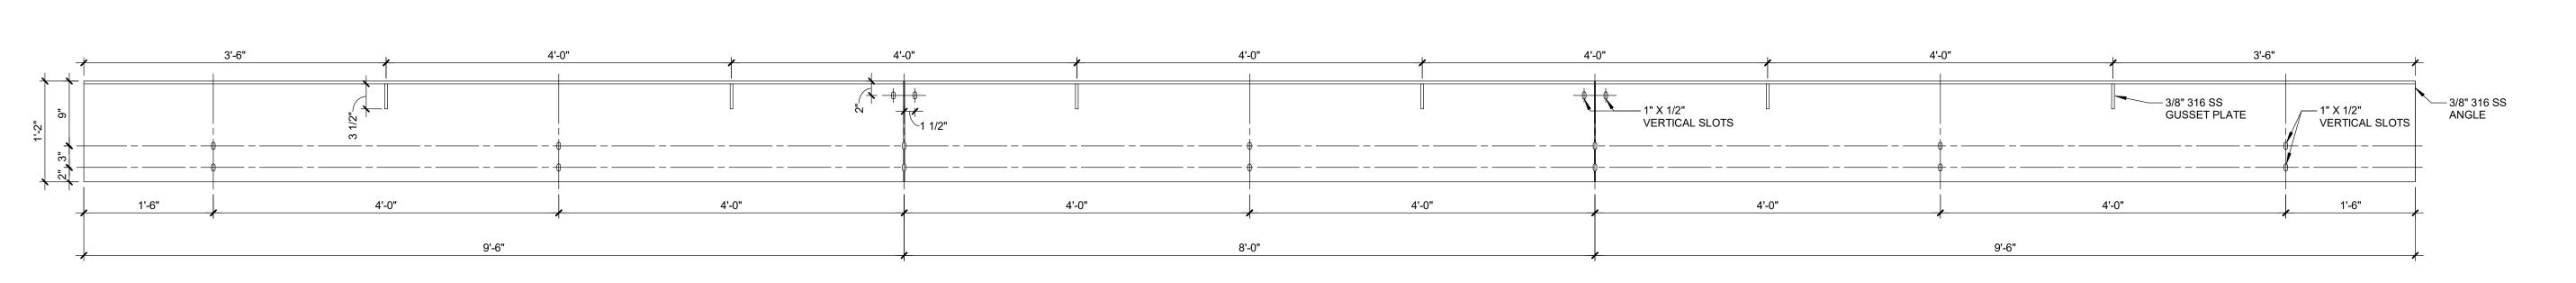

MEDIA RETENTION BAFFLE DETAIL - SIDE VIEW NO SCALE

NOTES: TYPICAL OF (6) BAFFLES PER FILTER

DETAIL IS MEANT TO ILLUSTRATE MINIMUM DESIGN INTENT. IT IS THE RESPONSIBILITY OF THE SUPPLIER TO COMPLETE THE DESIGN AND SUBMIT FABRICATION LEVEL SHOP DRAWINGS.

Arbor

202² Filter 18/

Vater Treatment Plant Underdrain Improvements

0

REVISIONS

7/25/2024 BIDS AND CONSTRUCTION Drawn By ANW

Designer ANW Reviewer Checker Manager BP

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