# City of Ann Arbor 2024 Water Treatment Plant Filter 18/20 Underdrain Improvement Ann Arbor, Michigan

Issued for Bids and Construction June 3, 2024



Project Number: 231370 RFP Number: 24-38 C2R2 Project Number: C2A-018

fishbeck.com 800.456.3824

1515 Arboretum Drive, Grand Rapids, Michigan

# GENERAL

G101 COVER SHEET G102 SITE LAYOUT

### DEMOLITION

D401 PROCESS PLANS AND SECTIONS D402 PROCESS PHOTOS

### PROCESS

- P001 GENERAL ABBREVIATIONS, SCHEDULE, AND DETAILS
- P101 HYDRAULIC PROFILE P201 FILTER PLANS
- P301 SECTIONS
- P401 PROJECT DETAILS P402 PROJECT DETAILS

GENERAL ABB	REVIATIONS
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ACM AFF AHU AL BF CJ CL CW CLG CMU CO CONC CONC CONST CONT DIA DN DS	CONTROL JOINT CENTERLINE CURTAINWALL CEILING CONCRETE MASONRY UNIT CLEANOUT CONCRETE

EF EL EJ EQ EWC FD FRT	EXHAUST FAN ELEVATION EXPANSION JOINT EQUAL ELECTRIC WATER COOLER FLOOR DRAIN FIRE RETARDANT TREATED
FT GA	FOOT/FEET GUAGE/GAGE
GALV	GALVANIZED
GC	GENERAL CONTRACTOR
HB HP	HOSE BIBB HIGH POINT
HORIZ	
HVAC	HEATING VENTILATING AIR
ID IE IMP	CONDITIONING INSIDE DIAMETER INVERT ELEVATION INSULATED METAL PANEL

IN	INCH/INCHES
INSUL	INSULATION
LAV	LAVATORY
LED	LIGHT EMITTING DIODE
LLH	LONG LEG HORIZONTAL
LLV	LONG LEG VERTICAL
LP	LOW POINT
MFR	MANUFACTURER
MAX	MAXIMUM
MEZZ	MEZZANINE
MIN	MINIMUM
MO	MASONRY OPENING
MTD	MOUNTED
N/A	NOT APPLICABLE
NC	NOISE CRITERIA
NIC	NOT IN CONTRACT
NO	NUMBER
	INSUL LAV LED LLH LLV LP MFR MAX MEZZ MIN MO MTD N/A NC NIC

NRC	NOISE REDUCTION
	COEFFICIENT
NTS	NOT TO SCALE
OC	ON CENTER
OD	OUTSIDE DIAMETER
ОН	OVERHEAD
OPP	OPPOSITE
ORD	OVERFLOW ROOF DRAIN
OS	OUTSIDE
PERP	PERPENDICULAR
PL	PLATE
PSF	POUNDS PER SQUARE FOOT
PSI	POUNDS PER SQUARE INCH
PVC	POLYVINYL CHLORIDE
R	RADIUS
REQD	REQUIRED
RD	ROOF DRAIN
SCH	SCHEDULE
SF	SQUARE FOOT

SIM


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SQ


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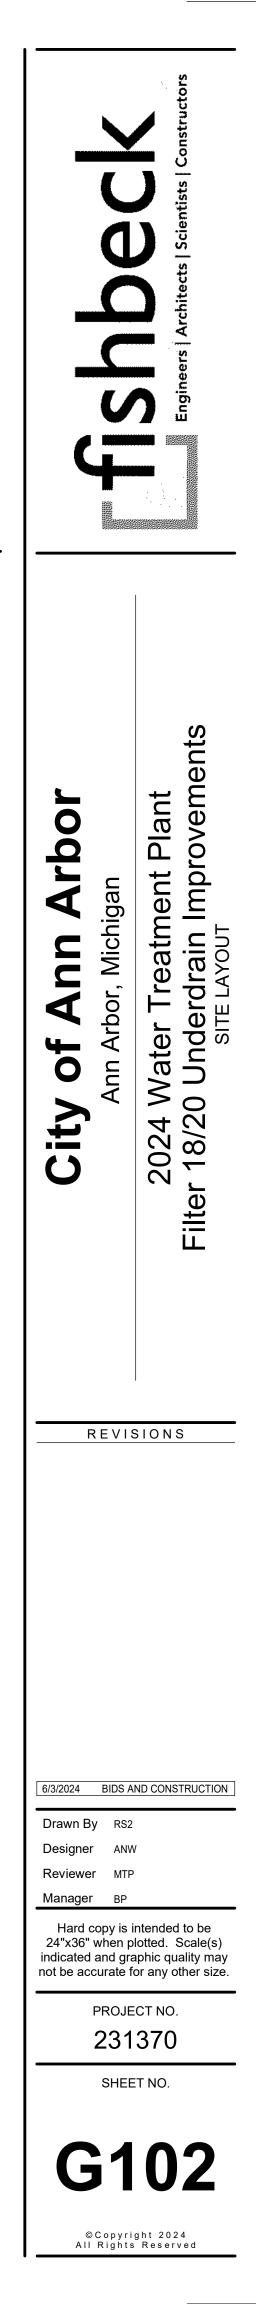
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M 14 CO Domeno's Plants US 23 The					City of Ann Arbor Ann Arbor, Michidan	2024 Water Treatment Plant Filter 18/20 Underdrain Improvements
E TAG		SEAL			6/3/2024BIDDrawn ByRDesignerAReviewerMManagerBHard copy24"x36" wherindicated and	S AND CONSTRUCTION SS2 NW TTP P is intended to be n plotted. Scale(s) graphic quality may e for any other size.
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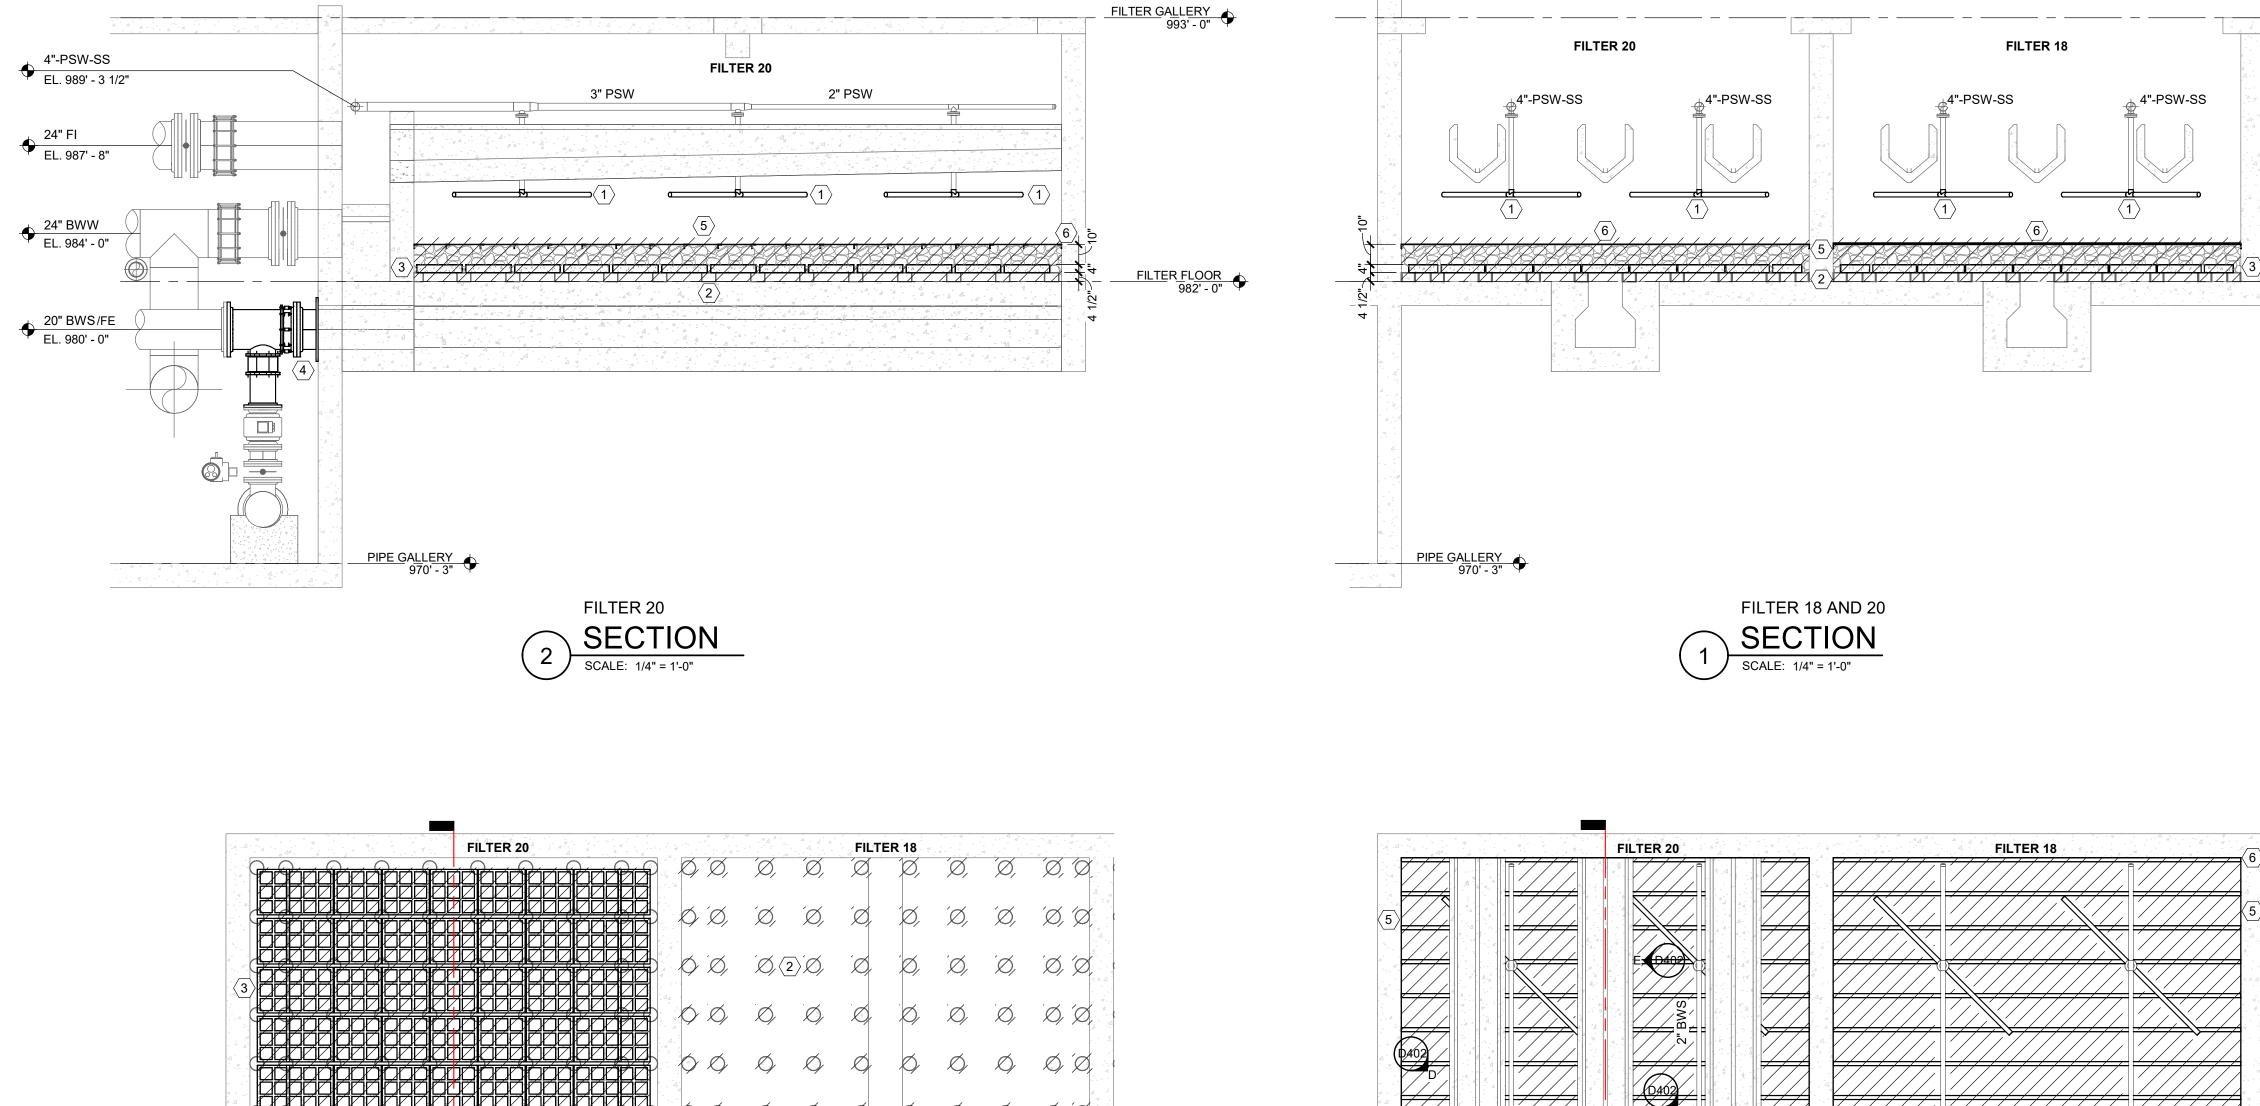





# SYMBOLS LEGEND

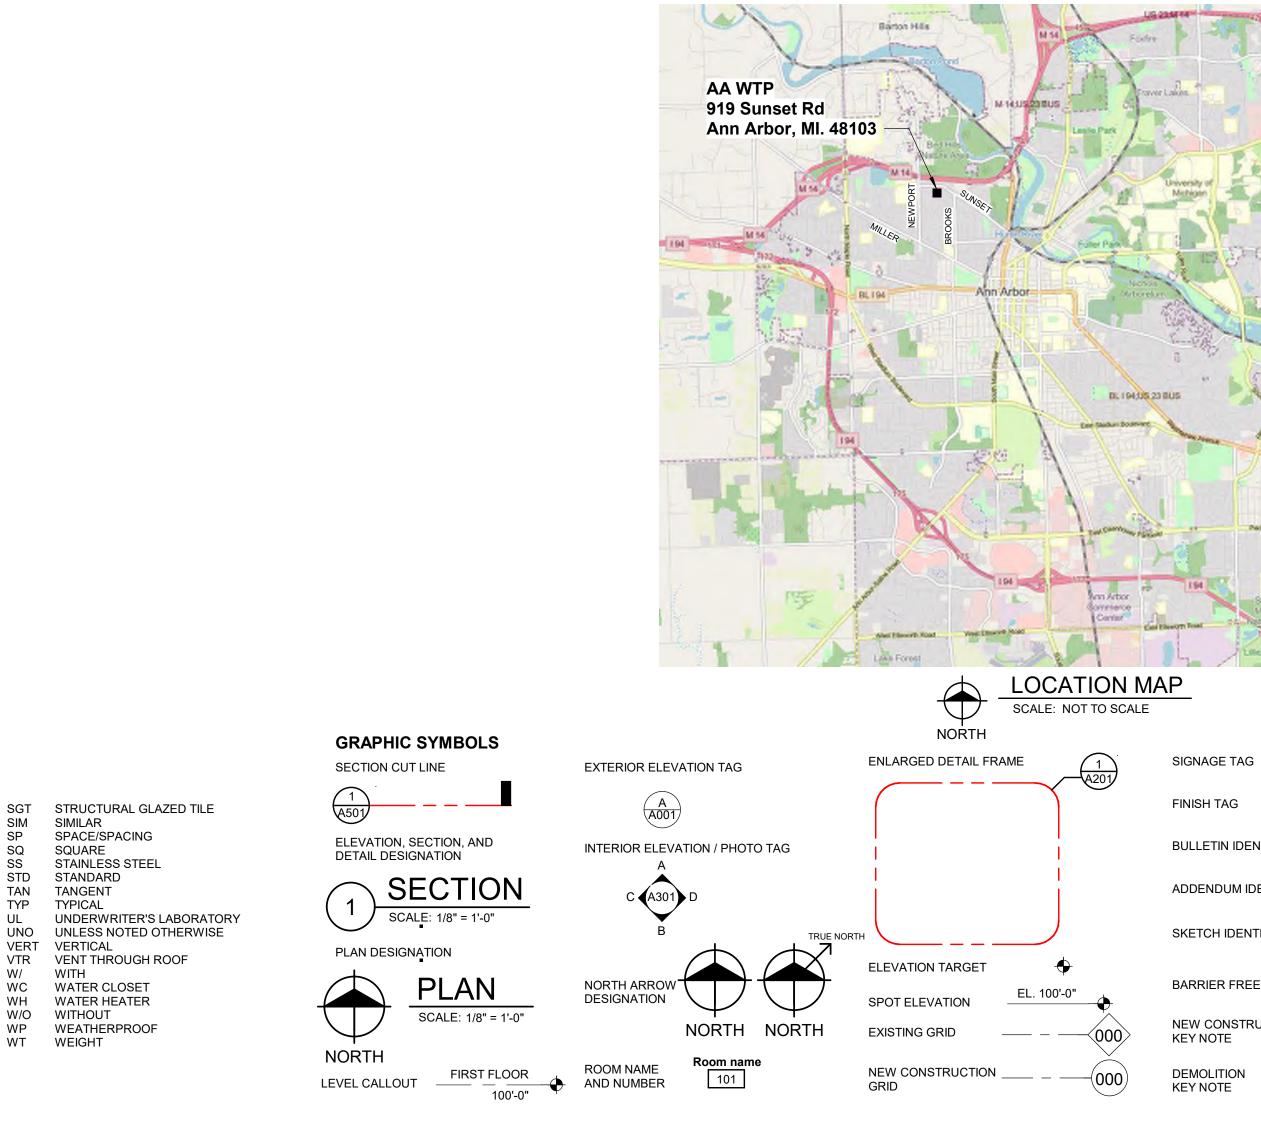

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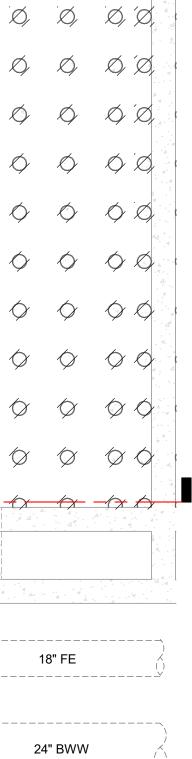


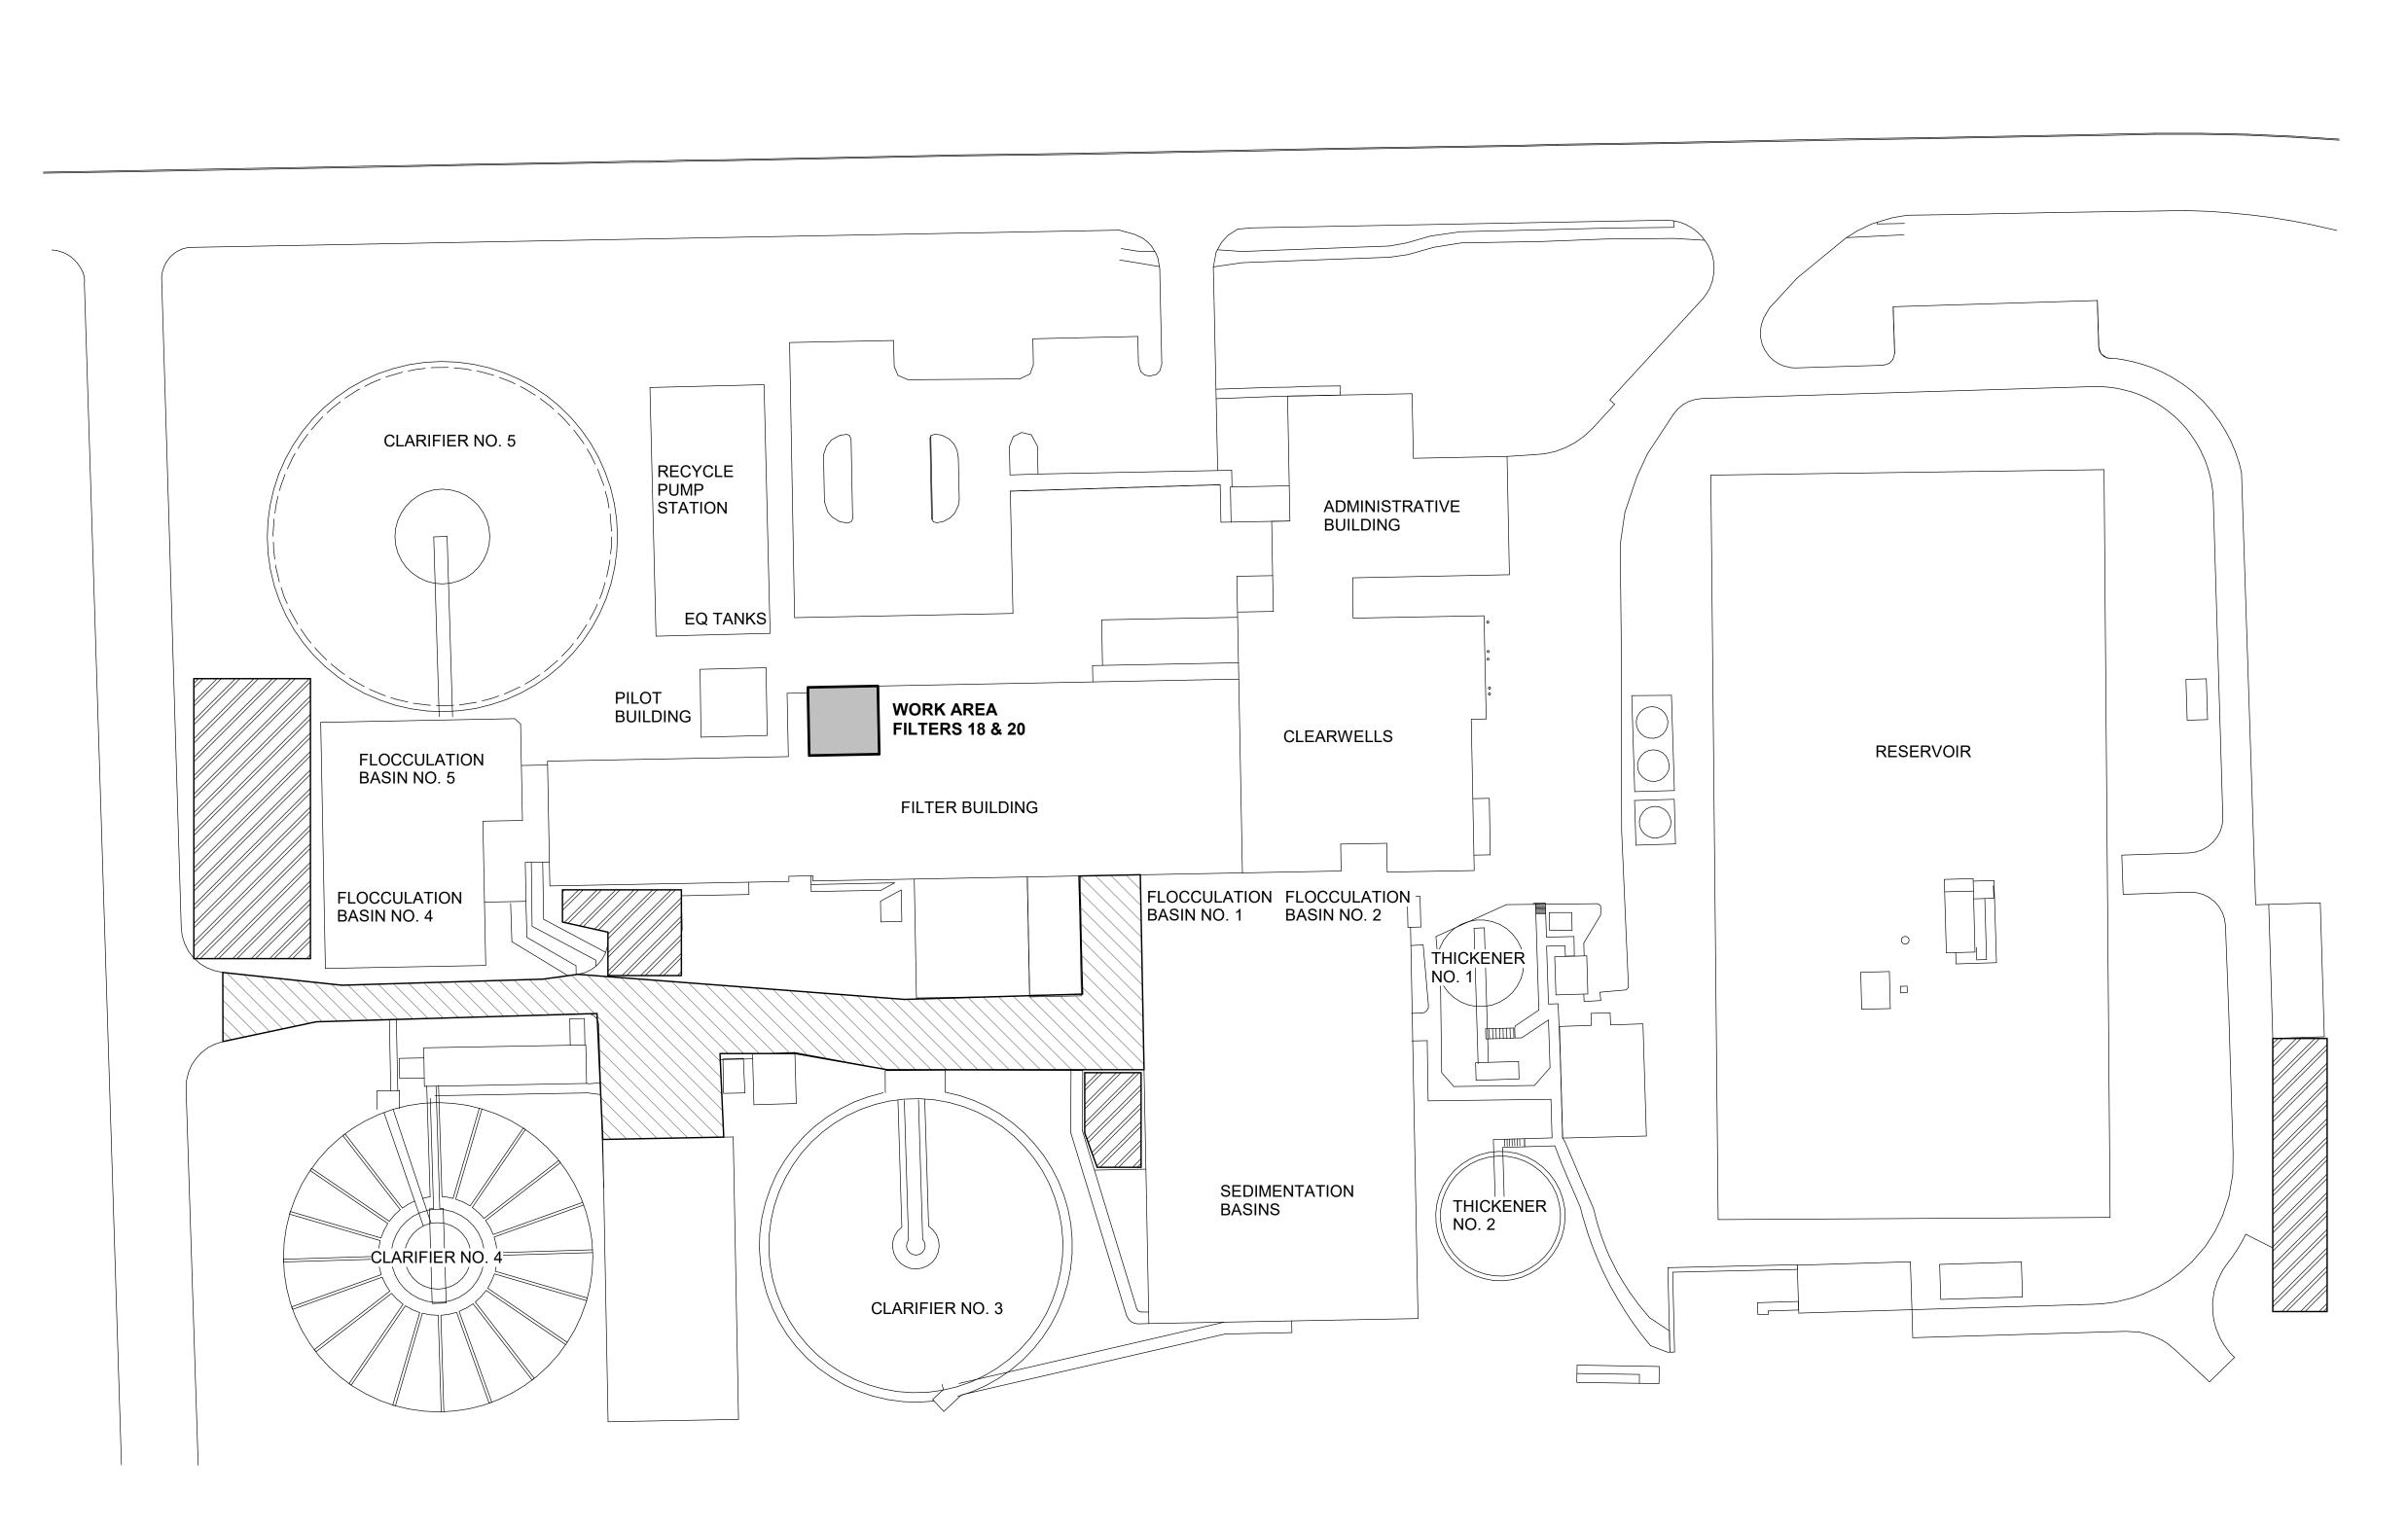FILTER 18 AND 20

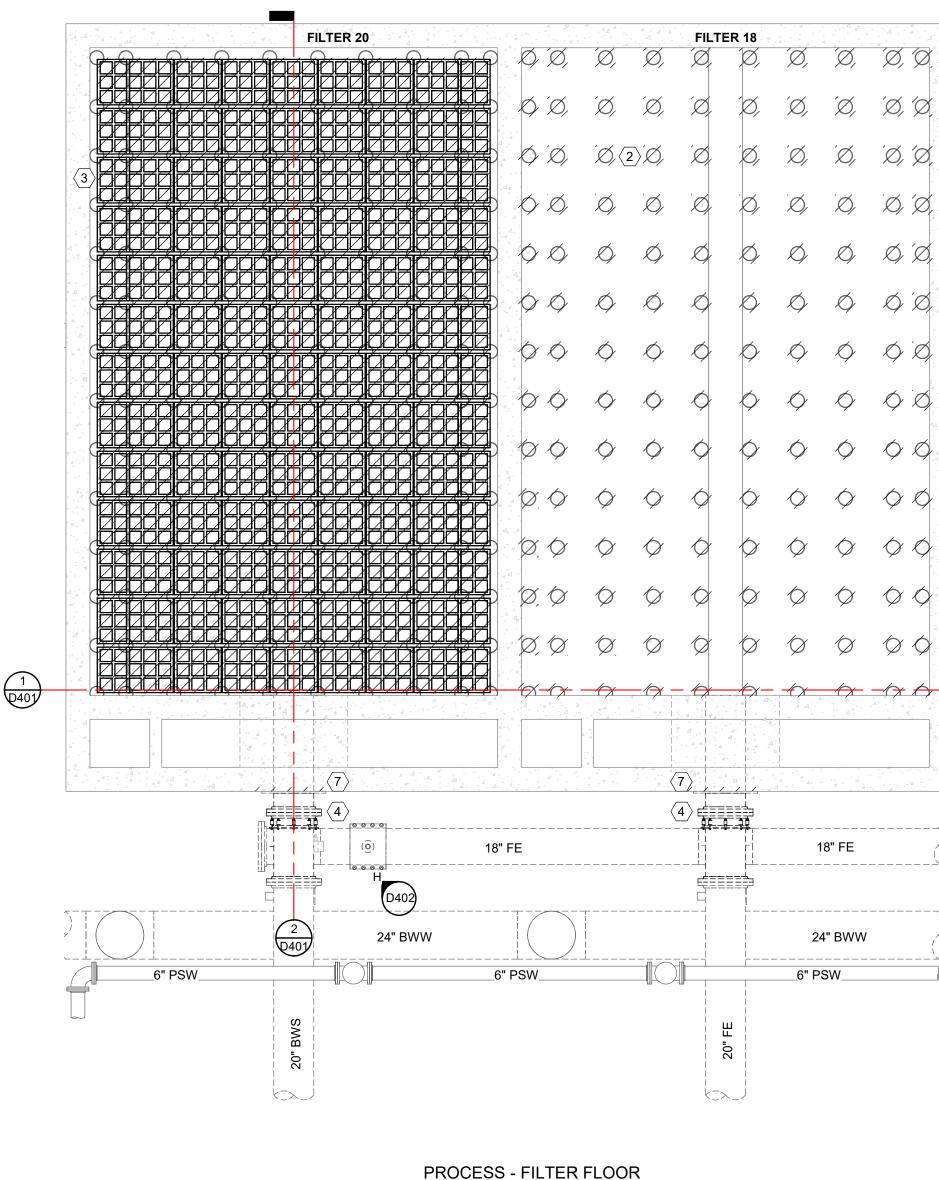
SCALE: 1/4" = 1'-0"

NORTH

**DEMOLITION PLAN** 




\_6" PSW\_

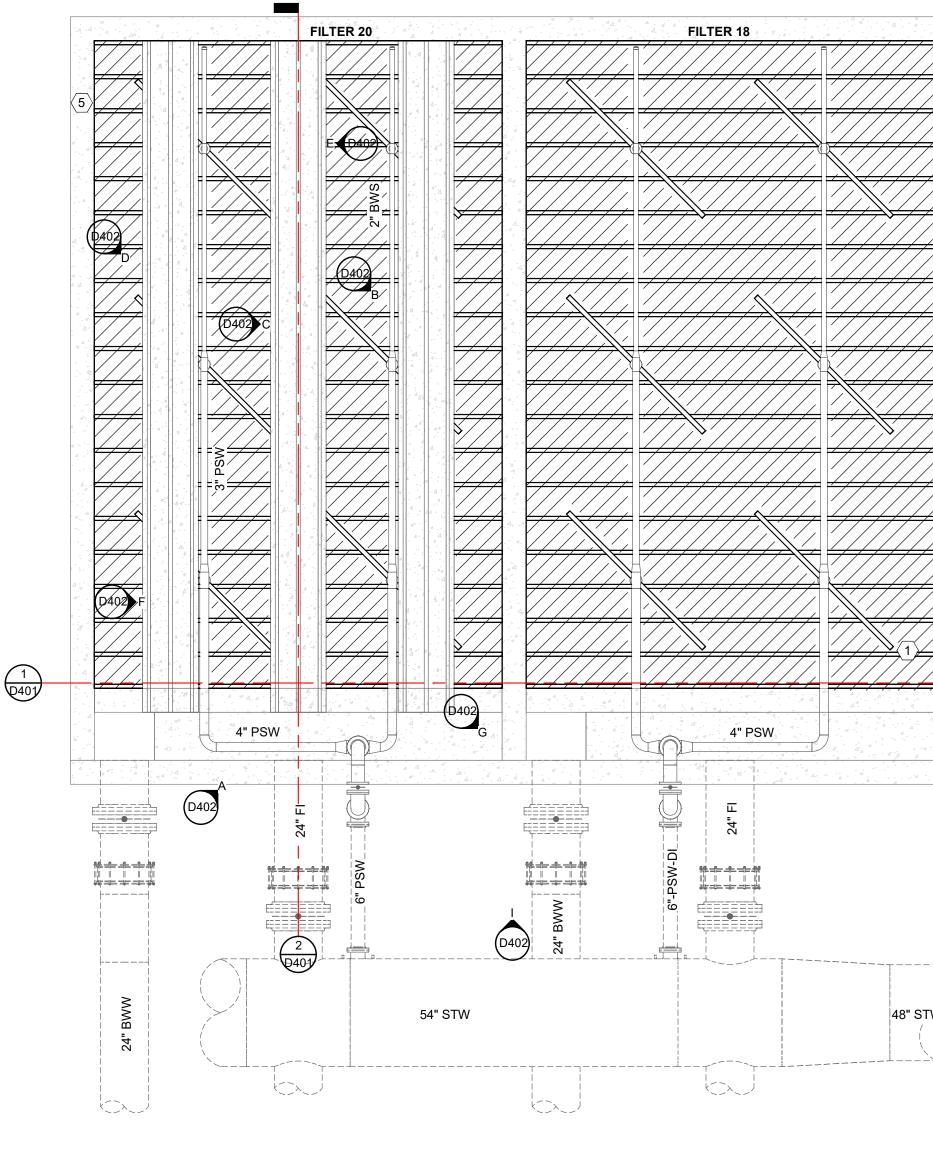


PROCESS - FILTER GALLERY FILTER 18 AND 20 **DEMOLITION PLAN** SCALE: 1/4" = 1'-0"

NORTH

48" STW

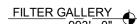

SYMBOLS LEGEND

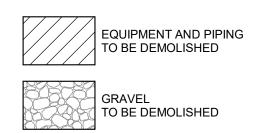



#### PROCESS DEMOLITION NOTES

- 1. REMOVE ALL PORTIONS OF WORK IDENTIFIED BY CROSS HATCHING UNLESS NOTED OTHERWISE.
- 2. DEMOLITION NOTES AND PLANS DO NOT FULLY REPRESENT ALL DEMOLITION WORK REQUIRED TO INSTALL NEW WORK IN ACCORDANCE WITH CONTRACT DOCUMENTS. BUT ARE INTENDED TO SERVE AS GENERAL DEMOLITION GUIDELINES.
- 3. GRAPHICAL REPRESENTATION OF EXISTING SYSTEMS WERE OBTAINED FROM PREVIOUS CONSTRUCTION AND/OR RECORD DRAWINGS MAY NOT FULLY REPRESENT EXISTING CONDITIONS AND IS FOR REFERENCE ONLY. CONTRACTOR TO FIELD VERIFY EXISTING CONDITIONS TO DETERMINE EXTENT OF WORK.
- 4. COORDINATE PHASING AND SEQUENCING OF DEMOLITION IN ACCORDANCE WITH PLANS AND SPECIFICATIONS AND WITH OTHER CONTRACTORS IN ORDER TO MAINTAIN CONTINUING OPERATIONS FOR OWNER. ALSO, TO MAINTAIN BUILDING SECURITY AND WEATHER TIGHTNESS.
- 5. COORDINATE ITEMS, IF ANY TO BE TURNED OVER TO THE OWNER PRIOR TO BEGINNING DEMOLITION. CONTRACTOR TO REMOVE, PROTECT AND RELOCATE ITEMS TO BE TURNED OVER TO THE OWNER.


#### NOTES

- 1. FILTER 18 AND FILTER 20 WALKWAY HIDDEN FROM FILTER GALLERY PLAN FOR CLARITY OF BACKWASH TROUGHS AND SURFACE WASH ARMS.
- 2. FILTER 18 BACKWASH TROUGHS HIDDEN FROM FILTER GALLERY PLAN FOR CLARITY OF SURFACE WASH ARMS
- 3. FILTER 18 UNDERDRAIN MODULES HIDDEN FROM FILTER FLOOR PLAN FOR CLARITY OF CONCRETE SUPPORT COLUMNS.

#### **(#)** DEMOLITION KEY NOTES

- 1 REMOVE, SERVICE, AND REINSTALL SURFACE WASH ARMS. TYPICAL OF 6 PER FILTER. TYPICAL OF FILTER 18 AND FILTER 20.
- 2 DEMOLISH CONCRETE SUPPORT COLUMNS (7" D X 4.5" H) ON FILTER FLOOR. TYPICAL OF FILTER 18 AND FILTER 20.
- 3 DEMOLISH UNDERDRAIN MODULES, INCLUDING CONCRETE BLOCKS AND CERAMIC SPHERES. TYPICAL OF FILTER 18 AND FILTER 20. 4 REMOVE, PAINT, AND REINSTALL FW/BWS PIPE, STEEL
- WALL PLATE, AND FITTINGS. TYPICAL OF FILTER 18 AND FILTER 20.
- 5 DEMOLISH GRAVEL AND STAINLESS STEEL #8 MESH RETAINING SCREEN. TYPICAL OF FILTER 18 AND FILTER 20. GRAVEL HIDDEN IN PLAN VIEW FOR CLARITY.
- 6 DEMOLISH STEEL HOLD-DOWN STRAPS AND ANGLES. 7 RESTORE CONCRETE AT WALL PLATE. SEE DETAIL.

	Engineers   Architects   Scientists   Constructor
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24"x36" when plotted. Scale(s) indicated and graphic quality may not be accurate for any other size.
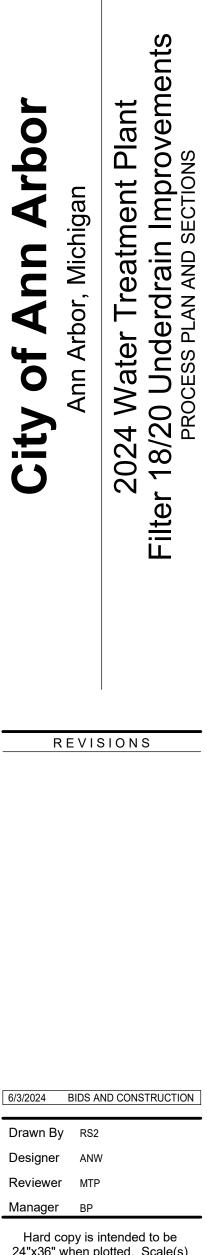
#### PROJECT NO. 231370

SHEET NO.

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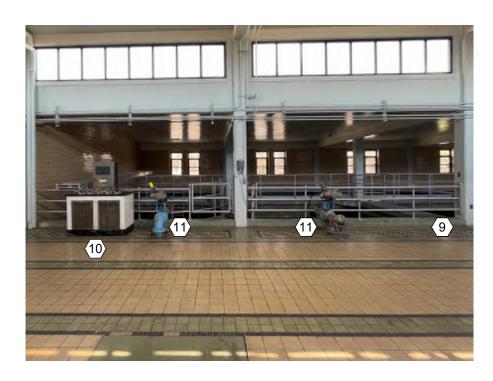




























SYMBOLS LEGEND




### **(#)** DEMOLITION KEY NOTES

- REMOVE, SERVICE, AND REINSTALL SURFACE WASH ARMS. TYPICAL OF 6 PER FILTER. TYPICAL OF FILTER 18 AND FILTER 20.
- 2 PROTECT SURROUNDING INSTRUMENTATION, ETC.
- 3 REMOVE, PAINT, AND REINSTALL FW/BWS PIPE, STEEL WALL PLATE, AND FITTINGS. TYPICAL OF FILTER 18 AND FILTER 20. 4 DEMOLISH STEEL HOLD-DOWN STRAPS AND ANGLES.
- 5 DEMOLISH GRAVEL AND STAINLESS STEEL #8 MESH RETAINING SCREEN. TYPICAL OF FILTER 18 AND FILTER 20. GRAVEL HIDDEN IN PLAN VIEW FOR CLARITY.
- 6 REPAIR BACKWASH TROUGH CONCRETE. SEE CONCRETE RESTORATION DETAIL.
- 7 RESTORE CONCRETE AT WALL PLATE. SEE DETAIL.
- 8 RESTORE CONCRETE AT FILTER WALL. SEE DETAIL. 9 REMOVE, STORE, AND REINSTALL RAILING AS NEEDED.
- 10 PROTECT FILTER CONTROL CONSOLE.
- 11 PROTEXT EXISTING PIPING, VALVES, ETC.






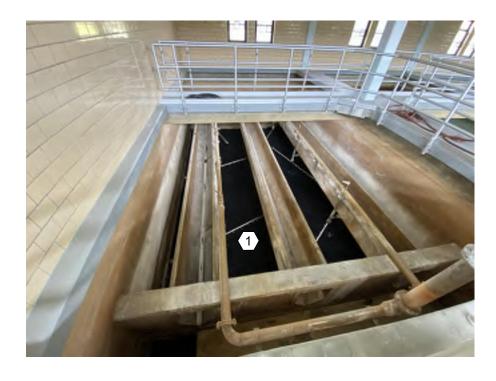




<b>City of Ann Arbor</b>	Ann Arbor, Michigan	2024 Water Treatment Plant	Filter 18/20 Underdrain Improvements PROCESS PHOTOS		
F	REVIS	SION	<u>s</u>		
6/3/2024	BIDS A	ND CONS	TRUCTION		
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- WIRE BRUSH OR BLAST CLEAN EX. REINFORCING;

- WHERE CROSS SECTIONAL LOSS IS GREATER THAN 10%, SPLICE ADDITIONAL REINFORCING MATCHING ORIGINAL SIZE

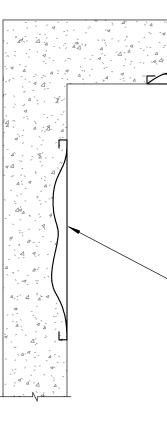TYPICAL REINFORCING DETAIL NO SCALE
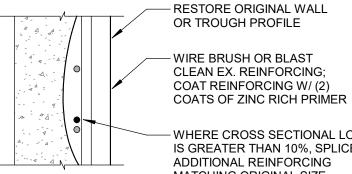
# PROCESS GENERAL ABBREVIATIONS

А	AIR
AB	ANCHOR BOLT
ABAN	ABANDON/ABANDONED ADJACENT
AFF	ABOVE FINSHED FLOOR
AG	ABOVE GRADE
AGGR	AGGREGATE
	ALUMINUM
	ALTERNATE/ALTERNATIVE
AMT	AMOUNT
	APPROXIMATE
-	-
	ASSEMBLY
	AVERAGE
В	BEND
	BACK TO BACK
BCKR	BACKER BOARD
BF	BLIND FLANGE
BFG	BELOW FINISHED GRADE
BFP	BACKFLOW PREVENTER
BLDG	BUILDING
BI KHD	BUILDING BULKHEAD
	BLOWDOWN
	BENCHMARK
BMC BOT	BOLTED MECHANICAL COUPLING BOTTOM
	BEARING
DRG	
DOIVII	BASEMENT
	BRITISH THERMAL UNITS
	BETWEEN
	CENTER TO CENTER
CB	CATCH BASIN
CF	CUBIC FEET
CFS	
CFM	CUBIC FEET PER MINUTE
CHAM	CHAMFER
CHEM	CHEMICAL
CHKPL	CHECKERPLATE
CL	CENTERLINE
CLR	CLEARANCE
CO	CLEANOUT
	COMPANION
CONC	CONCRETE
	CONCENTRATED
	CONCENTRATED
CONC	
CONST	CONSTRUCTION
COORD	
COR	CORRUGATED
CPLG	COUPLING
CPVC	CHLORINATED POLYVINYL CHLORIDE
CTL	CONTROL
CW	COLD WATER
CV	

DEG DEMO DET DIA DIF DISCH DIS	DISTANCE DIRECTION DIAPHRAGM SEAL DOWN DEEP/DEPTH DRAWING DRAIN-WASTE-VENT EAST END TO END EACH ECCENTRIC EQUIPMENT DRAIN ELECTRICALLY HEAT-TRACED EXPANSION JOINT ELEVATION ELEVATION ELEVATION ELBOW EMBEDMENT ENGINEER EQUAL EQUIPMENT EACH SIDE EMERGENCY SHOWER AND EYE WASH EACH WAY EXCAVATE (ION) EXISTING EXISTING EXISTING EXISTING EXPOSED EXTERIOR FACE TO FACE FABRICATED FLOOR DRAIN FINISHED FLOOR
FIN	FINSHED
FLR	FLOOR
FM	FORCE MAIN
FRP	FIBERGLASS REINFORCED PLASTIC
FSP	FABRICATED STEEL PIPE
FTG	FITTING
F.V.	FIELD VERIFY
GA	GAUGE/GAGE
GA	GAUGE/GAGE
GAC	GRANULATED ACTIVATED CARBON
GFA	GROOVED FLAGNE ADAPTER
GPC	GROOVED PIPE COUPLING

HP HP HT HVAC HW HVL HZ I.E. I.D. IN INS INS INS INS INS INS INS INS INS	GALLONS PER DAY GALLONS PER MINUTE GRADE HOSE BIBB HIGH DENSITY POLYETHYLENE EXTRUSION HEADWALL HANGER HYDRAULIC GRADE LINE HORIZONTAL HIGH POINT HORSEPOWER HEIGHT HEATING, VENTILATING AND AIR CONDITIONING HOT WATER HIGH WATER LEVEL HYDRAULIC HERTZ INVERT ELEVATION INSIDE DIAMETER INCH INSULATION, INSULATE INCUDE INSTRUMENT, INSTRUMENTATAION INTERIOR INVERT IRON PIPE SIZE ISOLATION RING JOINT LABORATORY LATERAL POUND LINEAL FOOT LENGTH LEFT HAND LIQUD LOW LOW WATER LEVEL LONGITUDINAL LOW FOINT LONG RADIUS LOW WATER LEVEL MOTOR MAITENANCE MATERIAL MAXIMUM MANUFACTURER MILLION GALLONS PER DAY MANHOLE MINIMUM MISCELLANEOUS MECHANICAL JOINT MOUNTED METAL
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CY

CUBIC YARD

SOUTH

SED SEDIMENTATION

SANITARY

SCHEDULE

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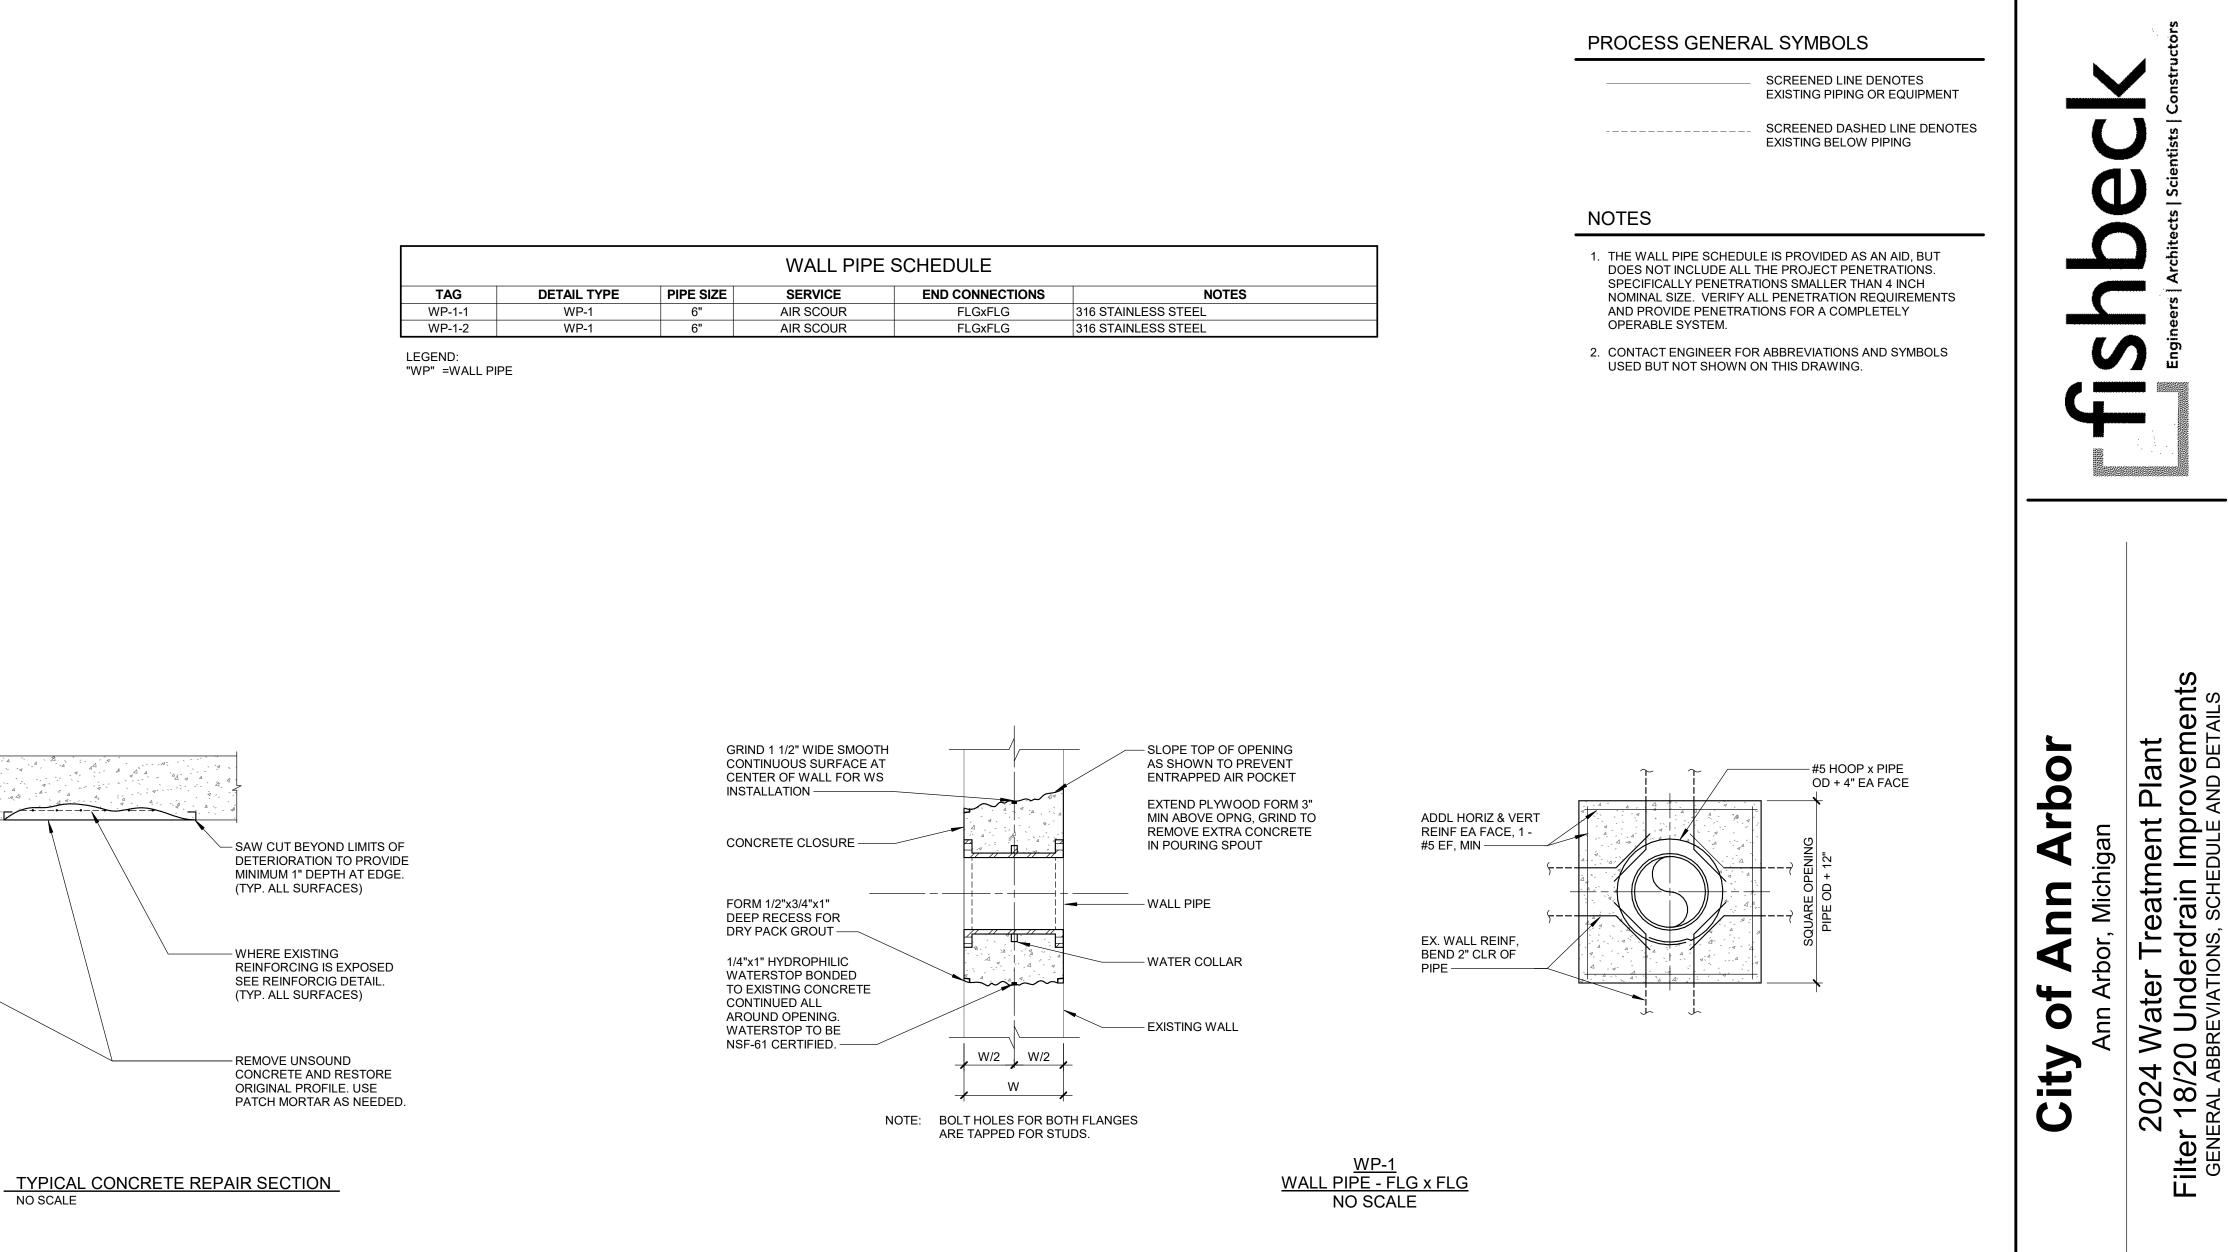
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NORTH

WALL PIPE SCHEDULE					
TAG	DETAIL TYPE	PIPE SIZE	SERVICE	END CONNECTIONS	NO
WP-1-1	WP-1	6"	AIR SCOUR	FLGxFLG	316 STAINLESS STEEL
WP-1-2	WP-1	6"	AIR SCOUR	FLGxFLG	316 STAINLESS STEEL



#### PIPE CONTENT ABBREVIATIONS

BWWBACKWASH WATERPCCACOMPRESSED AIRPSCLPCHLORINE GAS (PRESSURIZED)PLCLSCHLORINE SOLUTIONPLD/DRDRAINPVDCDECANTRADGDIGESTER GASRVDSLDIGESTER SLUDGESAEFFEFFLUENTSEFECLFERRIC CHLORIDESEFLTFILTRATESNFWFILTERED WATERSFFTWFILTER TO WASTESFHFSHYDROFLUOROSILICIC ACIDSGHYPOSODIUM HYPOCHLORITESFINFLINFLUENTSTLIMELIMESTLIMELIQUIFIED PETROLEUM GASTVMEMETHANOLVNACAUSTICVCNGNATURAL GASWNPWNON-POTABLE WATERWIOFOVERFLOWWIOADYAGENWI	LRPLANT RECYCLEOLYPOLYMERSWPLANT SERVICE WATERJPNEUMATIC UNLOADINGJWPLANT UTILITY WATERWPOTABLE/FINISHED WATERASRETURN ACTIVATED SLUDGEWRAW WATERANSANITARYBDSODIUM BISULFITELSLUDGENSUPERNATANTPLSAMPLE LINEODASODA ASHPDSUMP PUMP DISCHARGELRSLUDGE TRANSFERTWSETTLED/CLARIFIED WATERWSERVICE WATERSLTHICKENED SLUDGENTEMPERED WATERVENTVACUUMVWASTEYASWASTE ACTIVATED SLUDGEYFWARM FLAREYWWASTE WATERWWWASTE WATERYWWASTE WATERYWWASH WATER SUPPLY
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#### PIPE/TUBING MATERIAL ABBREVIATIONS

CI CPVC CS CU	CAST IRON CHLORINATED POLYVINYL CHLORIDE CARBON STEEL COPPER	PE PP PTFE PVC	POLYETHYLENE POLYPROPYLENE TEFLON PIPE POLYVINYL CHLORIDE
DI	DUCTILE IRON	PVDF	POLYVINYLIDENE FLUO
FRP	FIBERGLASS REINFORCED PLASTIC	RCP	REINFORCED CONCRET
GALV	GALVANIZED STEEL	316SS	STAINLESS STEEL (NUM
HDPE	HIGH-DENSITY POLYETHYLENE	TT	TITANIUM
PCCP	PRESTRESSED CONCRETE CYLINDER PIPE		

#### NOT APPLICABLE SIM NOT IN CONTRACT NUMBER SP AMERICAN NATIONAL TAPER PIPE THREAD SP NOT TO SCALE ON CENTER OUTSIDE DIAMETER OVERHEAD ELECTRICAL OPNG OPENING OPP OPPOSITE ORIG ORIGINAL ING OVHD OVERHEAD PUMP, PUMPING PROCESS AND INSTRUMENTATION DIAGRAM PLAIN END PERF PERFORATED PLATE PANEL PARTS PER MILLION PAIR PROP PROPOSED PUMP STATION POUNDS PER SQUARE FOOT POUNDS PER SQUARE INCH PAINTED FLOW QUANTITY UL RADIUS ROOF DRAIN RECIRC RECIRCULATE/RECURCULATING/RECIRCULATION RED REDUCER/REDUCING REF REFERENCE REHAB REHABILITATION REINF REINFORCE/REINFORCING REQD REQUIRED RES RESERVOIR RESIL RESILIENT REVISION RESTRAINED FLANGE ADAPTER RIGHT HAND RESTRAINED JOINT ROOM W ROUGH OPENING WS **REVOLUTIONS PER MINUTE** W٦ RISER WS RUBBER XP

SH

YH

ANALYTICAL	ABBREVIATIONS

M CHLORIDE	ALK CH4	ALKALINITY METHANE	O3 ORP	OZONE OXIDATION/REDU
JENT JENT W/PLANT RECYCLE _E	CL2 COMB CON DO	CHLORINE COMBUSTIBLE GAS CONDUCTIVITY DISSOLVED OXYGEN	PC PH PO4 SC	PARTICLE COUNT HYDROGEN ION C PHOSPHATE STREAMING CURF
E WATER NLOADING WATER SHED WATER ATED SLUDGE	F IR H2S METH NH3 NO3 O2	FLUORIDE INFRARED HYDROGEN SULFIDE METHONOL AMMONIA NITRATE OXYGEN	SO2 TEMP TH TSS TURB UV	SULFURE DIOXIDE TEMPERATURE TOTAL HARDNESS TOTAL SUSPENDE TURBIDITY ULTRAVIOLET

#### PROCESS EQUIPMENT ABBREVIATIONS

AIC A	AIR COMPRESSOR AIR SYSTEM	HTR HX	HEATER HEAT EXCHANGER	
BFP	BELT FILTER PRESS	HSP	HIGH SERVICE PUMP	
BP	BOOSTER PUMP	LSP	LOW SERVICE PUMP	
BPS	BOOSTER PUMP SKID	MH	MANHOLE	
BWR	BLOWER	MX	MIXER	6/3/2024 BIDS AND CONSTRUCTION
BTK	BULK STORAGE CHEMICAL TANK	Р	PUMP	
CENT	CENTRIFUGE	PFP	PLATE AND FRAME FILTER PRESS	Drawn By ANW
CF	CARTRIDGE FILTER	PM	POLYMER FEED SYSTEM	,
CIP	CLEAN-IN-PLACE	R	REACTOR	Designer ANW
CL	CLARIFIER	RD	RUPTURE DISC	Deviewer MTD
CN	CONVEYOR	RPZ	REDUCED PRESSURE ZONE VALVE	Reviewer MTP
DIF	DIFFUSER	SCP	SCREW PRESS	Manager BP
DIG	DIGESTER	SMP	SUMP PUMP	
DTK	DAY TANK (CHEMICAL)	SP	SAMPLE PUMP	Hard copy is intended to be
ESEW	EMERGENCY SHOWER AND EYE WASH	STR	STRAINER	
FLT	FILTER	TK		24"x36" when plotted. Scale(s)
FM	FLOCCULATOR MIXER	TP	TRANSFER PUMP	indicated and graphic quality may
GT	GRAVITY THICKENER	U	MISCELLANEOUS EQUIPMENT	not be accurate for any other size.
		UV	ULTRAVIOLET LIGHT	

OXIDATION/REDUCTION POTENTIAL

HYDROGEN ION CONCENTRATION

PARTICLE COUNTER

STREAMING CURRENT

TOTAL SUSPENDED SOLIDS

SULFURE DIOXIDE

TOTAL HARDNESS

REVISIONS

PROJECT NO.

231370


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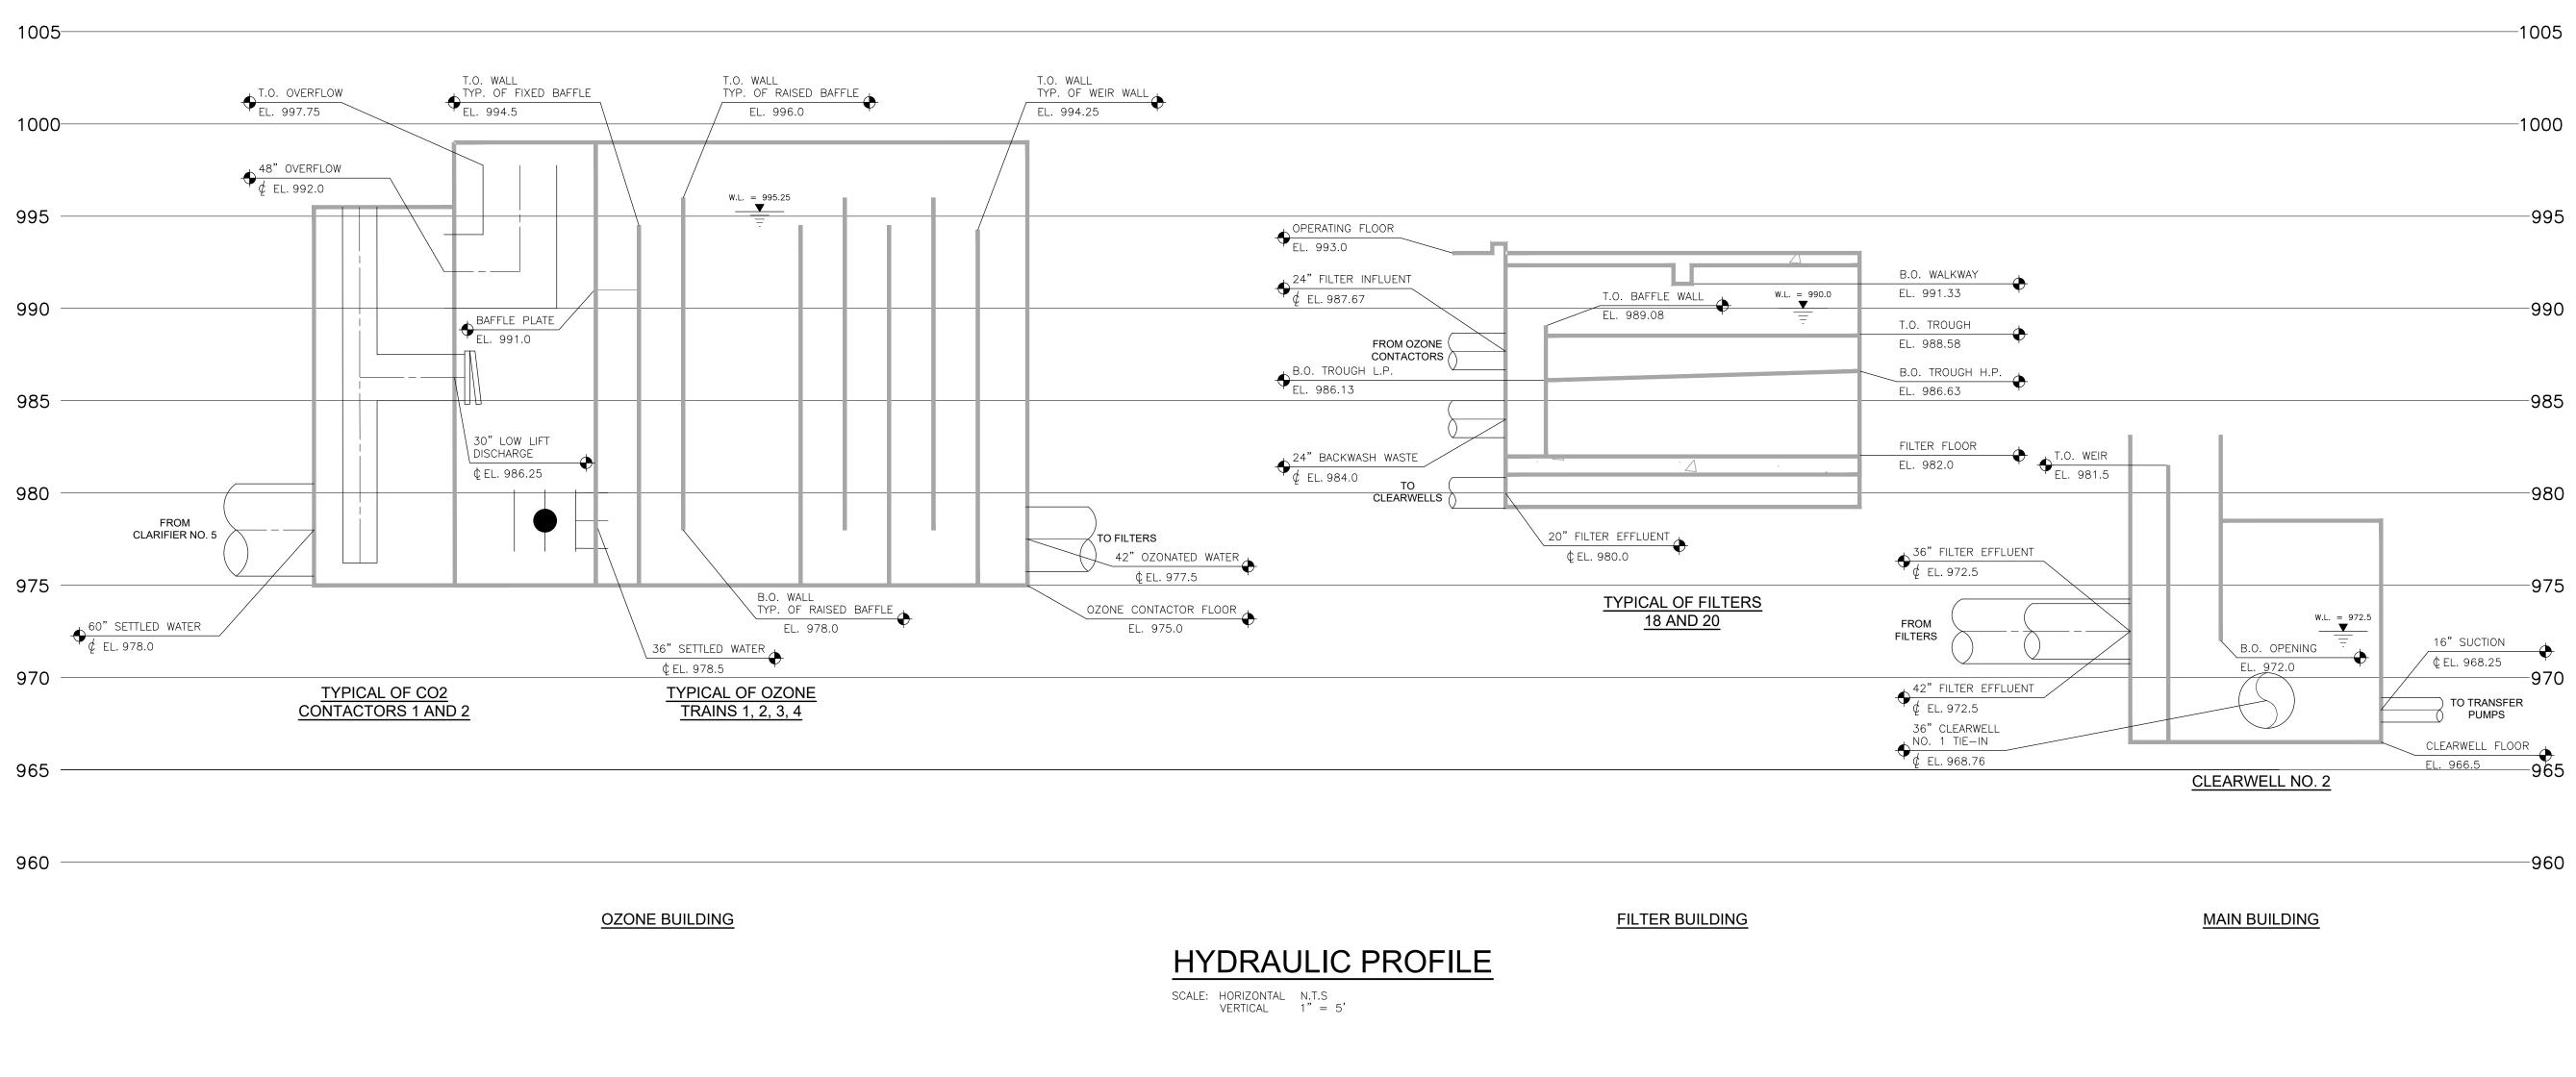
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ORIDE (KYNAR) ETE PIPE

IMERIC INDICATES GRADE)







SCALE: HORIZONTAL N.T.S VERTICAL 1" = 1'

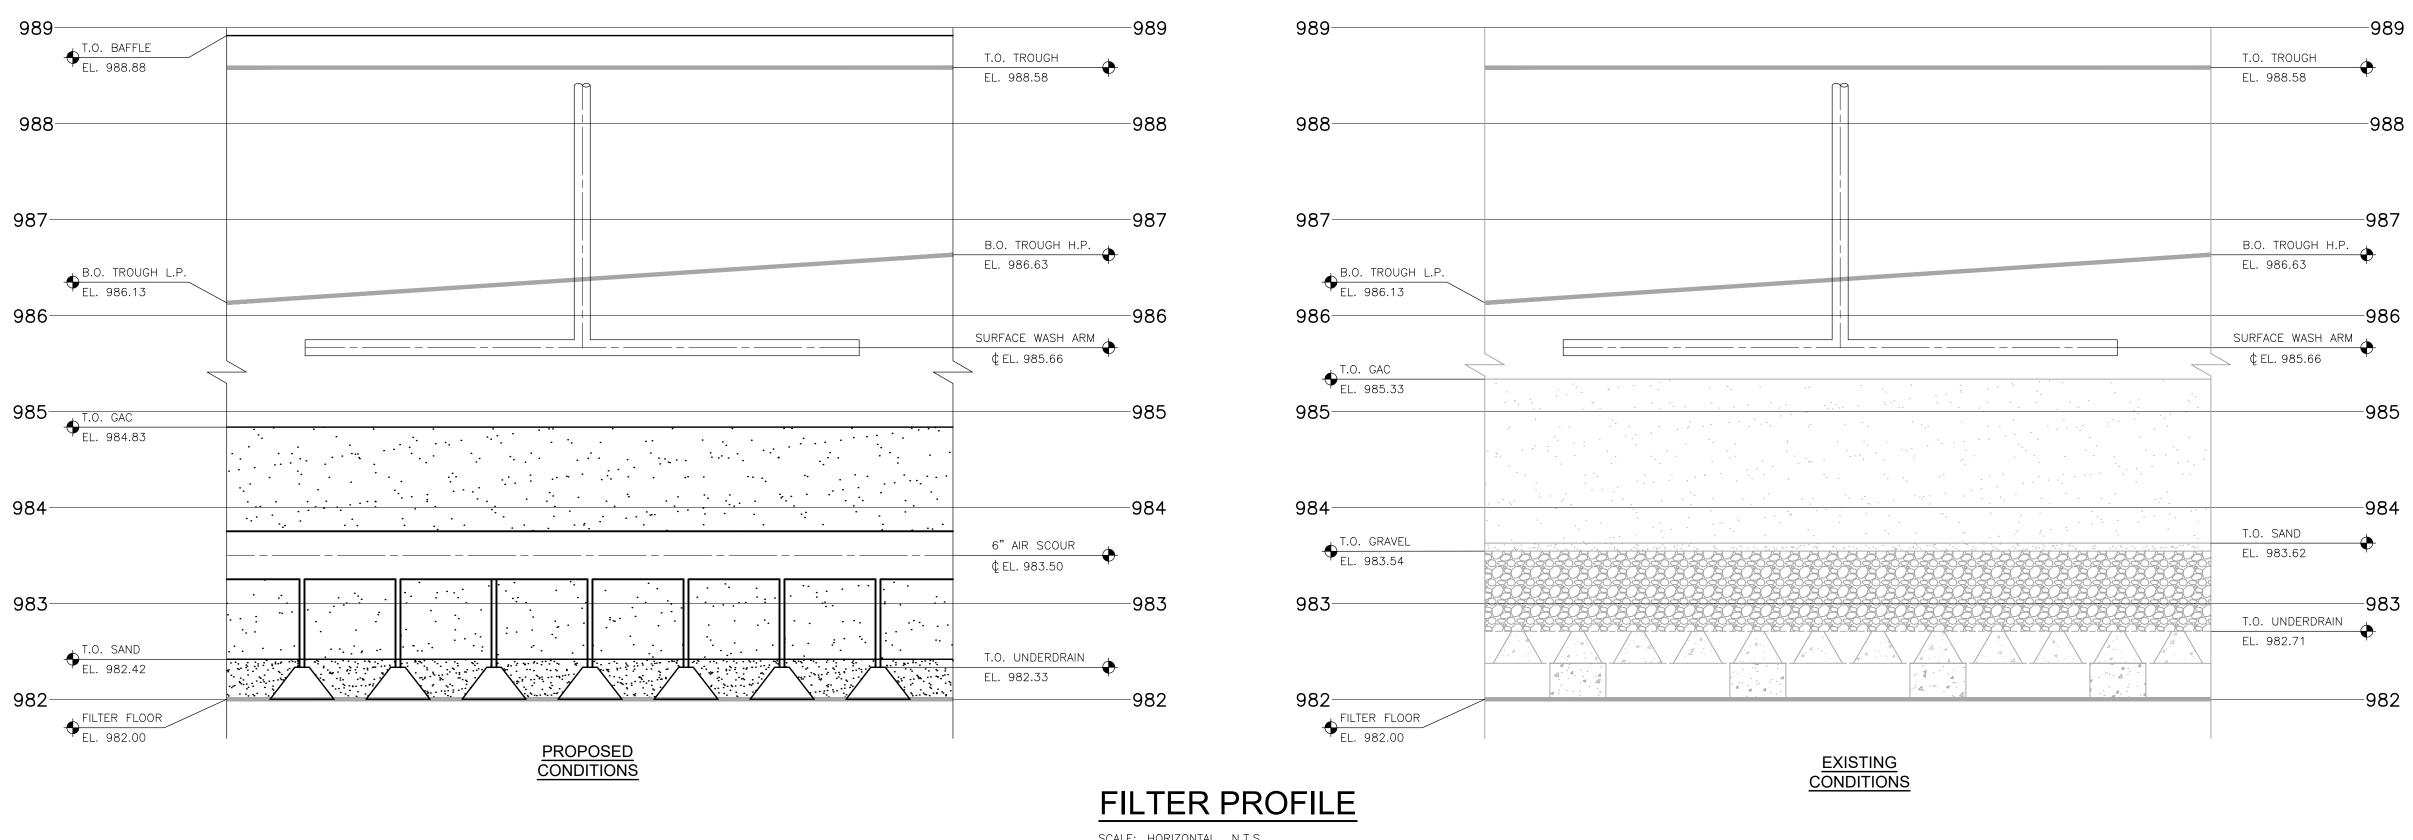
# NOTES

- 1. FIELD VERIFY EXISTING ELEVATIONS.
- 2. PROPOSED FILTER PROFILE SHOWN FOR REFERENCE ONLY. SEE PROCESS SECTIONS FOR DETAILS.
- 3. DEMOLISH FILTER UNDERDRAIN AND GRAVEL SHOWN IN EXISTING FILTER PROFILE. SEE PROCESS DEMOLITION FOR DETAILS.

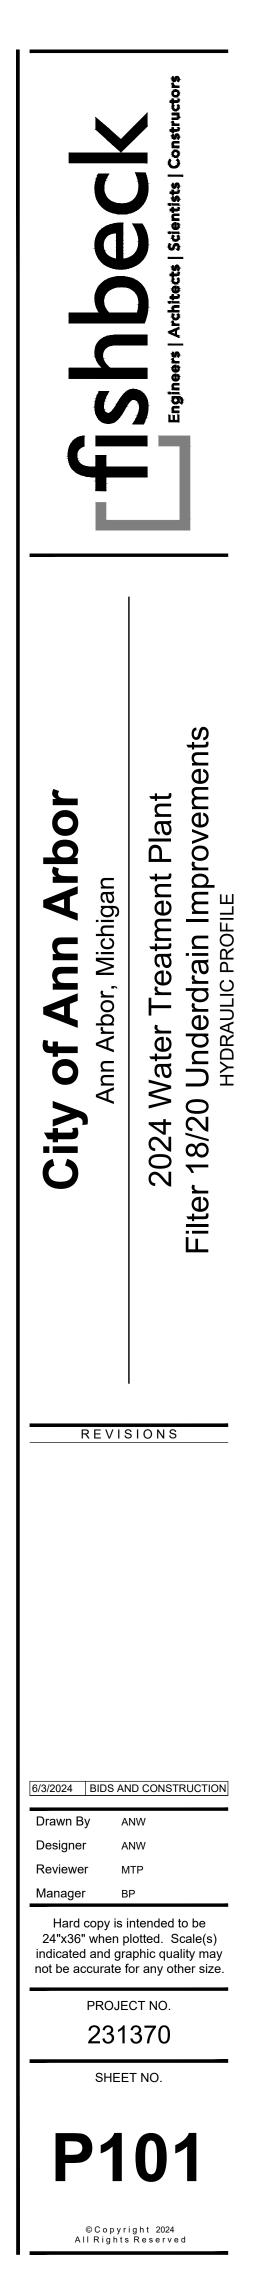

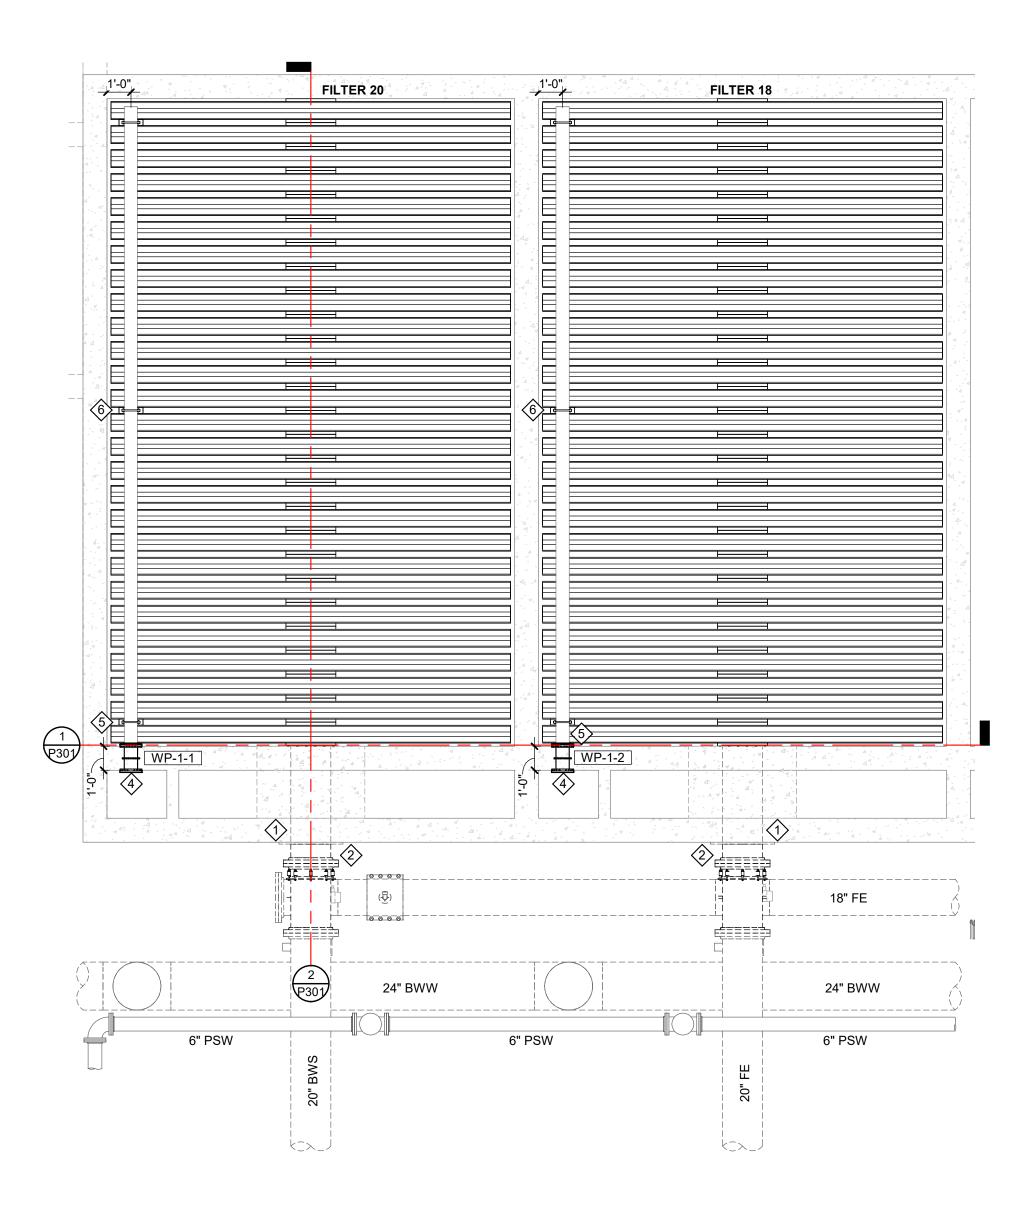



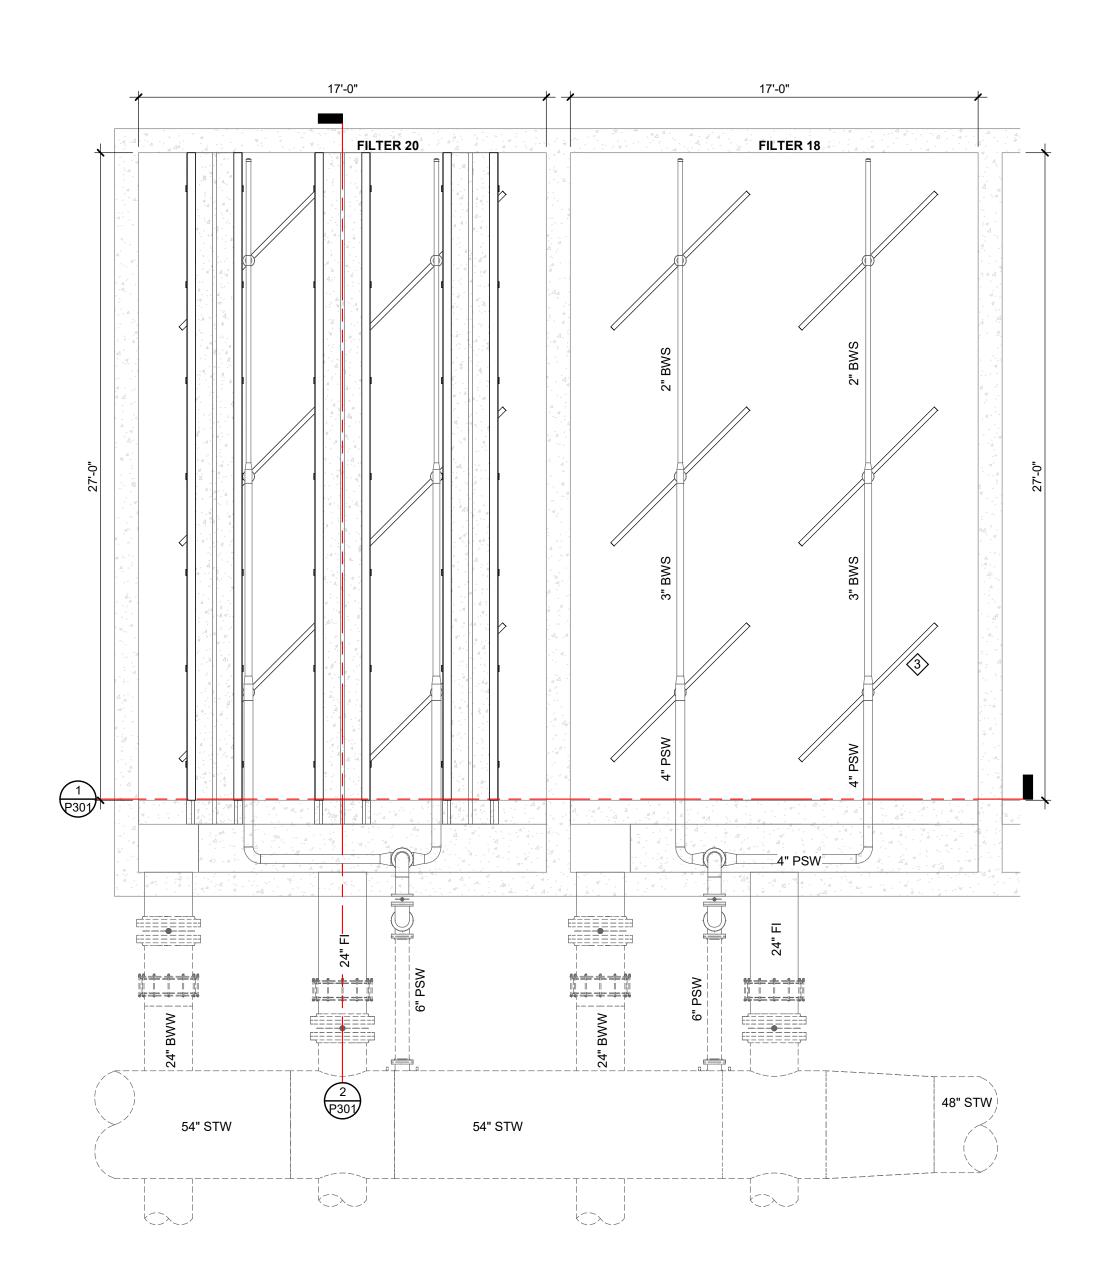



#### PROCESS GENERAL NOTES


- 1. THE FOLLOWING NOTES APPLY TO ALL PROCESS SHEETS.
- 2. NOTES, SYMBOLS, LEGENDS AND ABBREVIATIONS SHOWN ON PROCESS DRAWINGS MAY NOT BE ALL INCLUSIVE, ONLY APPLY TO PROCESS DRAWINGS (P### SHEETS) AND, ALSO WHEN PRESENT, PROCESS DEMOLITION (D4## SHEETS).
- 3. GRAPHICAL REPRESENTATION OF EXISTING SYSTEMS IS BASED ON PREVIOUS CONSTRUCTION AND/OR RECORD DRAWINGS AND MAY NOT FULLY REPRESENT EXISTING CONDITIONS, AND IS FOR REFERENCE ONLY. FIELD VERIFY EXISTING CONDITIONS TO DETERMINE EXTENT OF WORK.
- 4. FIELD VERIFY ALL DIMENSIONS SHOWN.

#### NOTES


- FILTER 18 AND FILTER 20 WALKWAY HIDDEN FROM FILTER GALLERY PLAN FOR CLARITY OF BACKWASH TROUGHS AND SURFACE WASH ARMS.
- 2. FILTER 18 AND FILTER 20 MEDIA HIDDEN FROM PLANS FOR CLARITY.
- 3. FILTER 18 BACKWASH TROUGHS HIDDEN FROM FILTER GALLERY PLAN FOR CLARITY OF SURFACE WASH ARMS.


#### ♦ KEY NOTES


- 1 INSTALL NEW SEAL WITHIN FW/BWS PIPE AND NEW GASKET AT WALL PLATE. SEE DETAIL. TYPICAL OF FILTER 18 AND FILTER 20.
- REINSTALL FW/BWS PIPE, STEEL WALL PLATE, AND FLANGED COUPLING ADAPTER. TYPICAL OF FILTER 18 AND FILTER 20.
   REINSTALL FW/BWS PIPE, STEEL WALL PLATE, AND
- FLANGED COUPLING ADAPTER. TYPICAL OF FILTER 18 AND FILTER 20.4 INSTALL BLIND FLANGE AT WALL PIPE.
- 5 INSTALL 6" SS AIR SCOUR HEADER. PROVIDED BY FILTER UNDERDRAIN SUPPLIER.
- 6 INSTALL U-BOLT AIR SCOUR PIPE STAND. PROVIDED BY FILTER UNDERDRAIN SUPPLIER. (TYP)

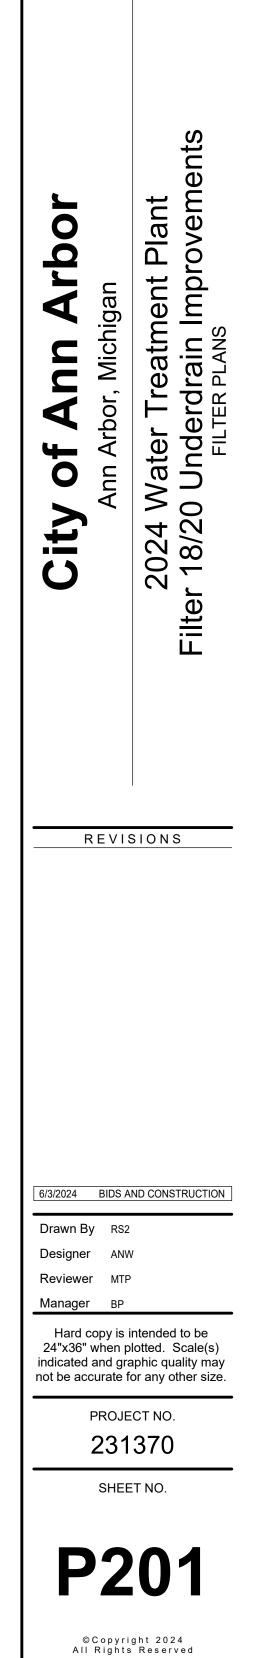



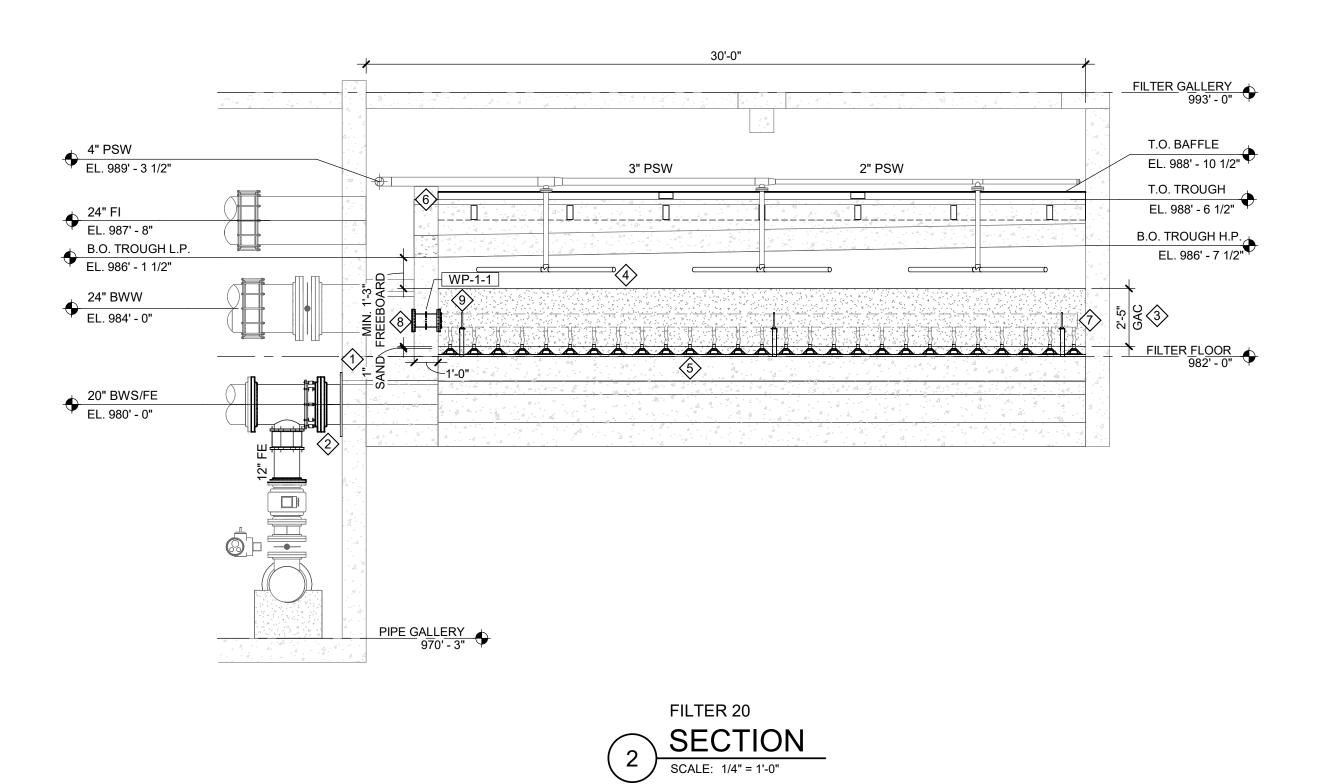

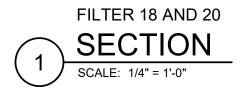

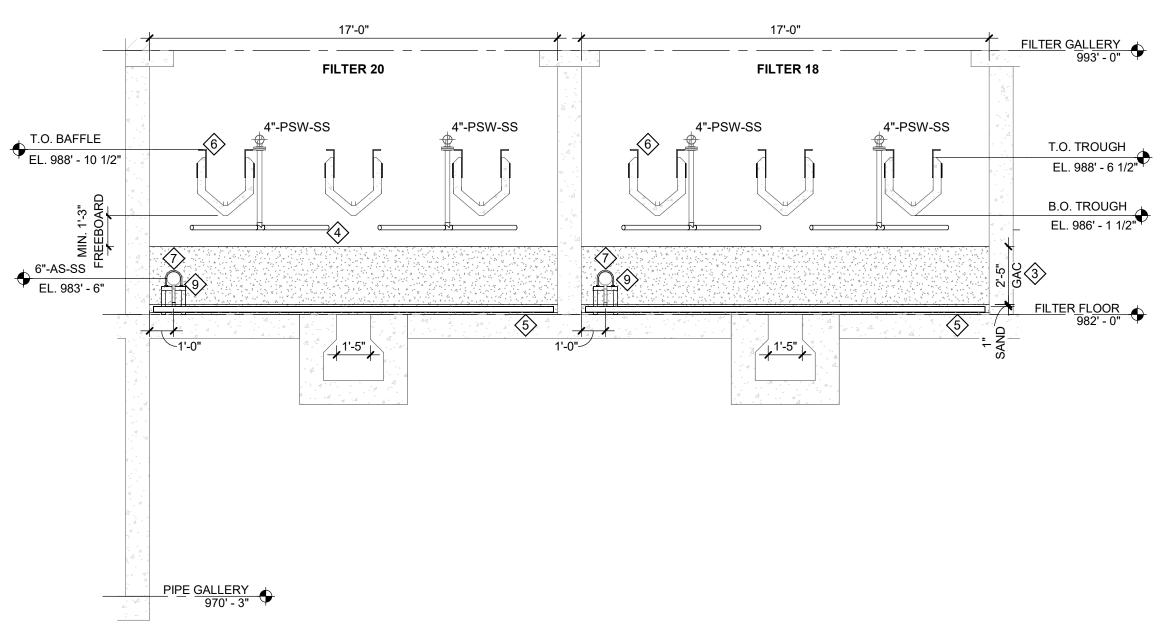

# SYMBOLS LEGEND



#### ♦ KEY NOTES


- 1 INSTALL NEW SEAL WITHIN FW/BWS PIPE AND NEW GASKET AT WALL PLATE. SEE DETAIL. TYPICAL OF FILTER 18 AND FILTER 20.
- 2 REINSTALL FW/BWS PIPE, STEEL WALL PLATE, AND FLANGED COUPLING ADAPTER. TYPICAL OF FILTER 18 AND
- FILTER 20. 3 FILTER GAC TO BE FURNISHED AND INSTALLED BY FILTER
- GAC SUPPLIER. TYPICAL OF FILTER 18 AND FILTER 20.REINSTALL SURFACE WASH ARMS. TYPICAL OF 6 PER
- FILTER. TYPICAL OF FILTER 18 AND FILTER 20.
- 7 INSTALL 6" SS AIR SCOUR HEADER. PROVIDED BY FILTER UNDERDRAIN SUPPLIER.
  8 INSTALL BLIND FLANGE AT WALL PIPE.
- 9 INSTALL BEIND FLANGE AT WALL FIFE.
   9 INSTALL U-BOLT AIR SCOUR PIPE STAND. PROVIDED BY FILTER UNDERDRAIN SUPPLIER. (TYP)

City of Ann Arbor Ann Arbor, Michigan	2024 Water Treatment Plant Filter 18/20 Underdrain Improvements			
REVISIONS				
6/3/2024 BIDS AND CONSTRUCTION				
Drawn By RS2				
Designer ANW				
Reviewer MTP				
Manager BP Hard copy is intended to be 24"x36" when plotted. Scale(s) indicated and graphic quality may not be accurate for any other size.				

PROJECT NO. 231370

SHEET NO.



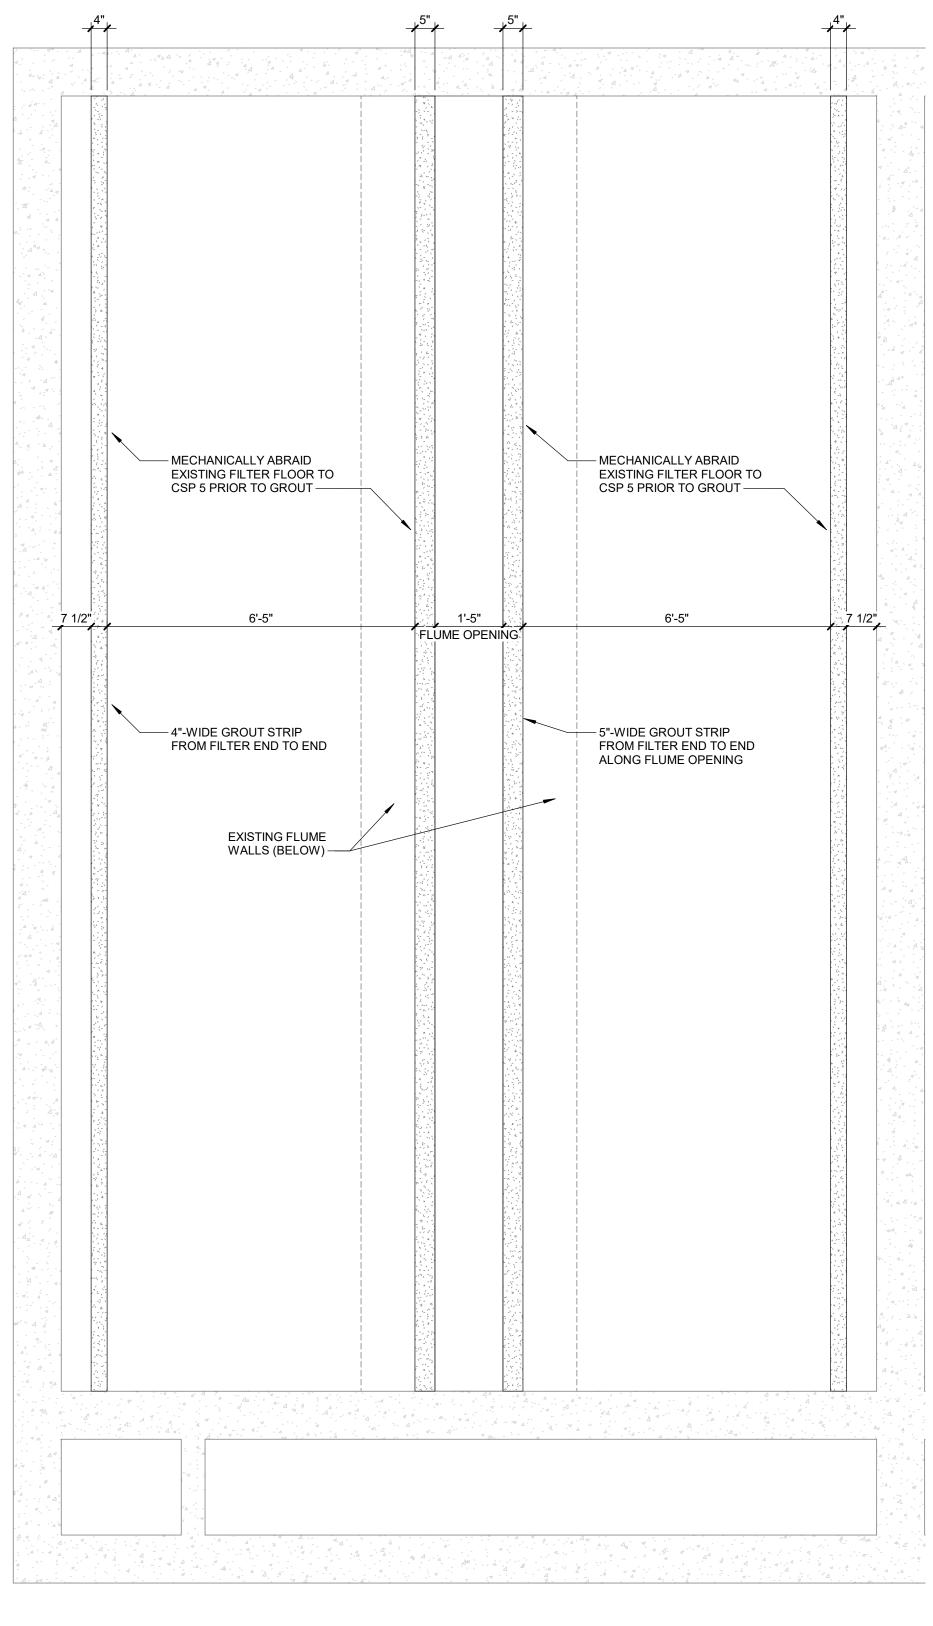

FILTER UNDERDRAIN GROUT DETAIL NO SCALE

NOTE: PROVIDE LEVEL GROUT STRIP, MINIMUM THICKNESS OF 1/2"

