City of Ann Arbor

WTP Lime Residual Removal Contract No. 2 - Dredging and Hauling

Ann Arbor, Michigan

Issued for Bids & Construction Project Number 241760 RFP 25-18



GENERAL

CIVIL

LIME RESIDUAL LAGOON EXISTING SITE PLAN

C102 WATER TREATMENT PLANT SITE PLAN

LIME RESIDUAL LAGOON ENLARGED SITE PLANS


2001 Commonwealth Blvd.

Ann Arbor, Michigan

C501 SESC & STANDARD DETAILS

REFERENCE

8 IN 2009 AS BUILT DRAWING SHEET 31 8 IN 2009 AS BUILT DRAWING SHEET 32 CITY OF ANN ARBOR WASHTENAW COUNTY, MICHIGAN

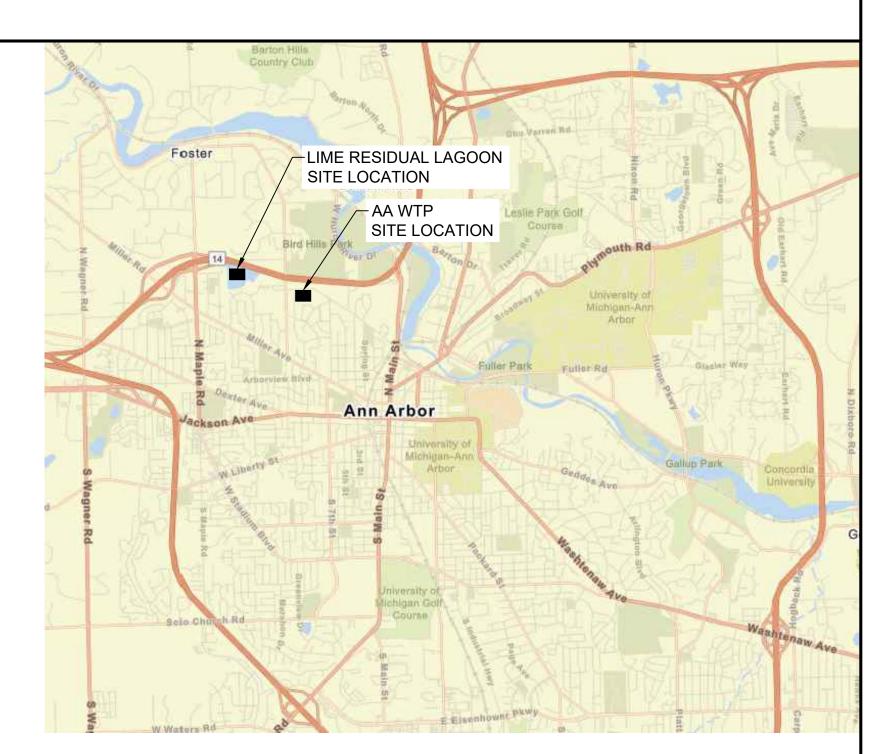




GRAPHIC SYMBOLS

ELEVATION, SECTION, AND


DETAIL DESIGNATION



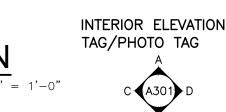






EXTERIOR ELEVATION TAG NORTH ARROW DESIGNATION

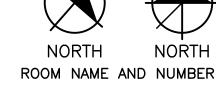


ROOM NAME

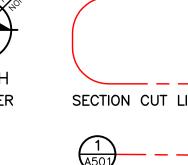

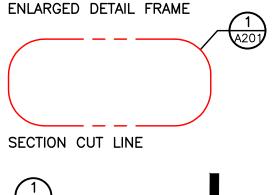

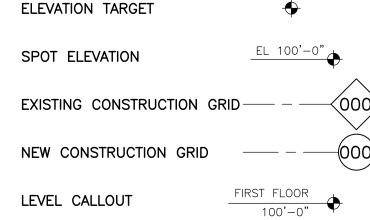

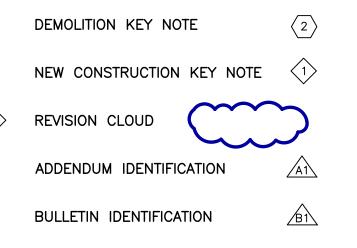

BUILDING CODE INFORMATION

SEAL

REVISIONS

3/25/2025 BIDS & CONSTRUCTION

Manager

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> PROJECT NO. 241760

SHEET NO.

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GENERAL NOTES

- 1. THREE FULL WORKING DAYS PRIOR TO ANY EXCAVATION; THE CONTRACTOR SHALL CONTACT MISS DIG (1-800-482-7171) FOR LOCATION OF UNDERGROUND UTILITIES LOCATED IN THE VICINITY OF THE WORK. THE CONTRACTOR SHALL MAKE ANY NECESSARY ARRANGEMENTS WITH UTILITY COMPANIES FOR RELOCATION OF EXISTING UTILITIES, IF REQUIRED.
- UNDERGROUND UTILITIES AS SHOWN HEREON WERE TAKEN FROM EXISTING PLANS AND ARE APPROXIMATE LOCATIONS ONLY. UNDERGROUND UTILITY LOCATIONS HAVE NOT BEEN FIELD VERIFIED.
 UNLESS SPECIFICALLY NOTED FOR REMOVAL ON THE CONSTRUCTION PLANS, ALL SIDEWALK, DRIVES,
- CULVERTS, GUARDRAILS AND ABOVE GROUND UTILITIES DAMAGED OR DESTROYED DURING CONSTRUCTION SHALL BE REMOVED AND REPLACED, INCIDENTAL TO THE COST OF CONSTRUCTION, AT NO EXPENSE TO
- 4. EXISTING WATER MAINS, STORM SEWERS, SANITARY SEWERS, GAS MAINS AND UNDERGROUND TELEPHONE, ELECTRIC AND CABLE TELEVISION CONDUITS AND/OR LINES ARE SHOWN ONLY IN THE PLAN VIEW OF THE CONSTRUCTION DRAWINGS. THE EXACT DEPTH OF THESE UTILITIES IS NOT KNOWN AND THEREFORE, NO ATTEMPT HAS BEEN MADE TO SHOW SUCH UTILITIES IN THE PROFILE OF THE CONSTRUCTION DRAWINGS. THE CONTRACTOR SHALL BE RESPONSIBLE FOR PROTECTING THESE UTILITIES WHICH ARE NOT WITHIN THE SPACE OCCUPIED BY COMPLETED PIPES OR STRUCTURES THAT ARE A PART OF THIS CONTRACT. DURING CONSTRUCTION, IF DAMAGED OR DESTROYED DURING CONSTRUCTION, THE CONTRACTOR SHALL BE RESPONSIBLE FOR THE COSTS TO REPAIR OR REPLACE THEM AT NO ADDITIONAL EXPENSE TO THE OWNER.
- 5. THE CONTRACTOR SHALL PROTECT EXISTING UTILITIES IN A MANNER ACCEPTABLE TO THE ENGINEER DURING THE PROPOSED CONSTRUCTION. ANY UTILITY, WHICH IS TO REMAIN IN SERVICE, THAT IS DAMAGED OR DESTROYED DURING CONSTRUCTION SHALL BE REPLACE BY THE CONTRACTOR AT NO ADDITIONAL EXPENSE TO THE OWNER.
- PRIOR TO CONSTRUCTION, THE CONTRACTOR SHALL EXPOSE EXISTING UTILITIES AT POINTS OF POSSIBLE
- conflict so that these conflicts can be resolved.

 7. PROTECT TREES IN ACCORDANCE WITH ANN ARBOR PUBLIC SERVICES DEPARTMENT STANDARD SPECIFICATIONS, DIVISION I GENERAL SPECIFICATIONS "PROTECTION OF TREES" AND STANDARD DETAIL
- 8. ACCESS TO THE FORCE MAIN AIR RELEASE VALVE LOCATED WITHIN THE SCHOOL PARKING AREA SHALL ONLY BE ACCESSED WITH ADVANCE APPROVAL. REQUESTS SHALL BE MADE A MINIMUM OF 3 DAYS IN ADVANCE. ALL OTHER CONTRACTOR ACCESS TO THE ANN ARBOR PUBLIC SCHOOL PROPERTY IS

SESC NOTES

- 1. CONTRACT 1 TEMPORARY SESC CONTROLS ARE TO BE LEFT IN PLACE FOR THIS CONTRACT. CONTRACTOR
- IS RESPONSIBLE FOR SUPPLEMENTING EXISTING SESC MEASURES TO ACCOMMODATE THEIR SITE LAYOUT AND CONSTRUCTION OPERATIONS.

 CONTRACTOR SHALL INSTALL SILT FENCING ALONG THE DOWN SLOPE SIDE OF ALL EXCAVATIONS.

 CONTRACTOR RESPONSIBLE FOR INSTALLATION AND MAINTENANCE OF ALL TEMPORARY AND PERMANENT SOIL EROSION AND SEDIMENTATION CONTROL (SESC) MEASURES DURING CONSTRUCTION. CONTRACTOR SHALL REMOVE ANY TEMPORARY SESC MEASURES AFTER PROJECT COMPLETION. CONTRACTOR RESPONSIBLE FOR OBTAINING, EXERCISING AND PERFORMING ALL WORK IN ACCORDANCE WITH THE CONDITIONS PROVIDED BY THE ISSUER OF THE SOIL EROSION AND SEDIMENTATION CONTROL PERMIT.

 4. ALL TEMPORARY SEDIMENT CONTROL MEASURES ARE TO BE INSTALLED AND VERIFIED BY ENGINEER
- PRIOR TO EARTH DISTURBANCE ACTIVITY AND CHECKED DAILY FOR EFFECTIVENESS AND REPAIRED AS
- 5. CONTRACTOR IS RESPONSIBLE FOR CLEANING ALL PUBLIC ROADWAYS OF LIME RESIDUAL AND OTHER DEBRIS FROM THE TRUCKING OPERATIONS DAILY. FURNISH A STREET SWEEPER THAT CAN ADEQUATELY CLEAN ALL SPILLED OR TRACKED LIME RESIDUE. THE CITY WILL FURNISH A LINED DUMPSTER AT THE WTP FOR THE STREET SWEEPER DEBRIS. THE CITY WILL HAVE THE DUMPSTER EMPTIED AS NEEDED FOR THE DURATION OF THE PROJECT.

DETAIL IS DRAWN

TRAFFIC NOTES

- 1. CONTRACTOR RESPONSIBLE FOR ANY TRAFFIC CONTROL REQUIRED TO COMPLETE THE WORK IN A SAFE AND EFFICIENT MANNER. WORK INCLUDES IDENTIFYING, APPLYING FOR AND OBTAINING ROW PERMITS AND APPROVAL FOR ALL TEMPORARY LANE CLOSURES OR PARKING SPACE RESTRICTIONS THROUGH THE CITY
- 2. CONSTRUCTION TRAFFIC TO THE WATER TREATMENT PLANT IS EXPECTED TO UTILIZE MILLER AVE TO NEWPORT RD TO SUNSET RD. CONTRACTOR MUST SUBMIT FOR APPROVAL OF ANY ALTERNATIVE ACCESS
- CONTRACTOR TO AVOID TRUCKING THROUGH NEWPORT AND SUNSET INTERSECTION BETWEEN 7:45 AM AND 9:00 AM BETWEEN 2:45 PM AND 4:00 PM FOR ANN ARBOR PUBLIC SCHOOL PICK-UP/DROP-OFF. TIMES MAY VARY ON HALF DAYS AND HOLIDAYS.
- 4. CONTRACTOR TO FURNISH AND INSTALL THREE EACH "TRUCKS ENTERING ROADWAY" TRAFFIC SIGNS. SIGNS TO BE FIELD LOCATED BY ENGINEER AND REMOVED UPON COMPLETION OF TRUCKING OPERATION.

SITE PLAN ABBREVIATIONS

ABBREV. MEANING

ABBREV.	WEANING	ABBREV.	WEANING
ABAN.	ABANDON	EGLE	MICHIGAN DEPARTMENT OF NATURAL RESOURCES
ADJ.	ADJACENT	MDOT	MICHIGAN DEPARTMENT OF TRANSPORTATION
AGG.	AGGREGATE	MDPH	MICHIGAN DEPARTMENT OF PUBLIC HEALTH
ALT.	ALTERNATE	MFGR	MANUFACTURER
APPD.	APPROVED	MGD	MILLION GALLONS PER DAY
APPROX.		MH.	MANHOLE

B/B	BACK TO BACK	MIN.	MINIMUM
BIT.	BITUMINOUS	MISC.	MISCELLANEOUS
BLDG.	BUILDING	MJ	MECHANICAL JOINT
BLVD.	BOULEVARD	MON.	MONUMENT
BM		NA	NOT APPLICABLE
	BENCH MARK		
BNDY.	BOUNDARY	NIC	NOT IN CONTRACT
вот.	ВОТТОМ	NRCP	NON-REINFORCED CONCRETE PIPE
BSMT.	BASEMENT	NTS	NOT TO SCALE
C & G	CURB AND GUTTER	OC	ON CENTER
C/C	CENTER TO CENTER	OD	OUTSIDE DIAMETER
CATV	CABLE TELEVISION	OE	OVERHEAD ELECTRIC
CB	CATCH BASIN	OP	FIBER OPTICS
CB CF CFS	CUBIC FEET	ORIG.	ORIGINAL
CES	CUBIC FEET PER SECOND	OT	OVERHEAD TELEPHONE
CL		PC	POINT OF CURVE
	CENTERLINE		· · · · · · · · · · · · · · · · · · ·
CMP	CORRUGATED METAL PIPE		POINT OF COMPOUND CURVATURE
CO	CLEAN OUT	PE	POLYETHYLENE
CONC.	CONCRETE	PE PERF.	POLYETHYLENE PIPE PERFORATED
CONST.	CONSTRUCTION	PERF.	PERFORATED
COORD.			
	COORDINATE	PI	POINT OF INTERSECTION
CP	COPPER PIPE	PIV	POST INDICATOR VALVE
CSP	CORRUGATED STEEL PIPE	PL	PROPERTY LINE
CSP CSPA	CORRUGATED STEEL PIPE ARCH	POB	POINT OF BEGINNING
CULV.	CULVERT	POE	POINT OF ENDING
CY	CUBIC YARD	PRC	POINT OF REVERSE CURVE
DEG (°)	DEGREE	PROP.	PROPOSED
DEMO.	DEMOLISH	PSF	POUNDS PER SQUARE FOOT
DIP	DUCTILE IRON	PSI	POUNDS PER SQUARE INCH
DIA.	DIAMETER	PT	POINT OF TANGENCY
DIM.		PVC	POLYVINYL CHLORIDE
	DIMENSION	PVC	
DIST.	DISTANCE		POINT OF VERTICAL CURVE
EL.	ELEVATION	PVI	POINT OF VERTICAL INTERSECTION
ENGR.	ENGINEER	PVMT.	PAVEMENT
EOM EQUIP.	EDGE OF METAL	PVT	POINT OF VERTICAL TANGENCY
EQUIP.	EQUIPMENT	QTY.	QUANTITY
	EASEMENT	R.	RADIUS
EXIST. EX.		RCP	REINFORCED CONCRETE PIPE
EXT.		RED.	REDUCER
	EXTERIOR		
F/F	FACE TO FACE	REF.	REFERENCE
FDN.	FOUNDATION	REQD.	REQUIRED
FIG.	FIGURE	REV.	REVISION
FF	FINISH FLOOR	RJ	RESTRAINED JOINT
FIN. GR.	FINISH GRADE	ROW	RIGHT OF WAY
FM	FORCE MAIN	SAN	SANITARY SEWER
FTG.	FOOTING	SF	SQUARE FOOT
GEN.	GENERATOR	SPEC.	SPECIFICATION
GND.	GROUND	SS	SIDE SLOPE
GPD	GALLONS PER DAY	STA.	STATION
GPM	GALLONS PER MINUTE	STD.	STANDARD
HDPE	HIGH DENSITY POLYETHYLENE	STL.	STEEL
HDWL.	HEADWALL	STM	STORM SEWER
Н.	HEIGHT	SYD	SQUARE YARD
HORIZ.	HORIZONTAL	TC	TOP OF CURB
HP	HIGH POINT	TAN.	TANGENT
HWL	HIGH WATER LEVEL	TEMP.	TEMPORARY
HWY.	HIGHWAY	TOC	TOP OF CASTING
HYD.	HYDRANT	T/W	TOP OF WALL
ID	INSIDE DIAMETER	TRPT	TRAVERSE POINT
INV	INVERT ELEVATION	TYP.	TYPICAL
INCL.	INCLUDE	UD	UNDER DRAIN
LA	LANDING AREA (SIDEWALK)	UTIL.	UTILITY
LAT.	LATERAL	VB	VALVE BOX
LF	LINEAL FEET	VCP	VITRIFIED CLAY PIPE
L.	LENGTH	VERT.	VERTICAL
LP	LOW POINT	W/	WITH
LS	LUMP SUM	W/O	WITHOUT
LWL	LOW WATER LEVEL	WL	WATER LEVEL
M/L	MORE OR LESS	WTR	WATER MAIN
MÁINT.	MAINTENANCE		
• •			

ABBREV.

MEANING

OVERALL SITE PLAN 250

SITE SYMBOL LEGEND

TOPOGRAPHY — PLAN			EXISTING UTILITIES	PROPOSED UTIL	PROPOSED UTILITIES		MISCELLANEOUS	
ENSENSENS	SHRUBS	×	- PROPOSED FENCE	8" SAN SANITARY SEWER & MANHOLE		NITARY SEWER & MANHOLE		EASEMENT CENTERLINE
W.	CONIFEROUS TREE		GRAVEL SURFACE	STORM SEWER & MANHOLE ED CATCH BASIN CURB TYPE	wyr	/E & LEAD		EASEMENT LINE
	DECIDUOUS TREE		PAVED SURFACE	CATCH BASIN LAWN TYPE	RIS	SER & LEAD	Δ	SURVEY LINE STATIONING TRAVERSE POINT
	HEDGE EDGE OF WOODS		EXISTING CURB & GUTTER	————— VALVE ————————————————————————————————————	O ——— STA	ANDARD SEWER CLEANOUT	•	SOIL BORING LOCATION
<u> 4112 - 4115 - </u>	MARSH (SWAMP)		PROPOSED CURB & GUTTER	PLUG 6" WTR WATER MAIN	832.56 MAX	XX. ELEVATION OF LOT AD AT PROPERTY LINE	855.00	PROPOSED PAVEMENT/GUTTER ELEVATION PROPOSED PAVEMENT
	- EXISTING DITCH	0	CONCRETE MONUMENT	4" FM FORCE MAIN	12" STM STC MAI	ORM SEWER & NHOLE	<u>{////</u> } <u>&</u>	MARKING (PAINTING) PROPOSED BARRIER FREE PARKING
	- PROPOSED DITCH	•	PROPERTY IRON SET PROPERTY IRON	——————————————————————————————————————	⊕ ⊙ CAT	TCH BASIN	•	TOP MOUNTED LIGHT FIXTURE
	EDGE OF WATER		— LOT LINE (AS PLATTED)	——————————————————————————————————————	uni	IDERDRAIN	•—	LIGHT POLE FIXTURE
*	LIGHT	—-Z-	— PROPERTY HOOK		8"_WTR wa	ATER MAIN		
	GUY ANCHOR		— TITLE LINE/PROPERTY LINE	——————————————————————————————————————	——— ∨AL	LVE & BOX		
	UTILITY POLE		- ROW LINE		——— ∨AL	LVE & CHAMBER	SOIL ERO	SION CONTROL
⊳	SIGN	٨	— SECTION LINE	PIPE-ONLY CULVERT	M ME	TER	(3)	SOIL EROSION CONTROL MEASURES
	GUARD RAIL	(BM)	BENCH MARK	FLARED END SECTION CULVERT HEADWALL CULVERT				
	RAILROAD TRACKS SCALE: 1" = 60' OR LESS		SECTION CORNER			ANDARD FIRE HYDRANT SSEMBLY		TEMPORARY MEASURE PERMANENT MEASURE
	RAILROAD TRACKS SCALE: 1" = 100' OR MORE	-	CENTER OF SECTION		l	JRB STOP & BOX		SECTION NUMBER
×	EXISTING FENCE	-	QUARTER CORNER		6" FORCE MAIN (FM)	PRCE MAIN		SECTION
×	SILT FENCE					R RELEASE STRUCTURE	C2 s	CALE: SCALE OF SECTION
						PE-ONLY CULVERT		SHEET WHERE SECTION IS DRAWN
						ARED END SECTION CULVERT		DETAIL LETTER
					上 12" CSP HEA	ADWALL CULVERT		DETAIL CALE: SCALE OF DETAIL
								SHEET WHERE DETAIL IS DRAWN

Hauling I Removal and Haulir Residual Dredging WTP

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3/25/2025 BIDS & CONSTRUCTION


Drawn By jreyes

Designer Reviewer

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> PROJECT NO. 241760

SHEET NO.

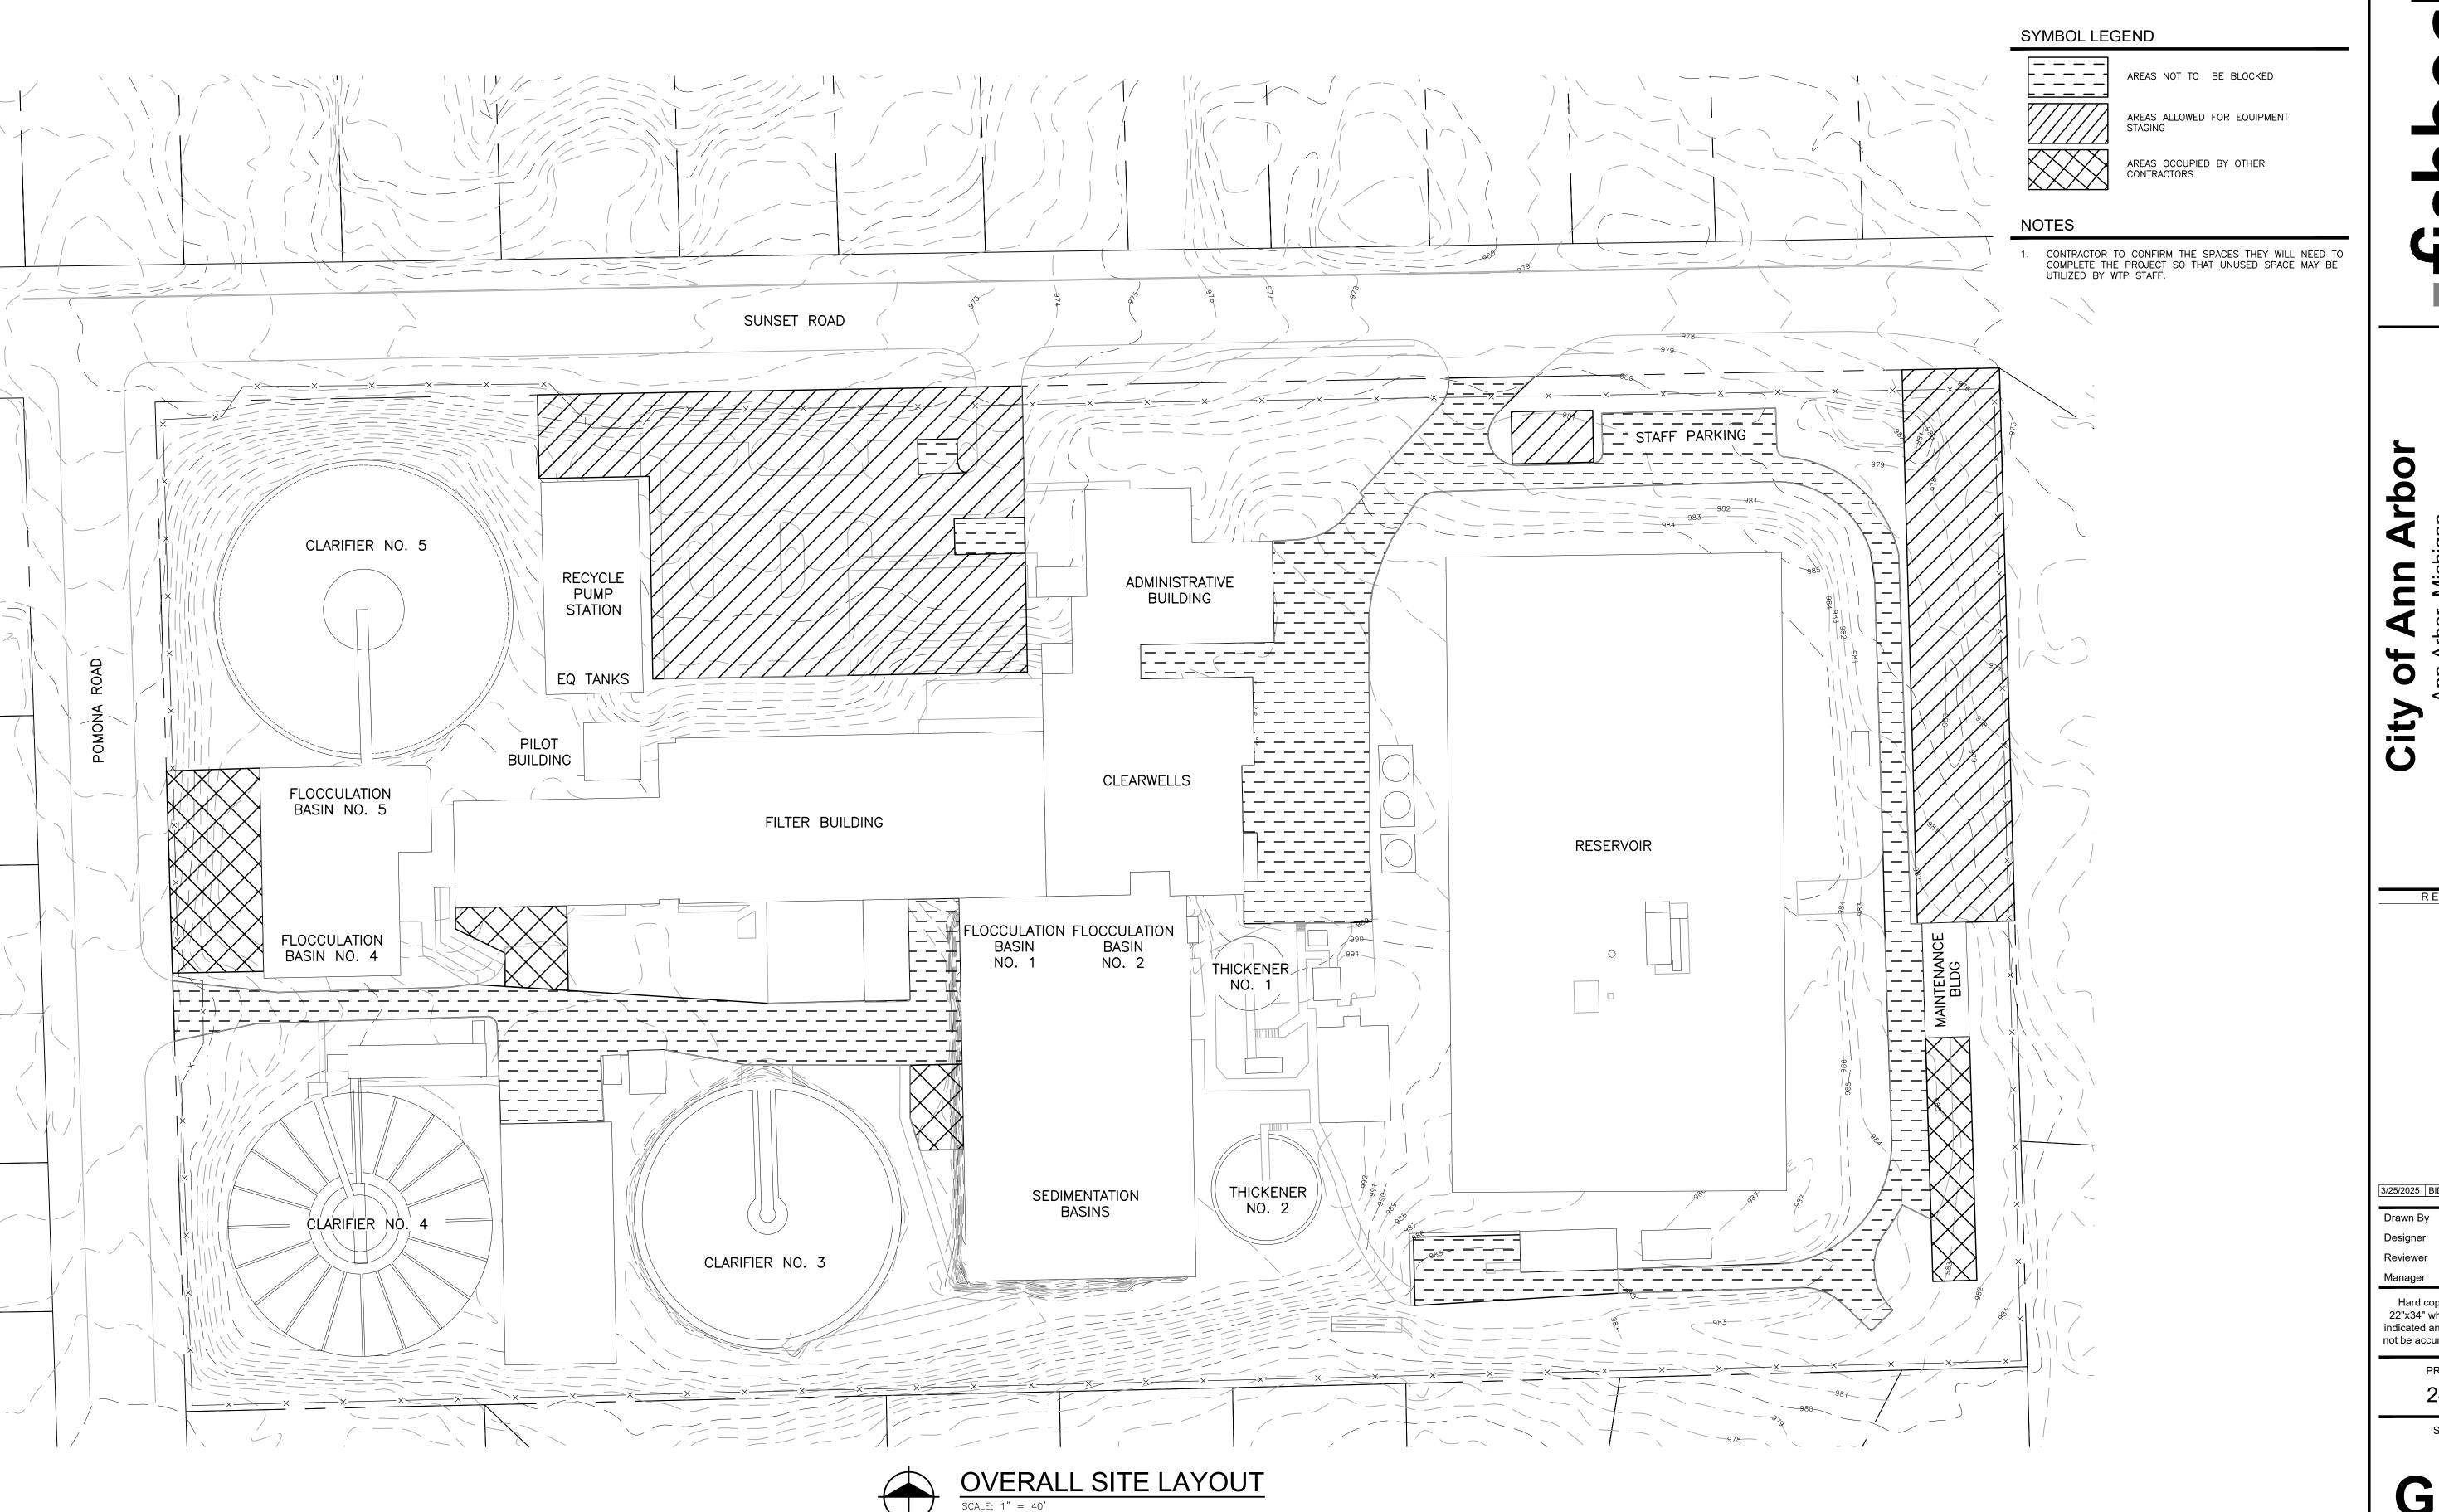

0 City Residual Removal Tredging and Hauling

Contract

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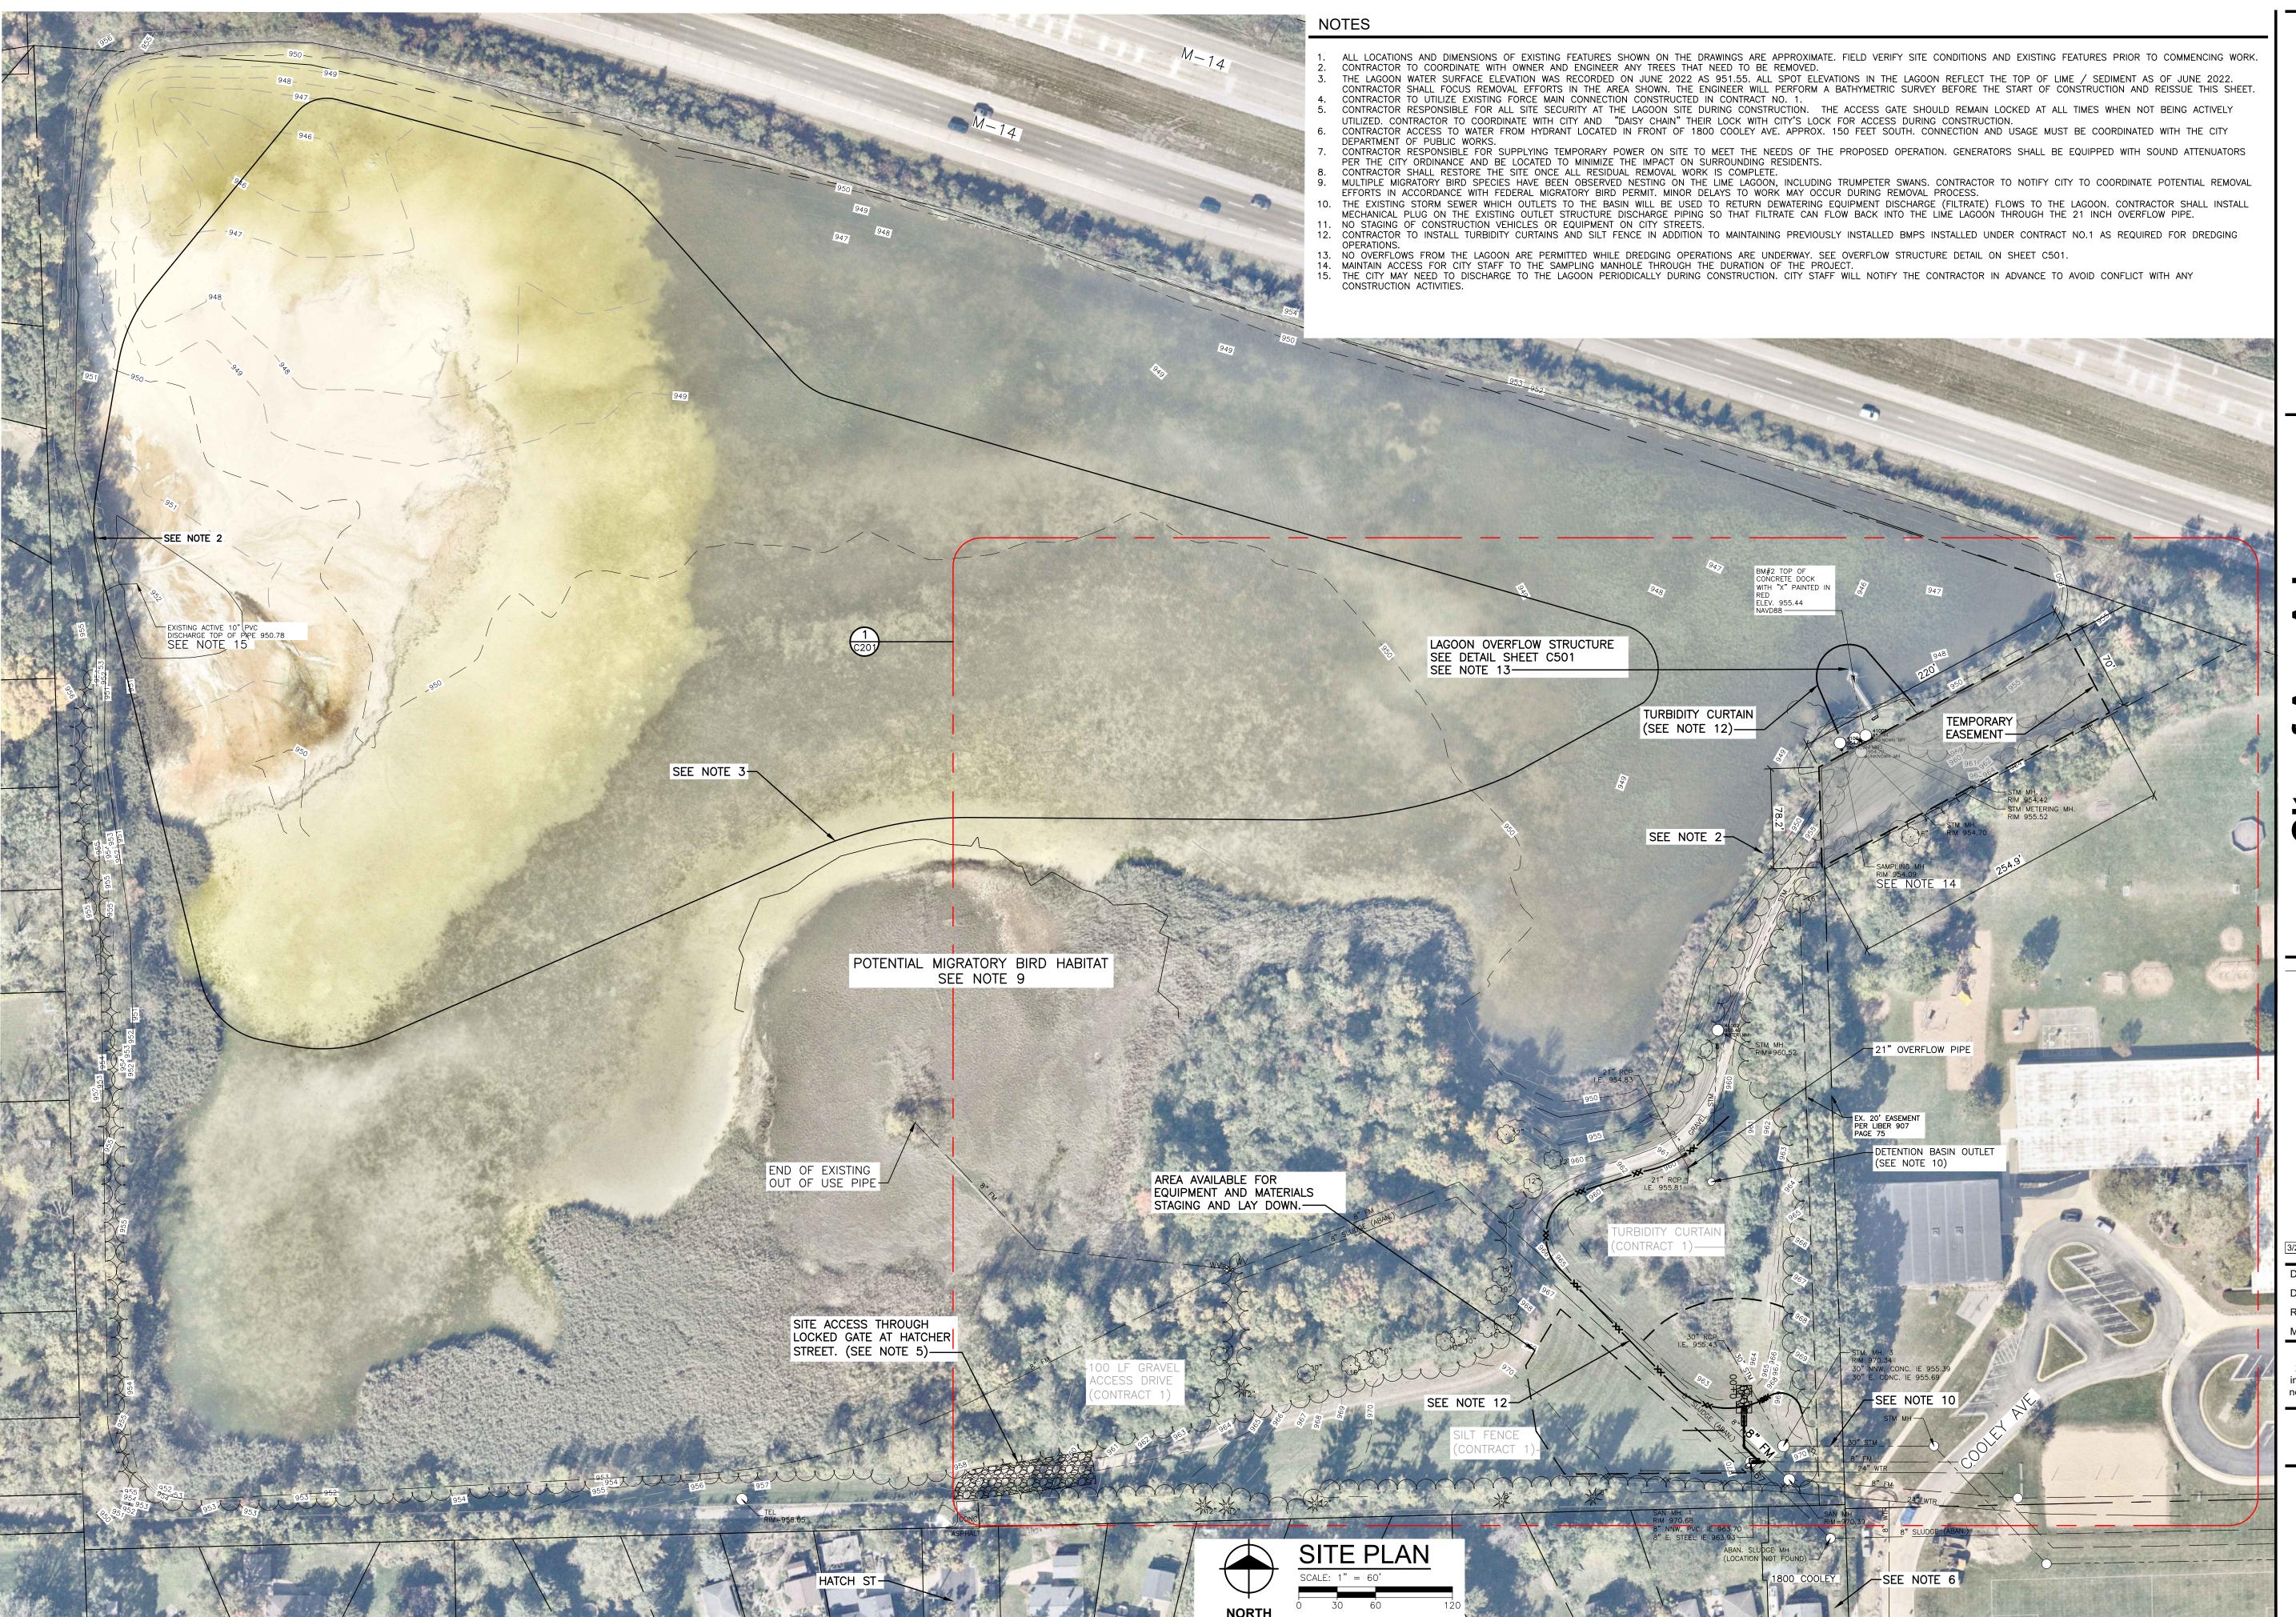
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> PROJECT NO. 241760

SHEET NO.

G102



FSHOOTS | Scientists | Constructors

Il Removal and Hauling

City of Ann Ark

REVISIONS

3/25/2025 BIDS & CONSTRUCTION

Drawn By jreyes

gner jsiwek ewer krostrowski

Manager jsiwek

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PROJECT NO. **241760**

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SHEET NO.

C101



STOPPED CITY Engineers | Architects | Scientists | Constructe

of Ann Arbon

al Removal and Hauling

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REVISIONS

3/25/2025 BIDS & CONSTRUCTION

Drawn By jreyes

ner jsiwek wer krostrowski

Reviewer krostrows


Manager jsiwek


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1 ENLARGED PLAN

SCALE: 1" = 40'

The Turbidity Curtoin system shall be designed to handle site specific drainage or flow patterns.

When water is less than 2 feet deep and has low flow, Turbidity Curtain (Shallow) may be used, Curtain shall be securely fastened to stokes. Water greater than 2 feet deep or where high flow exists requires the use of Turbidity Curtain (Deep).

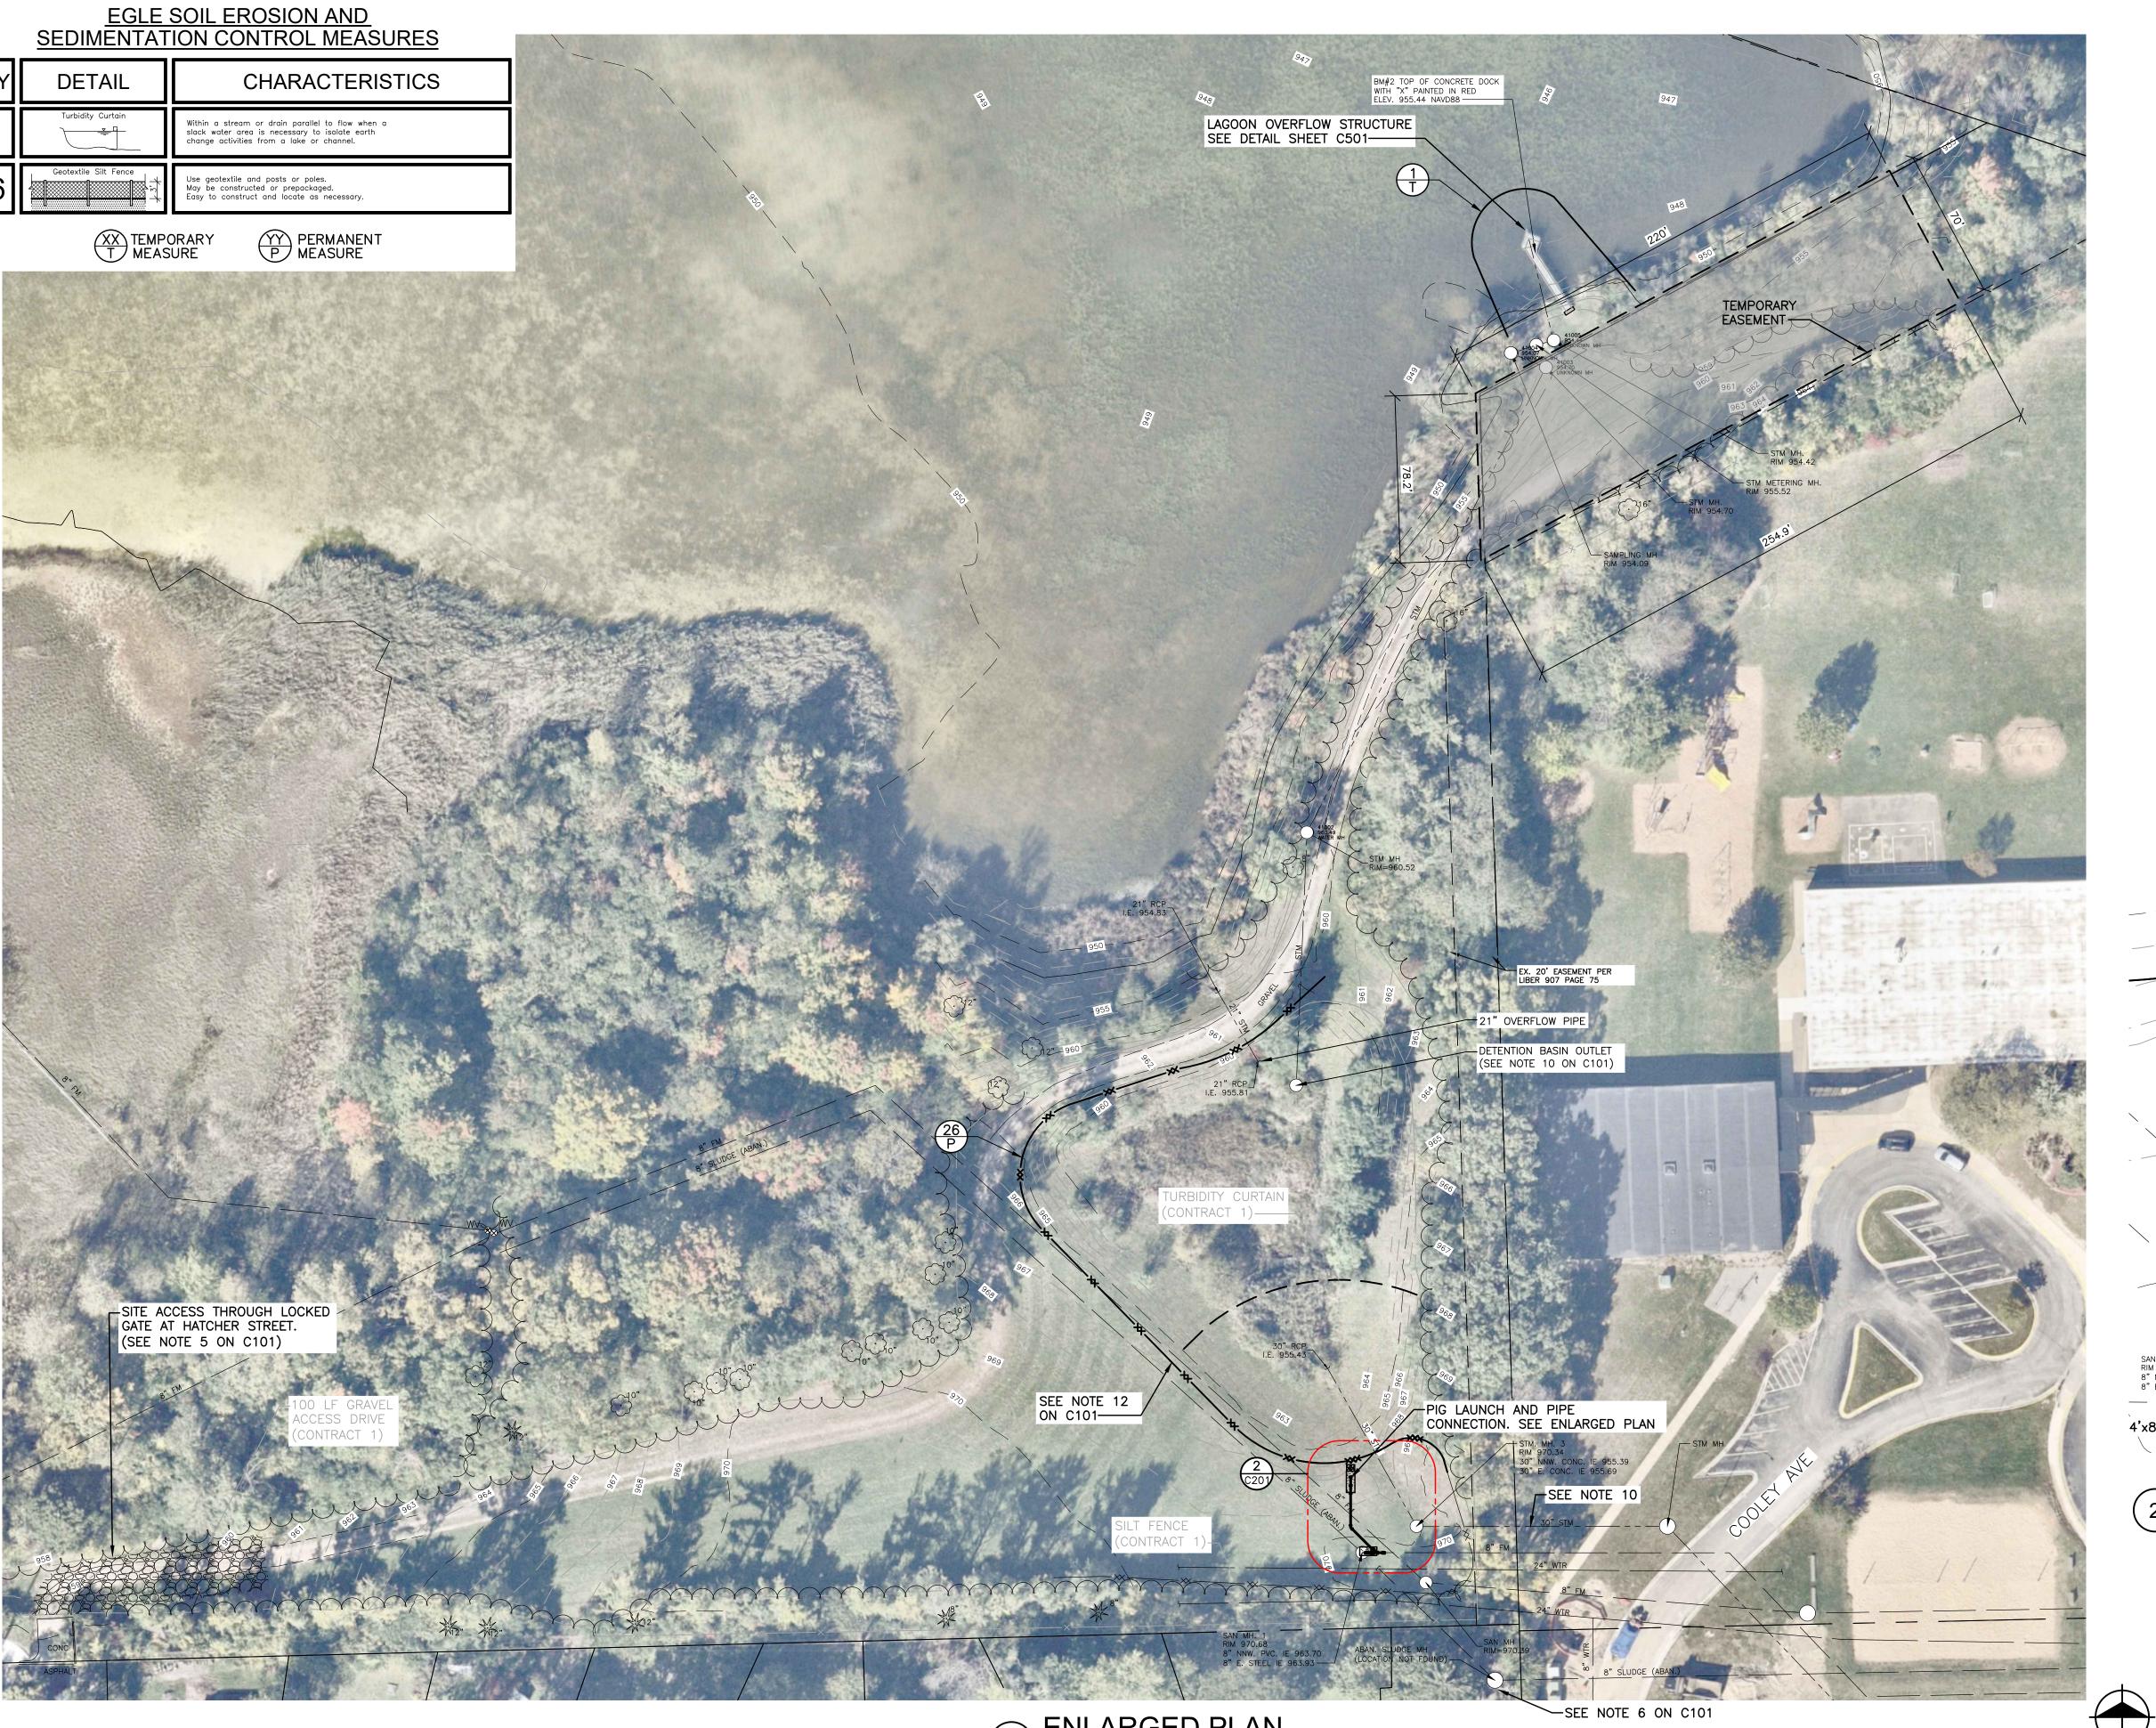The Turbidity Curtain shall be installed at the location shown on the plans and according to the special provision. The Turbidity Curtain shall be placed parallal to the direction of flow and anchored upstream, downstream, and to the

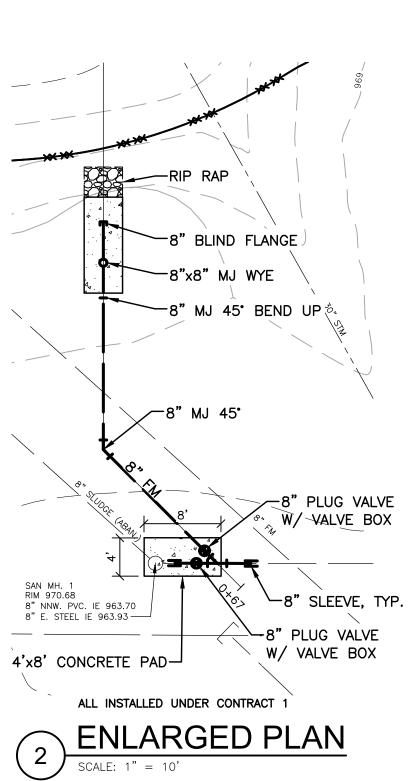The Contractor shall maintain the Turbidity Curtain until the construction activity within the watercourse is camplete or as approved by the Engineer. Retained sediment shall be removed to the maximum extent practicable prior to removing

Optional Measures: The Turbidity Curtain may include a re-directional barrier on the upstream and of the work area.

Related SESC Measuress

stream bed to maximize protection to the watercourse.

E & S-18 Dewotering with Filter Bog

Measurement and Payments

E & S-34 Cofferdom


Turbidity Curtoin requires inclusion of the appropriate special provision in the contract documents, Payment includes furnishing and installing sufficient onchors, tie-dawns, ar other mechanisms to ensure proper position and performance of the Turbidity Curtoin Optional work shown, when installed and maintained as directed by the Engineer, will be poid using the associated contract item listed here.

Contract Item (Pay Item) Turbidity Curtain (Shallow)

<u>Pay Unit</u>

Turbidity Curtain E&S-1-A PLAN DATE

MICHIGAN DEPARTMENT OF TRANSPORTATION BUREAU OF HIGHWAY DEVELOPMENT SESC DETAIL FOR

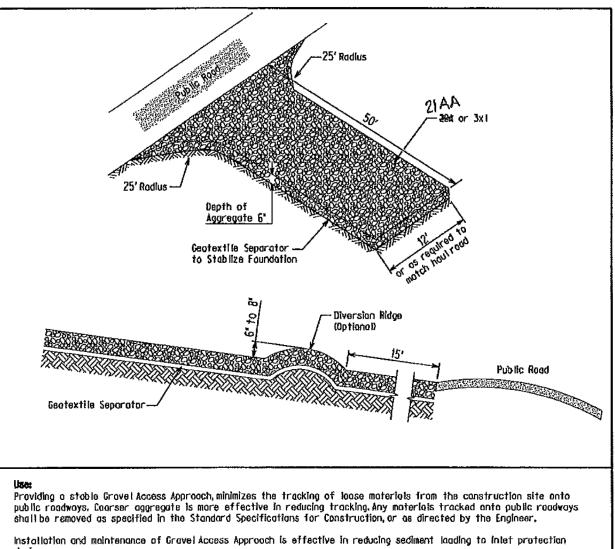

The Gravel Access Approach should be located in accordance with the plans or as directed by the Engineer. All vegetation and other objectionable material shall be ramoved from the foundation area. Geotextile Separator must be placed beneath the aggregate to stabilize the foundation.

Replace or replanish aggregate if it is no longer preventing tracking.

A Grayel Access with Diversion Ridge is recommended where occess grade exceeds 2%. This will also old in dislodging soil

Related SESC Measuress


Measurement and Payments


Optional work shown, when installed and maintained as directed by the Engineer, will be included in the Item Gravel Access Approach

Contract (tem (Pay Item) Erosian Control, Gravel Access Approach

MICHIGAN DEPARTMENT OF TRANSPORTATION BUREAU OF HIGHWAY DEVELOPMENT SESC DETAIL FOR <u>Pay Unit</u>

Gravel Access Approach 04-07-2005 E&S-14-PLAN DATE

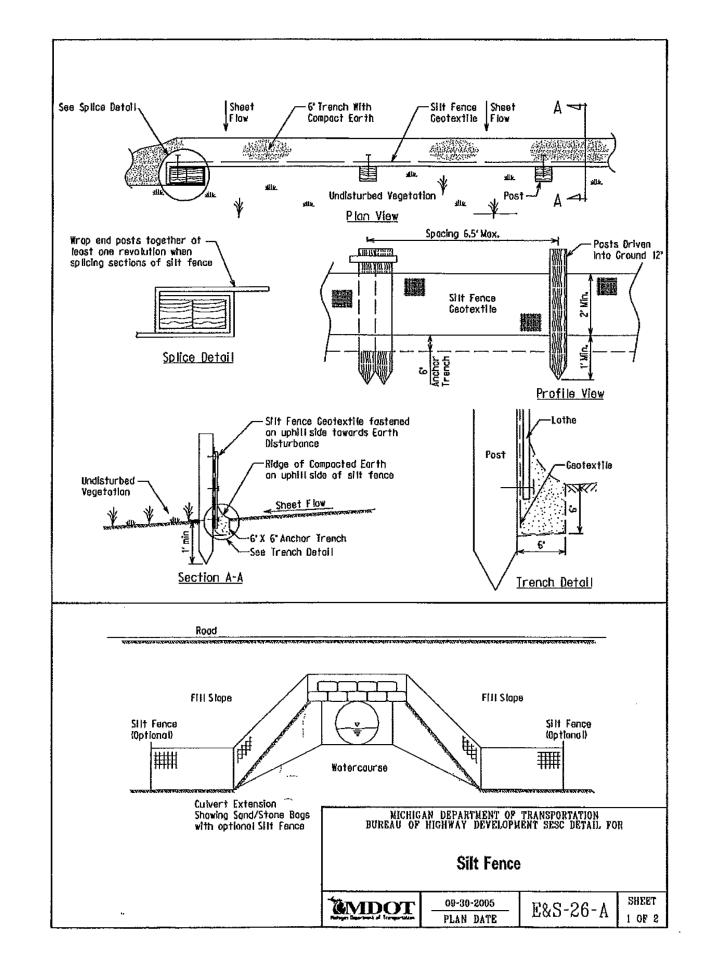

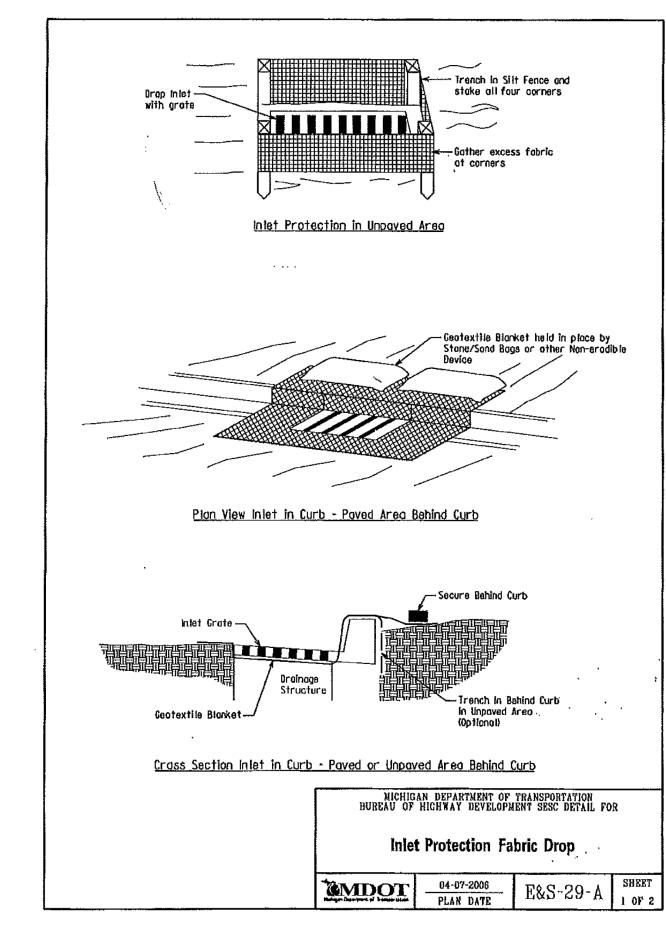


NOTES

- 1. DETAILS ARE PROVIDED FOR PROPOSED AND EXISTING SESC BMP'S LEFT IN PLACE FROM CONTRACT NO. 1. SESC BMP'S LEFT IN PLACE FROM CONTRACT NO. 1 THAT ARE TO BE RE-USED IN CONTRACT NO. 2 SHALL BE MAINTAINED THROUGHOUT THE COURSE OF THE CONTRACT. ALL SESC BMP'S SHALL BE REMOVED BY CONTRACTOR UPON COMPLETION OF CONTRACT 2.
- 2. CONTRACTOR SHALL REMOVE ALL INLET PROTECTIONS LOCATED WITHIN CITY STREETS UPON THE COMPLETION OF THE TRUCKING PORTION OF THE PROJECT.
- 3. CONTRACTOR SHALL ANCHOR TURBIDITY CURTAIN TO PROVIDE PROTECTION ENTIRELY AROUND THE EXISTING OVERFLOW STRUCTURE. CONTRACTOR SHALL CHECK THE SECURITY OF THE INSTALLATION BEFORE AND AFTER ANY STORM EVENTS.

FIBERGLASS GRATING OPERATING NUT ELEV. 955.61 (F.M) ELEV. 954.51 INTERMEDIATE SUPPORT W/S.S. MOUNTING HARDWARE - GALV. STEEL OPERATING T/ICE (FEB 2008) ELEV. 950.7± T/WATER ELEV. - #5 • 10" E.W. E.F. - 18" S.S. KNIFE GATE VALVE (VICTAULIC OR GROOVED) 949.98 (F.M.) NON-SHRINK GROUT AND WATERPROOFING (TYP.) T/SLUDGE ELEV. 949.3: T/CONC. ELEV. 949.0 (F.M.) - 18" D.I. STORM PIPE WITH GROOVED END EMBEDDED FLUSH -INV. ELEV. 945.87 (F.M.) #4 TIES @ 12" 18" THICK CONCRETE— WALLS W/ #5 E.W./E.F. © 10" O.C. (TYP. 3 - 6A STONE (SEE DETAIL) T/ EXISTING CONCRETE ELEV. 943.53 (F.M.) - FILLED WITH 4,000 PSI, AIR ENTRAINED FIBER REINFORCED CONCRETE. T/SLAB ELEV. 945.45 (F.M.) #5 0 10" O.C. W/ 7" EMBED. T/SLAB ELEV. 939.97 EXISTING 8" D.I. STORM SEWER (I.E. 940.85) FOR INFORMATIONAL PURPOSES ONLY -EXISTING 21" RCP STORM SEWER (BEHIND)

LAGOON OVERFLOW WEIR STRUCTURE DETAIL

- FIBERGLASS STOP LOGS ARE TYPICALLY INSTALLED TO ELEVATION 952.00 ON THE WEST AND NORTH SIDE OF THE OVERFLOW AND ELEVATION 951.00 ON THE EAST SIDE. TO AVOID OVERFLOWS, CONTRACTOR SHALL MAINTAIN THE WATER SURFACE LEVEL IN THE LAGOON AT LESS THAN 952.00.
- THE 18" KNIFE GATE VALVE SHOULD REMAIN CLOSED DURING DREDGING, COORDINATE THE OPENING OF THE VALVE IF WET WEATHER MAY THREATEN TO INCREASE THE WATER LEVEL IN THE POND ABOVE 952.00.
- TO AVOID ANY CONTAMINATED SPILLS DURING CONSTRUCTION, CONTRACTOR TO WRAP THE OVERFLOW WITH GEOTEXTILE FABRIC BETWEEN ELEVATIONS 948.00 AND 954.00. FABRIC WRAP TO BE A MINIMUM OF TWO LAYERS THICK AND OVERLAP AT ANY SEAMS. CONTRACTOR TO CHECK AND MAINTAIN THE GEOTEXTILE FABRIC WRAP AFTER RAIN EVENTS.

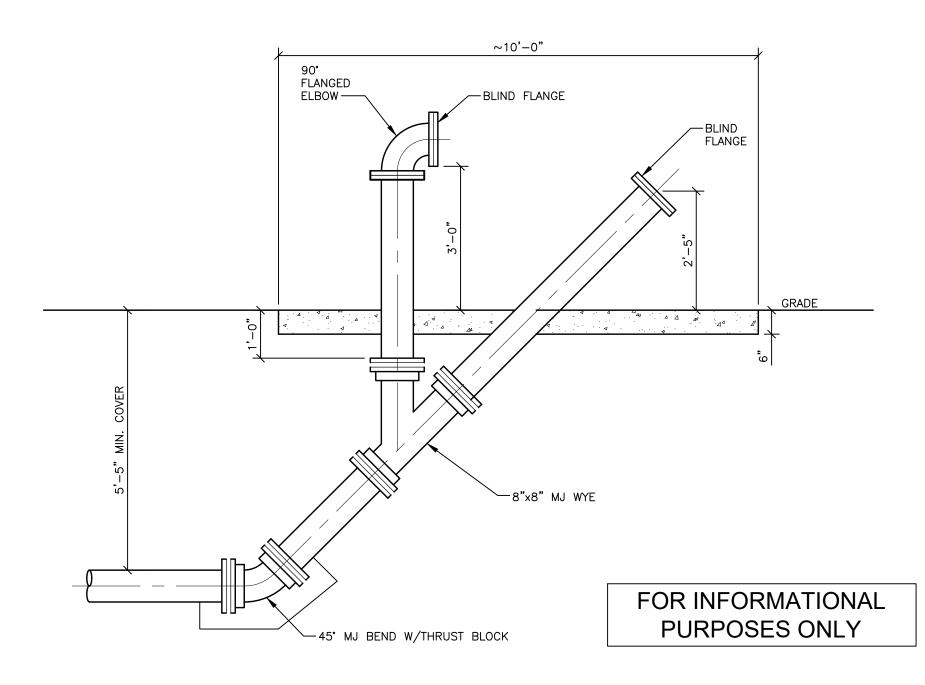

SWAB LAUNCH AND PIPE CONNECTION DETAIL NO SCALE

PIGGING NOTES:

- REMOVE CAP AND INSERT POLY-PIG SWAB.
- REPLACE CAP AND APPROPRIATE FITTINGS FOR FLUSHING AND/OR TESTING.
- USING PRESSURE PUMP, INSERT POLY-PIG SWAB INTO FORCE MAIN TO BE SWABBED. WHEN SWAB IS IN MAIN, STOP
- PUMP, MOMENTARILY, THEN BEGIN FLUSHING MAIN.
- CONTRACTOR TO ADJUST THE ORIENTATION OF THE DISCHARGE BY REALIGNING THE 90 DEGREE BEND TO SUIT THEIR OPERATIONS. CONTRACTOR TO FURNISH ALL FITTINGS TO WORK WITH THEIR PUMPING AND TESTING EQUIPMENT. UPON COMPLETION OF THE WORK, AND ALL FLUSHING OF THE FORCE MAIN IS COMPLETE THE CONTRACTOR SHALL PUMP WATER OUT OF THE STAND PIPES TO A MINIMUM 5 FEET BELOW GRADE AND REINSTALL THE BLIND FLANGES.

3/25/2025 BIDS & CONSTRUCTION

REVISIONS

Hauling

and

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Drawn By

Designer Reviewer Manager

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City of Ann Arbo

e Residual Removal Dredging and Hauling

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Drawn By jreyes

Reviewer krostrowski

Manager jsiwek

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