
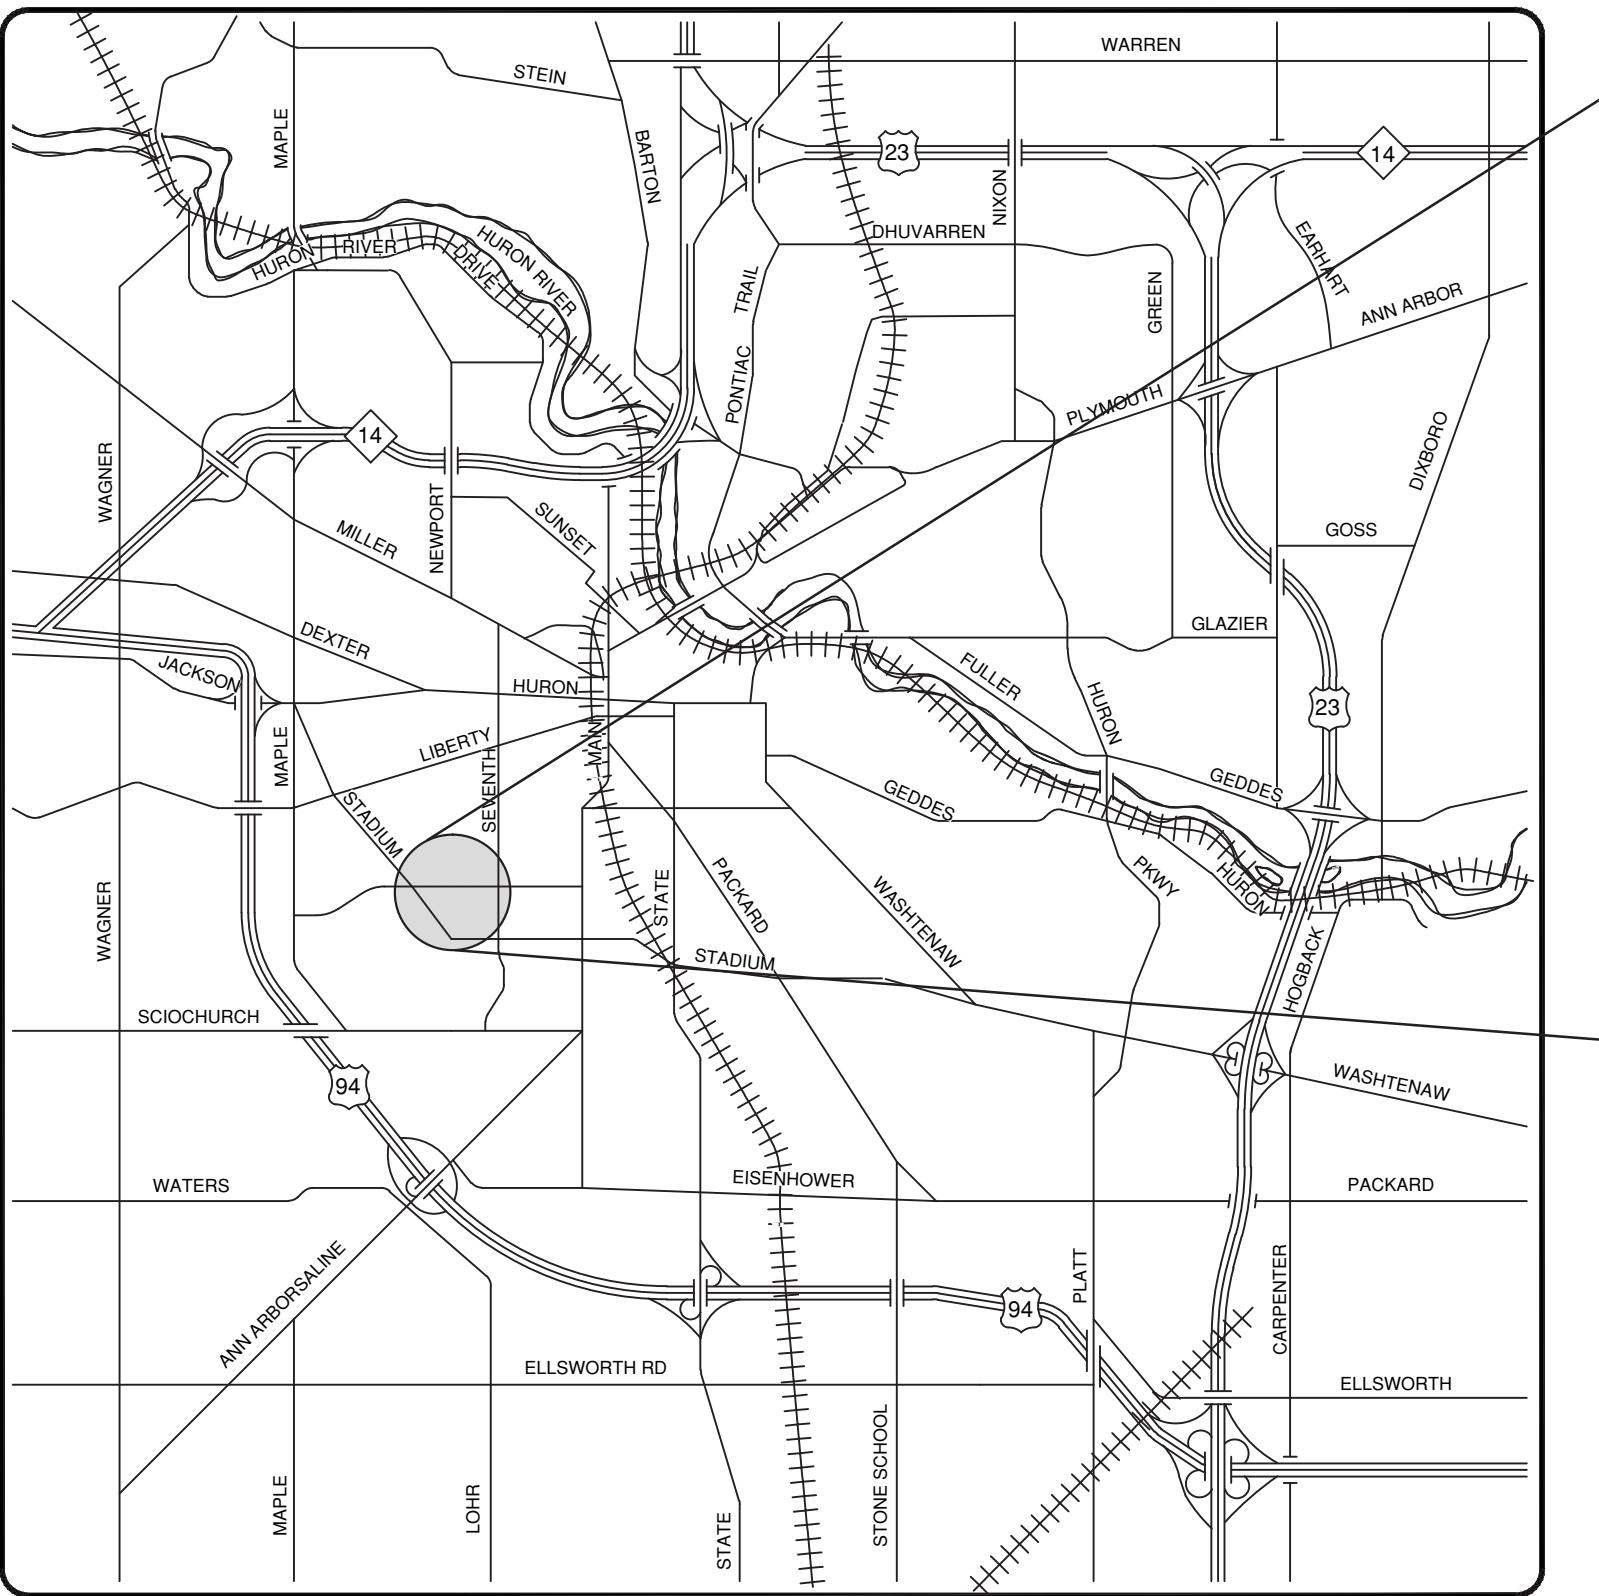


# CITY OF ANN ARBOR PROJECT MANAGEMENT


## HEWETT DR, RUSSELL RD, RUSSETT RD & REDEEMER AVE WATER MAIN REPLACEMENT

BID No. 4378, FILE No. 2013034

SHEET LIST TABLE	
SHEET NUMBER	SHEET TITLE
1	COVER SHEET
2	NOTES
3	LEGEND
4	ROAD SECTION AND TRENCH DETAIL
5	OVERALL UTILITY SHEET
6-9	REMOVALS
9-25	WATER MAIN PLAN & PROFILE
26-29	ROAD PLAN & PROFILE

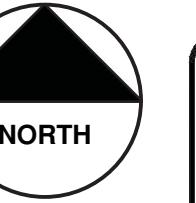

VICINITY MAP

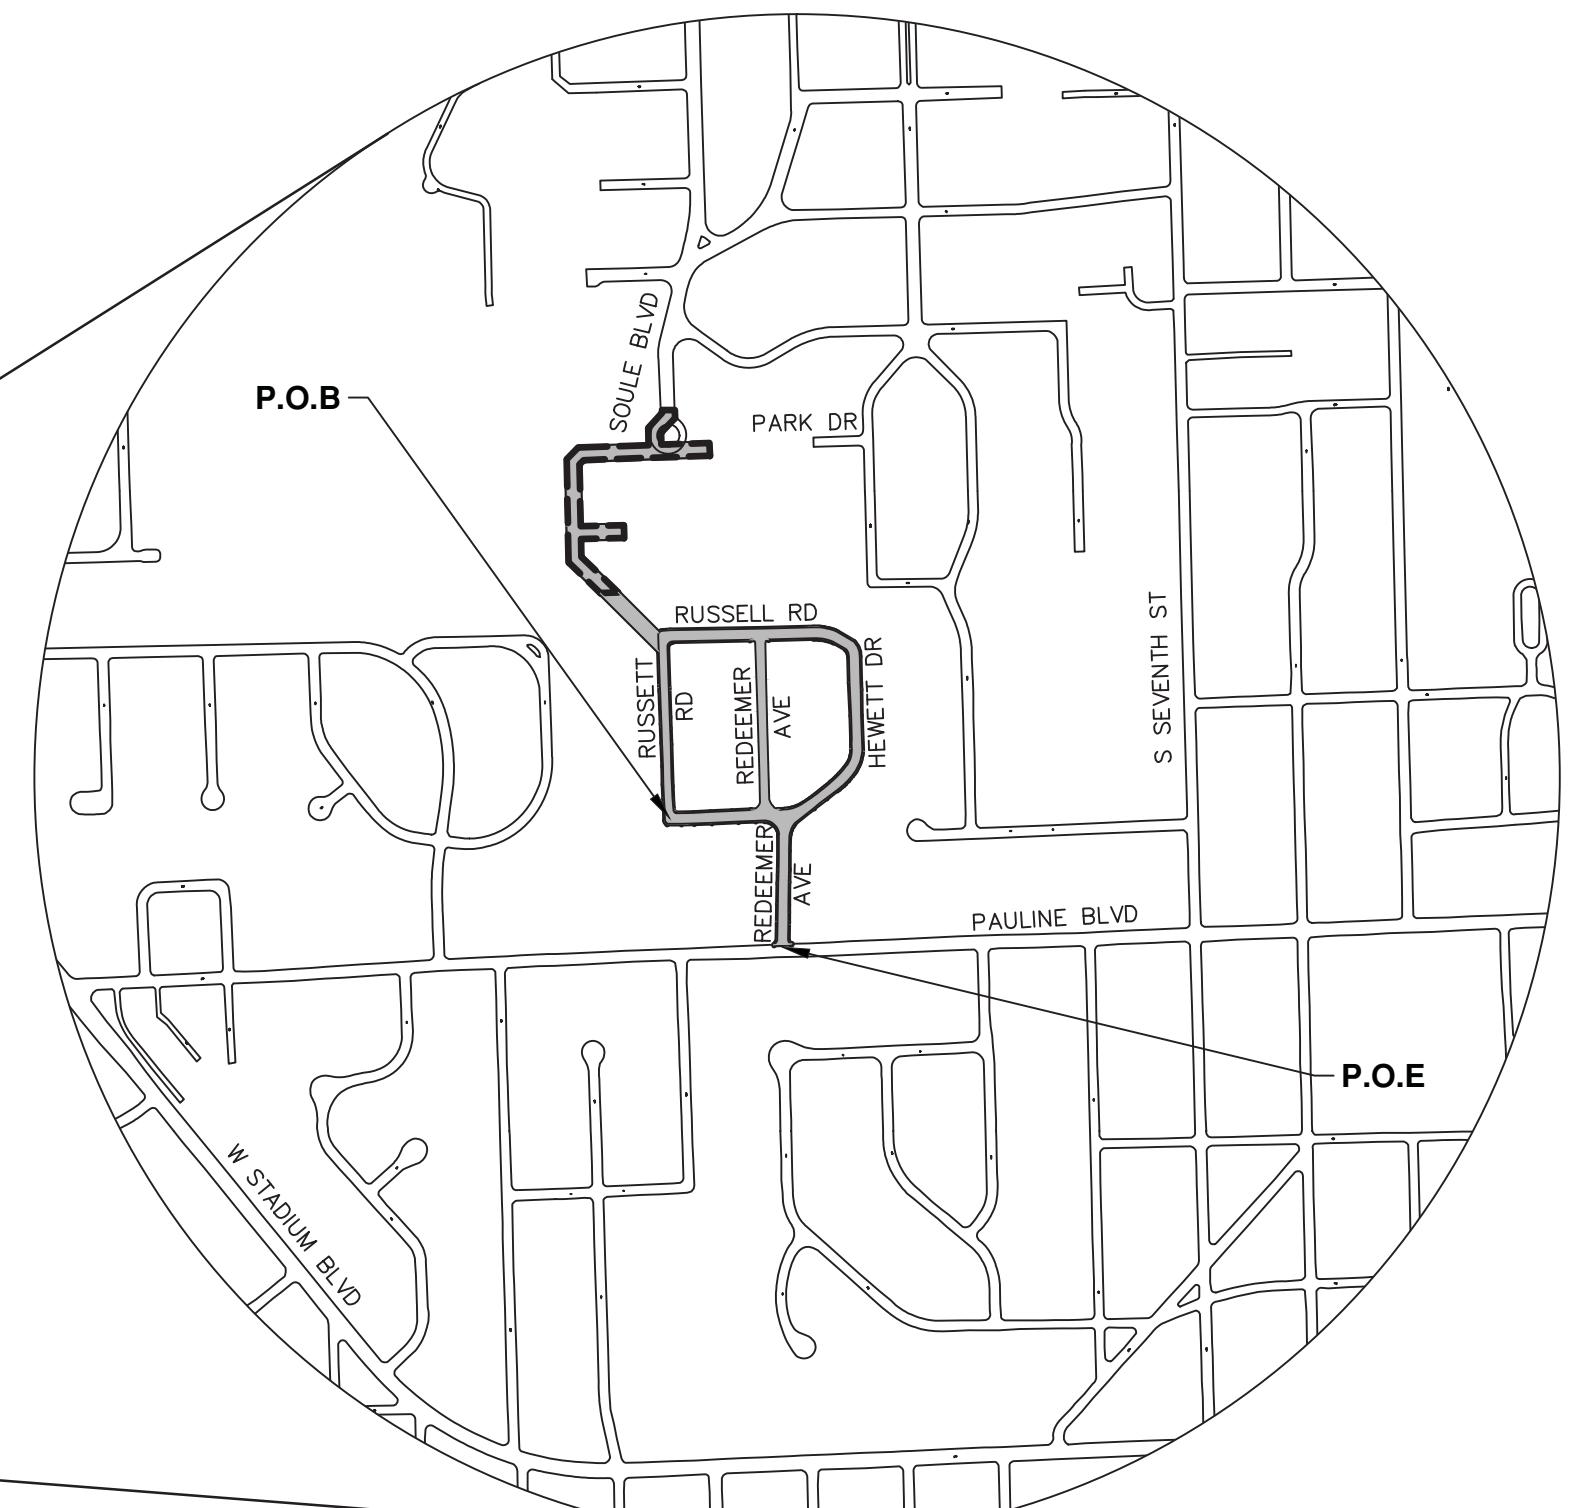

PROJECT MANAGEMENT SERVICE UNIT	
PREPARED UNDER THE SUPERVISION OF	
 David Arthur Dykman, P.E. MI LICENSE No. 52912 PROJECT MANAGER	
DRAWING No.	05 / 01 / 2015
DATE	05 / 01 / 2015



NOTES

FOR PROTECTION OF UNDERGROUND UTILITIES AND IN CONFORMANCE WITH PUBLIC ACT 53, THE CONTRACTOR SHALL CALL 811 OR 1-800-482-7171 A MINIMUM OF THREE FULL WORKING DAYS, EXCLUDING SATURDAYS, SUNDAYS, AND HOLIDAYS, PRIOR TO BEGINNING EACH EXCAVATION IN AREAS WHERE PUBLIC UTILITIES HAVE NOT BEEN PREVIOUSLY LOCATED. MEMBERS WILL THUS BE ROUTINELY NOTIFIED. THIS DOES NOT RELIEVE THE CONTRACTOR OF THE RESPONSIBILITY OF NOTIFYING UTILITY OWNERS WHO MAY NOT BE A PART OF THE "MISS DIG" ALERT SYSTEM.

THE UNDERGROUND LOCATIONS SHOWN FOR NATURAL GAS, TELEPHONE, ELECTRICAL POWER, CABLE TV AND FIBER OPTIC LINES ARE APPROXIMATE. THE CITY OF ANN ARBOR ASSUMES NO RESPONSIBILITY FOR THEIR ACCURATE REPRESENTATION IN THIS DRAWING. MISS DIG MUST BE CONTACTED PRIOR TO CONSTRUCTION TO LOCATE THESE UTILITIES.

THE IMPROVEMENTS COVERED BY THESE PLANS SHALL BE PERFORMED IN ACCORDANCE WITH THE MICHIGAN DEPARTMENT OF TRANSPORTATION 2012 STANDARD SPECIFICATIONS FOR CONSTRUCTION (INCLUDING REFERENCED M.DOT PUBLICATIONS) AND THIS PROJECT'S CONTRACT DOCUMENTS. THE OMISSION OF ANY CURRENT STANDARD DETAIL DOES NOT RELIEVE THE CONTRACTOR FROM THIS REQUIREMENT.

Know what's below.  
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811

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REV.	DESCRIPTION	DATE	DRAWN	CHECKED
03	ADDITION 1	05/01/15	JKA	DAD
02	POST-MODE 2015 REVIEW	05/18/15	JKA	DAD
01	EBERWHITE EXTENSION	02/26/15	CEC	DAD
00	MDEQ PERMIT REVIEW COMMENTS	07/22/14	ES-DPF	DAD



PROJECT DESCRIPTION AND LIMITS

PROJECT DESCRIPTION

PROJECT LIMITS

PROJECT MANAGEMENT - PUBLIC SERVICES - CITY OF ANN ARBOR

SHEET No.

1 TO 30

**CONSTRUCTION SEQUENCE:**

The Contractor shall review the Traffic Maintenance Plans of the Contract Documents and note that they are required to maintain access at all times to residences solely accessed off of Yellowstone Dr. Leave 10 feet of existing pavement for access road during utility installation, final removal limits of pavement as directed by Engineer. The driveways are to be maintained at all times. During crossing of drives with utilities and road building, residents must be notified by the contractor at least a day in advance so vehicles can be moved prior to the closure. Drives are to be temporarily put back as soon as possible, and opened for resident use at the end of each day. The Contractor may choose to adjust the limits or sequencing of construction in order to complete the work more efficiently. However, changes to the stages and phases shown in the plans must be approved in writing by the Engineer prior to construction and must assure that access is maintained as described above.

1. Installation of traffic control devices, and maintenance of traffic plan. Installation of portable, changeable message signs with messages as directed by the Engineer one week prior to construction. Installation of Soil Erosion Control Devices.
2. Removal of pavement and concrete items on east side leaving a minimum of 10 feet of existing pavement for access lane on the side detailed on Maintenance of Traffic Plan or as directed by Engineer. Access lane to be open and free of obstructions at end of each day.
3. Install 8 inch water main.
4. With passing pressure test, schedule and make connection of 8" main to existing 8" main. With placement of aqua swab during water main placement flush and remove 8 inch swab from water main.
5. Test water main per City Detailed Specification for Water Main Testing.
6. Once bacteriological samples have passed schedule with Field Operations and transfer water services to new 8" Water Main.
7. Schedule and finish the remaining water main connections and abandon the old main.
8. Place edge drain and construct road cross section for east half of road. Proposed aggregate base will be used as access road during storm placement. Aggregate base will be ramped at driveways and be maintained at all times. Any areas of base that become contaminated or deficient will be removed and replaced as directed by Engineer.
9. Removal of hma and concrete items on west side of Yellowstone. Install storm sewer improvements as indicated on plans. Clean and video inspect storm per City of Ann Arbor Standards.
10. Finish installation of road cross section and edge drain on west half of Yellowstone. This work is to take place behind storm sewer installation.
11. Grade aggregate base for curb, prep driveways and sidewalk and install concrete items on both sides of street. Pre pour meeting required to discuss resident parking during cure time. Drive approaches to be placed same day as curb or no later than next day. Only one side of sidewalk to be removed and replaced at a time. Pedestrian traffic to be maintained on one side of Yellowstone at all times.
12. Topsell, seed and install mulch blankets at all disturbed areas.
13. Fine grade aggregate and place hma leveling course.
14. Adjust structures in road to finish grade.
15. Schedule and pave wearing course.
16. Place permanent pavement markings
17. Remove soil erosion control and construction signage. Open road to normal traffic.

**SOIL EROSION CONTROL NOTES:****GENERAL**

1. The contractor shall implement and maintain the soil erosion control measures as shown on the plans at all times during construction on this project. Any modifications or additions to the soil erosion control measures due to construction or changed conditions shall be complied with as required or directed by the owner, project engineer, or the City of Ann Arbor. The contractor is required to obtain a Soil Erosion Control Permit anytime the disturbed area exceeds 1 acre.
2. All soil erosion and sedimentation control work shall conform to the permit requirements of the City of Ann Arbor, Chapter 63, and the laws of the State of Michigan.
3. Daily or after storm events inspections shall be made by the contractor. Periodic inspections may be made by the owner/project engineer to determine the effectiveness of erosion and sedimentation control measures. Any necessary corrections shall be made without delay, and without additional cost to the Owner.
4. Erosion and sedimentation from work on the site shall be contained on the site and not be allowed to collect on any off-site areas or waterways.
5. All mud/dirt tracked onto roads from the site due to construction, shall be promptly removed by the contractor. If so ordered, the Contractor shall employ a mechanical street sweeper at no additional cost to the Owner.
6. Restoration of all disturbed areas, including placement of topsoil, seed, fertilizer and mulch and/or sod shall be done within 5 days of the completion of final grade.
7. Construction operations shall be scheduled and performed so that preventative soil erosion control measures are in place prior to excavation in critical areas and temporary stabilization measures are in place immediately following backfilling operations.
8. Special precautions will be taken in the use of construction equipment to prevent situations that promote erosion.
9. Proper dust control shall be maintained during construction by use of water trucks and/or chloride as required or as directed by Engineer.
10. The contractor shall be responsible for maintaining all temporary soil erosion control measures and removal of same upon authorized completion of the project. Completion of project will not be authorized until all site work and utility construction is complete and all soils are stabilized.
11. The contractor shall not grade into adjacent properties. Silt fence shall be installed and maintained to prevent grading, erosion and sedimentation into them.
12. Tree protection fencing must remain intact until restoration of the site is complete.
13. Sequence of Erosion Control Measures:

  - I. Install silt fence, tree protection fencing and inlet filters on existing storm inlets prior to any clearing or earth moving operation.
  - II. Install inlet filters immediately following installation of proposed storm drainage system.
  - III. Contractor to continually maintain erosion and sedimentation control measures, as required to allow drainage and sediment removal. Remove any accumulated sediment.
  - IV. Strip and clear – maintain erosion control measures around temporary stock piles.
  - V. Rough grade
  - VI. Install stormwater management system.
  - VII. Connect stormwater management system.

STORM SEWER STRUCTURE TABLE							
STRUCTURE	UTILITY STATION	ALIGNMENT	INVERT ELEVATION, SIZE & DIRECTION	TOP OF CASTING ELEVATION	DEPTH (Feet)	SIZE	APPLICATION/CONSTRUCTION
88-62696	5+34-20.6 LT	Pauline	12° E 927.18	930.68	5.50	24" Dia.	CB
88-62697	5+63 17.4 RT	Pauline	12° N 928.33	930.83	4.50	24" Dia.	CB
88-62741	6+89-16.4 LT	Redeemer	12° W 905.72	908.57	4.85	24" Dia.	CB
88-62742	6+58 29.4 RT	Redeemer	12° NE 904.04	908.04	6.00	24" Dia.	CB
88-62743	3+12 16.3 RT	HEWETT	12° NE 904.88	908.88	6.00	24" Dia.	CB
88-62744	2+93-19.2 LT	HEWETT	12° SE 905.16	909.26	6.10	24" Dia.	CB
88-62745	5+29 17.2 RT	Redeemer	12° S 906.43	910.03	5.60	24" Dia.	CB
88-62746	5+39-24.5 LT	Redeemer	12° SW 905.21	910.16	6.95	24" Dia.	CB
88-62747	3+95-15.9 LT	HEWETT	12° S 903.82	907.72	5.90	24" Dia.	CB
88-62748	10+07-18.3 LT	RUSSELL	12° N 898.43	902.93	6.50	24" Dia.	CB
88-62749	9+79 14.4 RT	RUSSELL	12° SE 898.40	902.70	6.30	24" Dia.	CB
88-62750	7+70-15.5 LT	RUSSELL	12° NW 898.08	901.78	5.70	24" Dia.	CB
88-62751	7+68 16.1 RT	RUSSELL	12° NE 897.72	901.82	6.10	24" Dia.	CB
88-62752	6+37 15.5 RT	RUSSELL	12° E 901.74	904.84	5.10	24" Dia.	CB
88-62753	6+36-16.4 LT	RUSSELL	12° SW 901.27	904.97	5.70	24" Dia.	CB
88-62754	0+32-14.1 LT	Redeemer	12° N 912.06	915.86	5.79	24" Dia.	CB
88-62755	0+31 14.6 RT	Redeemer	12° NE 911.82	916.12	6.30	24" Dia.	CB
88-62756	2+98 16.0 RT	RUSSELL	12° E 911.72	915.72	6.00	24" Dia.	CB
88-62757	3+22-15.6 LT	RUSSELL	12° SE 910.84	915.14	6.30	24" Dia.	CB
88-62758	0+11-0.7 LT	RUSSELL	12° E 914.56	919.99	7.43	24" Dia.	CB
88-62759	0+56-11.9 LT	Russett	12° N 914.66	921.16	8.50	24" Dia.	CB
88-62760	5+37-14.2 LT	Russett	12° S 914.49	919.99	7.50	24" Dia.	CB
88-62761	0+14 1.5 RT	HEWETT	12° E 913.51	918.81	7.30	24" Dia.	CB
92-52679	7+34-121.9 LT	RUSSELL	30° W 886.66	901.66	15.00	48" Dia.	MH
92-52681	7+56 7.6 RT	RUSSELL	30° S 891.62 12° SW 897.24 12° SE 897.34 12° N 894.47 30° NE 891.62	902.34	10.72	48" Dia.	MH
92-52682	9+86-6.3 LT	RUSSELL	30° SW 893.19 12° S 897.29 12° NW 897.79 30° N 893.14	903.07	9.93	48" Dia.	MH
92-52683	12+27-4.9 LT	RUSSELL	30° W 898.15 30° NE 898.15	906.92	8.77	48" Dia.	MH
92-52684	3+94 5.3 RT	HEWETT	12° S 900.23 30° W 898.91 12° SW 902.76 12° N 903.11 30° E 898.86	908.26	9.40	48" Dia.	MH
92-52685	10+27-6.0 LT	Redeemer	12° W 926.17 12° S 926.24 12° N 922.77	930.96	8.19	48" Dia.	MH
92-52686	6+89-6.1 LT	Redeemer	12° S 902.07 12° E 905.01 12° N 902.02	909.12	7.10	48" Dia.	MH
92-52687	0+35 4.6 RT	RUSSELL	12° E 911.81 12° S 913.14 12° W 911.91	920.24	8.43	48" Dia.	MH
92-52688	3+35 4.8 RT	RUSSELL	12° E 907.01 12° S 910.51 12° SW 909.81 12° W 899.81 12° W 910.01 12° W 907.11	915.31	8.30	48" Dia.	MH
92-52689	5+26 4.0 RT	RUSSELL	12° SE 898.73 12° W 898.63	907.78	9.15	48" Dia.	MH
92-52690	5+95 6.1 RT	RUSSELL	12° SE 897.65 12° NW 897.75	906.15	8.50	48" Dia.	MH
92-52691	6+48 4.5 RT	RUSSELL	12° S 896.56 12° NE 899.91 12° NW 896.61 12° W 899.81	904.91	8.35	48" Dia.	MH
92-52698	0+35 5.5 RT	HEWETT	12° W 912.15 12° N 912.05 12° E 910.76	918.25	7.49	48" Dia.	MH
92-52699	0+93 5.6 RT	HEWETT	12° W 907.00 30° E 906.28 24° SW 906.48	915.05	8.77	48" Dia.	MH
92-52730	3+20 5.6 RT	HEWETT	30° W 900.76 12° SW 903.51 12° NW 903.41 12° N 903.21 12° NE 903.31 30° E 903.71	909.21	10.50	48" Dia.	MH
92-56371	10+91-20.8 LT	Eberwhite	12° SE 908.55 12° N 908.50	916.30	9.80	48" Dia.	Eccentric Cylindrical Structure
r(34)	5+04 89.6 RT	Eberwhite	12° NW 921.84 12° E 922.24	926.39	5.55	24" Dia.	Eccentric Cylindrical Structure
r(35)	5+06 107.9 RT	Eberwhite	12° W 922.70	925.00	4.30	24" Dia.	Eccentric Cylindrical Structure
r(36)	6+77-94.2 LT	Eberwhite	12° S 914.82	917.82	5.00	24" Dia.	Cylindrical Structure Slab Top Circular Frame

PERMITS REQUIRED TO BE OBTAINED BY THE CONTRACTOR PRIOR TO THE BEGINNING OF CONSTRUCTION.	
PERMIT	ISSUING AUTHORITY
LANE CLOSURE PERMIT	CITY OF ANN ARBOR PROJECT MANAGEMENT UNIT
"NO PARKING" SIGNS PERMIT	CITY OF ANN ARBOR PROJECT MANAGEMENT UNIT
GRADING/SOIL EROSION & SEDIMENTATION CONTROL PERMIT	CITY OF ANN ARBOR CUSTOMER SERVICE
RIGHT-OF-WAY PERMIT	CITY OF ANN ARBOR CUSTOMER SERVICE

\* NO COST TO CONTRACTOR

PERMIT	ISSUING AUTHORITY
M.D.E.Q. WATER MAIN CONSTRUCTION PERMIT	MICHIGAN DEPARTMENT OF ENVIRONMENTAL QUALITY
ADENDUM 1	DAN WOODEN (734) 794-6350
POST MODEQ 2015 REVIEW	MARK COZART (734) 794-6350
EBERWHITE EXTENSION 01	KEVIN ERNST (734) 794-6350
MDQ PERMIT REVIEW COMMENTS 00	STEVEN GOEBEL (734) 794-6350
REV.	CHUCK FOJTK (734) 794-6361

PERMIT	ISSUING AUTHORITY




<tbl\_r cells="2" ix="4" maxcspan="1" maxrspan

BM #	ELEV	DESCRIPTION
1	932.790	RR spike in N side of LP on S side of Pauline and Redeemer
2	922.330	RR spike in W side of LP on E side of Redeemer between house numbers 1027&1015
3	910.790	RR spike in N side of LP on S side of Hewitt @ CL of Redeemer extended from the North
4	912.910	RR spike in N side of LP on S side of Hewitt on the E side of driveway for HSE # 1401
5	924.510	RR spike in W side of LP on E side of Russett, 100' N of CL Hewitt
6	926.980	RR spike in W side of LP on E side of Russett between House #813 & 819
7	922.960	RR spike in E side of LP @ NW corner of Russett & Russell
8	916.330	RR spike in S side of LP on N side of Russell & Redeemer
9	907.830	N Rim on Storm MH @ CL of Russell in front of HSE #1210
10	904.930	N Rim of Storm MH @ CL of Russell in front of HSE #801
11	903.530	RR spike in E side of LP on W side of Russell between HSE #814 & 820
12	904.910	RR spike in NW side of LP on E side of Russell @ HSE #831
13	916.320	RR spike in W side of LP on E side of Redeemer between HSE #845 & 835
14	924.380	RR spike in W side of LP on E side of Redeemer between HSE #801 & 811

### CONSTRUCTION NOTES:

1. Driveways and entrances to buildings, real property, and the like shall not be blocked unless approved by the Engineer. Vehicular and pedestrian access shall be maintained at all times. It shall be the Contractor's responsibility to coordinate all necessary driveway closures with the property owner(s) and resident(s) in the areas of construction.
2. The location and depth of all existing utilities and service leads are to be field verified by the Contractor prior to construction.
3. Location and depth of utilities as depicted on the plans is approximate and shown according to the best information available. It is the Contractor's responsibility to excavate ahead and adjust depth of conflict utilities accordingly. Damage to utilities is the Contractor's responsibility to avoid and/or repair as necessary.
4. The Contractor is to take special care to protect the existing water main and is responsible for maintaining consistent water service.
5. During non-working hours no trench shall remain open-unless approved by the Engineer; any open trench shall be properly secured with protective fencing. This work shall be included in the item of work "General Conditions".
6. Trenches for transferring water services shall be excavated to MIOSHA and City of Ann Arbor Field Services requirements.
7. City of Ann Arbor Field Services will install the corporation and copper service lead(s) to transfer the connection(s). If an existing water service is found to be failing or is not copper, the lead will be replaced to the curb box by Field Services.
8. For the installation of corporations, or any other related activities, the Contractor shall not receive additional compensation for delays due to the scheduling of or coordination with the City of Ann Arbor Field Services.
9. The Contractor shall backfill trenches in accordance with Trench Detail(s) shown on plans. This work shall be included in the item of work "Excavate and Backfill for Water Service Tap and Lead". All concrete removals and replacements required for this work will be paid for separately.
10. All ductile iron pipe and fittings shall be polyethylene wrapped per ANSI/AWWA C105/A21.5.
11. Cor-blu bolts to be used at all mechanical water main joints at hydrants and Megalug fittings.
12. When all water services are transferred the Contractor shall abandon the existing water main. Reference the Detailed Specifications for water main abandonment procedures. Caps and plugs shall be installed by the Contractor where shown on the plans and shall be included in the item of work for water main abandonment or as directed by Engineer.
13. The Contractor shall construct, flush, and bacteriologically test the water main per the Detailed Specifications and as approved by the Engineer. All chlorinated water shall be discharged directly into an approved sanitary sewer. The Contractor shall supply all necessary hoses, fittings and the like to accomplish this work.
14. Water main fittings, other than those specifically listed as separate pay items, which are required to complete the work, such as blow-off assemblies, concrete thrust blocks, solid sleeves and mechanical plugs, shall not be paid for separately, but shall be included in the pipe pay items.
15. "No Parking" signs shall be installed by the Contractor at locations as approved or directed by the Engineer. All signs shall be installed in accordance with the detailed specifications.
16. Postal delivery and refuse pickup service shall be maintained at all times by the Contractor.
17. All fittings, hydrants, valves and castings removed during construction are the property of the City of Ann Arbor. The Contractor within 48 hours shall deliver to City of Ann Arbor Field Operations and Maintenance Facility at the W.R. Wheeler Service Center located at 4251 Stone School Road.
18. Where street curbs are undermined due to construction activities, they shall be removed and replaced as directed by the Engineer.
19. The Contractor shall be responsible for the continuous maintenance of the temporary road surface and soil erosion control measures within the construction area until the full completion of the project. This work shall be included in the item of work "General Conditions".
20. All curb, sidewalk, driveway approach removals shall be approved by Engineer before the work is done.
21. Sawed sewer pipe connections shall be coupled with a Fernco flexible coupling and a stainless steel shear ring.
22. The location of material stock piles and on-site staging areas to be approved by the Engineer.

SANITARY SEWER STRUCTURE TABLE							
STRUCTURE	UTILITY STATION	ALIGNMENT	INVERT ELEVATION, SIZE & DIRECTION	TOP OF CASTING ELEVATION	DEPTH (Feet)	SIZE	APPLICATION/CONSTRUCTION
71-64446	???	???	8" E 921.98	932.43	12.45	48" Dia.	MH
71-64447	???????	???	8" W 921.00 8" E 920.95	931.20	12.25	48" Dia.	MH
71-64450	???????	???	8" W 920.71	930.71	10.00	48" Dia.	MH
71-64489	0+31-4.9 L	HEWETT	8" N 908.89 8" E 908.84	918.79	9.95	48" Dia.	MH
71-64490	0+91-4.4 L	HEWETT	8" E 903.37 8" W 905.62 8" SW 903.42	915.22	11.85	48" Dia.	MH
71-64494	3+18-5.4 L	Russett	8" S 916.31	926.41	10.10	48" Dia.	MH
71-64495	2+56-5.3 L	Russett	8" N 916.58	926.48	9.90	48" Dia.	MH
71-64496	9+21 3.7 R	Redeemer	8" N 916.35	923.80	7.45	48" Dia.	MH
71-64497	3+35-4.4 L	HEWETT	8" W 897.01 8" E 896.96 8" N 897.01	909.46	12.50	48" Dia.	MH
71-64498	3+84-4.2 L	HEWETT	8" S 896.62 10" E 895.67 8" W 895.72	908.42	12.75	48" Dia.	MH
71-64499	4+30-4.4 L	HEWETT	10" NE 894.82 10" W 894.87	907.12	12.30	48" Dia.	MH
71-64500	2+36-8.0 L	Redeemer	8" S 915.23 8" N 915.28	924.63	9.40	48" Dia.	MH
71-64501	4+19-7.9 L	Redeemer	8" S 906.31 8" N 906.36	916.06	9.75	48" Dia.	MH
71-64502	1+23-7.6 L	Redeemer	8" S 913.09 8" N 913.04	922.39	9.35	48" Dia.	MH
71-64503	9+64-9.0 L	RUSSELL	10" N 890.94 10" SW 891.04	902.94	12.00	48" Dia.	MH
71-64504	7+28-5.0 L	RUSSELL	8" N 892.68 10" E 892.60 10" S 888.48	902.78	14.30	48" Dia.	MH
71-64505	6+31-12.3 L	RUSSELL	8" NW 895.15 8" S 895.10	905.15	10.05	48" Dia.	MH
71-64506	0+29-8.5 L	RUSSELL	8" S 909.89 8" E 909.79	919.79	10.00	48" Dia.	MH
71-64507	2+40-8.2 L	RUSSELL	8" W 907.39 8" E 907.24	917.24	10.00	48" Dia.	MH
71-64508	3+36-7.9 L	RUSSELL	8" S 904.17 8" W 904.22 8" E 904.12	915.02	10.90	48" Dia.	MH
71-64509	5+43-12.9 L	RUSSELL	8" SE 897.48 8" W 897.58	907.08	9.60	48" Dia.	MH
71-64510	7+29-120.6 L	RUSSELL	10" W 887.80	900.53	12.73	48" Dia.	MH
71-67116	11+11-9.9 L	Eberwhite	8" N 904.82 8" SE 905.02	914.62	11.80	48" Dia.	Eccentric Cylindrical Structure
s-36	9+44 114.0 R	Eberwhite	8" NW 910.58 8" S 910.68	922.58	14.00	48" Dia.	Eccentric Cylindrical Structure

EXISTING LEGEND	
◊ FIRE HYDRANT	—w— WATER MAIN
GATE VALVE IN BOX	—r— STORM SEWER
⊗ GATE VALVE IN WELL	—s— SANITARY SEWER
◎ STOP BOX	—·— GAS MAIN
□ WATER VAULT	—o— ELECTRICAL OVER HEAD
● WELL	—v— ELECTRICAL UNDER GROUND
□ CATCH BASIN (SQ)	—·— BOUNDARY
● CATCH BASIN (RD)	BUILDING
○ STORM MANHOLE	—·— CENTERLINE OF DITCH
□ NON-CURB CATCH BASIN (SQ)	—·— CENTERLINE/CROWN OF ROAD
○ SANITARY MANHOLE	—·— EDGE OF WATER
○ CLEAN-OUT	—//— FENCE
● POST	—:-:— GRAVEL
◊ PEDESTRIAN SIGNAL	oooooo STONE WALL
↑ SIGN	—R.O.W.— R.O.W.
□ HAND HOLE	—TREELINE— TREELINE
⊗ ORNAMENTAL LIGHT	—WETLAND— WETLAND
※ FLOOD LIGHT	
① UNKNOWN MANHOLE	
② TELEPHONE MANHOLE	
⊗ TELEPHONE RISER	
◎ GAS VALVE	
○ GAS VENT	
■ GAS BOX	
☒ ELECTRICAL RISER	
☒ TRANSFORMER	
▢ UTILITY POLE	
○ LAMP POLE	
▼ GUY ANCHOR	
○ GUY POLE	
● MONITORING WELL	
▣ MAILBOX	
● SOIL BORING	
△ TRAVERSE POINT	
✚ BENCH MARK	
○ IRON PIPE	
▣ MON BOX	

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CITY OF ANN ARBOR PUBLIC SERVICES 301 EAST FUBB STREET ANN ARBOR MI 48105-3647 734-763-5110 www.a2gov.org		05/01/15	03/18/15	02/26/15	02/12/14
ADENDUM 1	POST MODEQ 2015 REVIEW	JKA	JKA	CEC, JKA	DAD
O2	O1	DAD	DAD	DAD	DAD
00	00	MDQ PERMIT REVIEW COMMENTS	DESCRIPTION	DATE	REV.

**PROJECT MANAGEMENT - PUBLIC SERVICES - CITY OF ANN ARBOR**

**HEWETT DR, RUSSELL RD, RUSSETT RD & REDEEMER AVE WATER MAIN REPLACEMENT**

**LEGEND**


PROPOSED LEGEND

HYDRANT (PLAN)	W ——— WATER MAIN
⊗ WATER GATE WELL	R ——— STORM SEWER
▼ REDUCER	S ——— SANITARY SEWER
WATER GATE VALVE	—·— CENTERLINE OF DITCH
○ WATER STOP BOX	—·— CENTERLINE OF ROAD
□ WATER VAULT	—//— FENCE
● INLET	□ ——— SILT FENCE
■ DOUBLE INLET	—·— Curb
● INLET JUNCTION CHAMBER	—·— TEMPORARY GRADING PERMIT
● ROUND CATCH BASIN	—·— WATER EASMENT
○ STORM MANHOLE	—·— SANITARY EASEMENT
○ CLEAN-OUT	—·— R.O.W.
● BARREL	—·— LIMITS OF CONSTRUCTION
↑ SIGN	oooooo STONE WALL
○ PUSH BUTTON	
DETECTABLE WARNING	
ASPHALT	
CONCRETE	
SIDEWALK	
TREE (DECIDUOUS)	
TREE (CONIFEROUS)	

SCALE : NTS


DRAWING No. 2013034-3

SHEET No. 3 OF 30

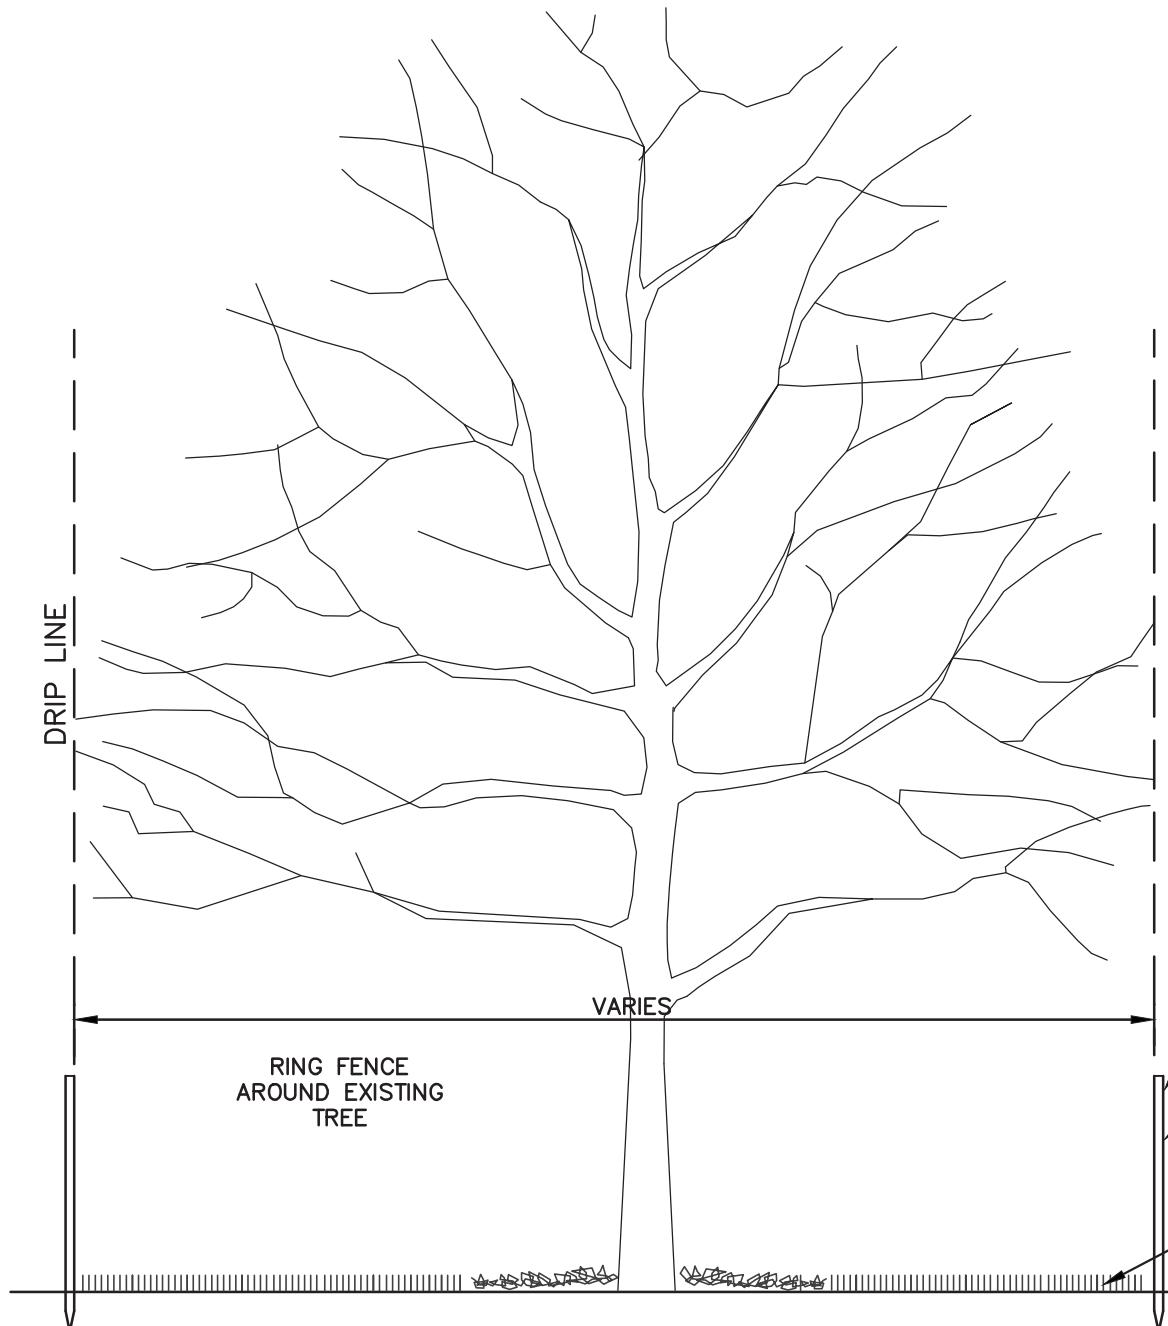

## **TREE PROTECTION DETAIL**


RUSSELL, RUSSETT, REDEEMER, & HEWETT ROADS - HMA APPLICATION ESTIMATE					
HMA MIX	RATE OF APPLICATION	THICKNESS (INCHES)	AWI (MIN.)	BINDER	LOCATION/NOTE
LVSP	220 LB/SYD	2.0	260	PG 58-28	TOP COURSE
LVSP	220 LB/SYD	2.0		PG 58-28	LEVELING COURSE
Bond Coat SS-1h	0.05-015 GAL/SYD	-	-	-	INCLUDE IN COST HMA ITEM

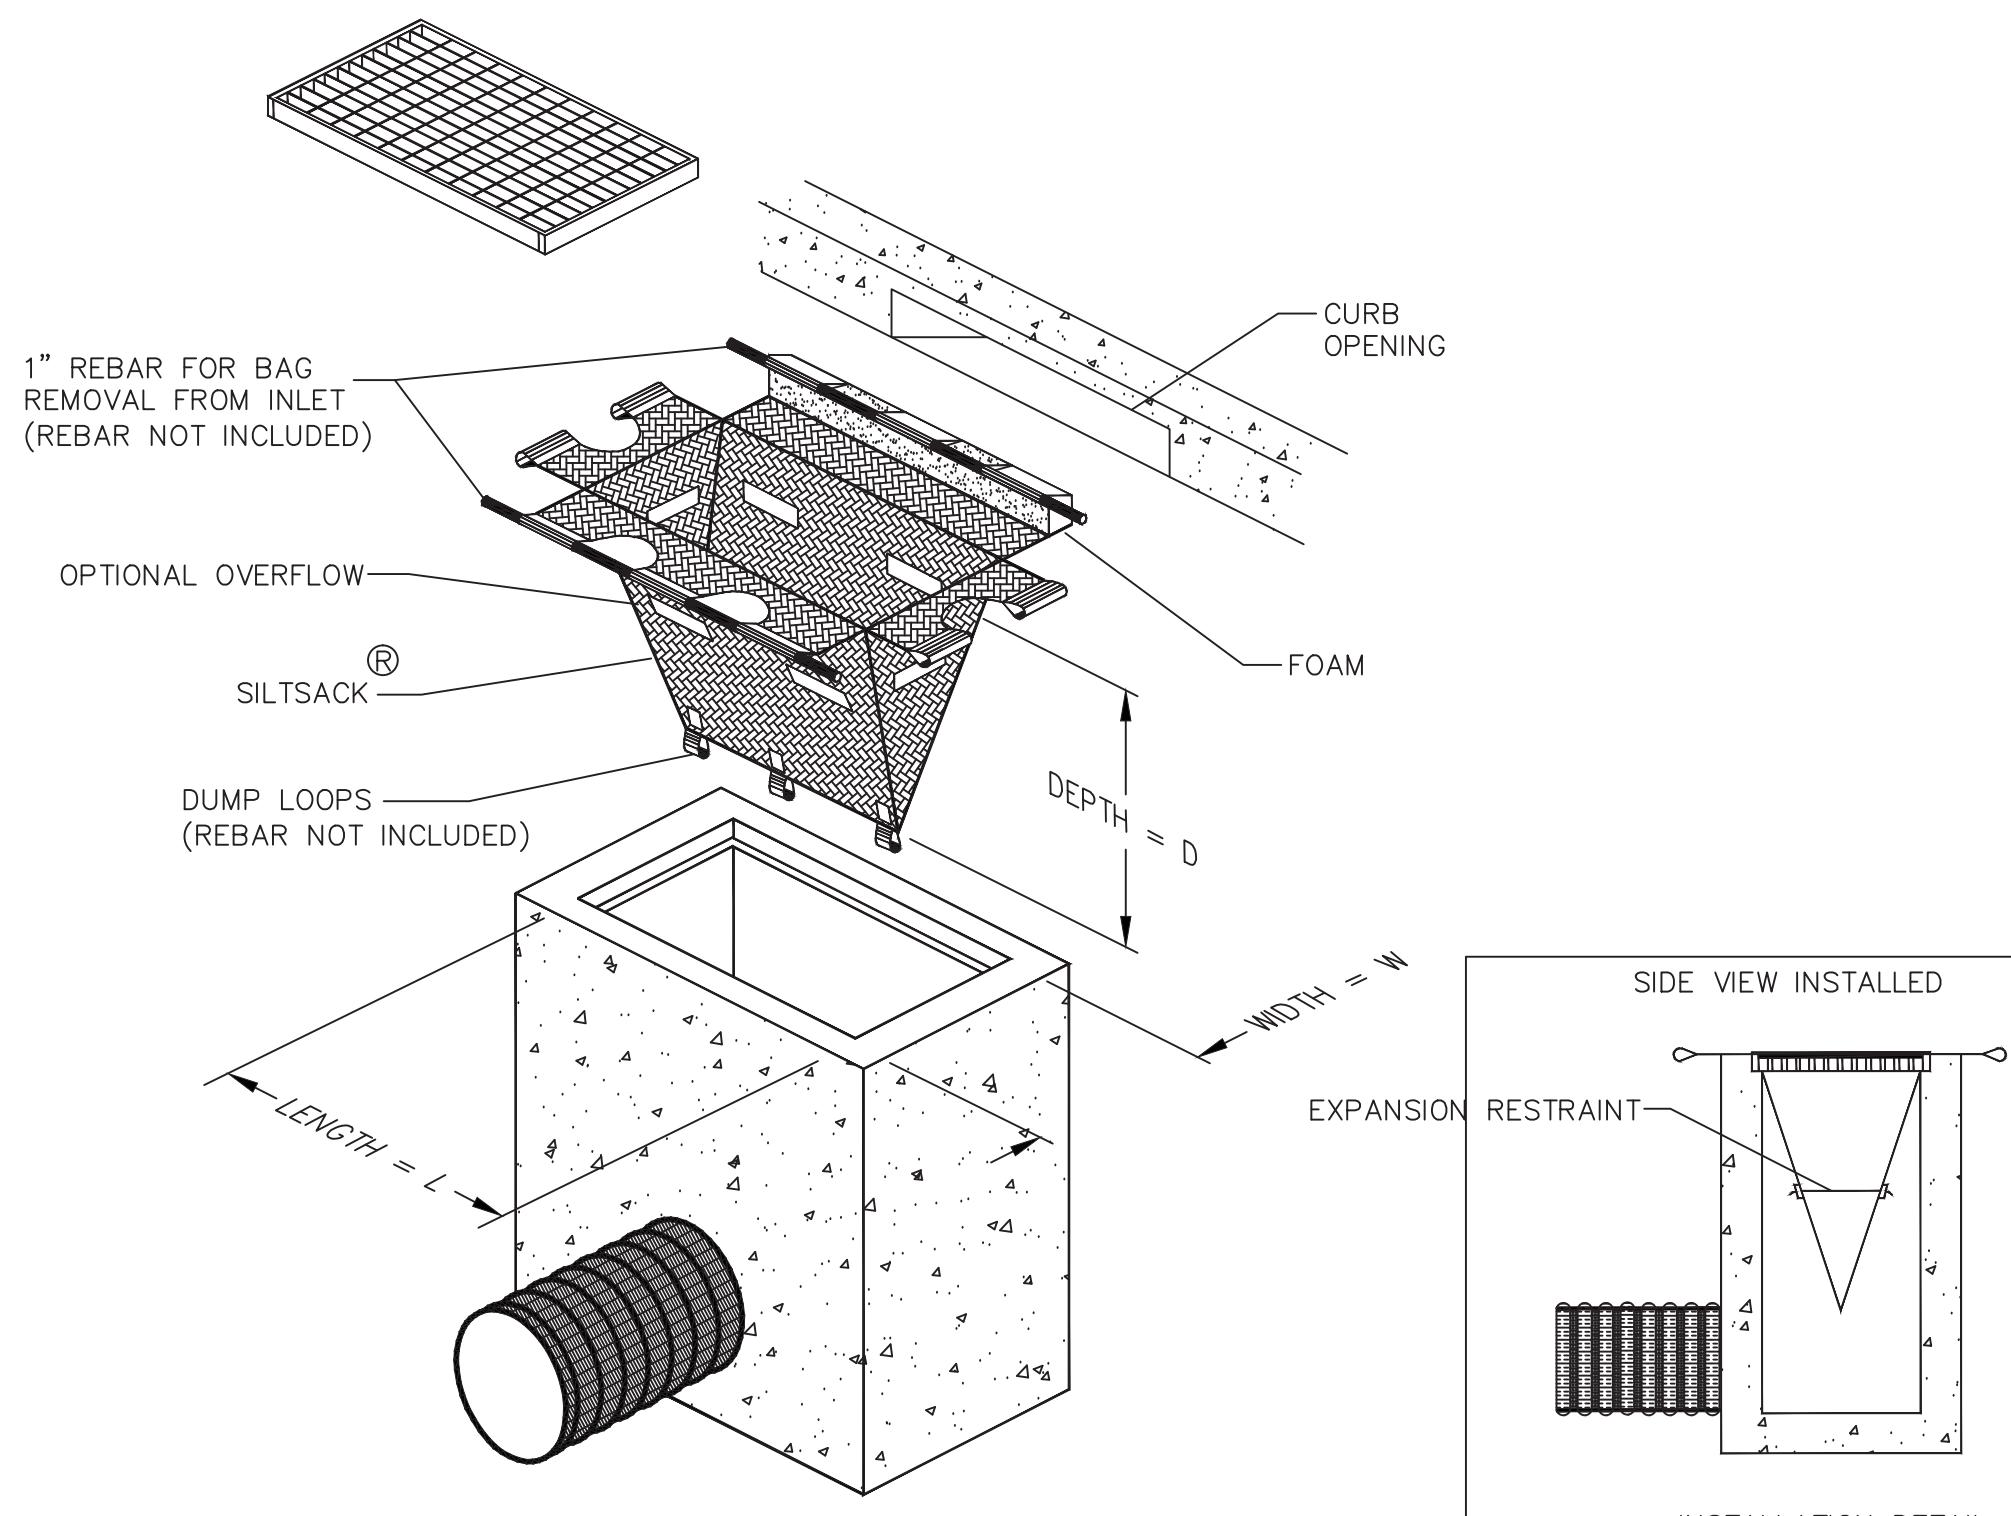

## **INLET FILTER (MODIFIED)**

---


NOT TO SCALE

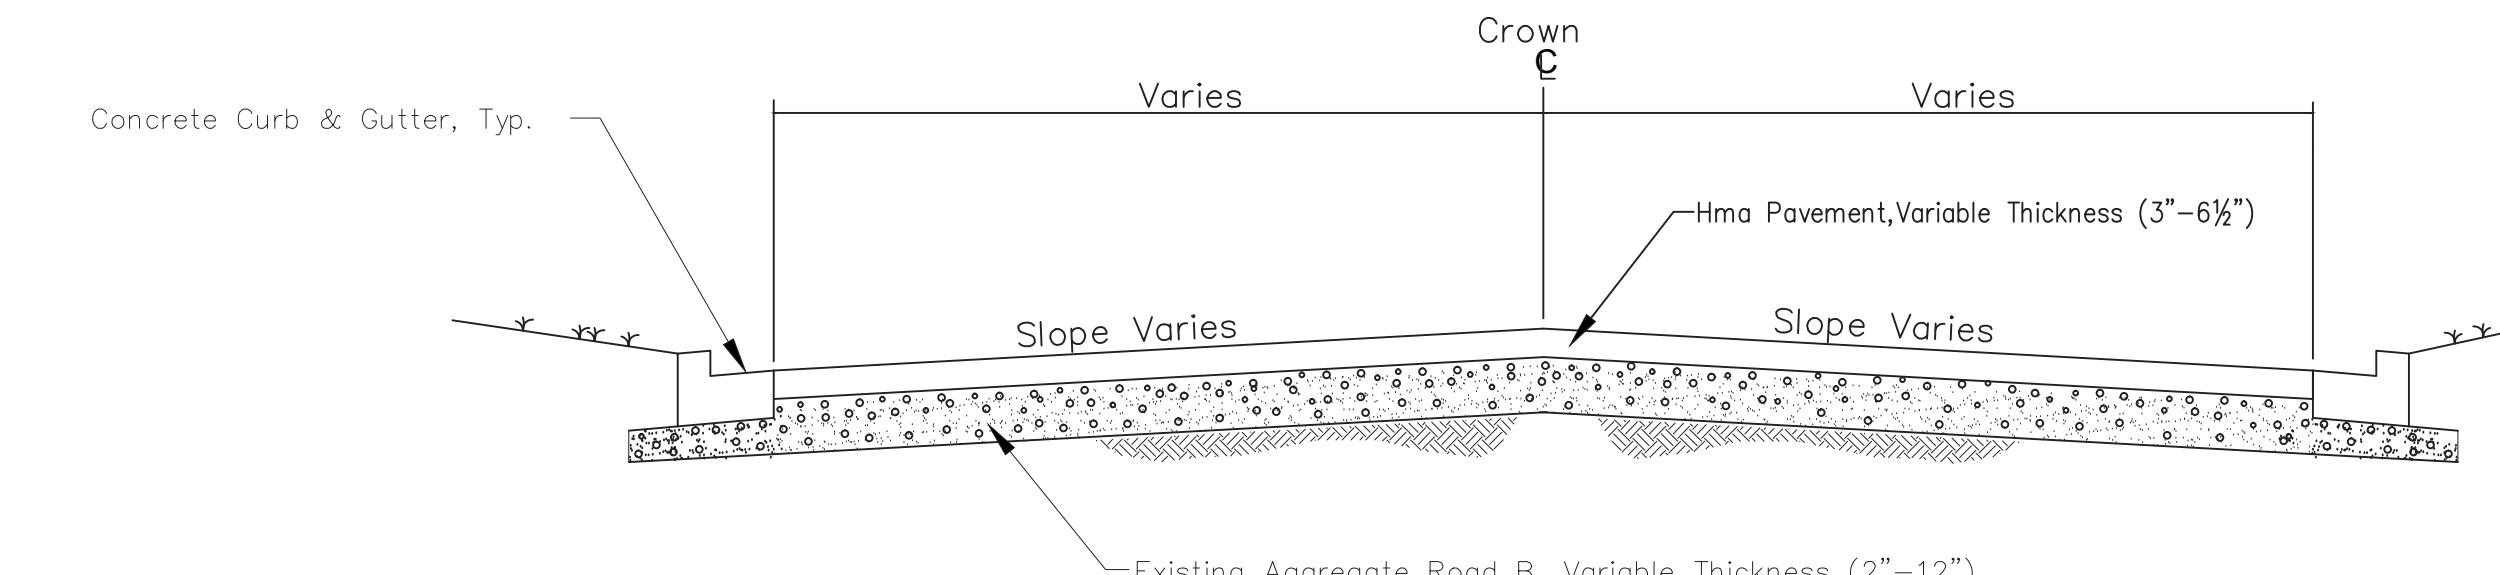

## Existing Typical Roadway Section

Russell, Russett, Redeemer, Hewett


N.T.S.

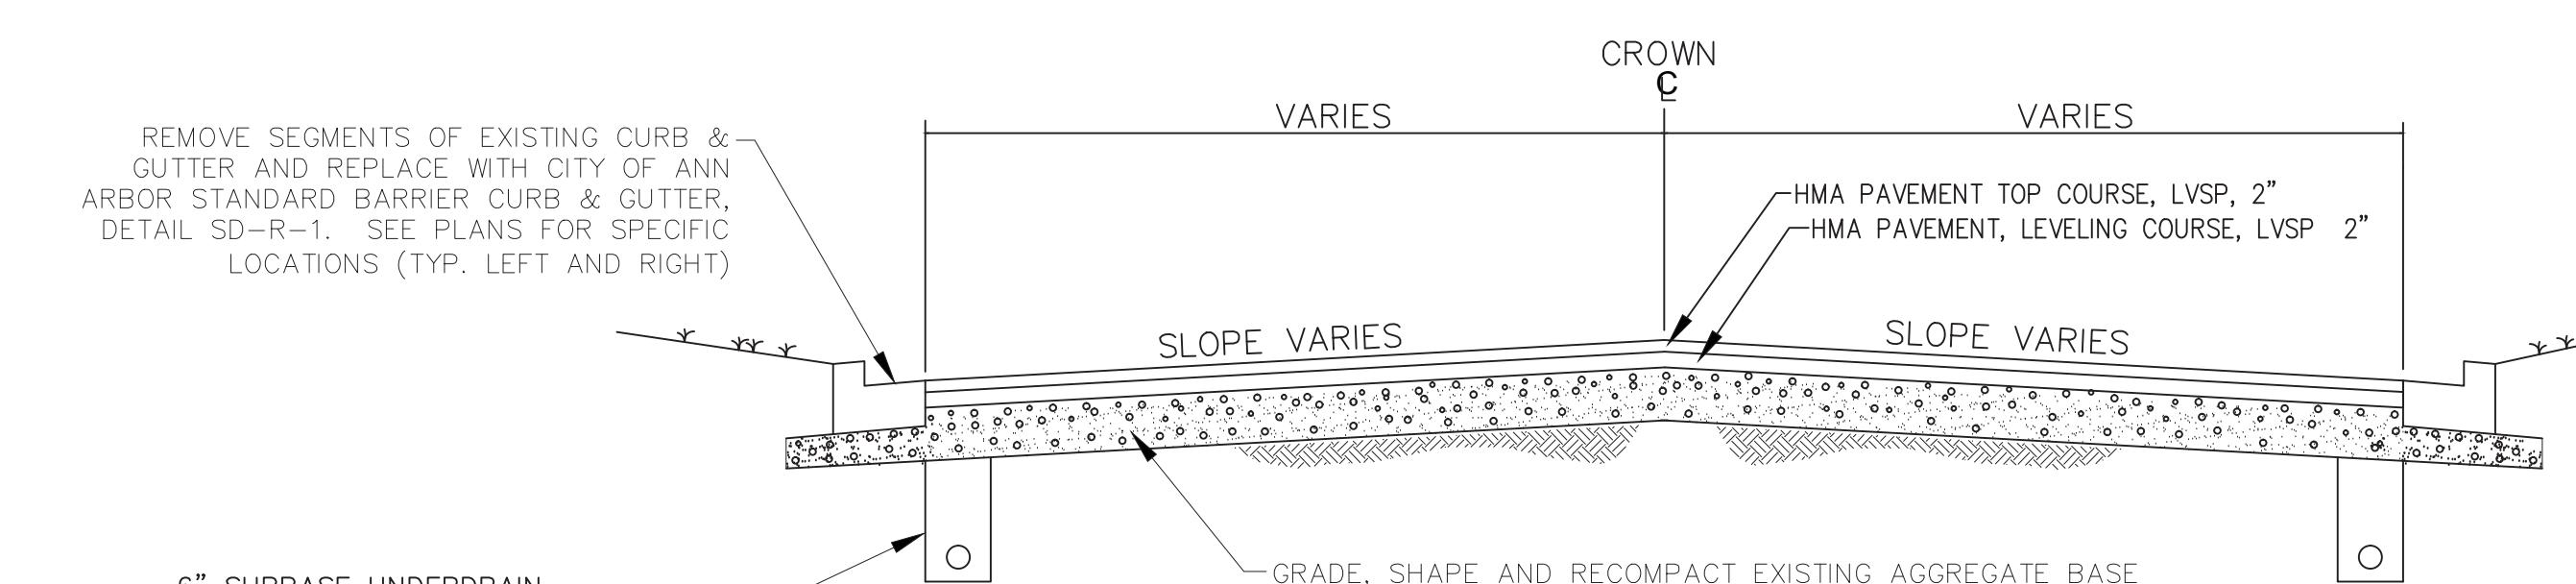

## PROPOSED TYPICAL ROADWAY SECTION

RUSSELL, BUSSETT, REDEFMER, HEWETT

N T S



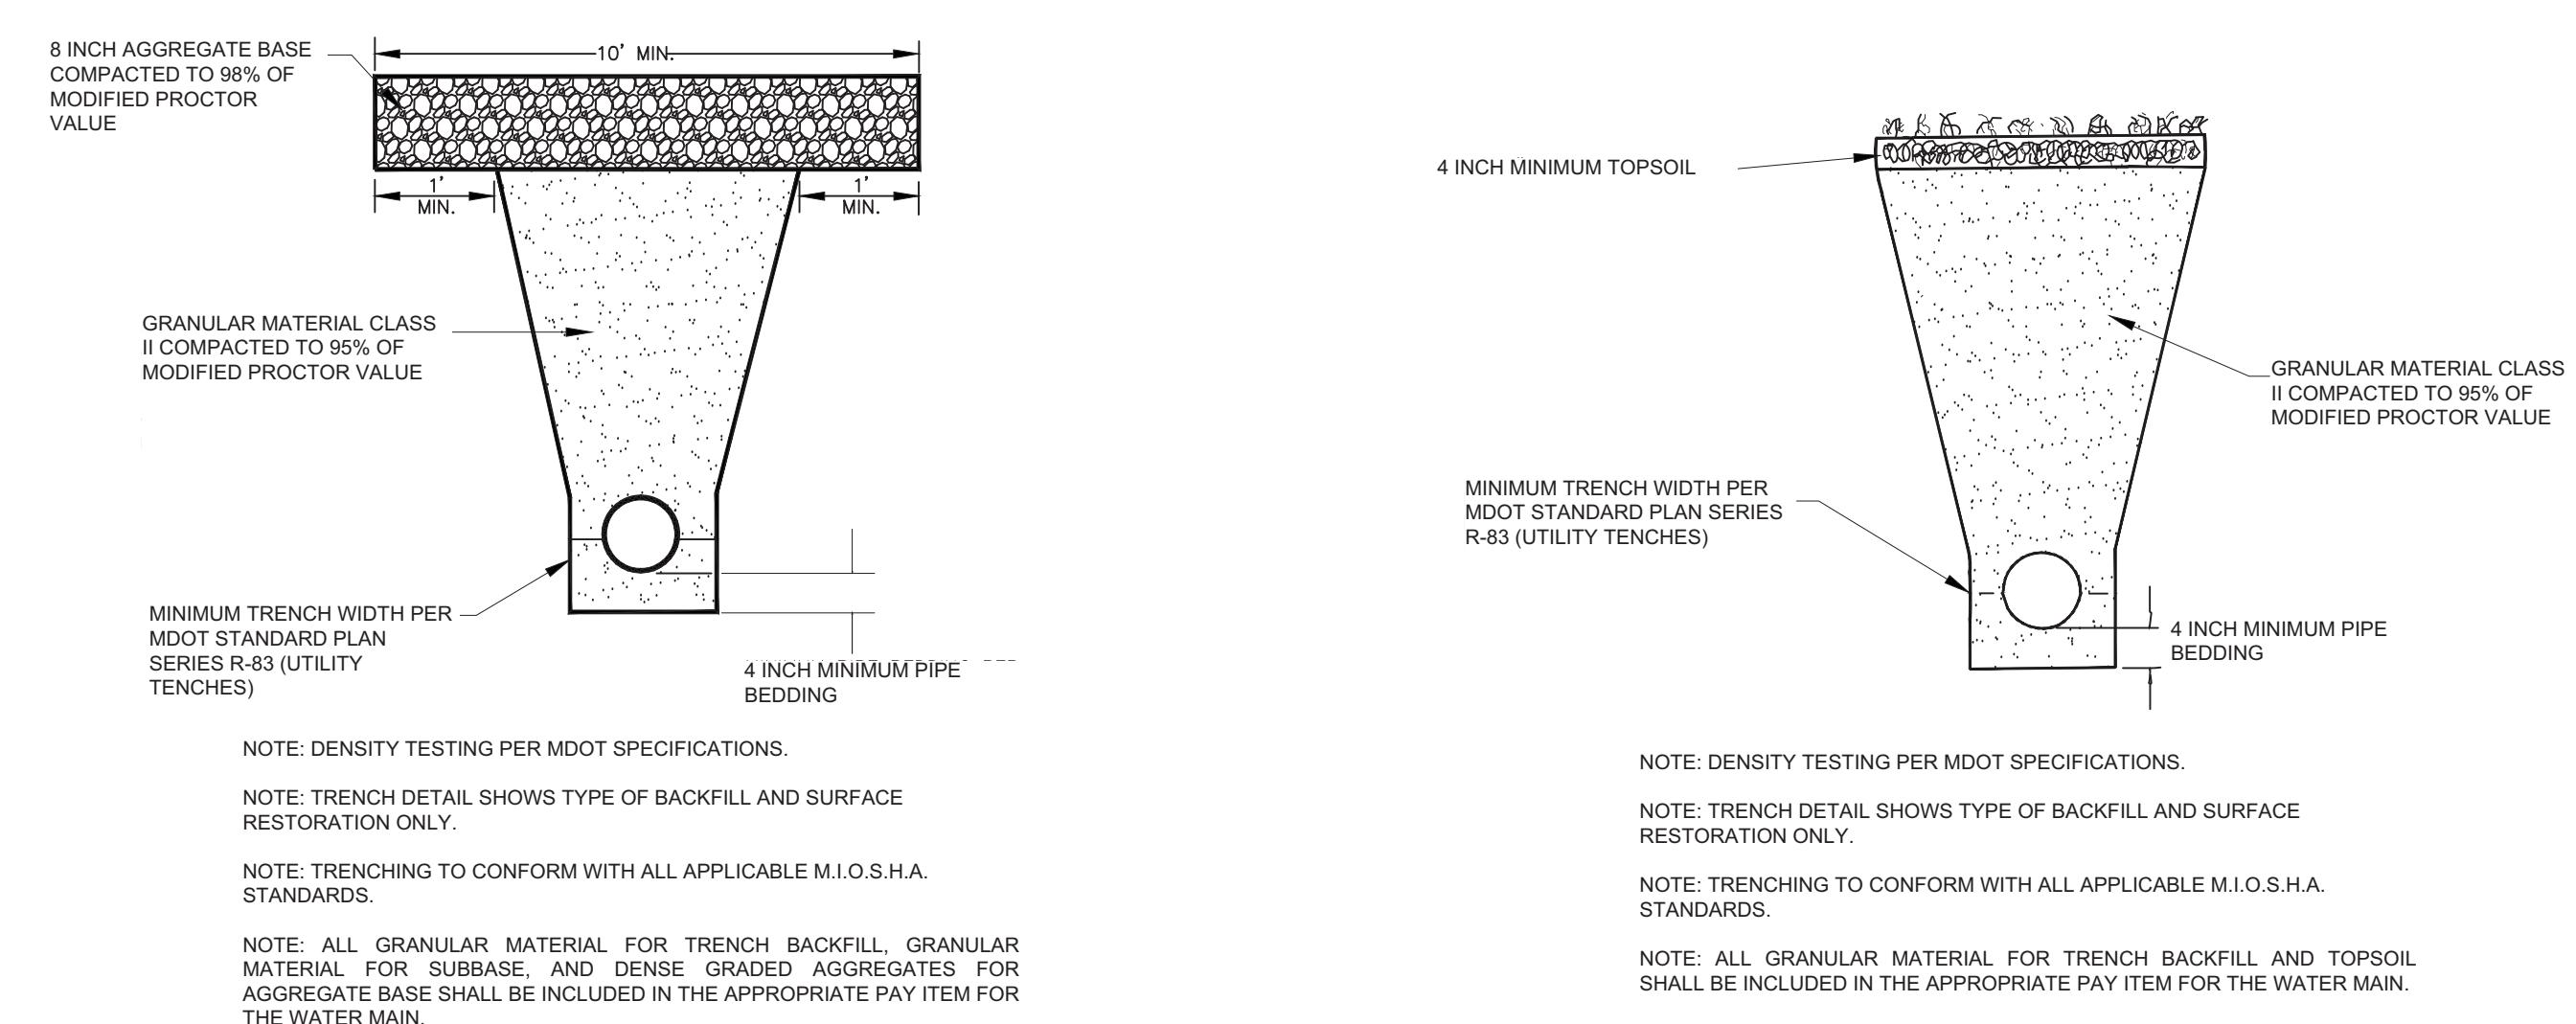



## UTILITY TRENCH – TYPE 1 MODIFIED


NOT TO SCALE

## UTILITY TRENCH - TYPE VI MODIFIED


NOT TO SCALE

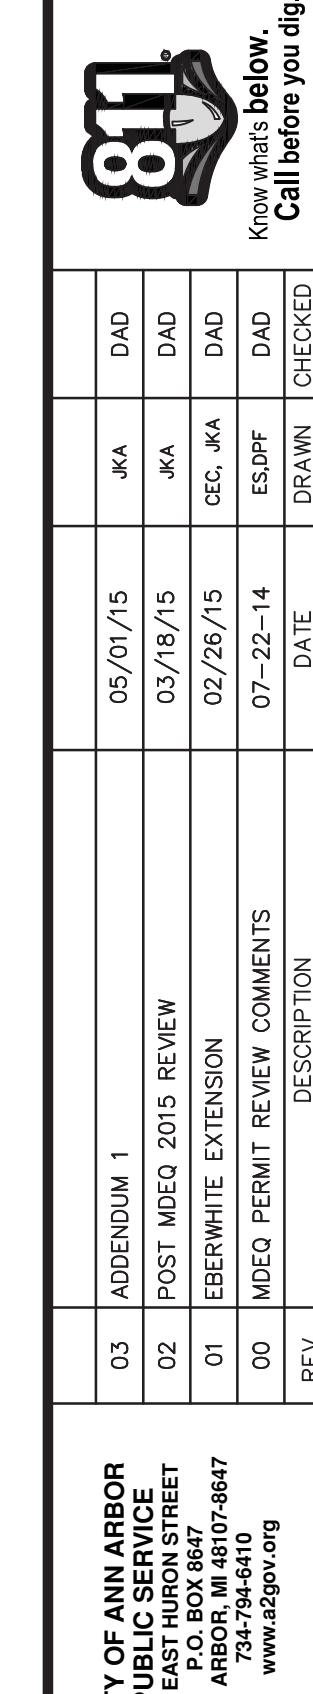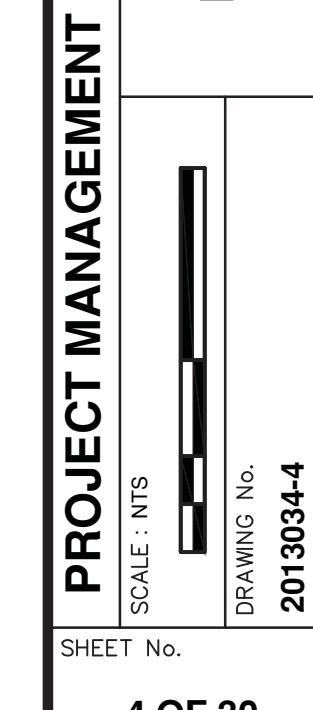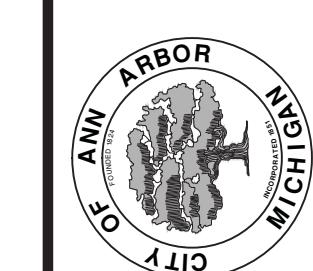

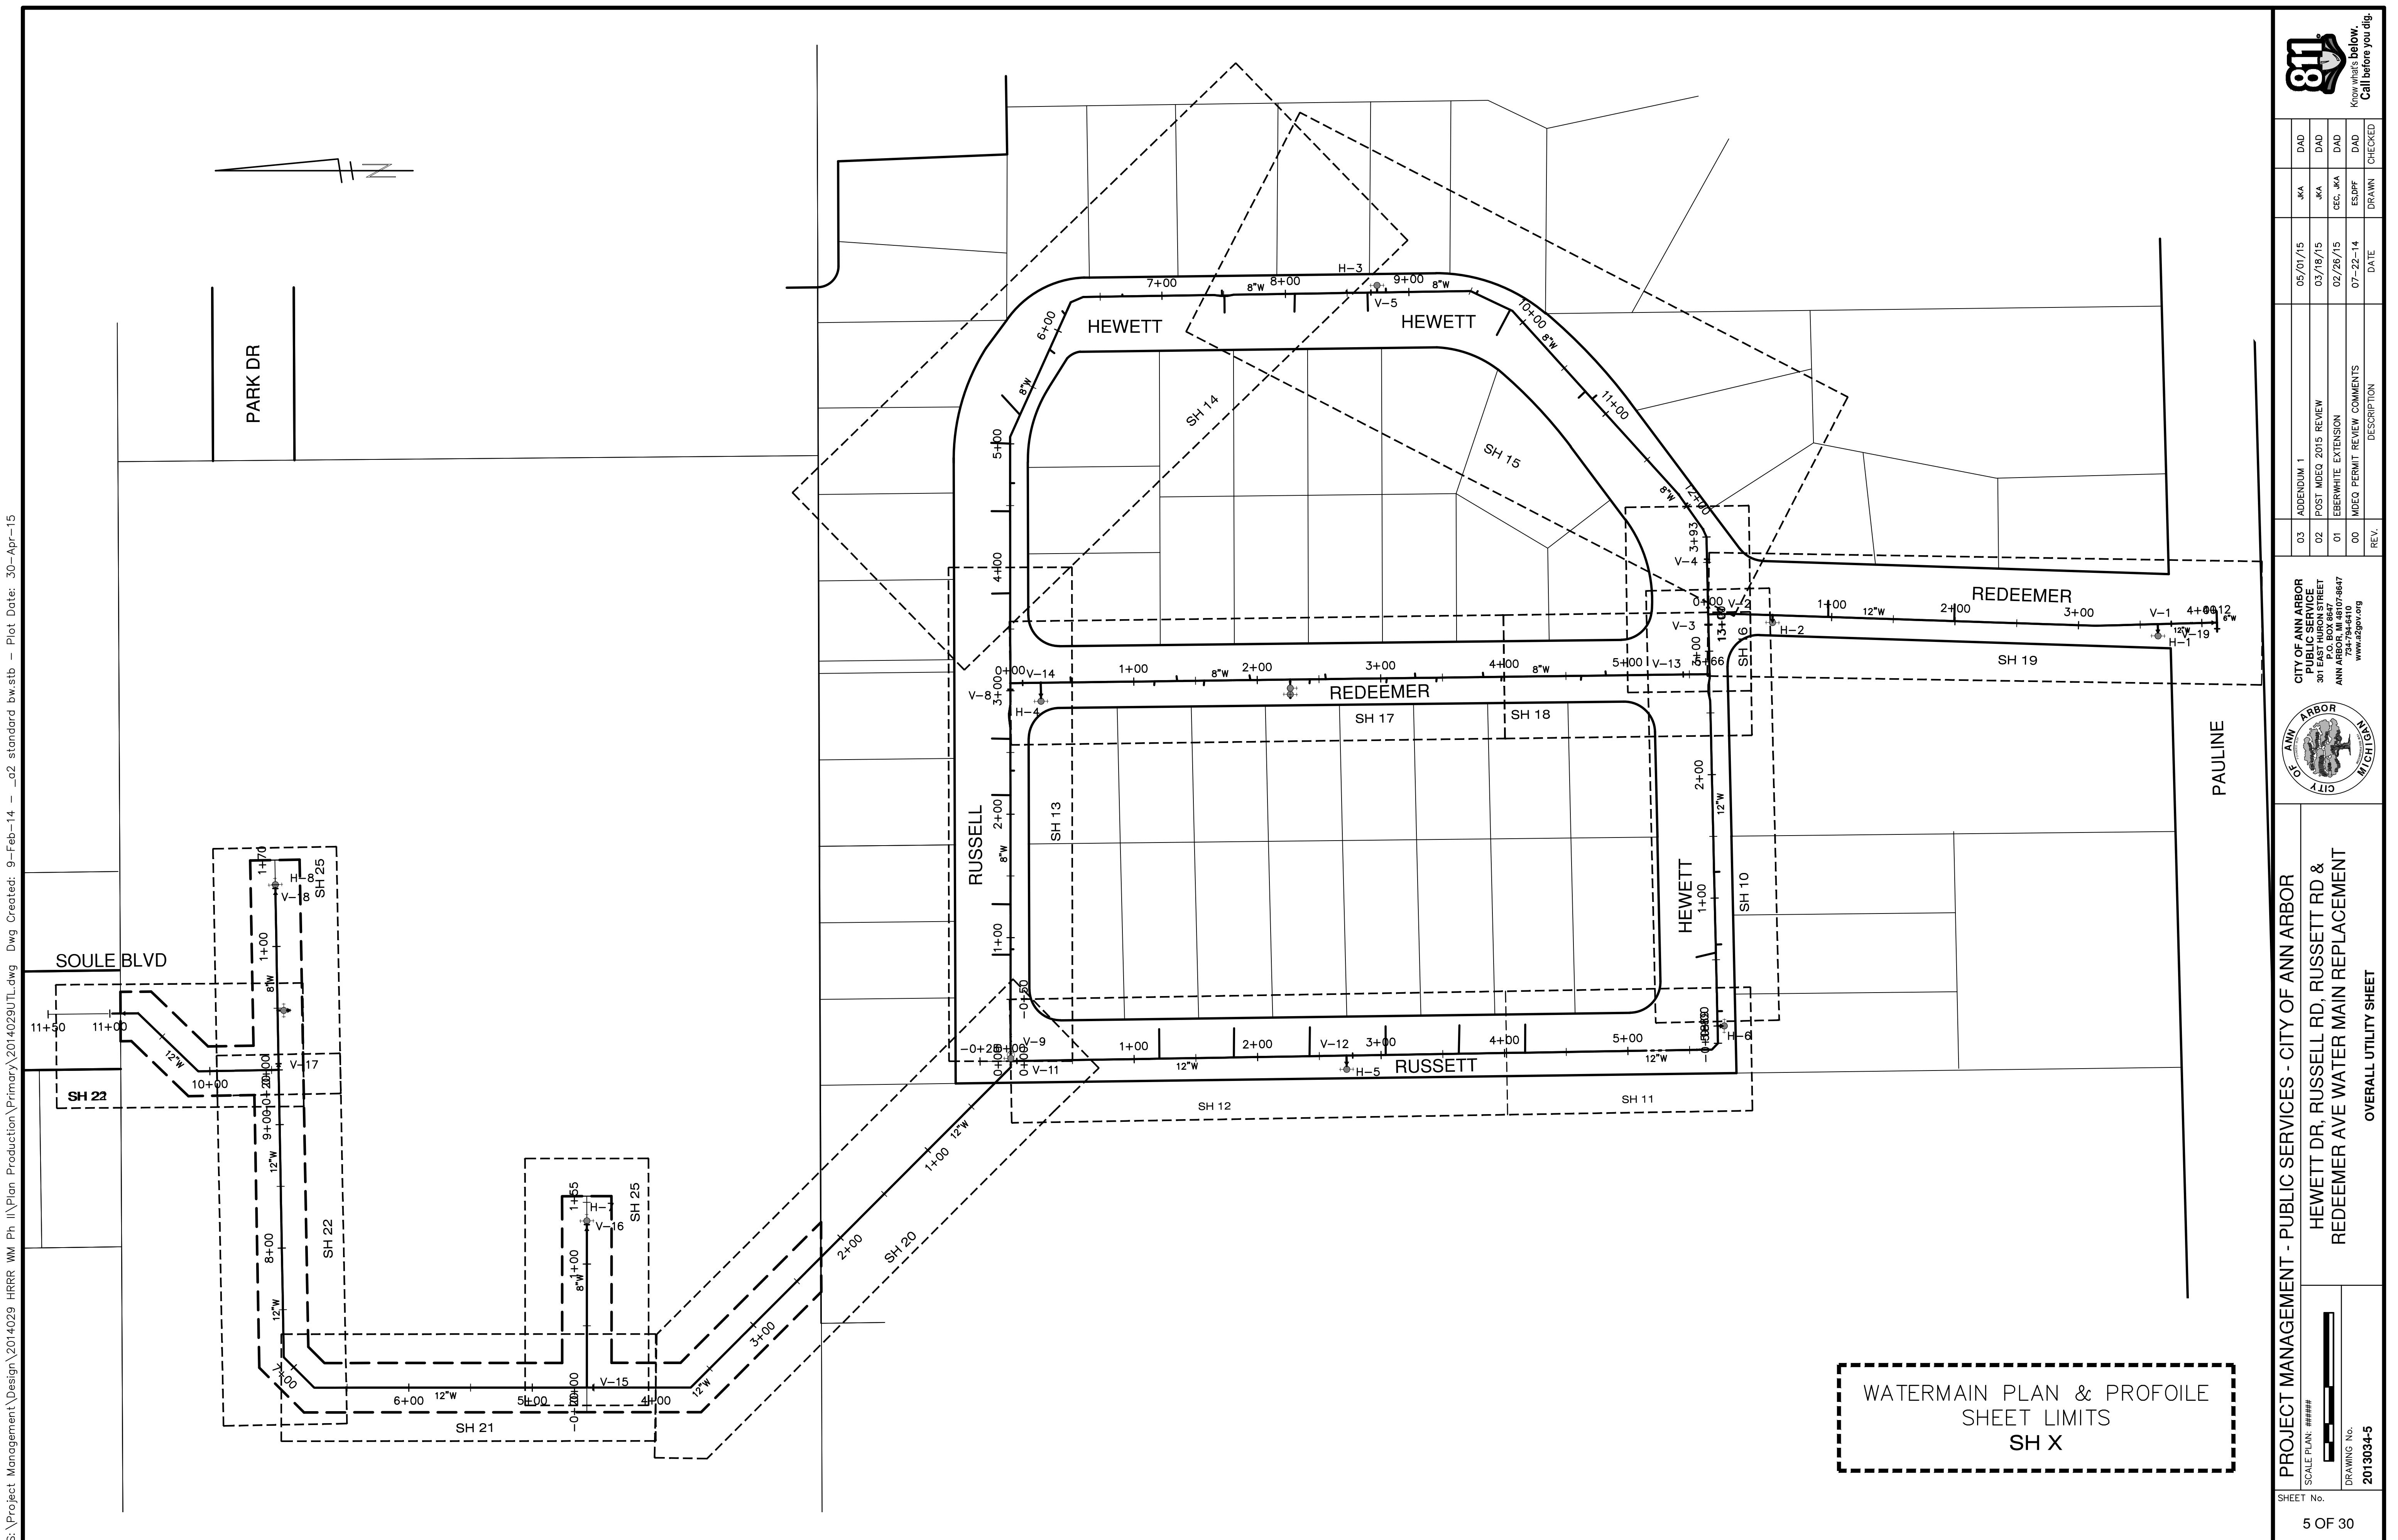

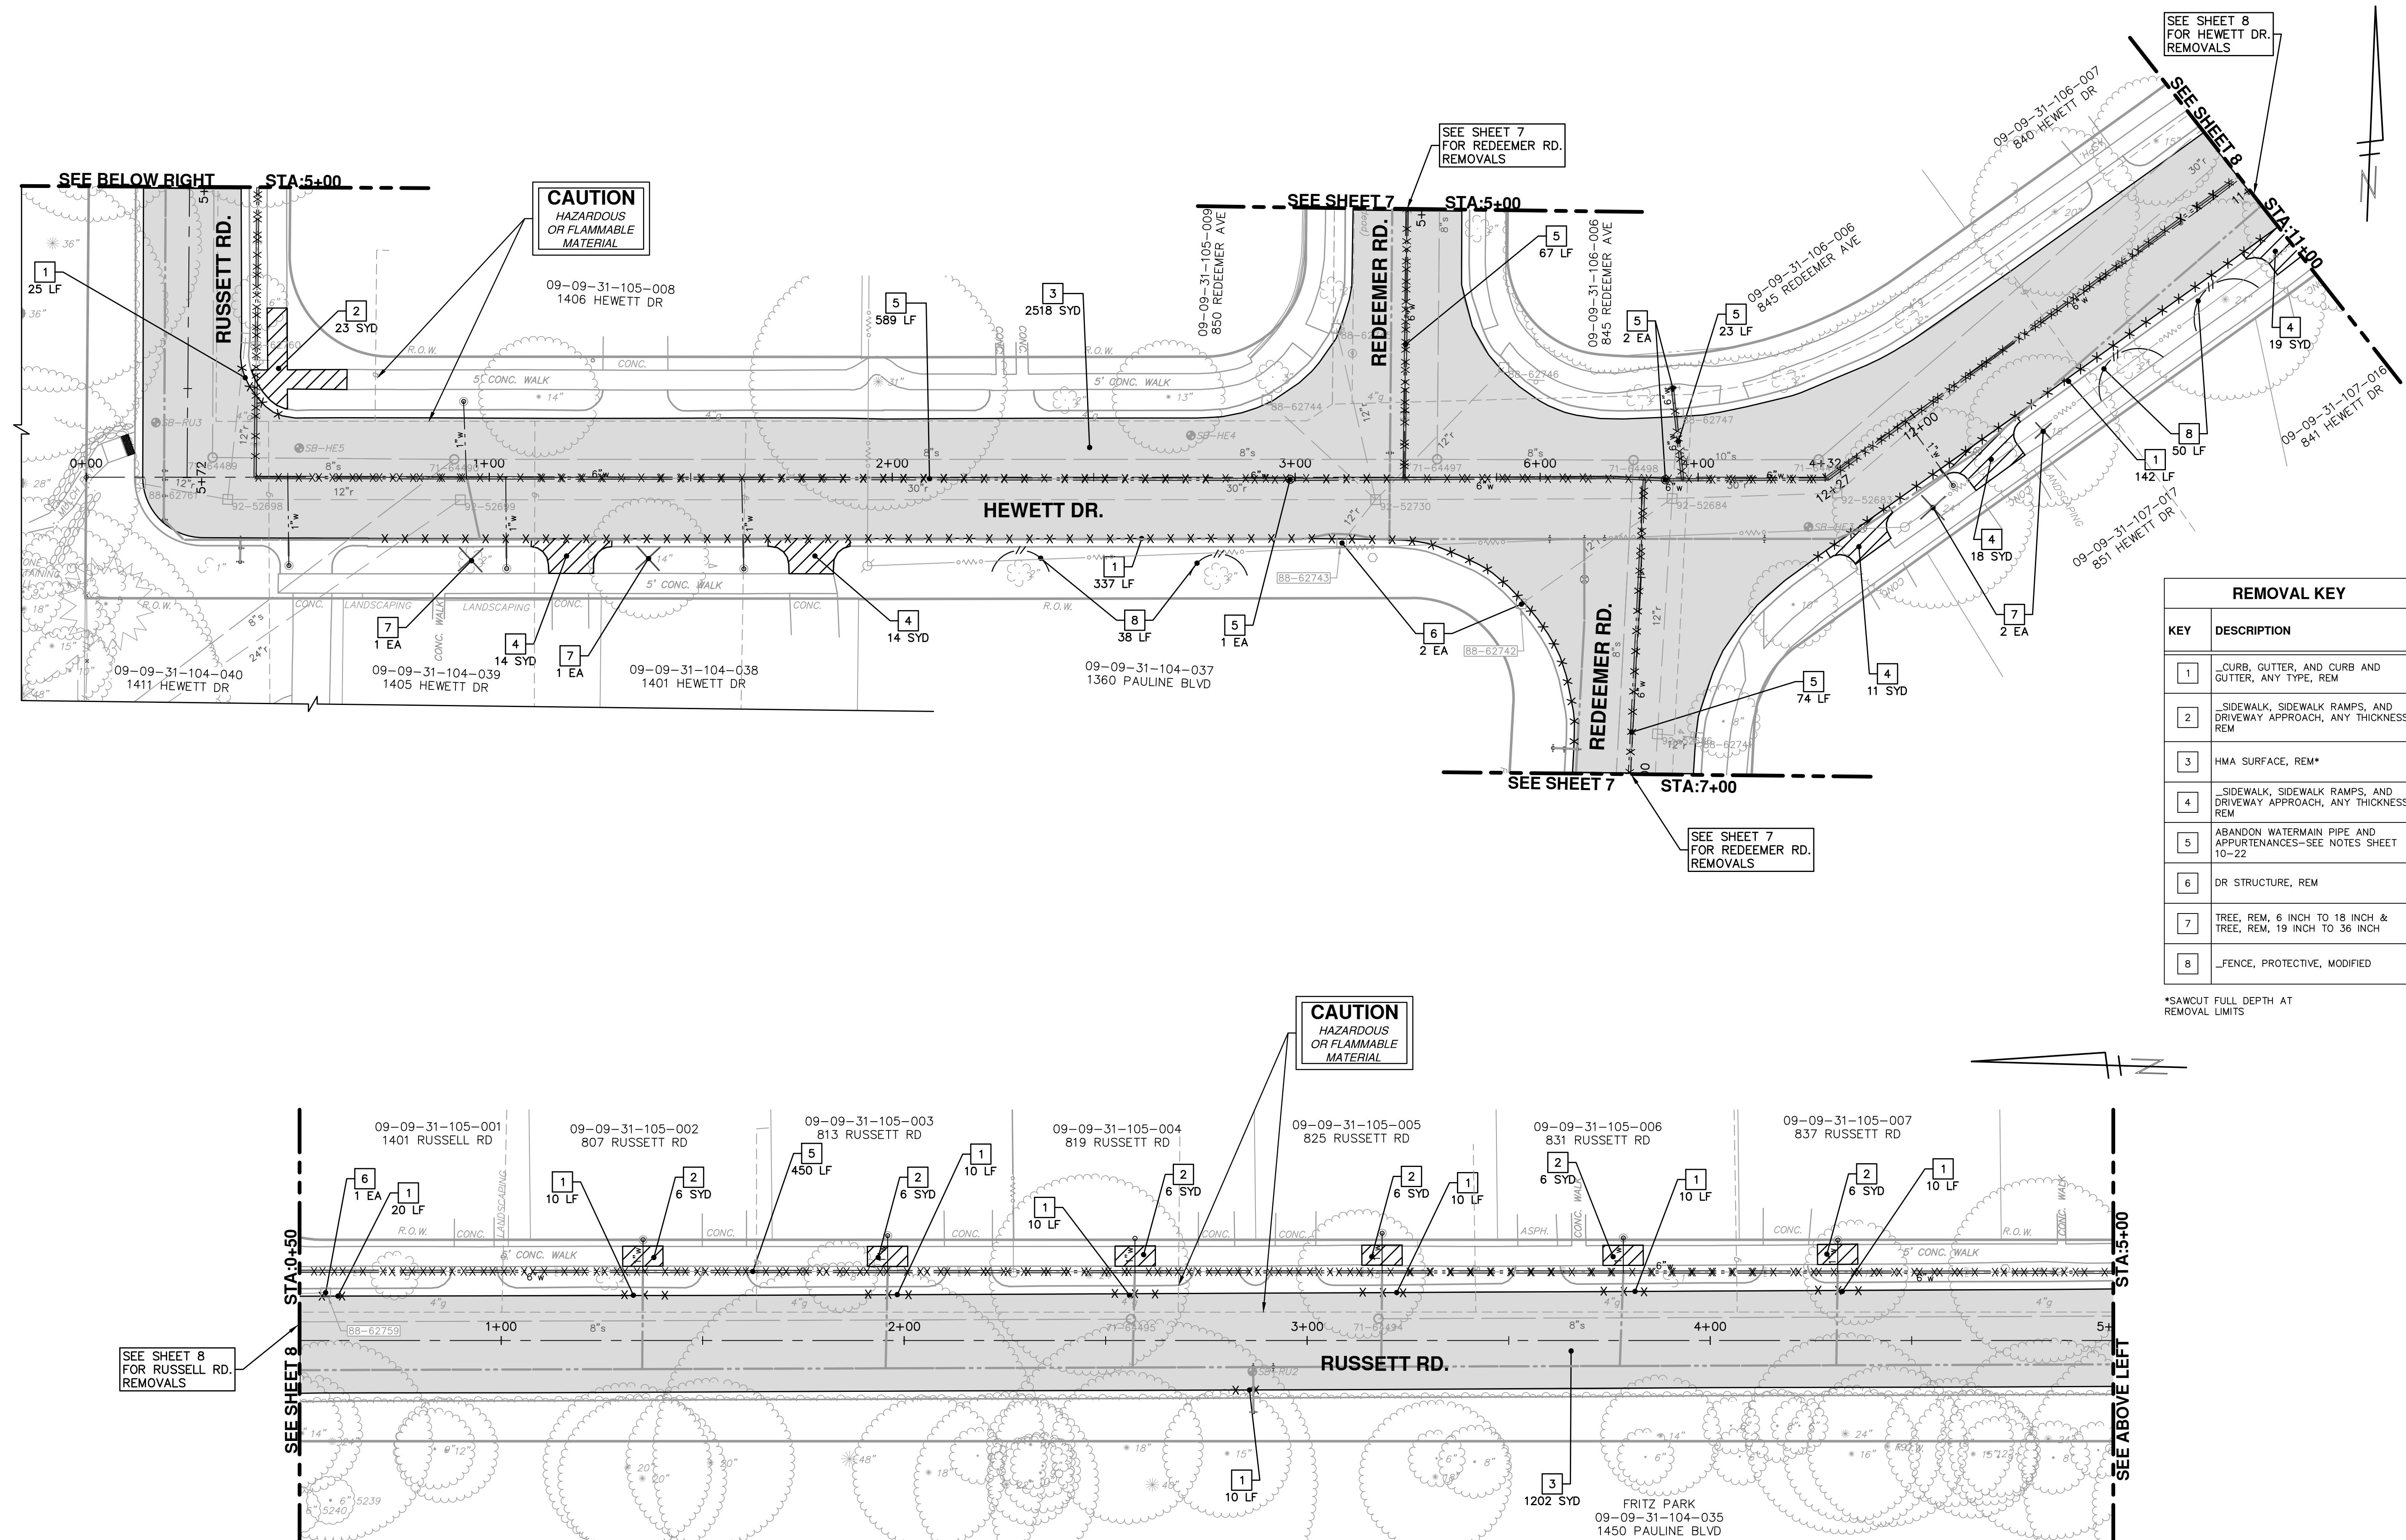

**PROJECT MANAGEMENT - PUBLIC SERVICES - CITY OF ANN ARBOR**  
**HEWETT DR, RUSSETT RD, RUSSETT RD &**  
**REDEEMER AVE WATER MAIN REPLACEMENT**  
**REMOVALS**  
**HEWETT & RUSSETT**

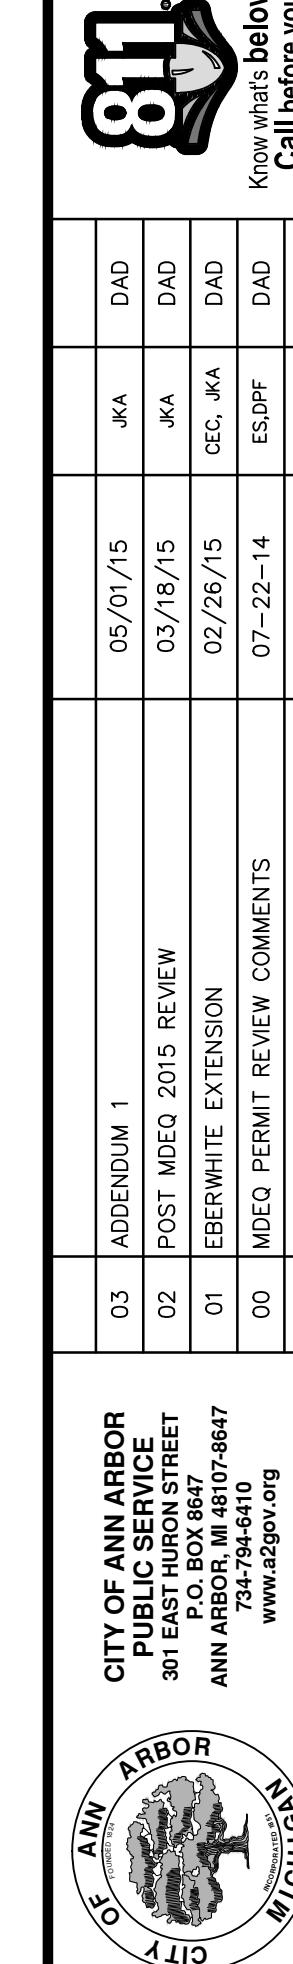

SCALE PLAN: 1" = 20'

DRAWING No.

2013034-6

DATE

DRAWN

CHECKED

REV.

05/01/15

JKA

DAD

05/08/15

JKA

DAD

02/26/15

CEC

DAD

02/22/14

ES.DPF

DAD

00

MDE PERMIT REVIEW COMMENTS

DESCRIPTION

REV.

03 ADENDUM 1

02 POST MODE 2015 REVIEW

01 EBWHITE EXTENSION

00 MDE PERMIT REVIEW

00 MDE PERMIT REVIEW COMMENTS

00 DESCRIPTION

REV.

05/01/15

JKA

DAD

05/08/15

JKA

DAD

02/26/15

CEC

DAD

02/22/14

ES.DPF

DAD

07-22-14

DRAWN

CHECKED

07-22-14

REV.

00

DESCRIPTION

REV.

03 ADENDUM 1

02 POST MODE 2015 REVIEW

01 EBWHITE EXTENSION

00 MDE PERMIT REVIEW

00 MDE PERMIT REVIEW COMMENTS

00 DESCRIPTION

REV.

05/01/15

JKA

DAD

05/08/15

JKA

DAD

02/26/15

CEC

DAD

02/22/14

ES.DPF

DAD

07-22-14

DRAWN

CHECKED

07-22-14

REV.

00

DESCRIPTION

REV.

03 ADENDUM 1

02 POST MODE 2015 REVIEW

01 EBWHITE EXTENSION

00 MDE PERMIT REVIEW

00 MDE PERMIT REVIEW COMMENTS

00 DESCRIPTION

REV.

05/01/15

JKA

DAD

05/08/15

JKA

DAD

02/26/15

CEC

DAD

02/22/14

ES.DPF

DAD

07-22-14

DRAWN

CHECKED

07-22-14

REV.

00

DESCRIPTION

REV.

03 ADENDUM 1

02 POST MODE 2015 REVIEW

01 EBWHITE EXTENSION

00 MDE PERMIT REVIEW

00 MDE PERMIT REVIEW COMMENTS

00 DESCRIPTION

REV.

05/01/15

JKA

DAD

05/08/15

JKA

DAD

02/26/15

CEC

DAD

02/22/14

ES.DPF

DAD

07-22-14

DRAWN

CHECKED

07-22-14

REV.

00

DESCRIPTION

REV.

03 ADENDUM 1

02 POST MODE 2015 REVIEW

01 EBWHITE EXTENSION

00 MDE PERMIT REVIEW

00 MDE PERMIT REVIEW COMMENTS

00 DESCRIPTION

REV.

05/01/15

JKA

DAD

05/08/15

JKA

DAD

02/26/15

CEC

DAD

02/22/14

ES.DPF

DAD

07-22-14

DRAWN

CHECKED

07-22-14

REV.

00

DESCRIPTION

REV.

03 ADENDUM 1

02 POST MODE 2015 REVIEW

01 EBWHITE EXTENSION

00 MDE PERMIT REVIEW

00 MDE PERMIT REVIEW COMMENTS

00 DESCRIPTION

REV.

05/01/15

JKA

DAD

05/08/15

JKA

DAD

02/26/15

CEC

DAD

02/22/14


ES.DPF

DAD

07-22-14


DRAWN

CHECKED

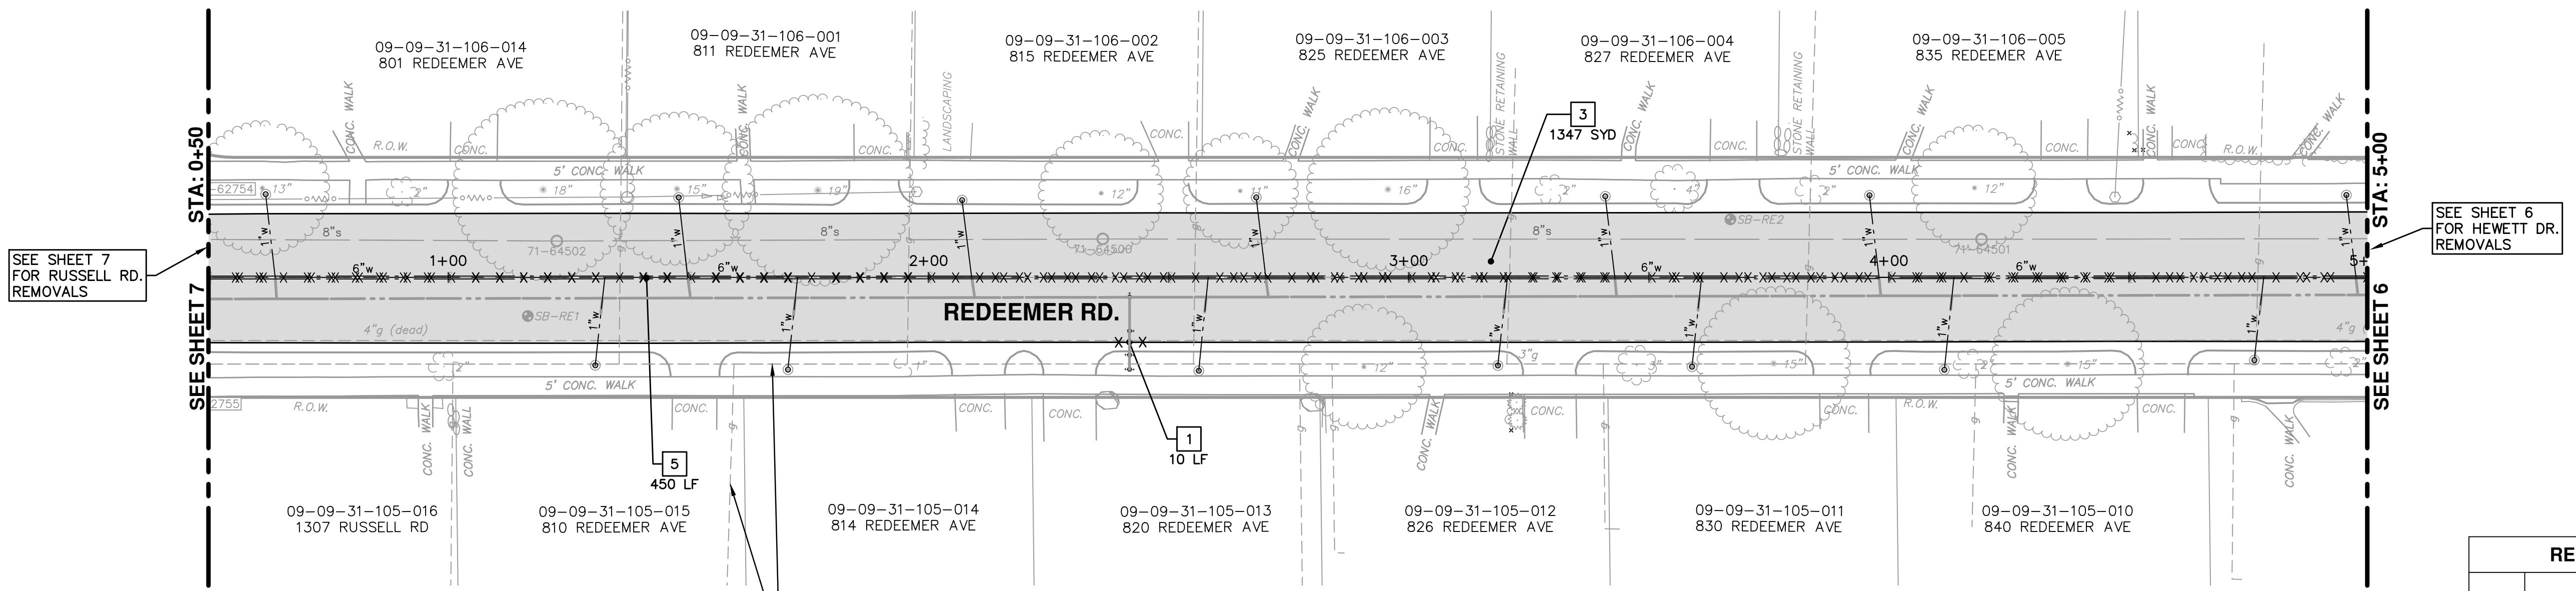

REMOVAL KEY	
KEY	DESCRIPTION
1	CURB, CUTTER, AND CURB AND GUTTER, ANY TYPE, REM
2	SIDEWALK, SIDEWALK RAMPS, AND DRIVEWAY APPROACH, ANY THICKNESS, REM
3	HMA SURFACE, REM*
4	SIDEWALK, SIDEWALK RAMPS, AND DRIVEWAY APPROACH, ANY THICKNESS, REM
5	ABANDON WATERMAIN PIPE AND APPURTENANCES—SEE NOTES SHEET 10-22
6	DR STRUCTURE, REM
7	TREE, REM, 6 INCH TO 18 INCH & TREE, REM, 19 INCH TO 36 INCH
8	FENCE, PROTECTIVE, MODIFIED

\*SAWCUT FULL DEPTH AT REMOVAL LIMITS

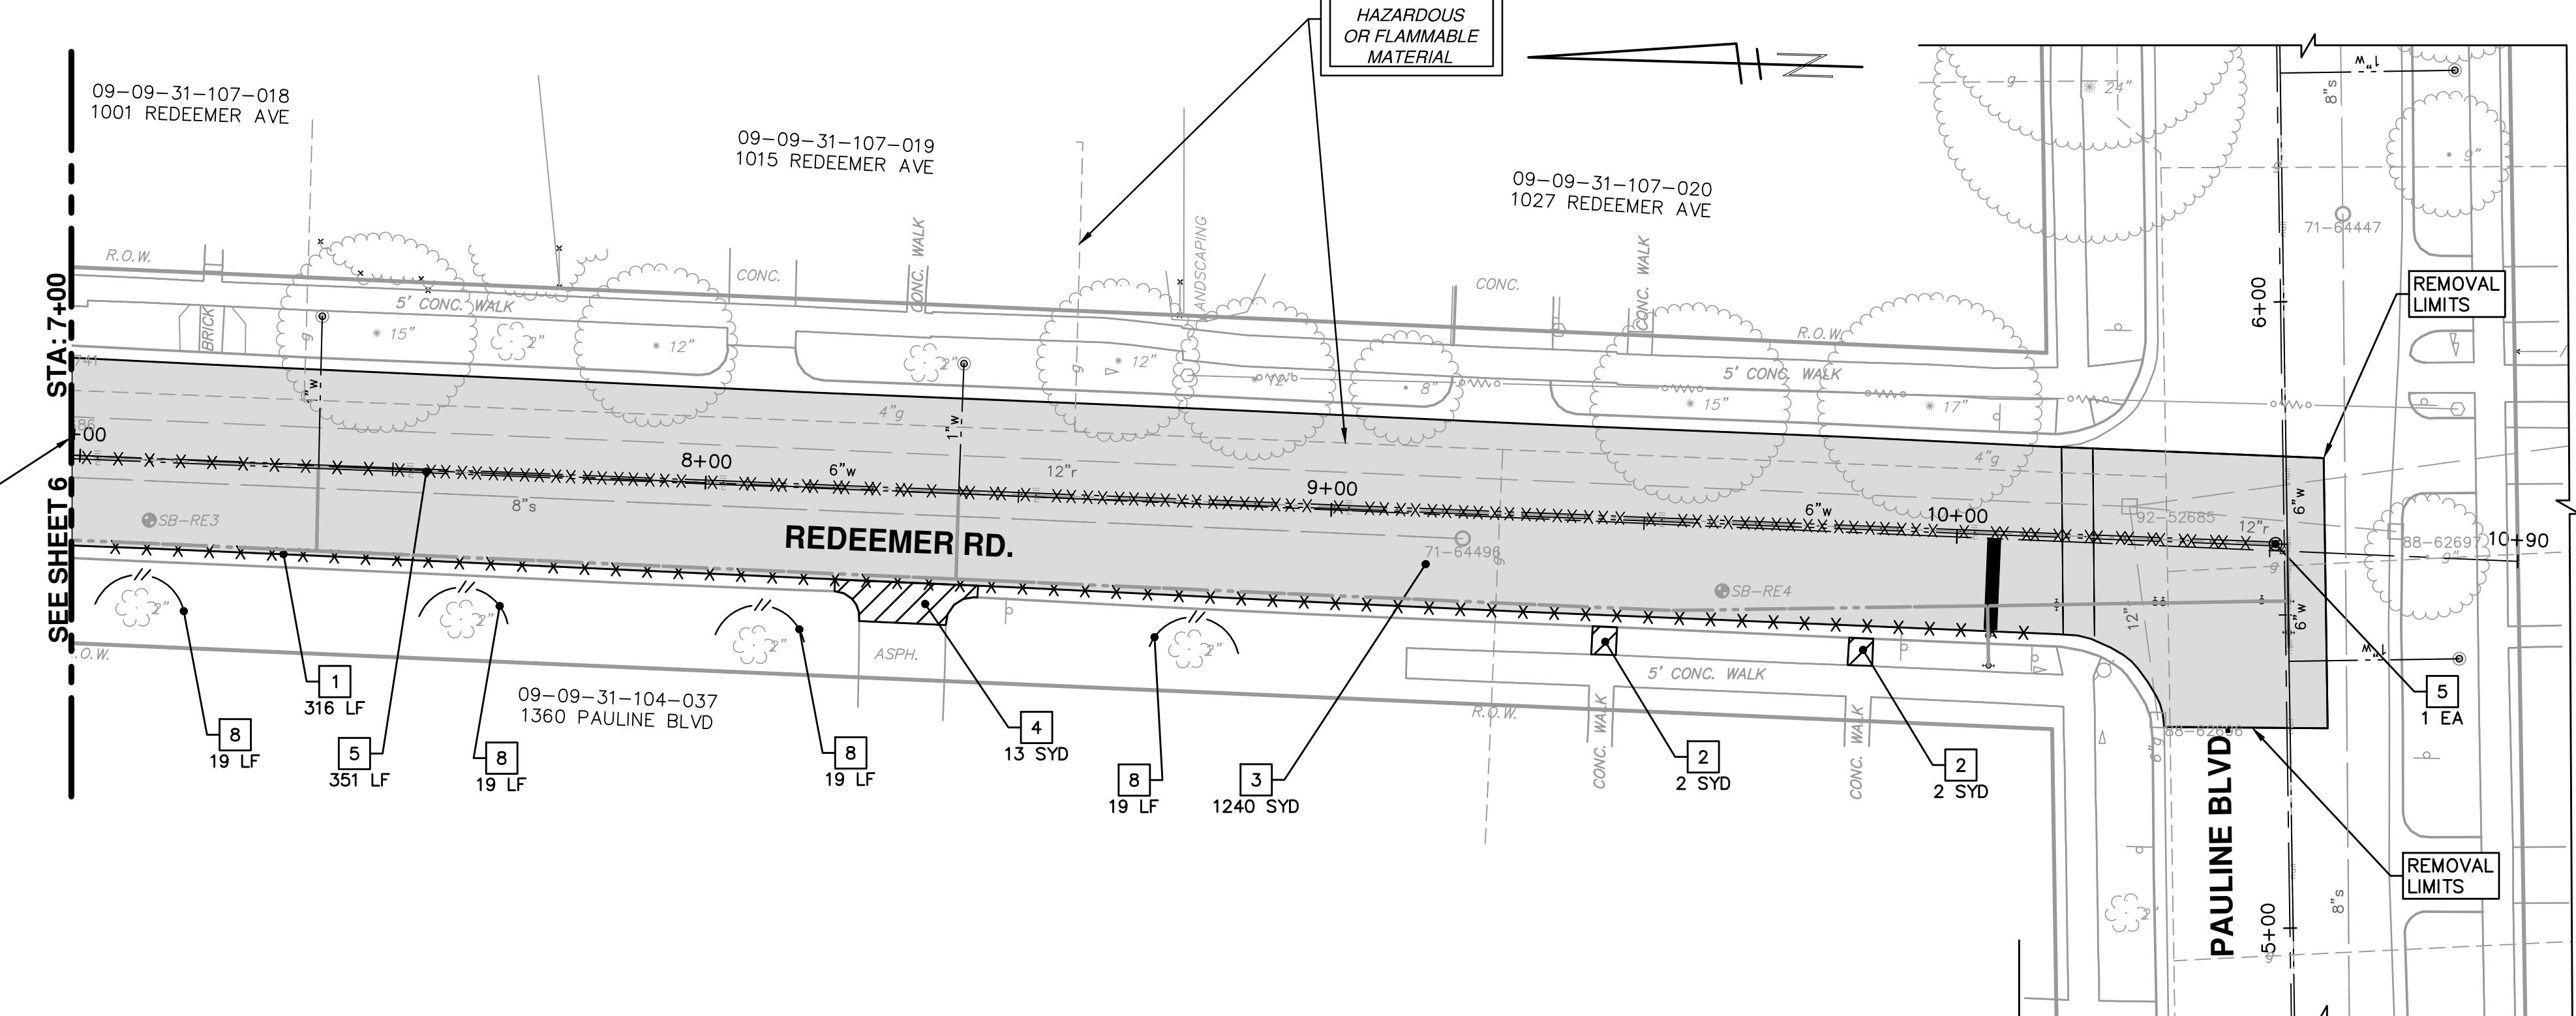

**PROJECT MANAGEMENT - PUBLIC SERVICES - CITY OF ANN ARBOR**

**HEWETT DR, RUSSELL RD, PAULINE BLVD & REDEEMER AVE WATER MAIN REPLACEMENT**

REMOVALS


REDEEMER

SCALE PLAN 1" = 20'


DRAWING No. 2013034-7

Sheet No. 7 OF 30

03 ADENDUM 1	05/01/15	JKA	DAD
02 POST MODE 2015 REVIEW	03/18/15	JKA	DAD
01 EBWHITE EXTENSION	02/26/15	CEC, JKA	DAD
00 MDQ PERMIT REVIEW COMMENTS	07-22-14	ES,DPF	DAD
DESCRIPTION	DATE	DRAWN	CHECKED
REV.			

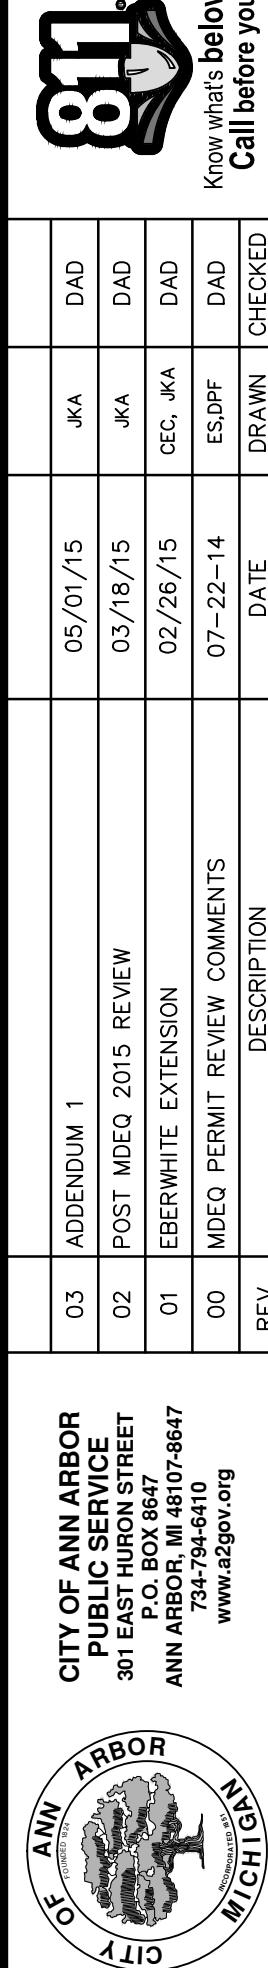


Know what's below.  
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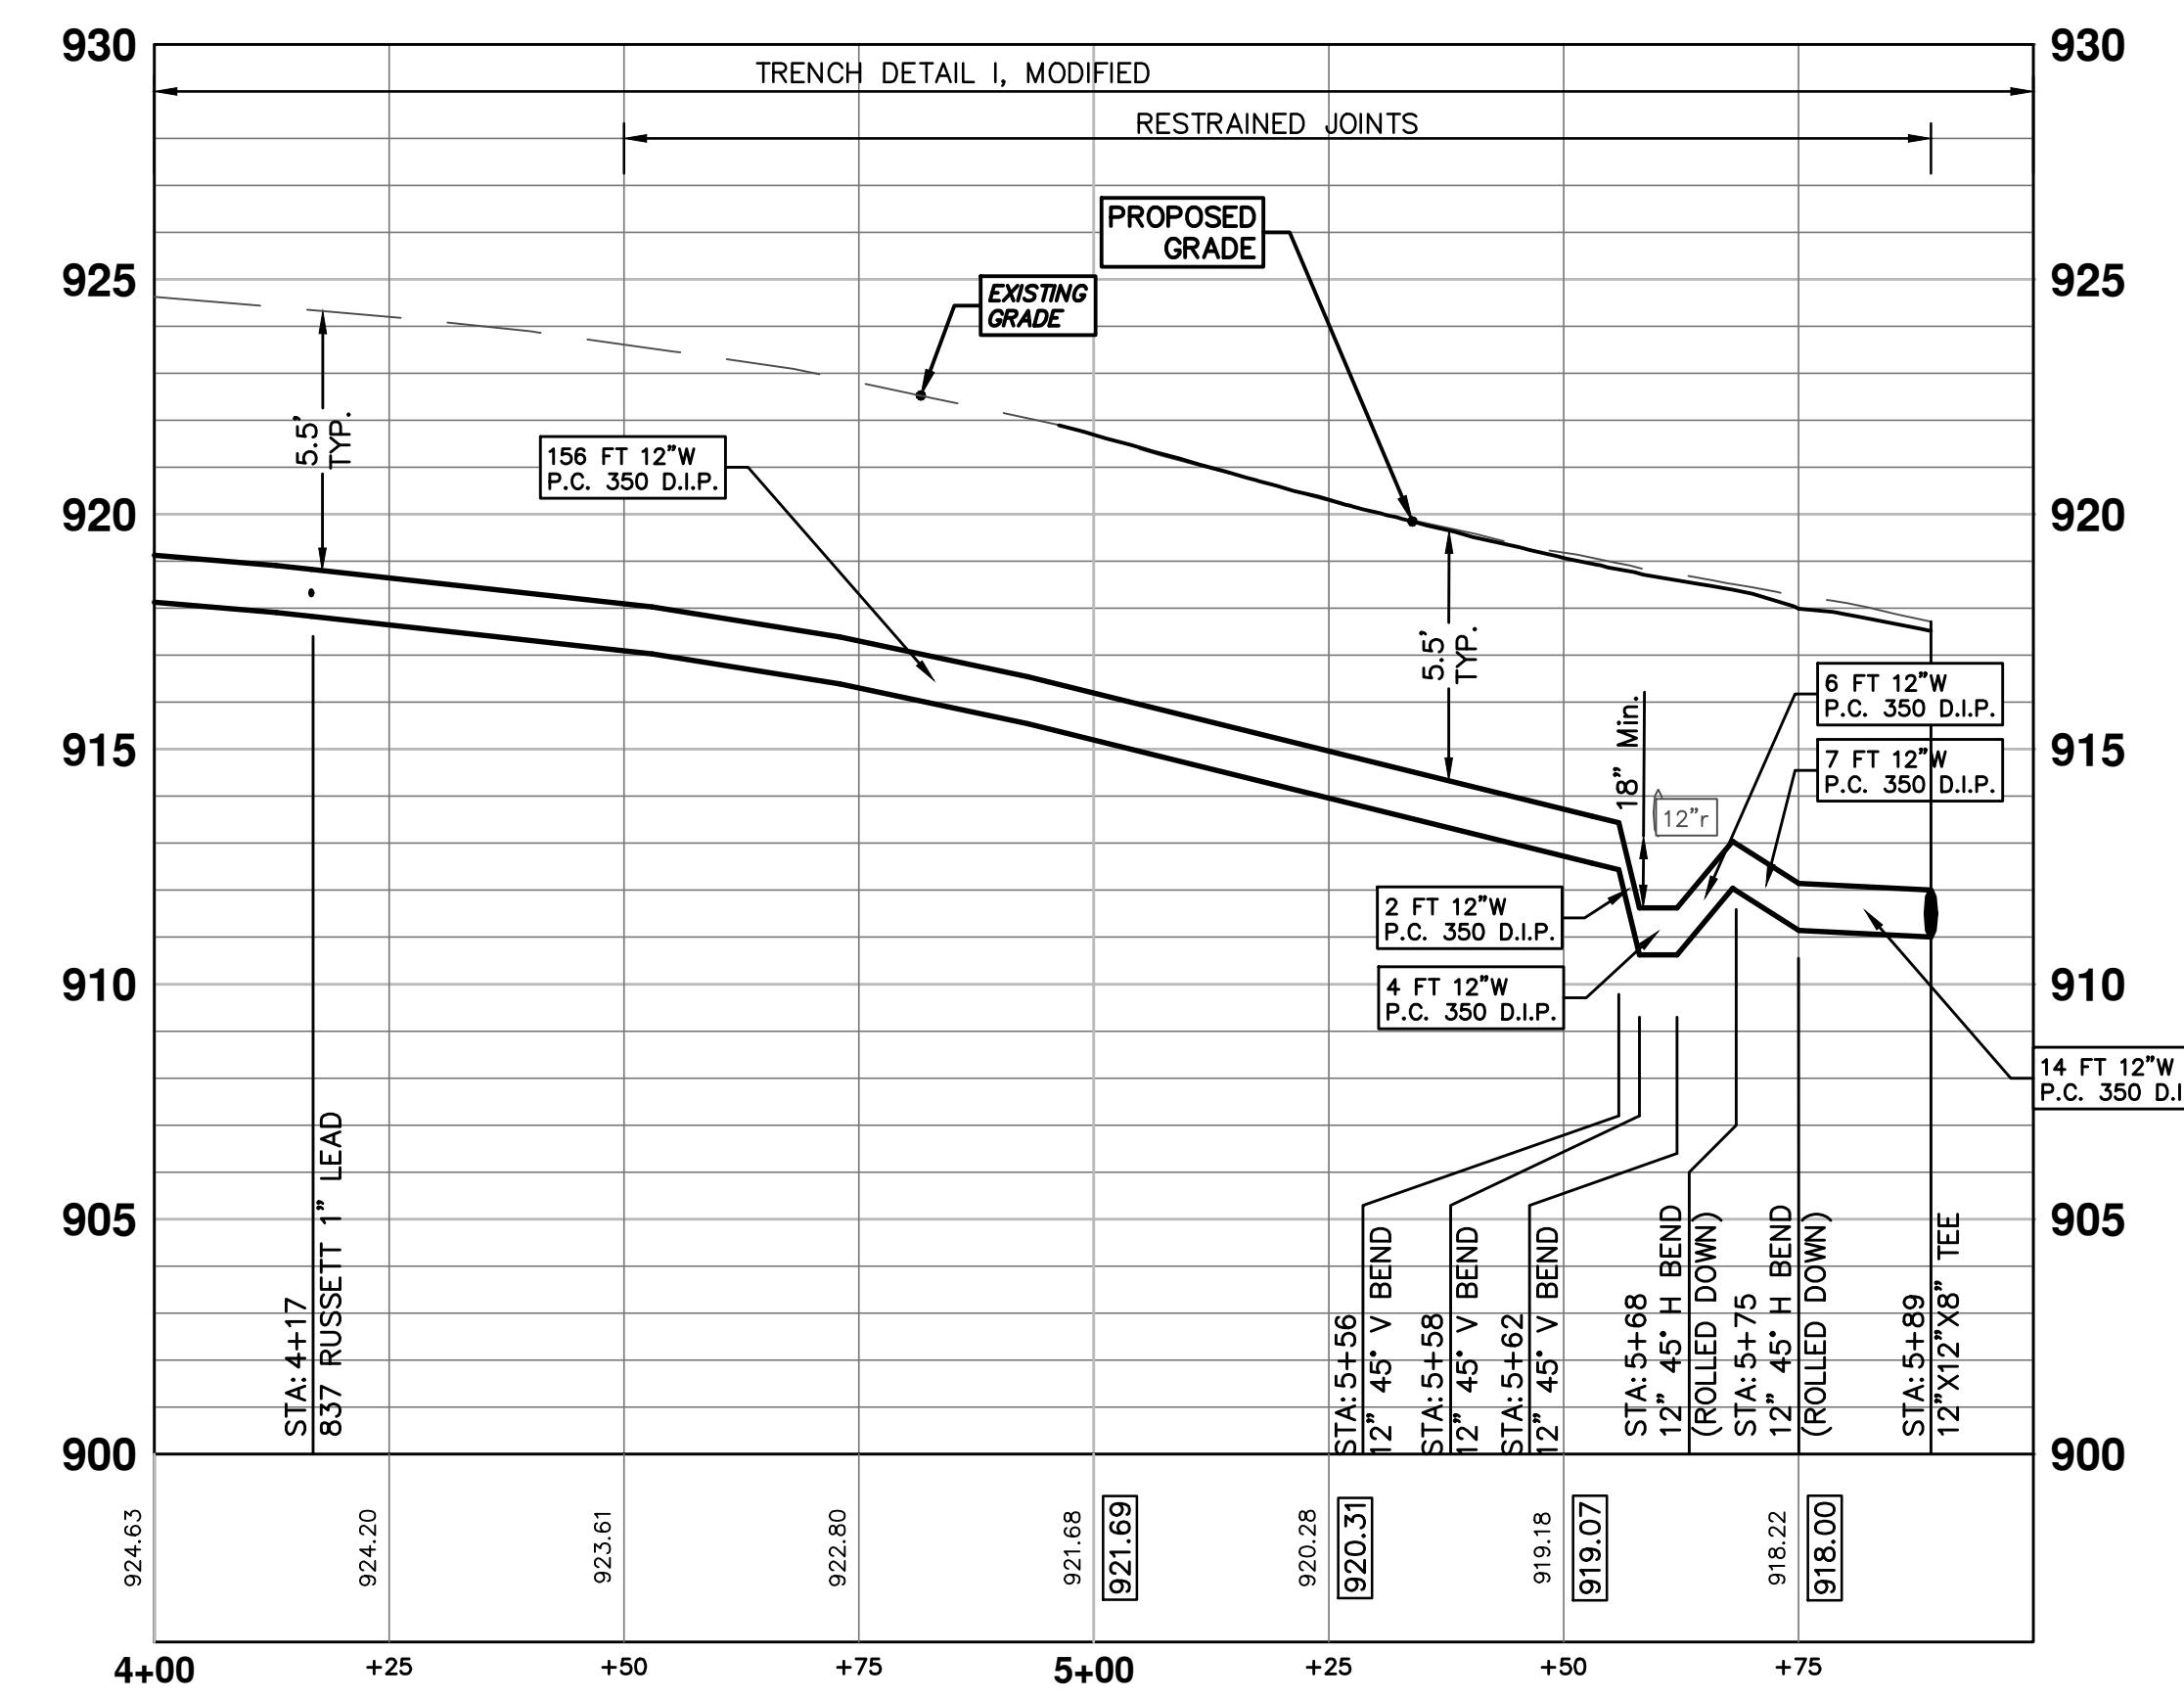
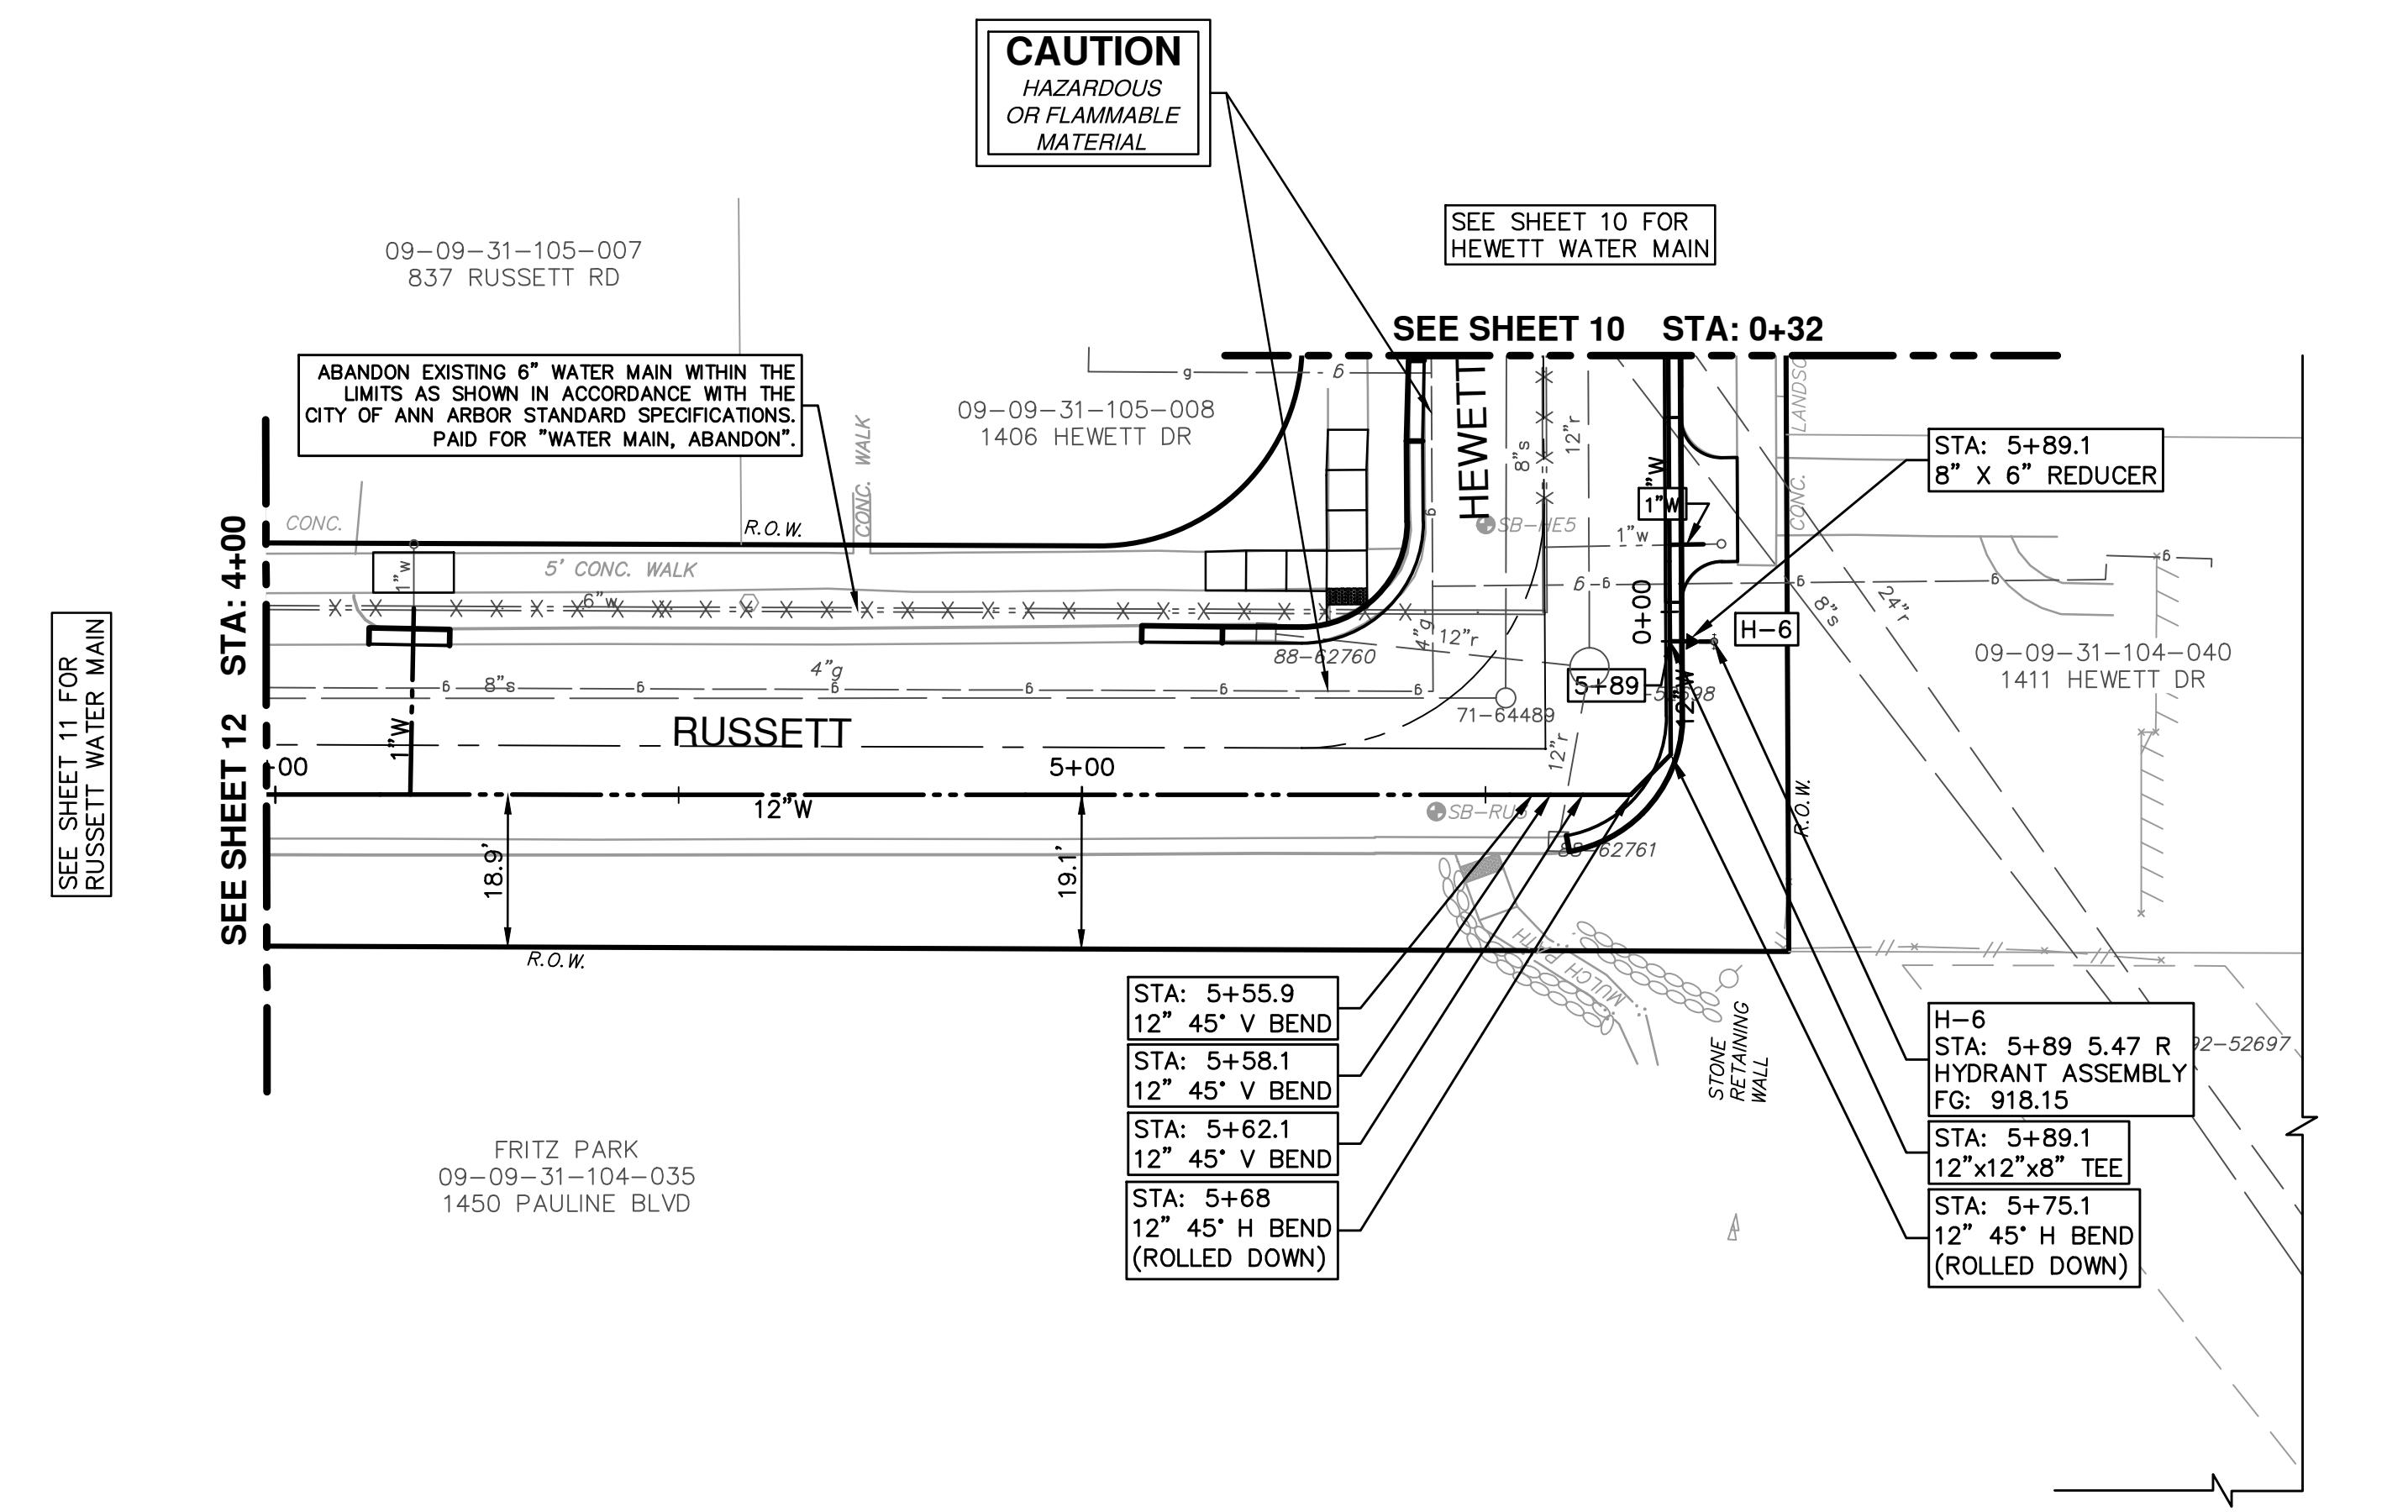
03 ADENDUM 1	05/01/15	JKA	DAD
02 POST MODEQ 2015 REVIEW	05/18/15	JKA	DAD
01 EBERWHITE EXTENSION PERMIT REVIEW COMMENTS	02/26/15	CEC, JKA	DAD
00 MDG PERMIT REVIEW COMMENTS	07-22-14	ES-DPF	DAD
DESCRIPTION	DATE	DRAWN	CHECKED

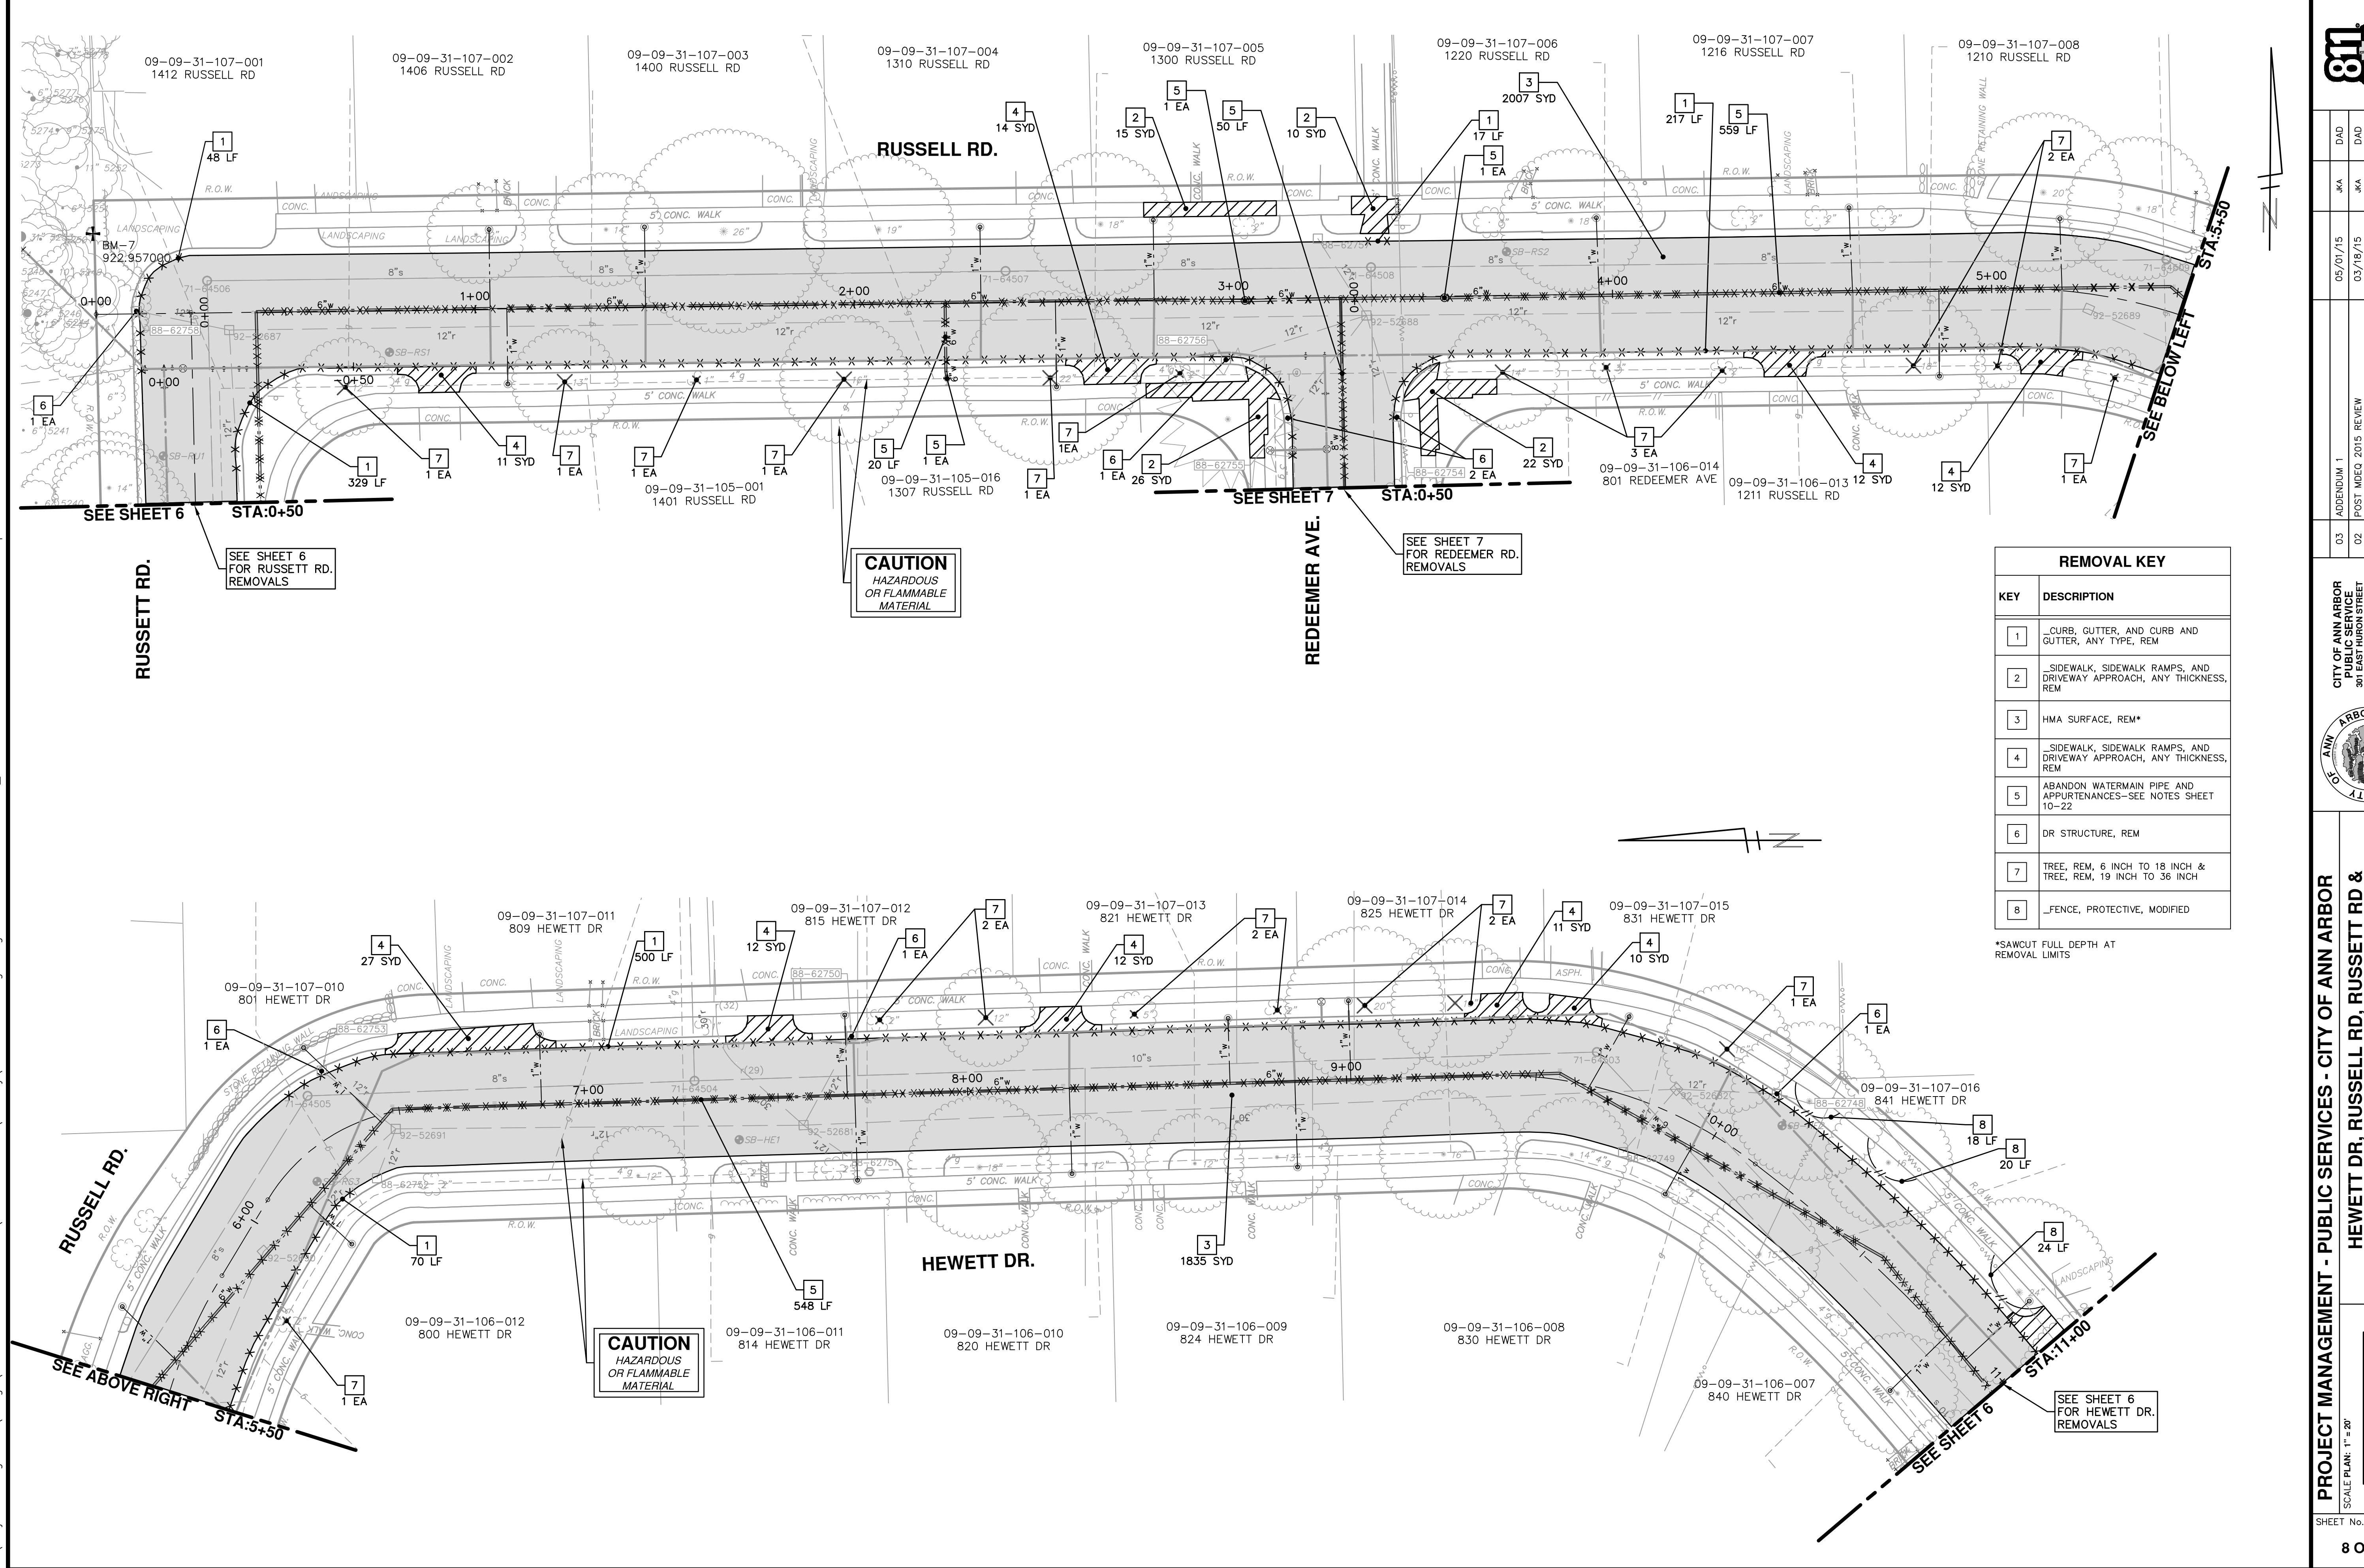

81  
Know what's below.  
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כטבּוֹת בְּרִיאָה

<b>811</b>	<b>Call before you dig.</b>
03 ADDENDUM 1	05/01/15 JK A DAD
02 POST MDEQ 2015 REVIEW	03/18/15 JK A DAD
01 EBERWHITE EXTENSION	02/26/15 CEC, JK A DAD
00 MDEQ PERMIT REVIEW COMMENTS	07-22-14 ES,DPF DAD
REV.	DESCRIPTION DATE DRAWN CHECKED

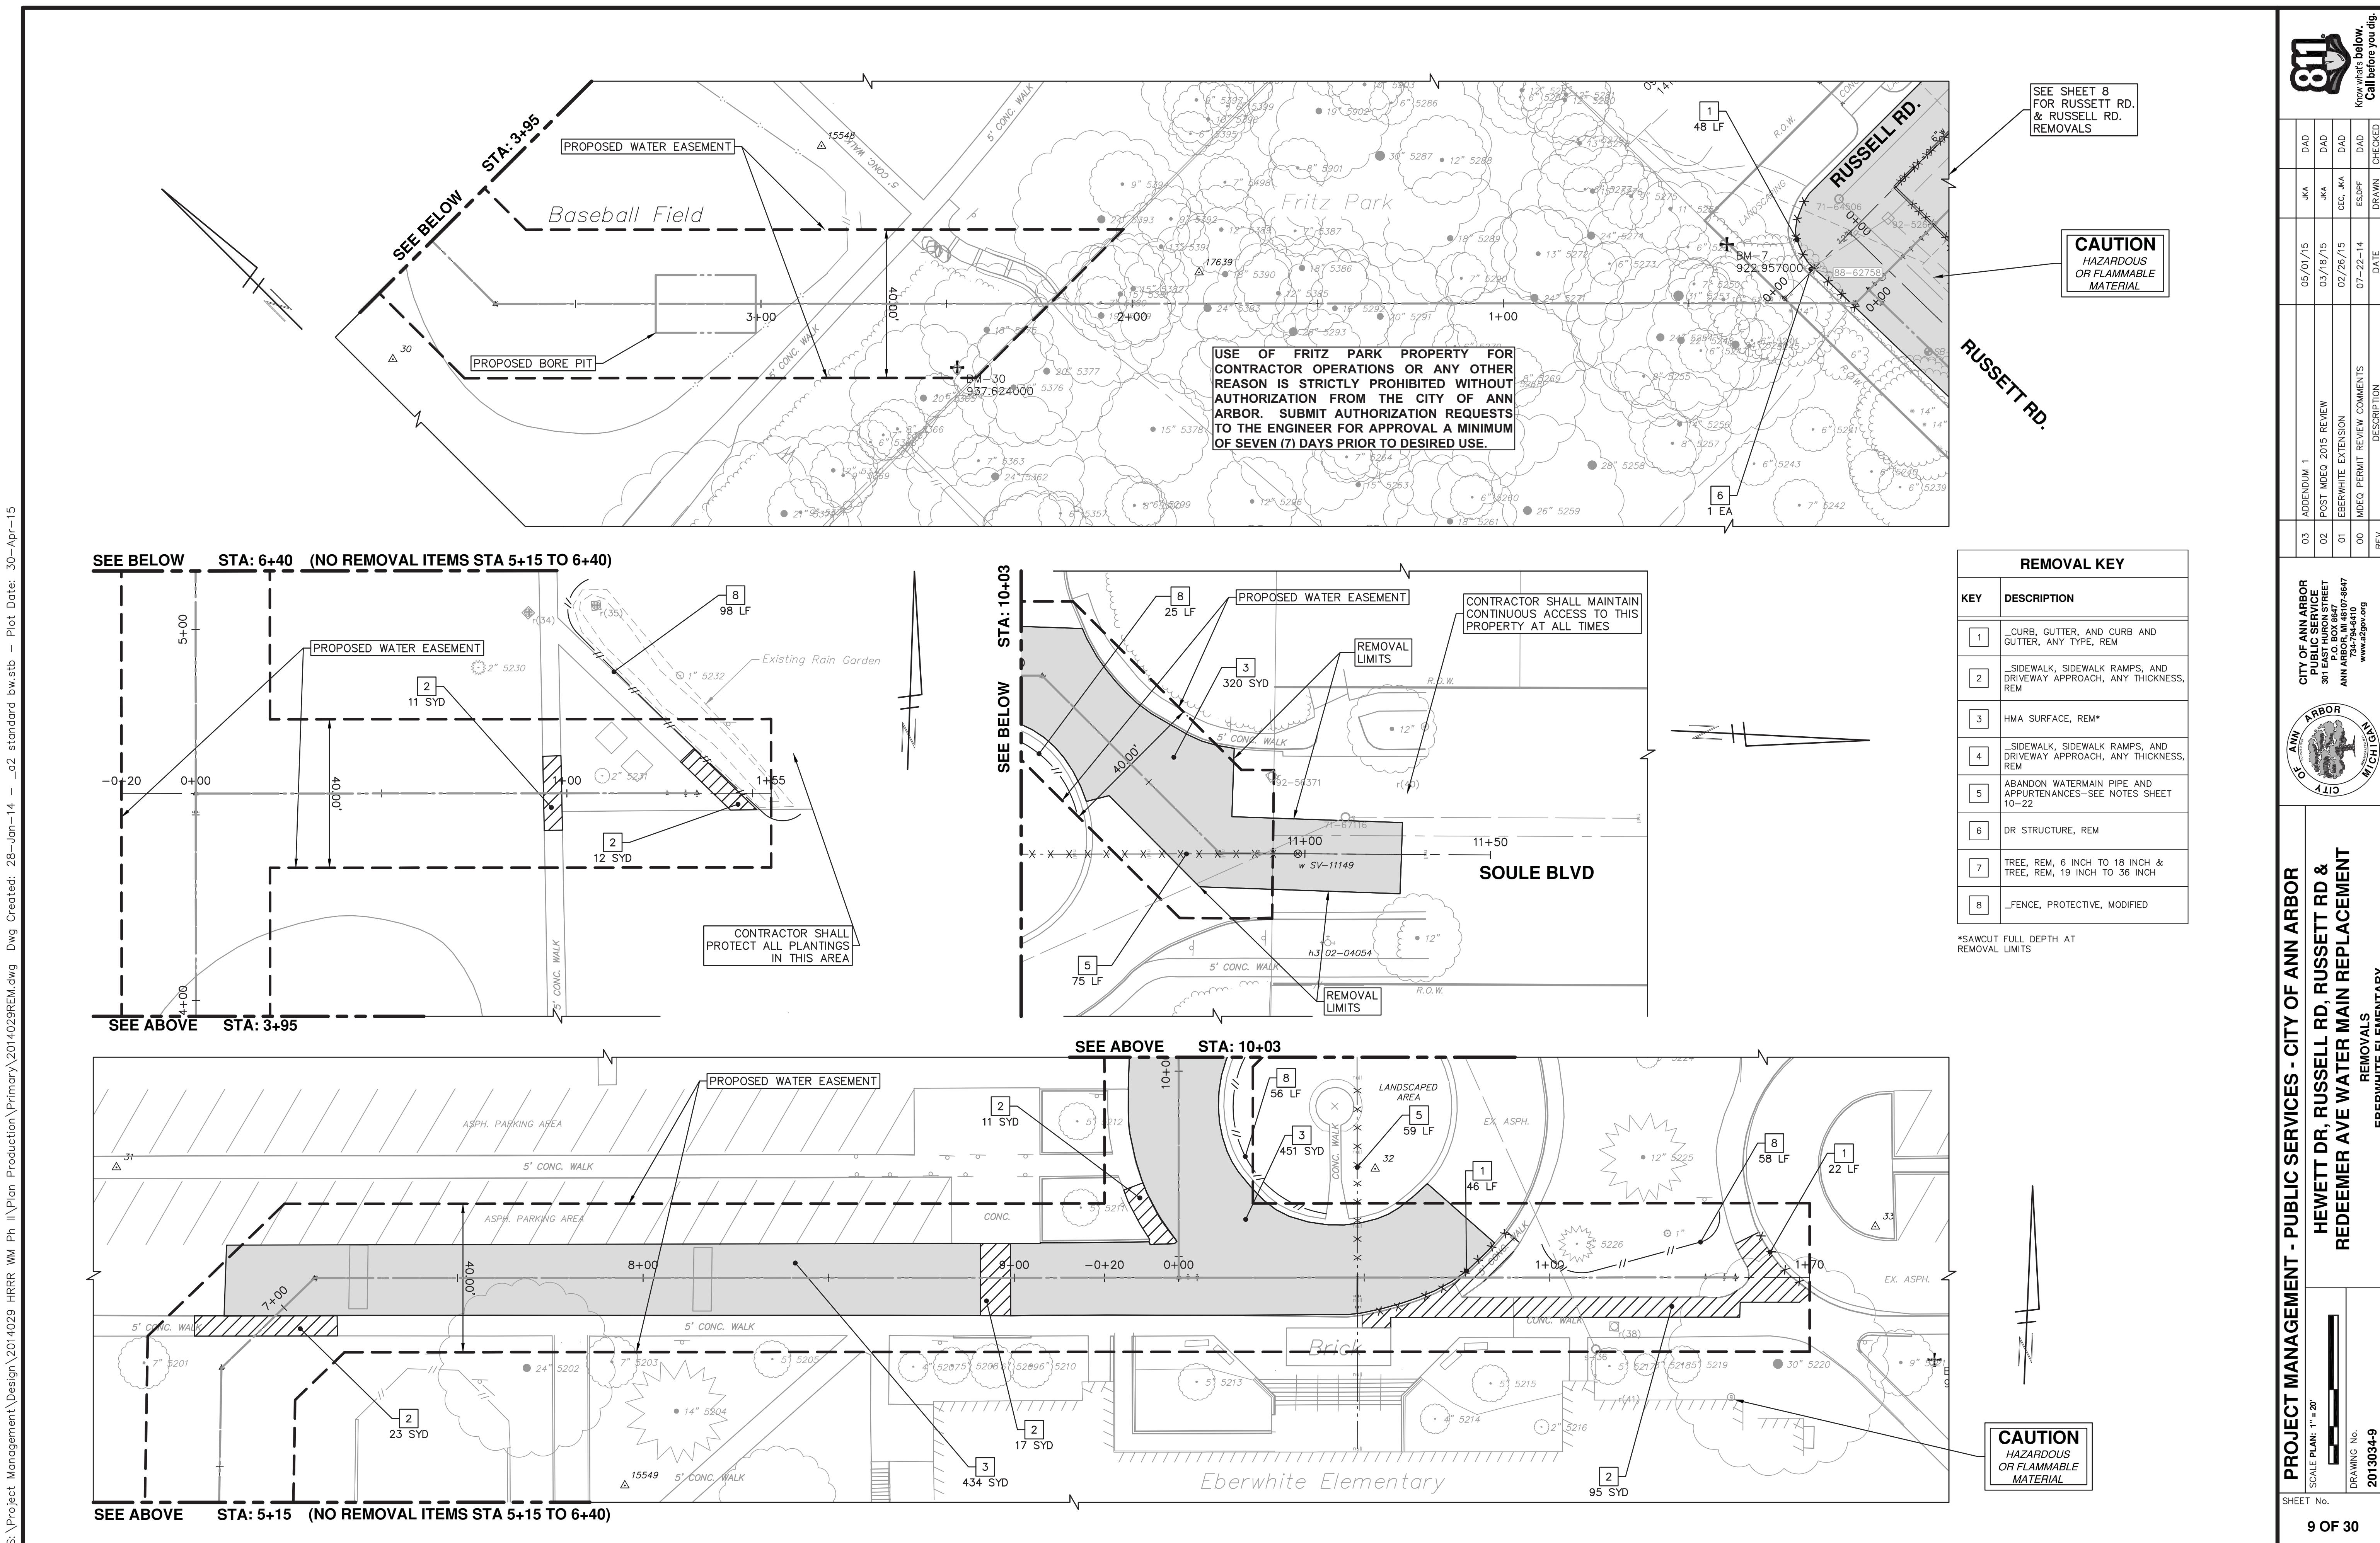

**PUBLIC SERVICES - CITY OF ANN ARBOR**

**HEWETT DR, RUSSELL RD, RUSSETT RD &  
REDEEMER AVE WATER MAIN REPLACEMENT  
WATER MAIN PLAN & PROFILE**

<b>PROJECT MANAGEMENT</b>		
SHEET No.	SCALE PLAN: 1" = 20'	PROFILE: 1" = 4'
		
	DRAWING No.	<b>2013034-11</b>
11 OF 30		

SEE SHEET 13 FOR  
RUSSELL WATER MA

**SEE SHEET 13 FOR RUSSELL STA: 0+86**

09-09-31-107-001  
1412 RUSSELL RD  
09-09-31-107-002  
1406 RUSSELL RD

R.O.W.

LANDSCAPING CONC.

LANDSCAPING

8''S

12''R

12''W

8''W

RUSSELL

V-9

P+00

V-111

CONC.

88-62758

BM-7  
922.957000

11" 5252

9" 5275

15" 5276

6" 5274

14" 5274

6" 5273

13" 5272

24" 5254

7" 250

10" 5249

5253

22" 6" 5247

6" 5248

24" 5254

8" 5255

14" 5256

14" 5257

6" 5243

6" 5244

12" 5245

12" 5246

6" 5247

6" 5248

14" 5256

8" 5257

CONC.

12" W

R.O.W.

09-09-31-1  
807 BLUSCE

ANSWER

MAIN WITHIN THE  
ANCE WITH THE  
RD SPECIFICATIONS.  
NDON"

09-09-31-105-00  
819 RUSSETT RD

09-09  
825

105-005  
ETT RD


09-09-31-105-0  
831 RUSSETT RI

The diagram illustrates the relationship between the horizontal distance  $g$  and the vertical distance of 18.8 meters. It features a horizontal line at the top labeled  $g$ . Below it, a horizontal line is labeled 18.8'. A vertical arrow points upwards from the 18.8' line to the  $g$  line, indicating they are equal in length.

## **WATER MAIN STRUCTURE TABLE**

WATER MAIN STRUCTURE TABLE					
STRUCTURE	TYPE	STATION	ALIGNMENT	RIM	DEPTH
V-9	8" GVIW	0+05	Pr Water Russell-Hewett Loop	920.47	6.80
V-11	12" GVIB	0+05	Pr Water Russett	920.51	6.46
H-5	HYDRANT ASSEMBLY	2+72	Pr Water Russett	927.60	7.02
V-12	12" GVIB	2+77	Pr Water Russett	926.62	6.50

SEE SHEET 20 FOR  
EBERWHITE WATER MAIN

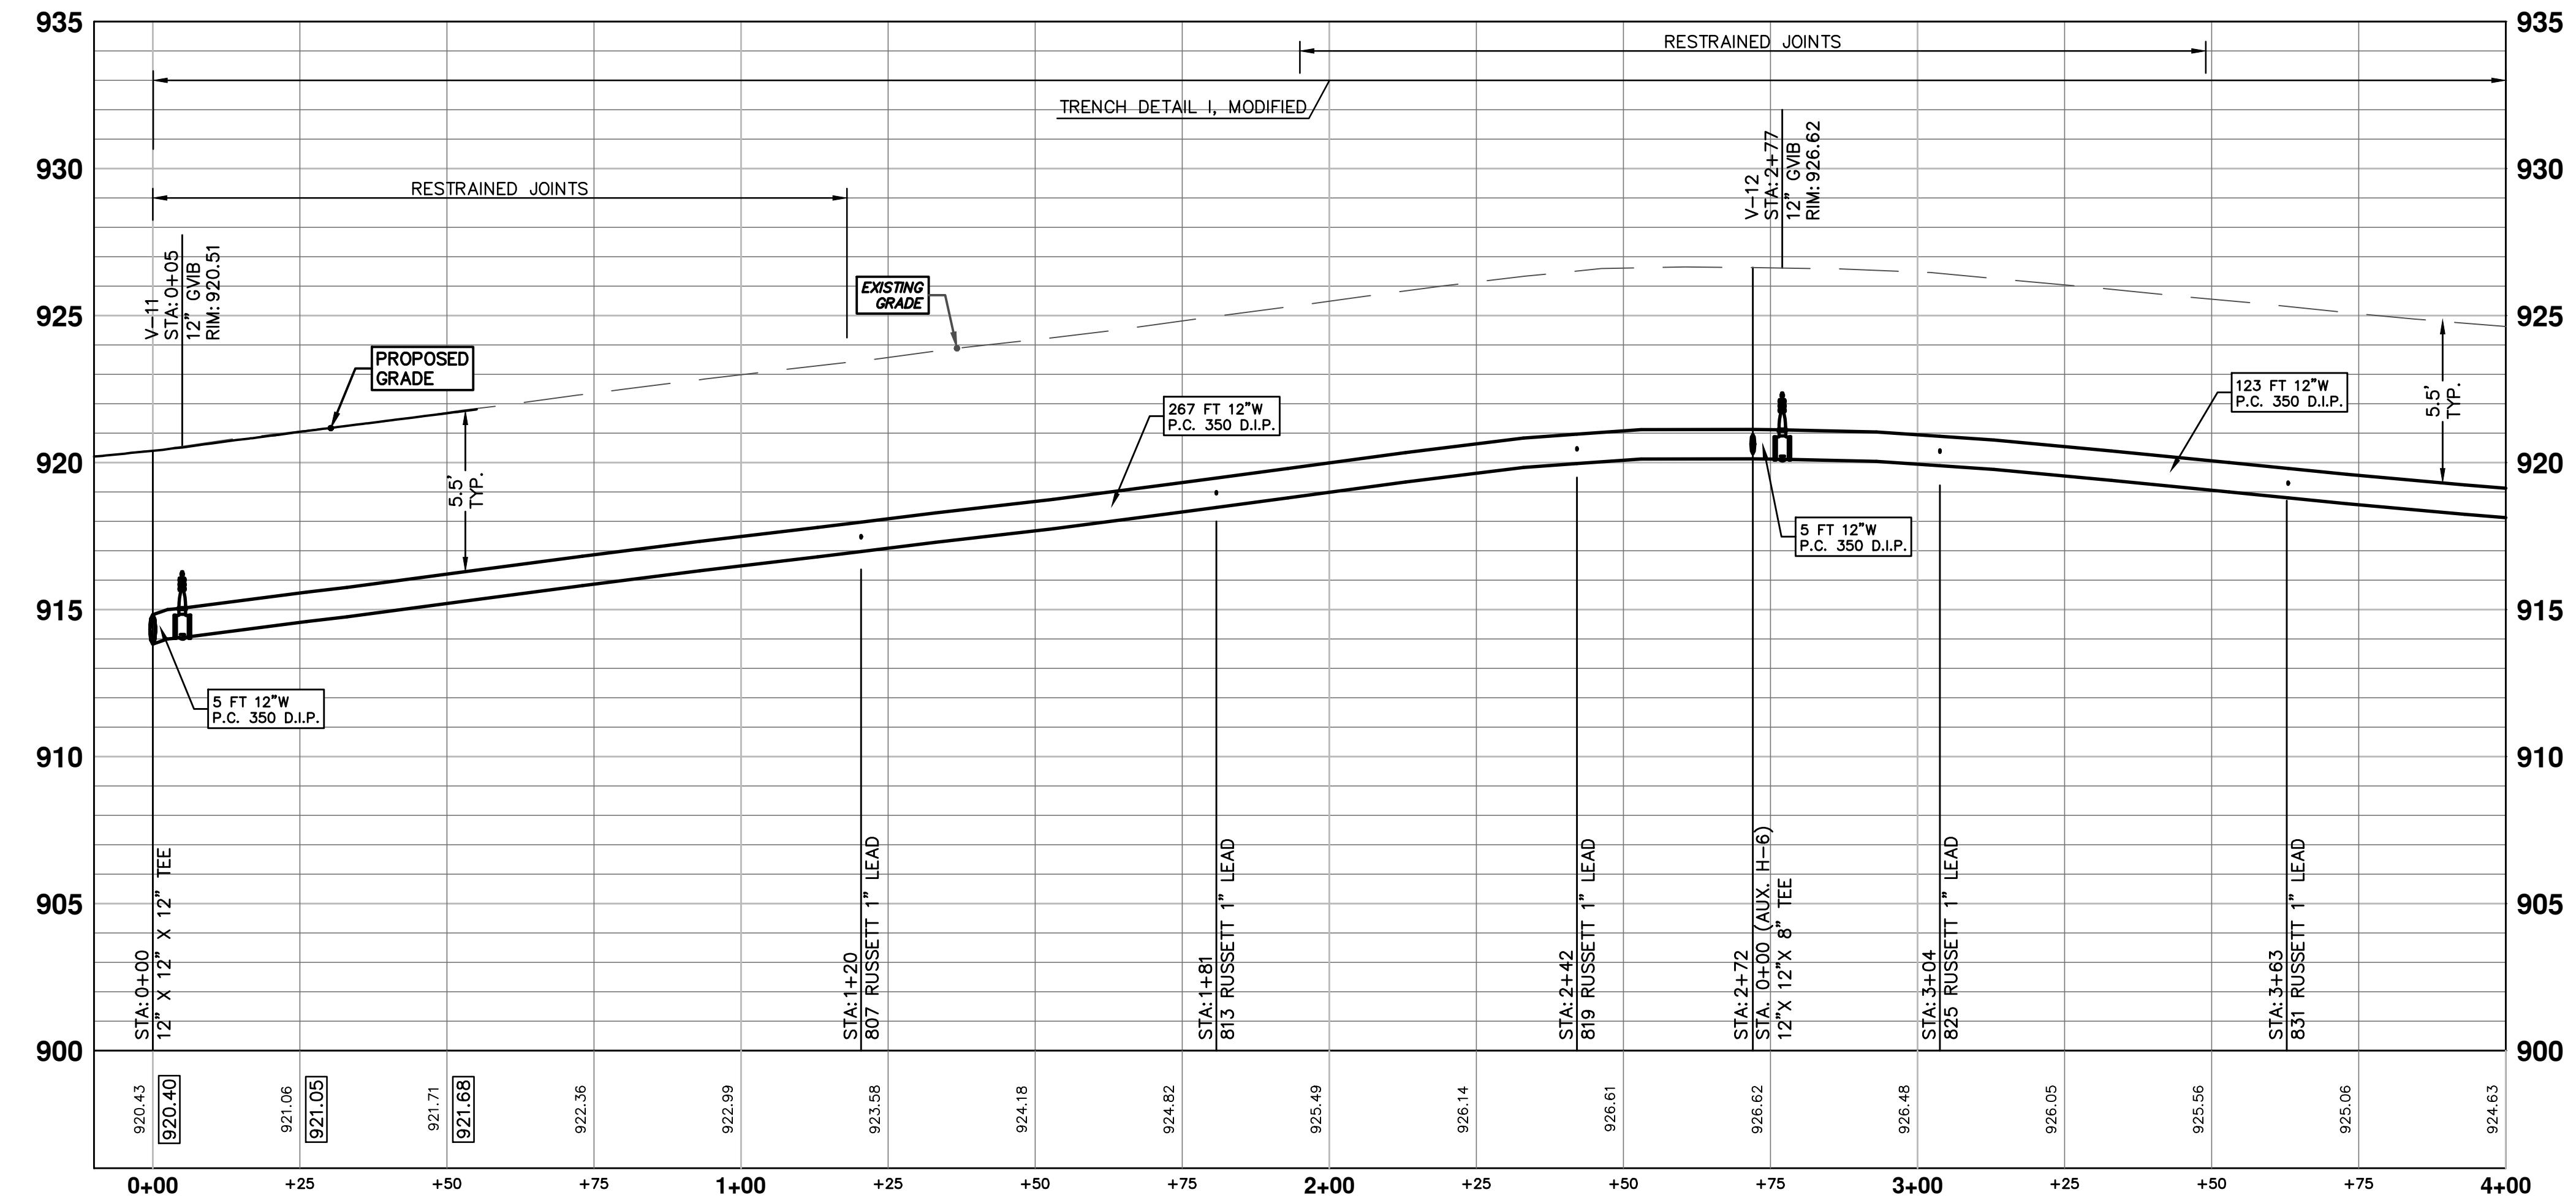

know what's new.  
**Call before you dig.**

The seal of the City of Ann Arbor. It features a circular design with "CITY OF ANN ARBOR" at the top and "MICHIGAN" at the bottom. In the center is a map of the city's geographic area.

**PUBLIC SERVICES - CITY OF ANN ARBOR**

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**HEWETT DR, RUSSELL RD, RUSSETT RD &  
REDEEMER AVE WATER MAIN REPLACEMENT**

**WATER MAIN PLAN & PROFILE**


**PUBLIC SERVICES - CITY OF ANN ARBOR**

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**HEWETT DR, RUSSELL RD, RUSSETT RD &  
REDEEMER AVE WATER MAIN REPLACEMENT**


**WATER MAIN PLAN & PROFILE**

<b>PROJECT MANAGEMENT -</b>	
SCALE PLAN: 1" = 20'	PROFILE: 1" = 4'
	
DRAWING No.	201203412
SHEET No.	1

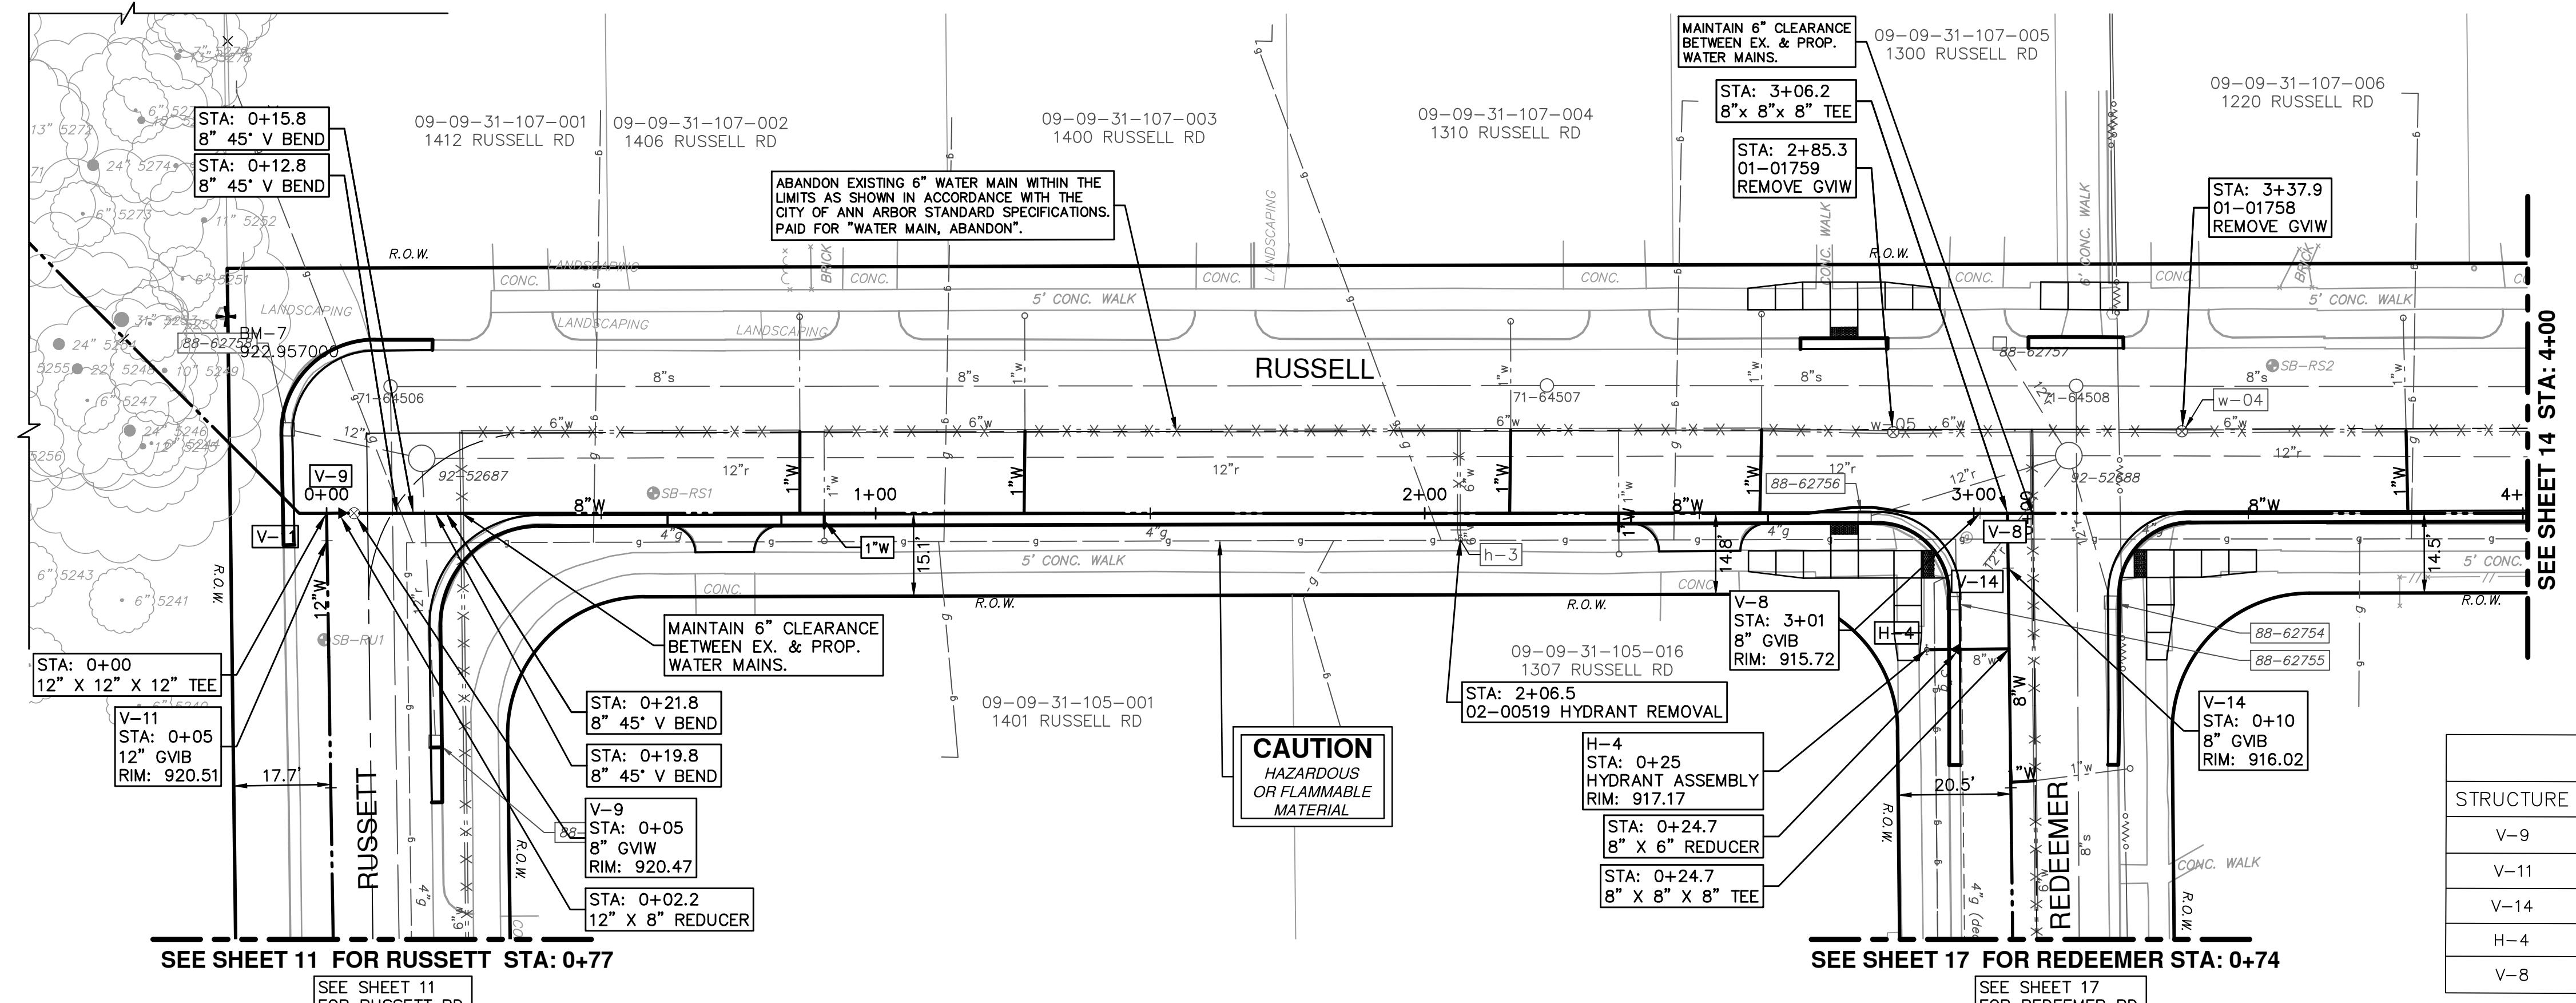

SEE SHEET 14 FOR  
RUSSELL RD./HEWETT  
RD. WATER MAIN

REVIEW	03 ADENDUM 1	02 POST MODEQ 2015 REVIEW	01 EBWHITE EXTENSION	02/26/15	JKA DAD
00 MDG PERMIT REVIEW COMMENTS	02/22/14	CEC JKA DAD			
REV.	DESCRIPTION	DATE	REV.	DATE	DRAWN CHECKED


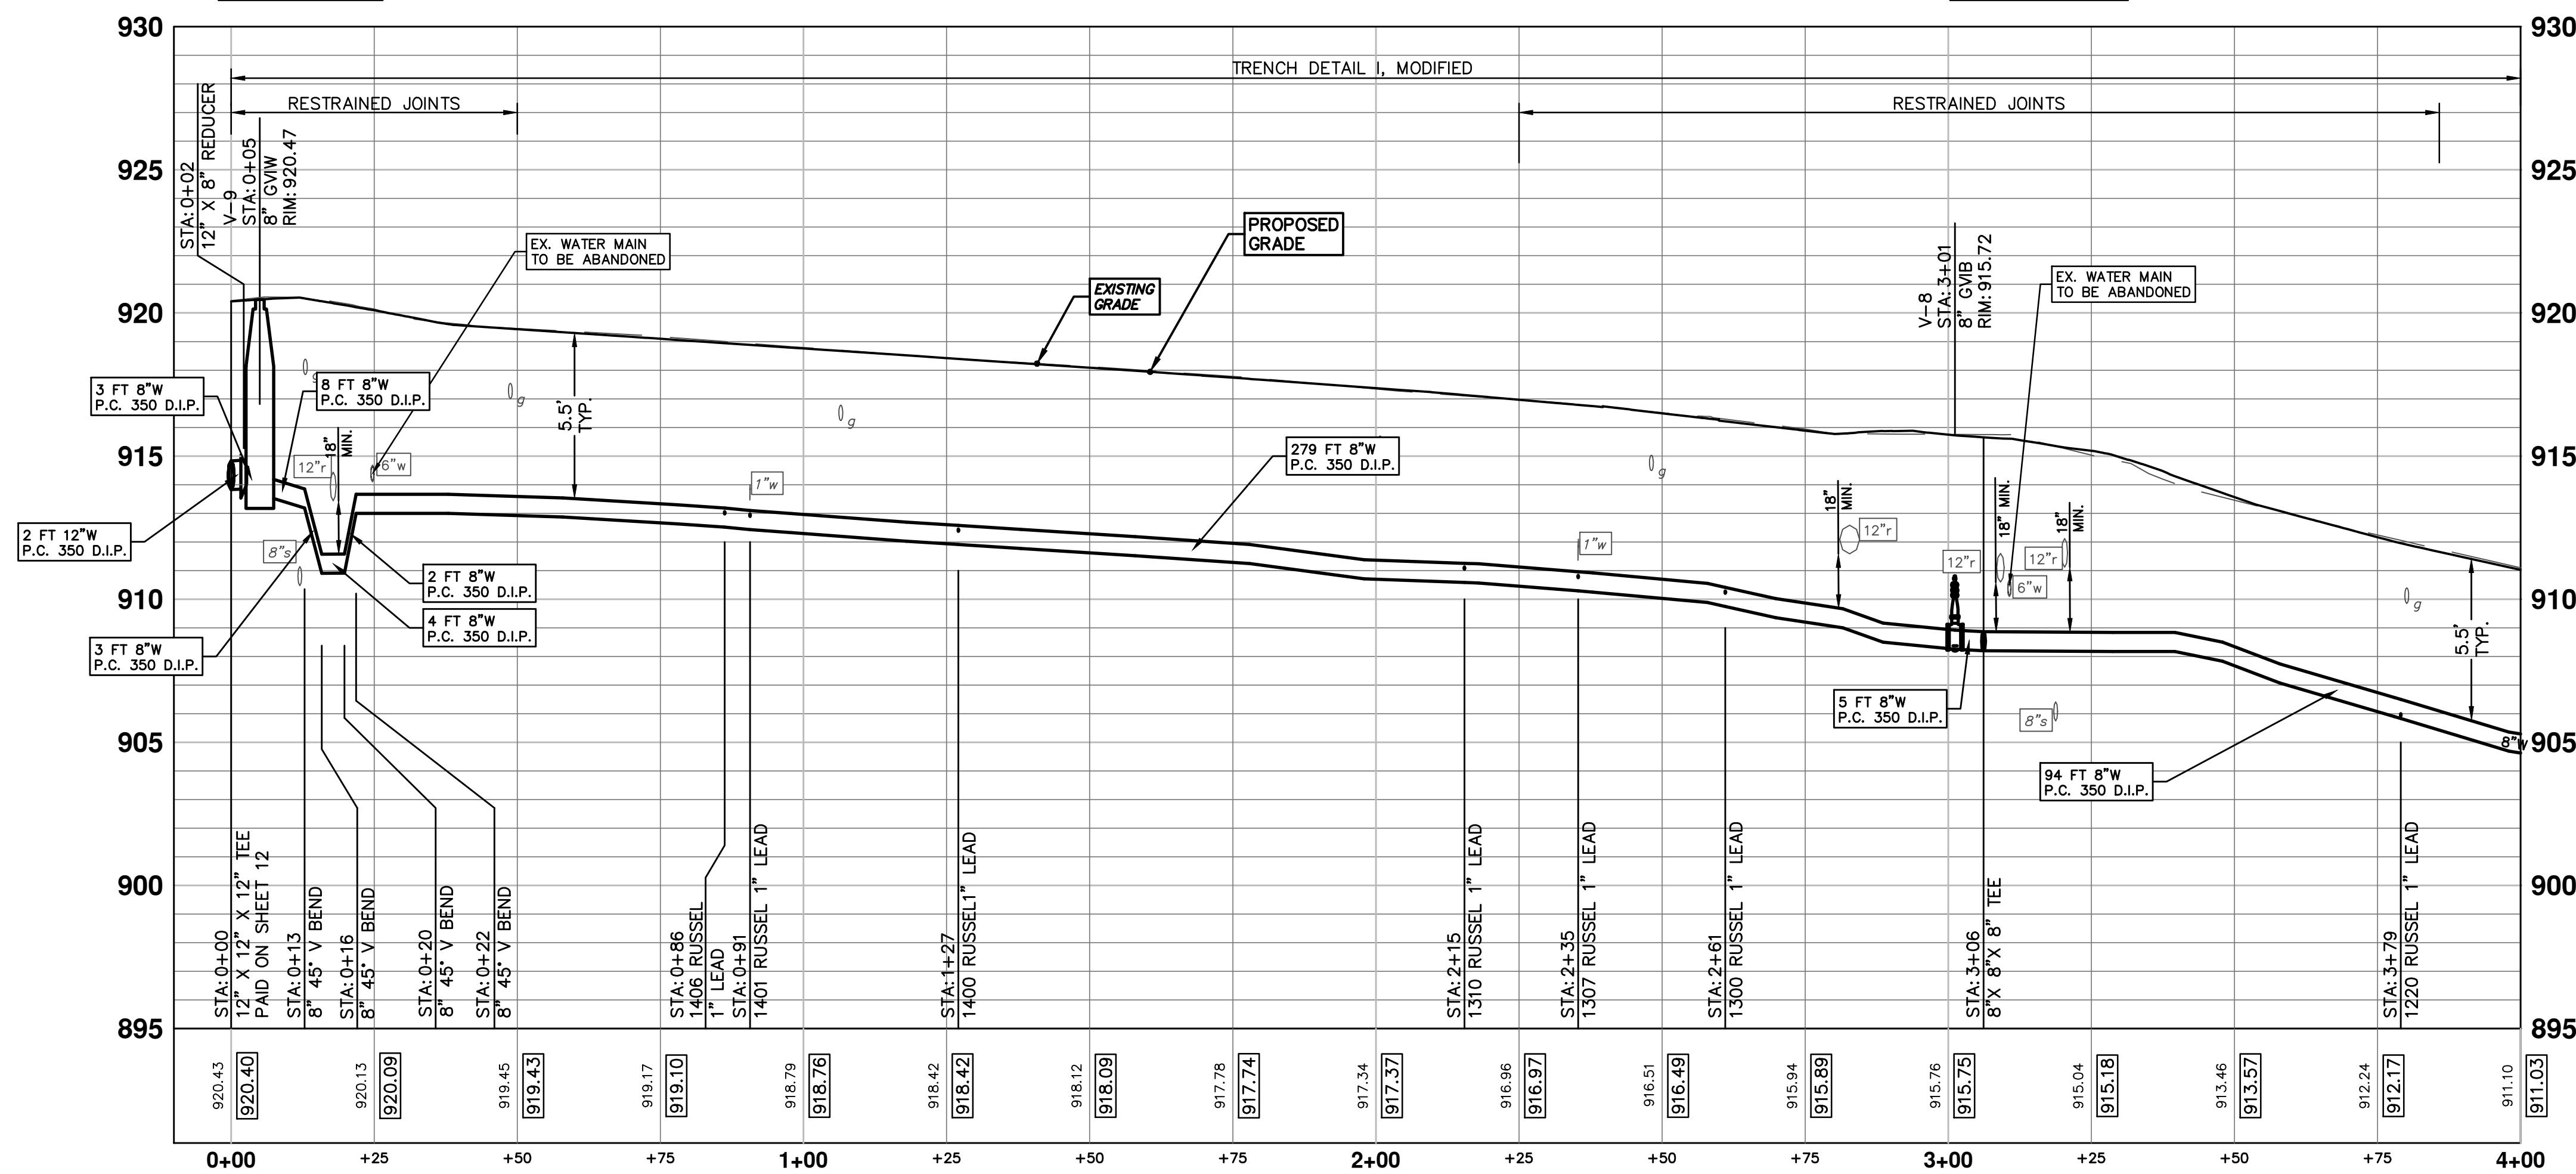


PROJECT MANAGEMENT - PUBLIC SERVICES - CITY OF ANN ARBOR		HEWETT DR, RUSSETT RD & REDEEMER AVE WATER MAIN REPLACEMENT	
SCALE PLAN 1" = 4'		DRAWING No. 2013034-13	
PROFILE 1" = 20'	LEAD	WATER MAIN PLAN & PROFILE	RUSSELL - HEWETT LOOP STA 0-00 TO 4+00

SHEET No. 13 OF 30



Know what's below.  
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ANN ARBOR SERVICE		IRON STREET BOX 8647 MI 48107-8647 946-6410 2gov.org		Know what's below. Call before you dig.	
REV.	DESCRIPTION	DATE	DRAWN	CHECKED	
03	ADDENDUM 1	05/01/15	JKA	DAD	
02	POST MDEQ 2015 REVIEW	03/18/15	JKA	DAD	
01	EBERWHITE EXTENSION	02/26/15	CEC, JKA	DAD	
00	MDEQ PERMIT REVIEW COMMENTS	07-22-14	ES,DPF	DAD	

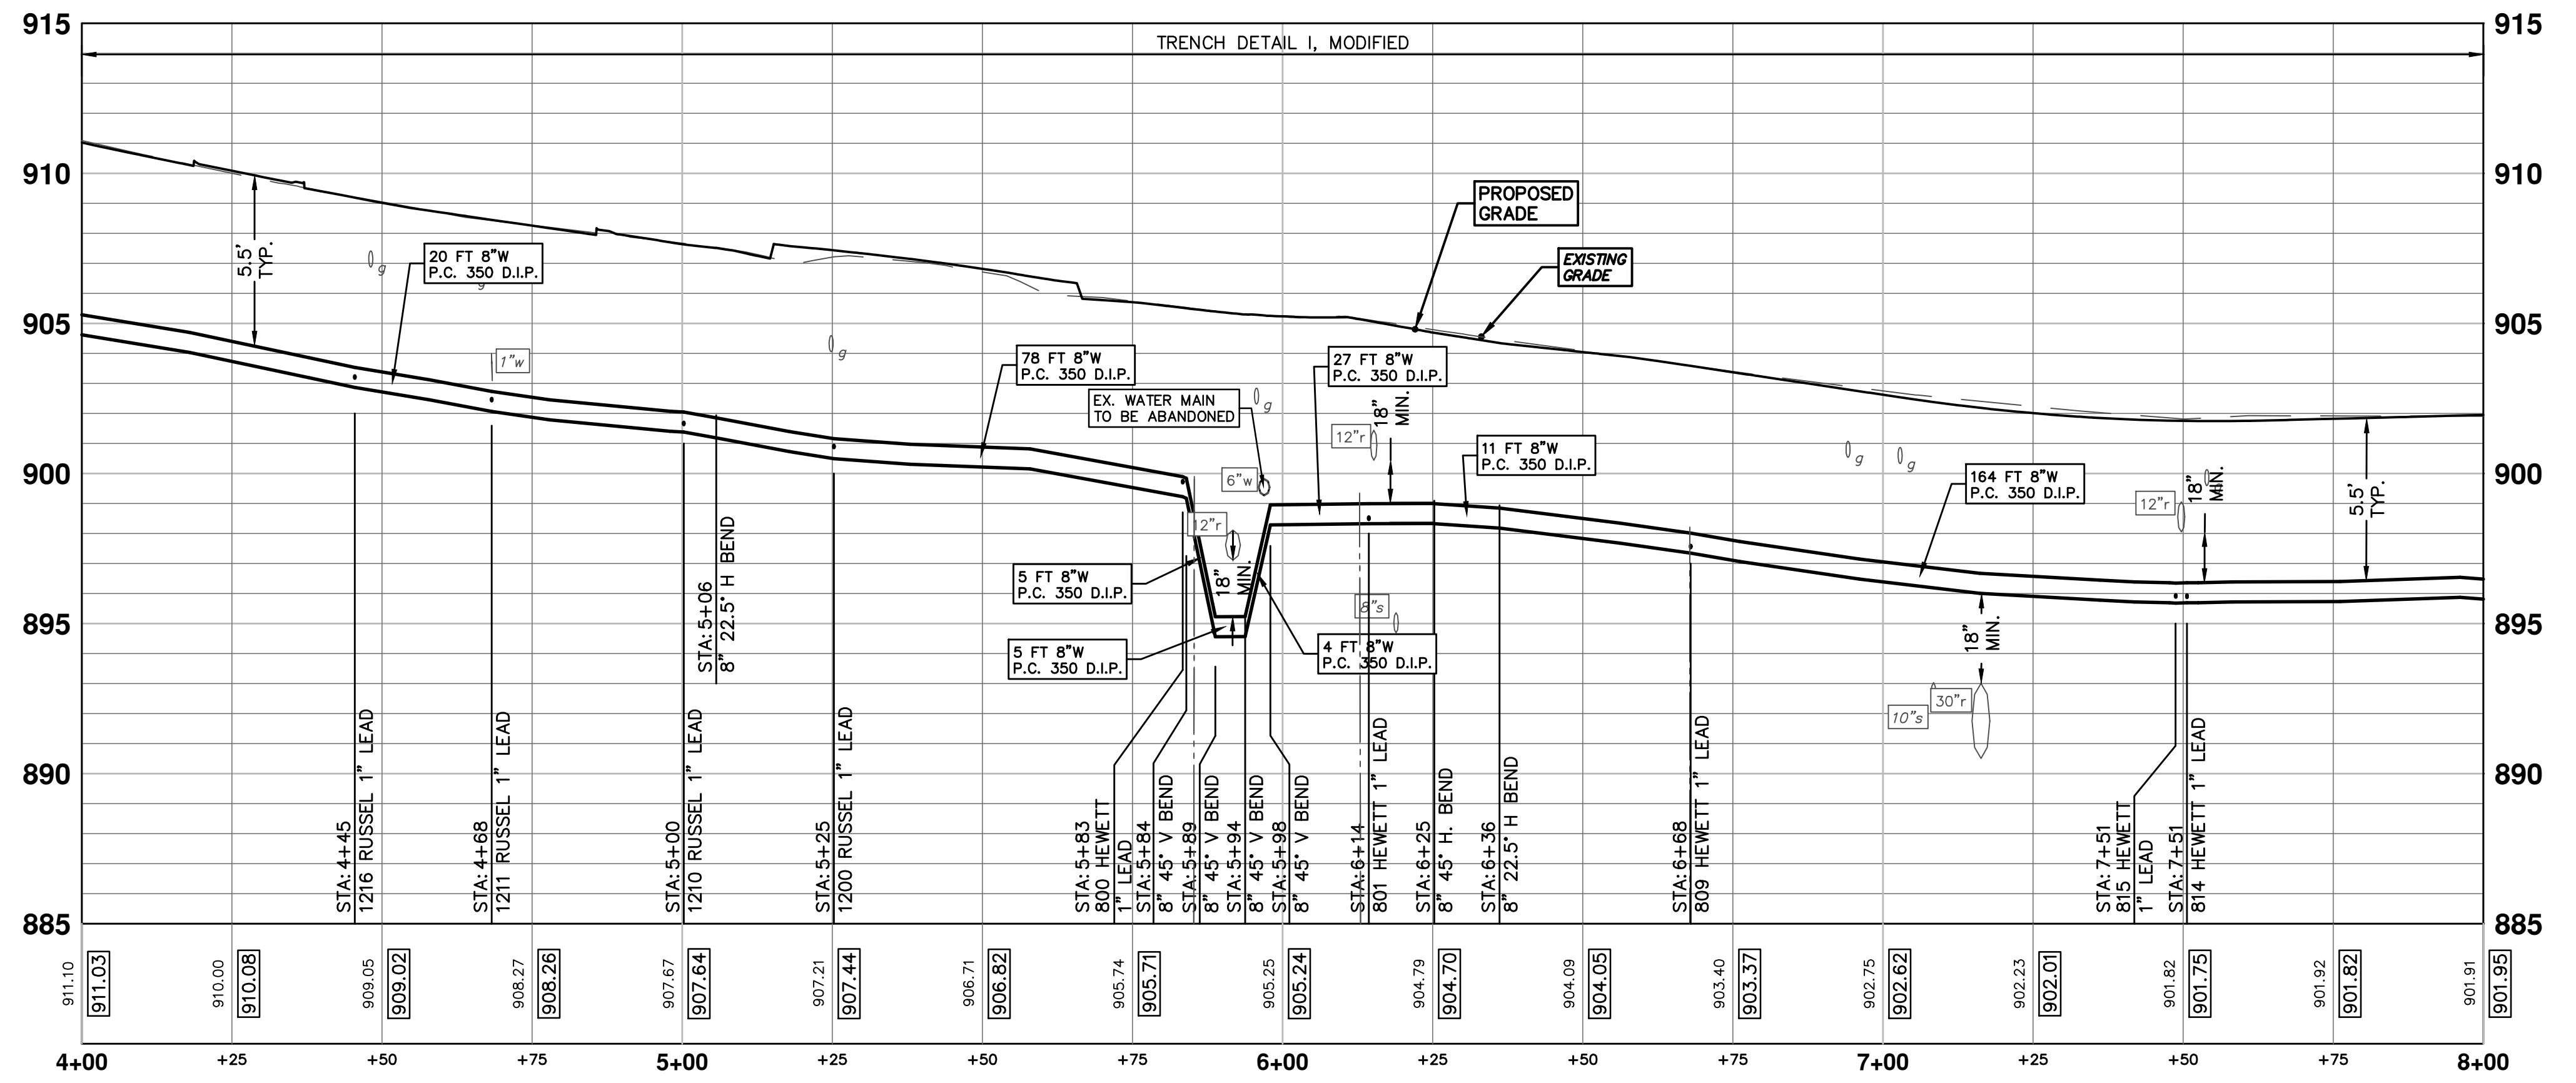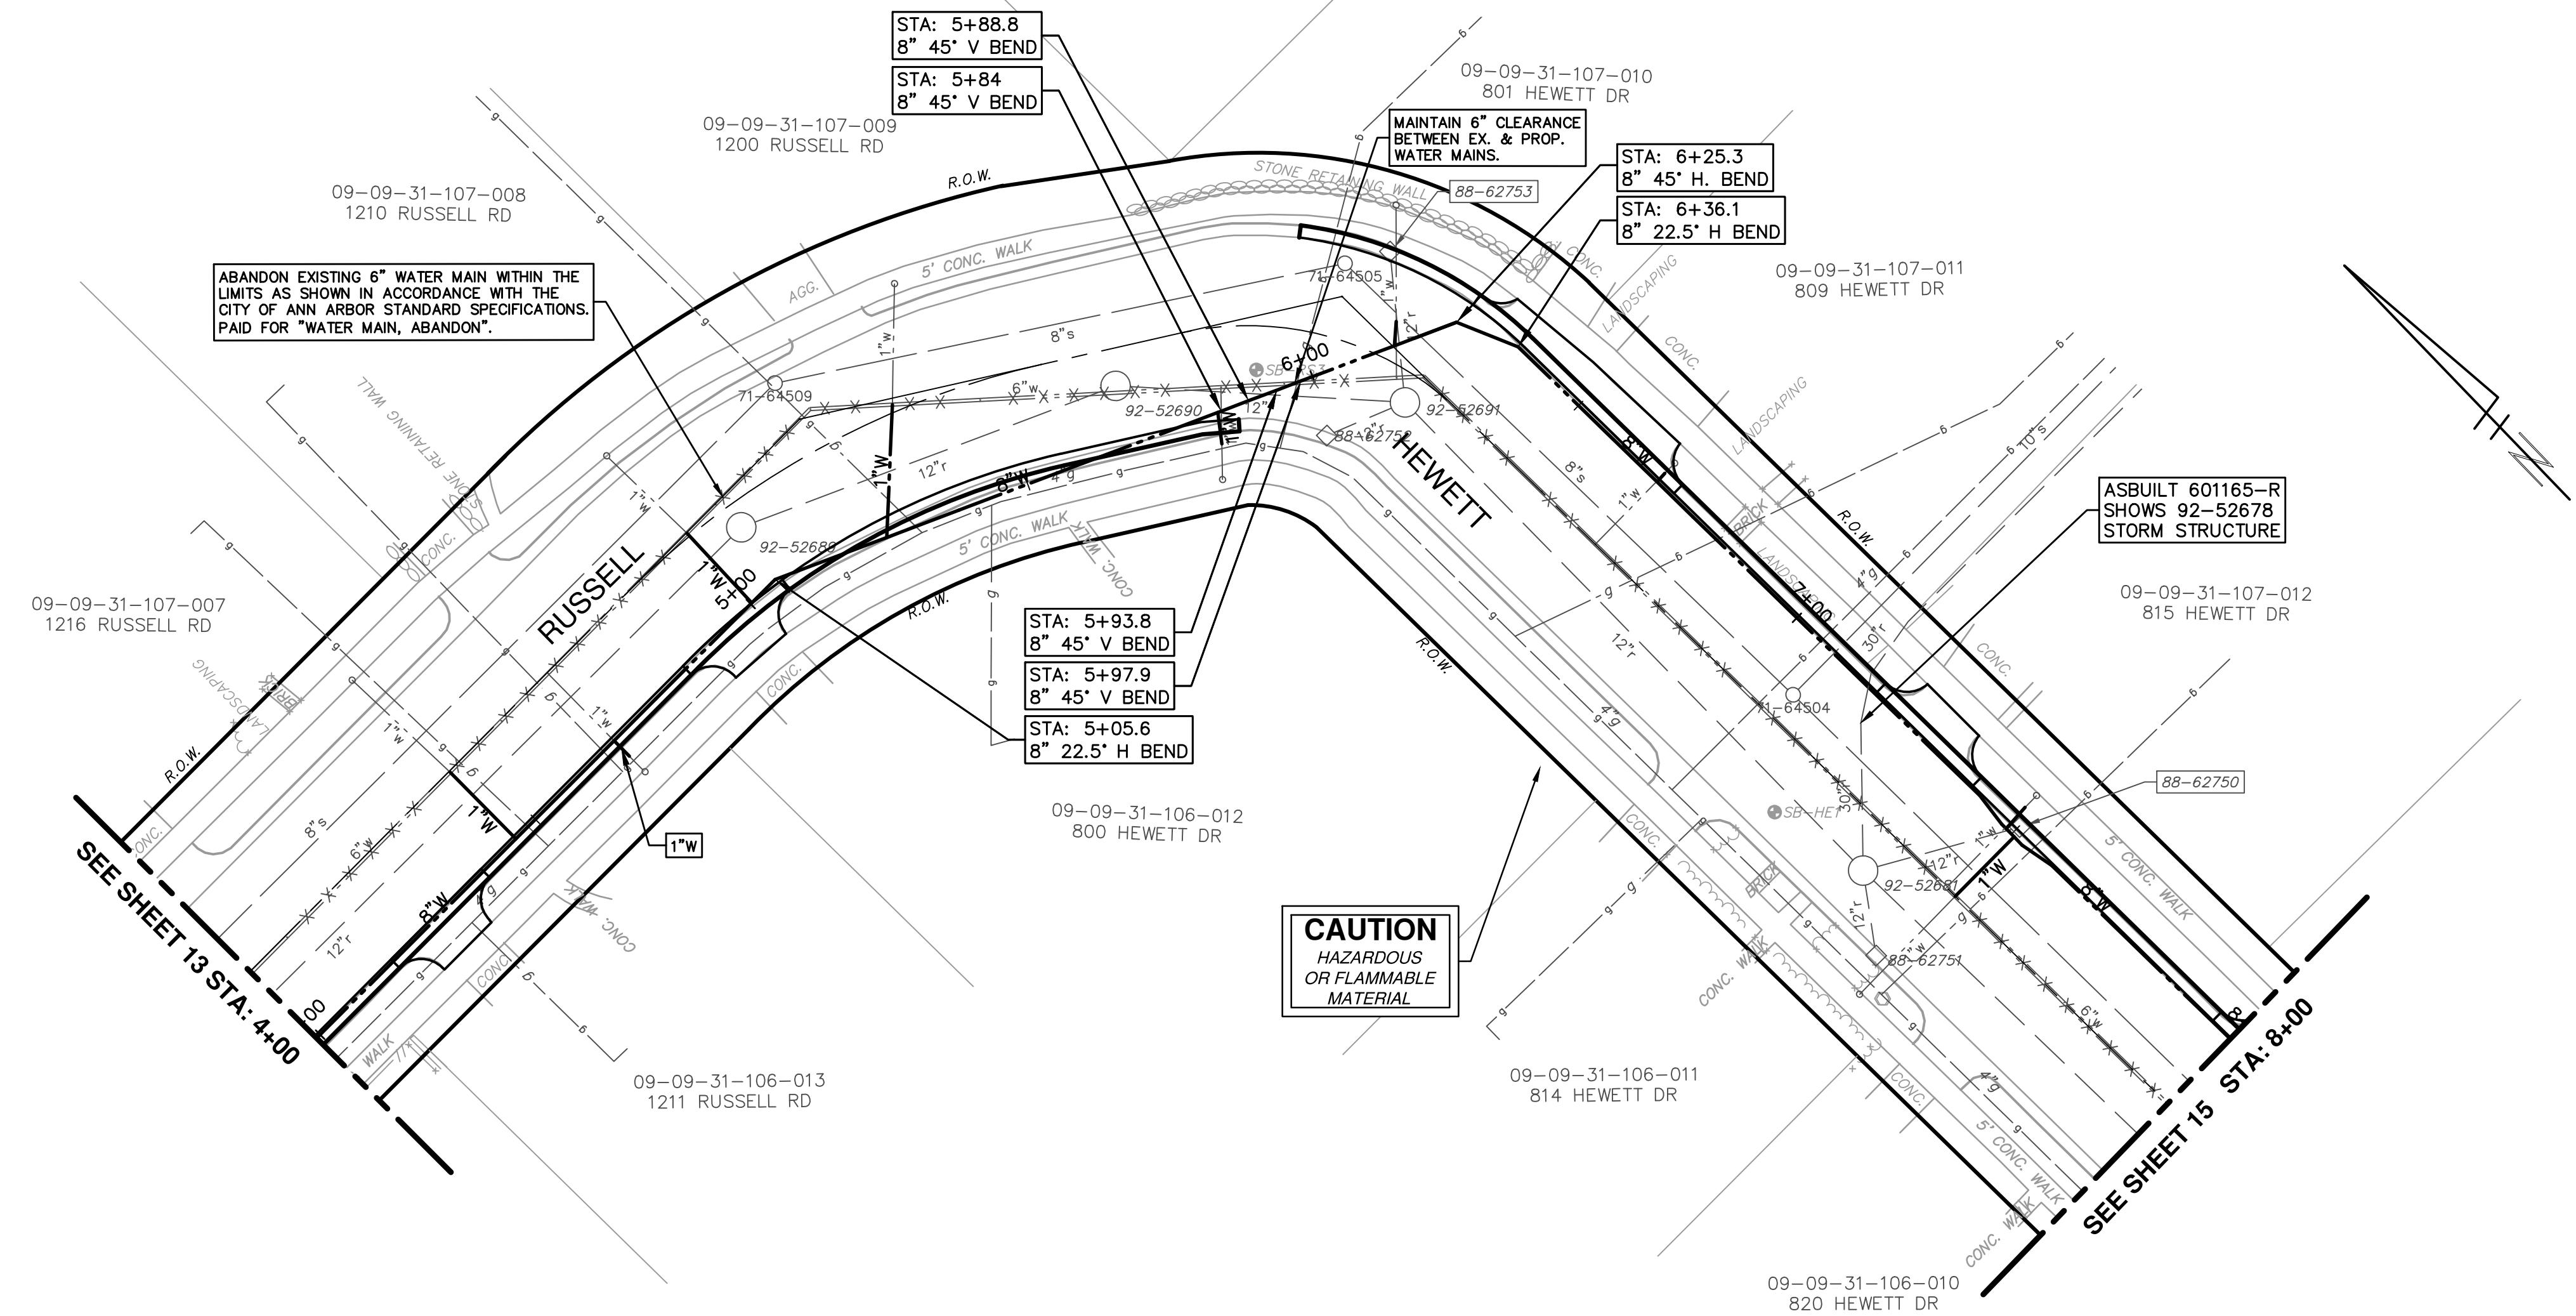



**T - PUBLIC SERVICES - CITY OF ANN ARBOR**

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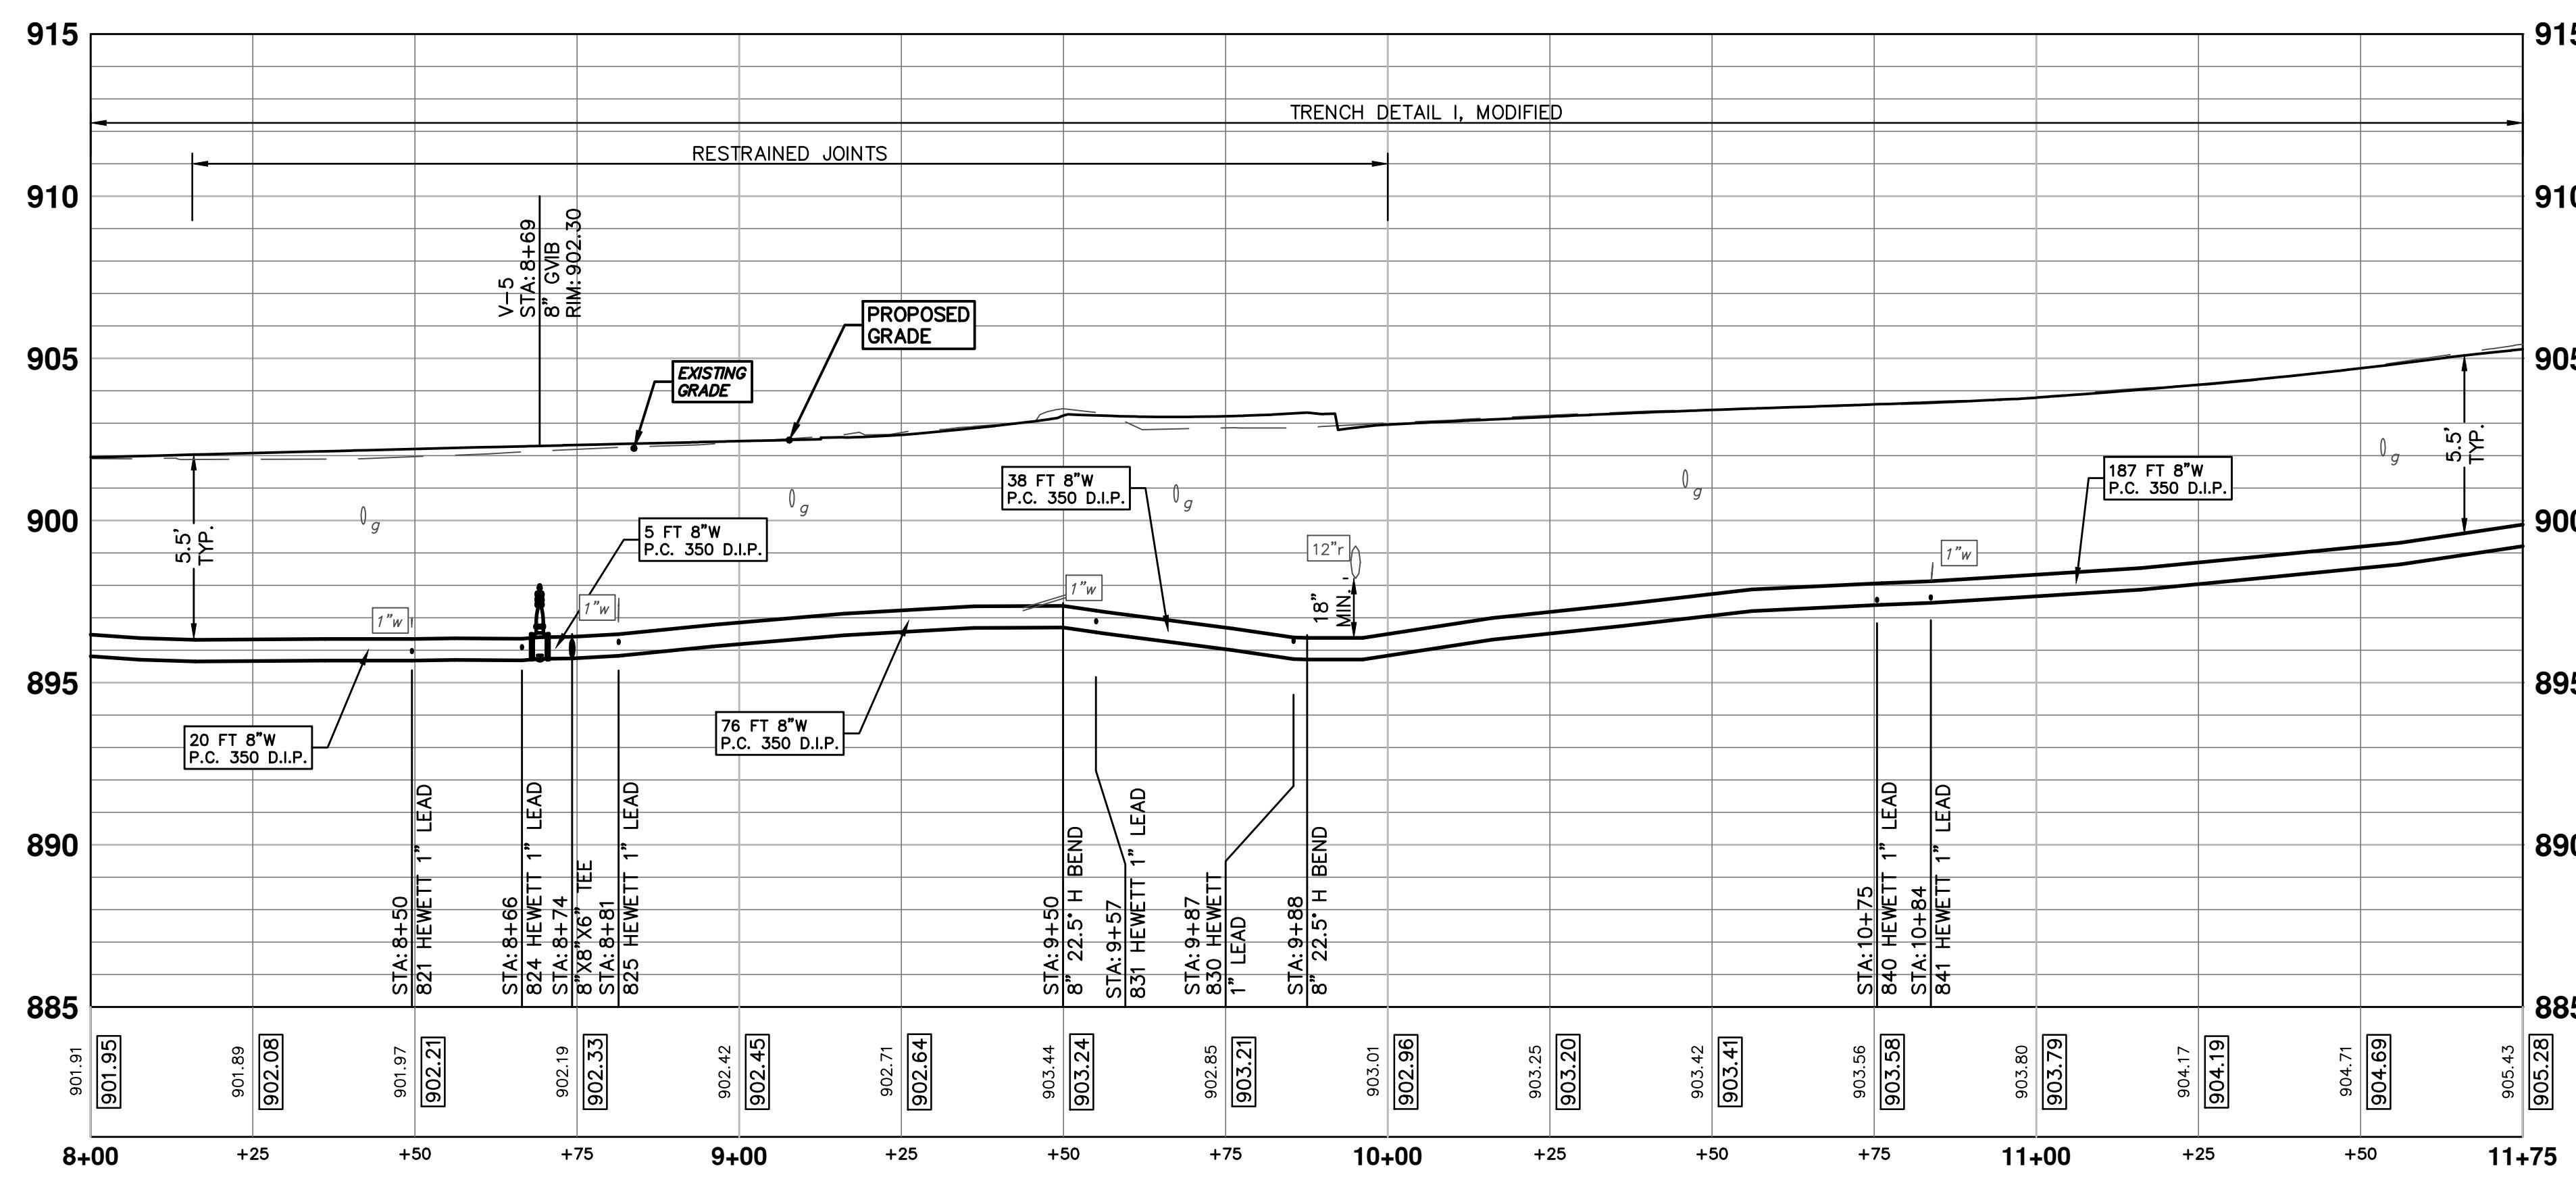
**HEWETT DR, RUSSELL RD, RUSSETT RD &  
REDEEMER AVE WATER MAIN REPLACEMENT**

**WATER MAIN PLAN & PROFILE**

<b>PROJECT MANAGEMENT</b>	
SCALE PLAN: 1" = 20'	PROFILE: 1" = 4' 
DRAWING No.	2013034-14
SHEET No.	
14 OF 30	

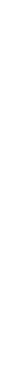


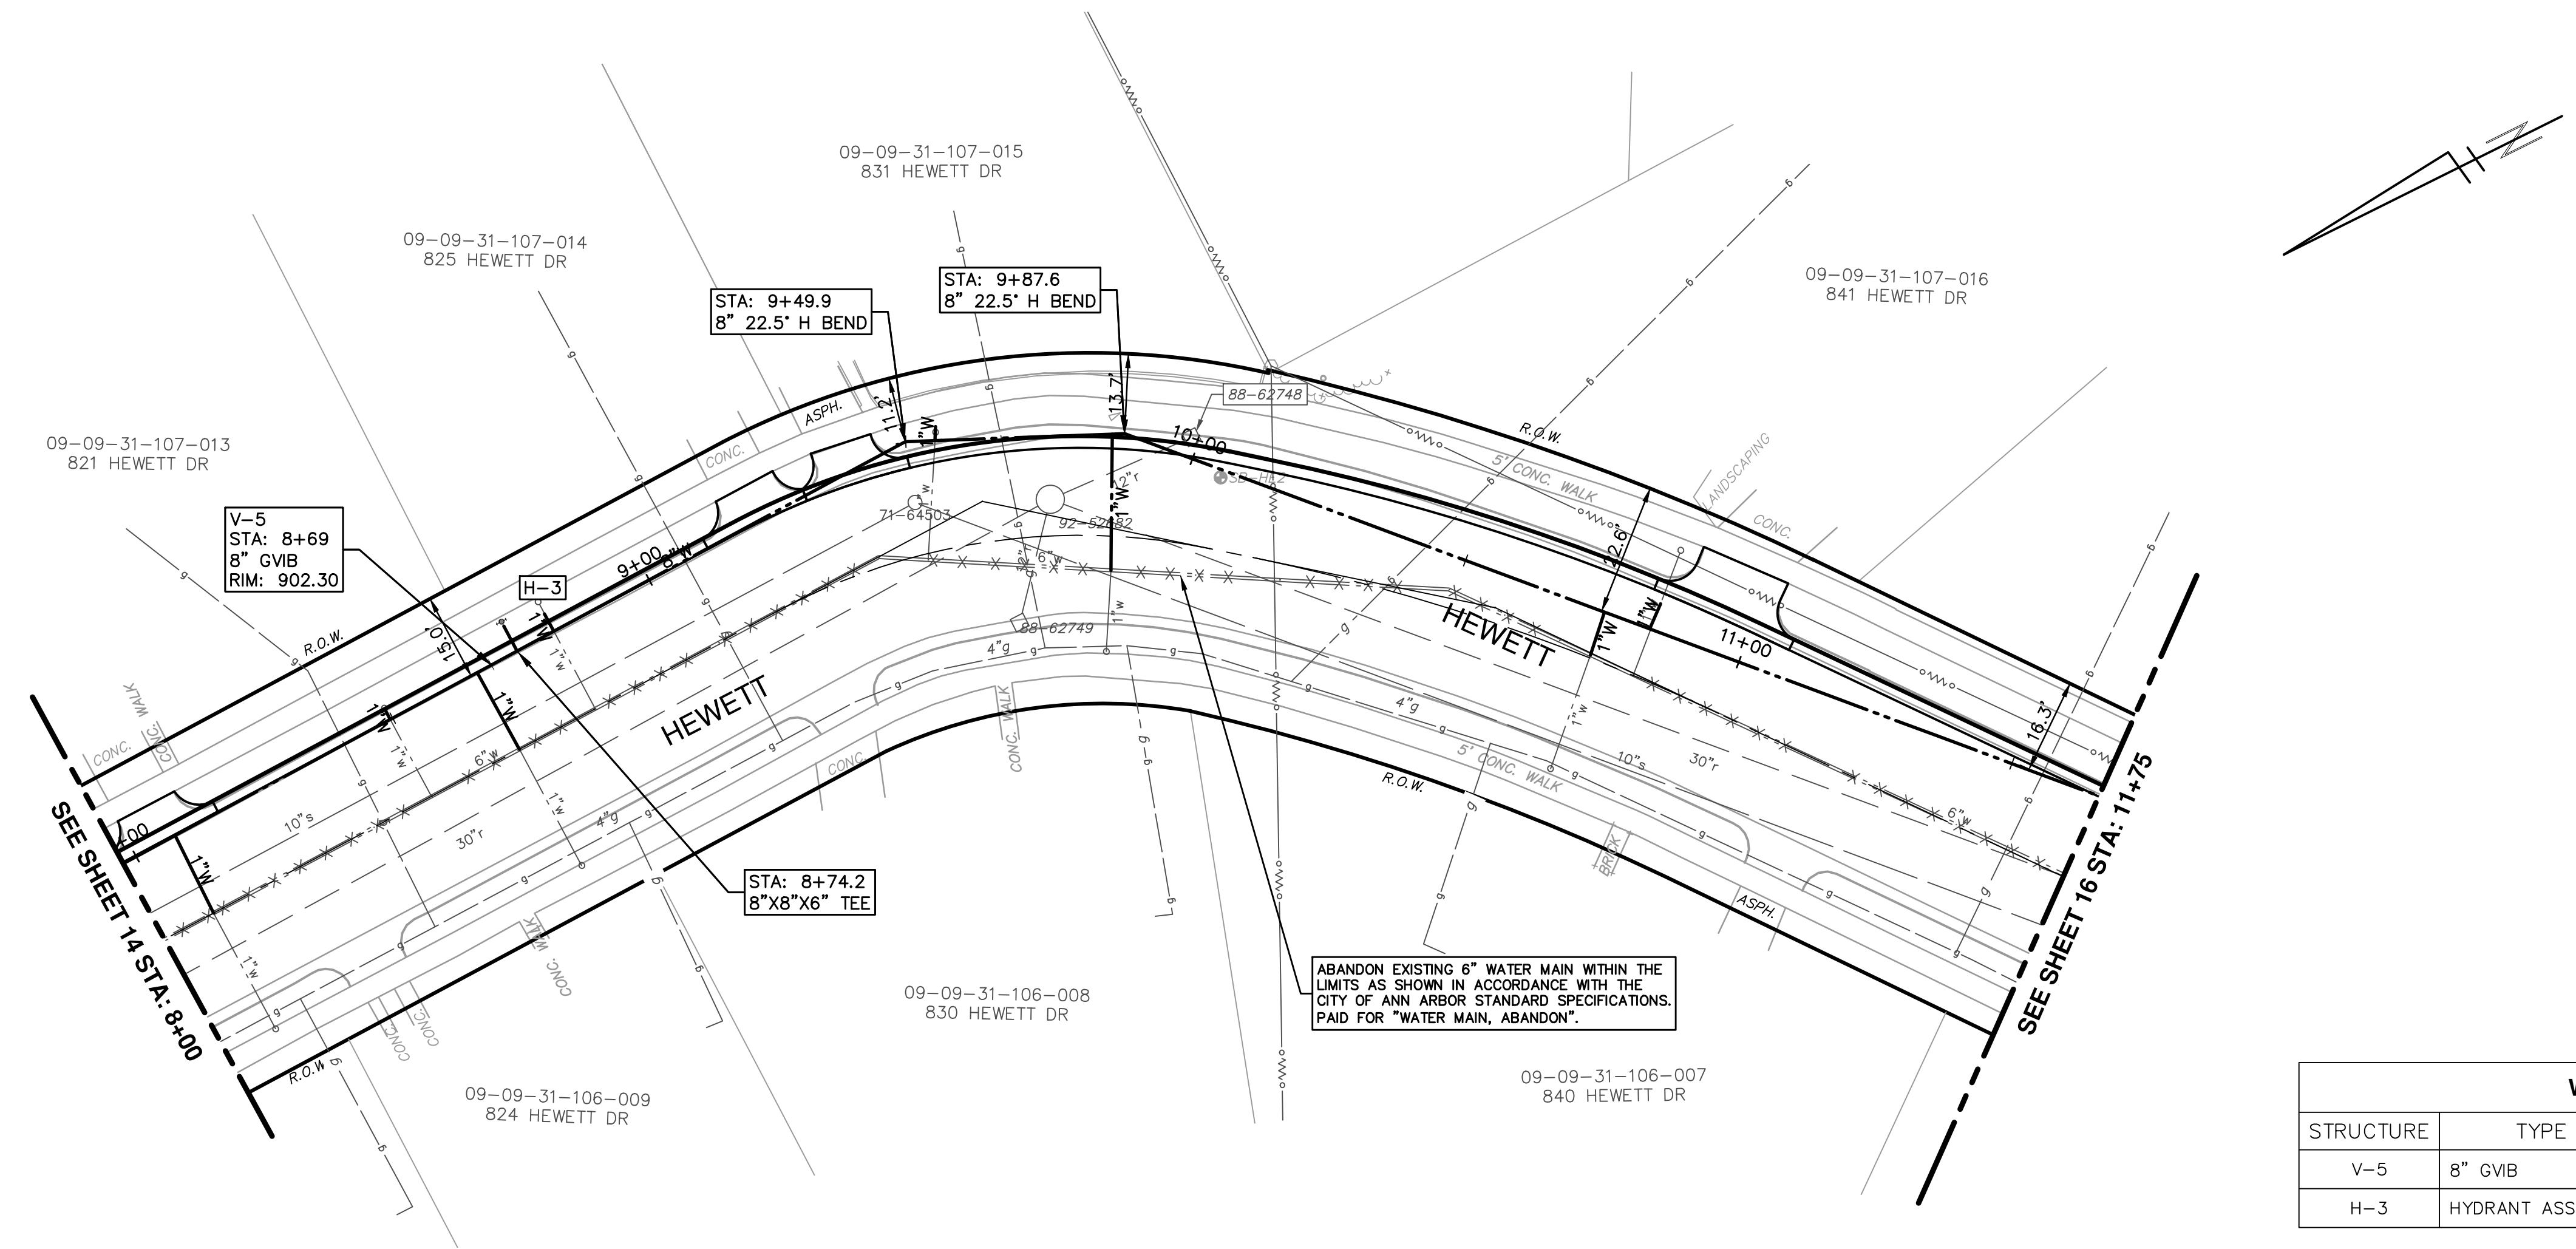WATER MAIN STRUCTURE TABLE					
STRUCTURE	TYPE	STATION	ALIGNMENT	RIM	DEPTH
V-5	8" GVIB	8+69	Pr Water Russell-Hewett Loop	902.30	6.57
H-3	HYDRANT ASSEMBLY	8+74	Pr Water Russell-Hewett Loop	902.99	9.18



PROJECT MANAGEMENT - PUBLIC SERVICES - CITY OF ANN ARBOR	
SCALE PLAN: 1" = 20'	PROFILE: 1" = 4'
HEWETT DR, RUSSELL RD, RUSSETT RD & REDEEMER AVE WATER MAIN REPLACEMENT	
DRAWING No.	WATER MAIN PLAN & PROFILE
2013034-15	RUSSELL - HEWETT LOOP STA 8+00 TO 11+75
SHEET No.	
15 OF 30	

Know what's below.  
 Call before you dig.

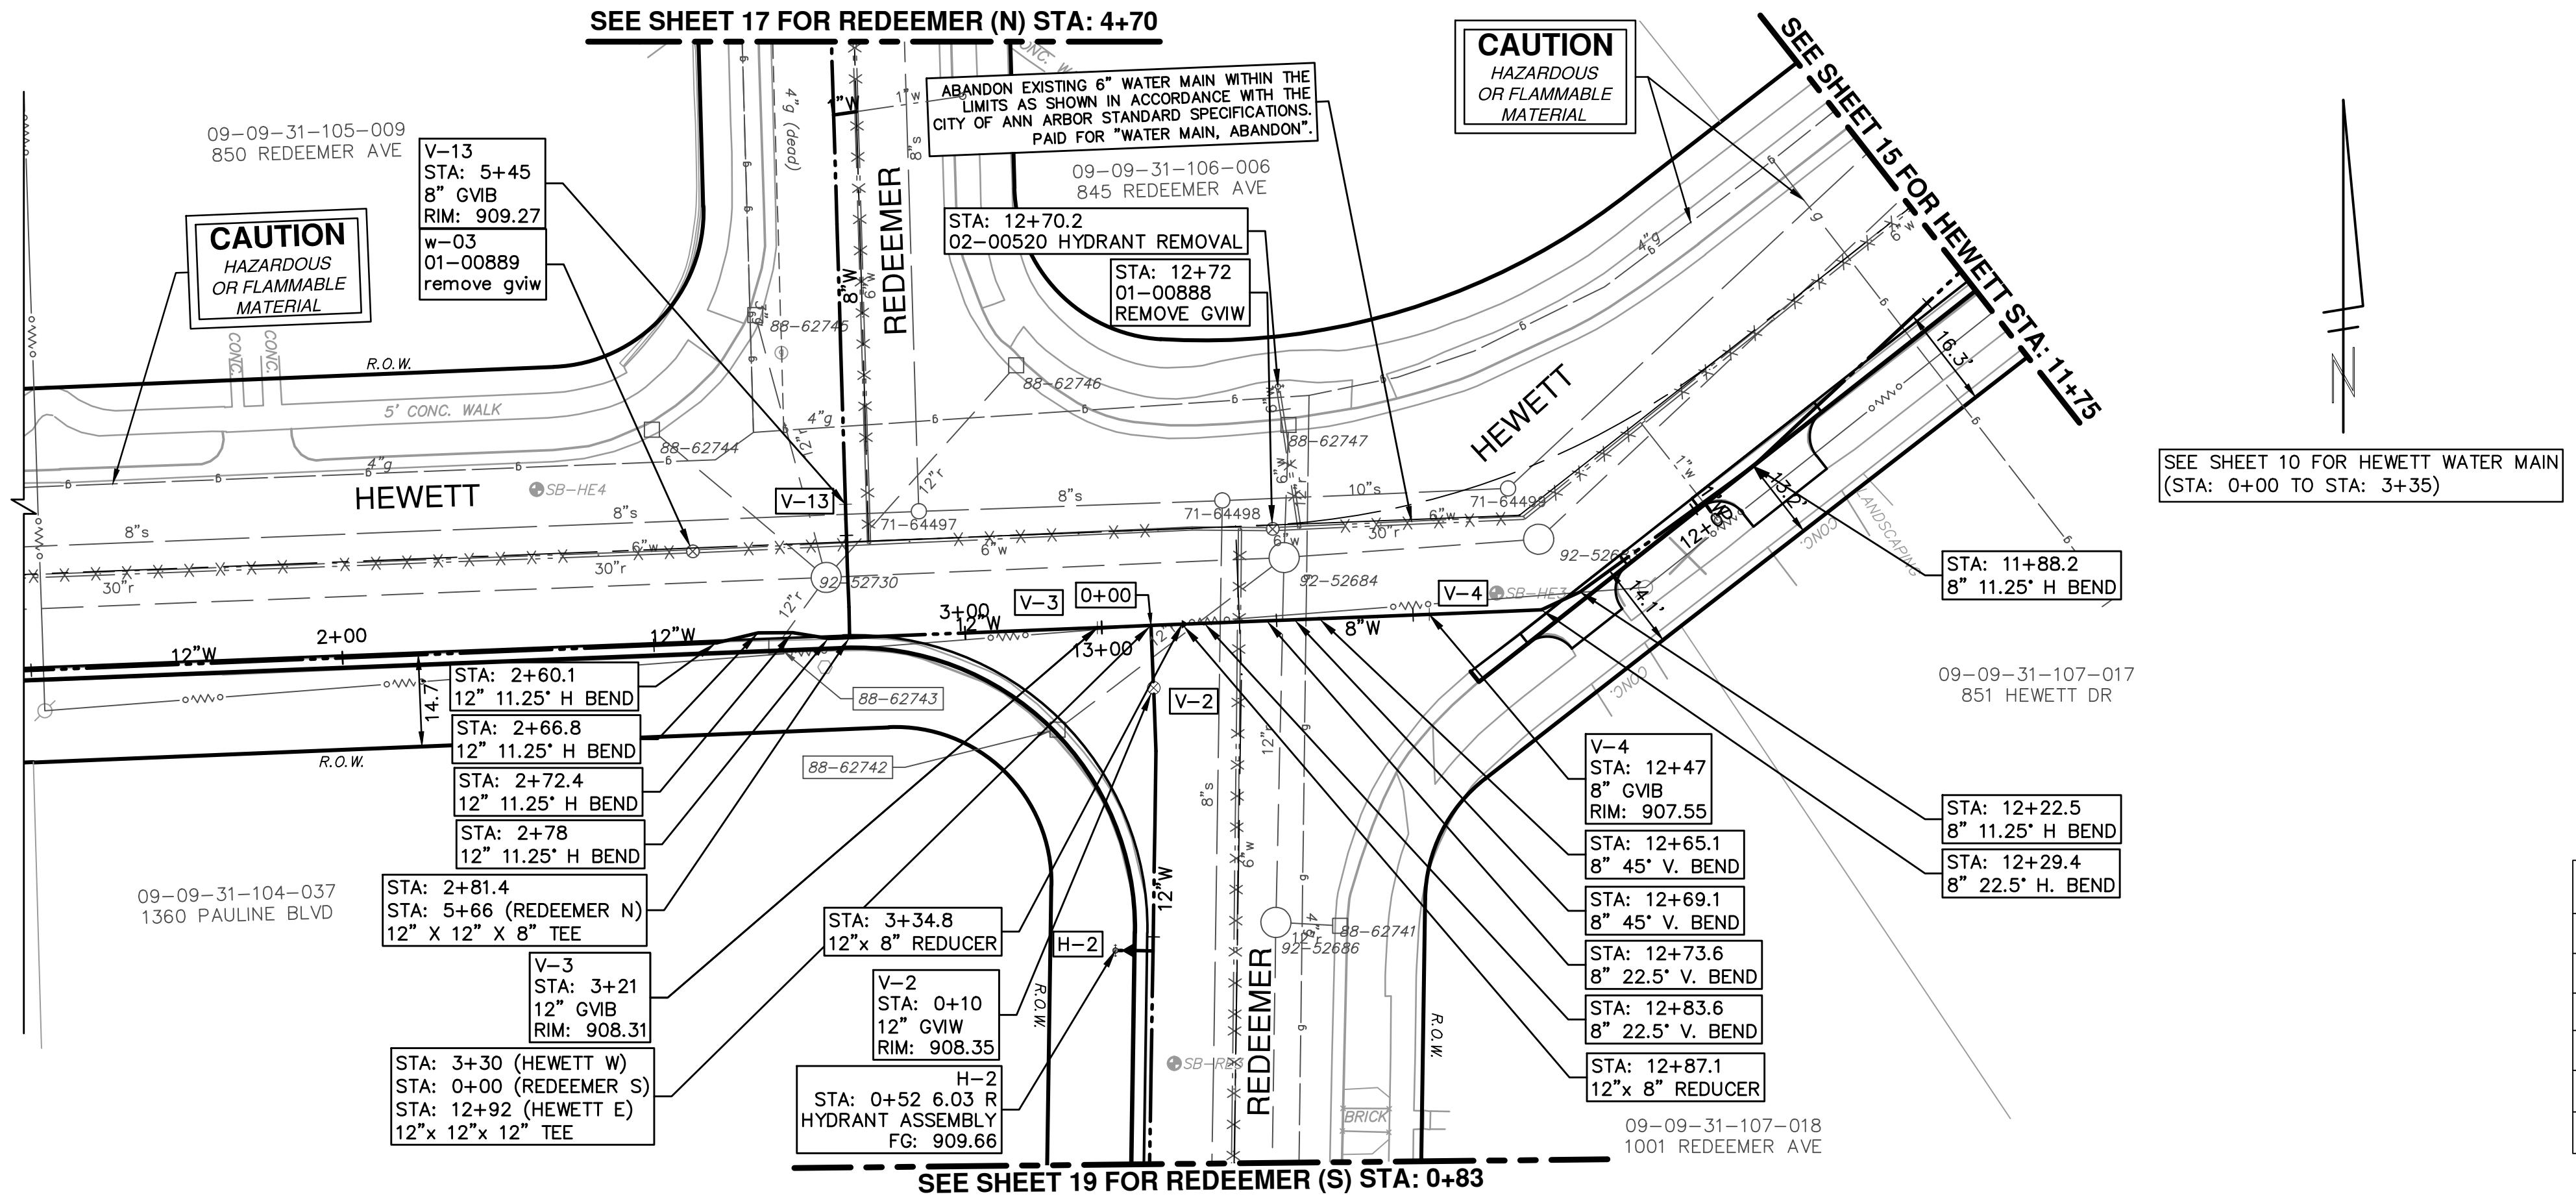


## **WATER MAIN STRUCTURE TABLE**

STRUCTURE	TYPE	STATION	ALIGNMENT	RIM	DEPTH
V-2	12" GVIW	0+10	Pr Water Redeemer S	908.35	7.35
H-2	HYDRANT ASSEMBLY	0+52	Pr Water Redeemer S	909.66	8.99
V-13	8" GVIB	5+45	Pr Water Redeemer N	909.27	5.58
V-4	8" GVIB	12+47	Pr Water Russell-Hewett Loop	907.55	6.21
V-3	12" GVIB	13+01	Pr Water Russell-Hewett Loop	908.31	7.31

## **EX-WATER MAIN STRUCTURE TABLE**



STRUCTURE	TYPE	STATION	RIM	DEPTH
w-03	01-00889 REMOVE GVIW	2+57	909.65	7.60
h-2	02-00520 HYDRANT REMOVAL	12+70	908.65	8.40
w-02	01-00888 REMOVE GVIW	12+72	908.17	8.38

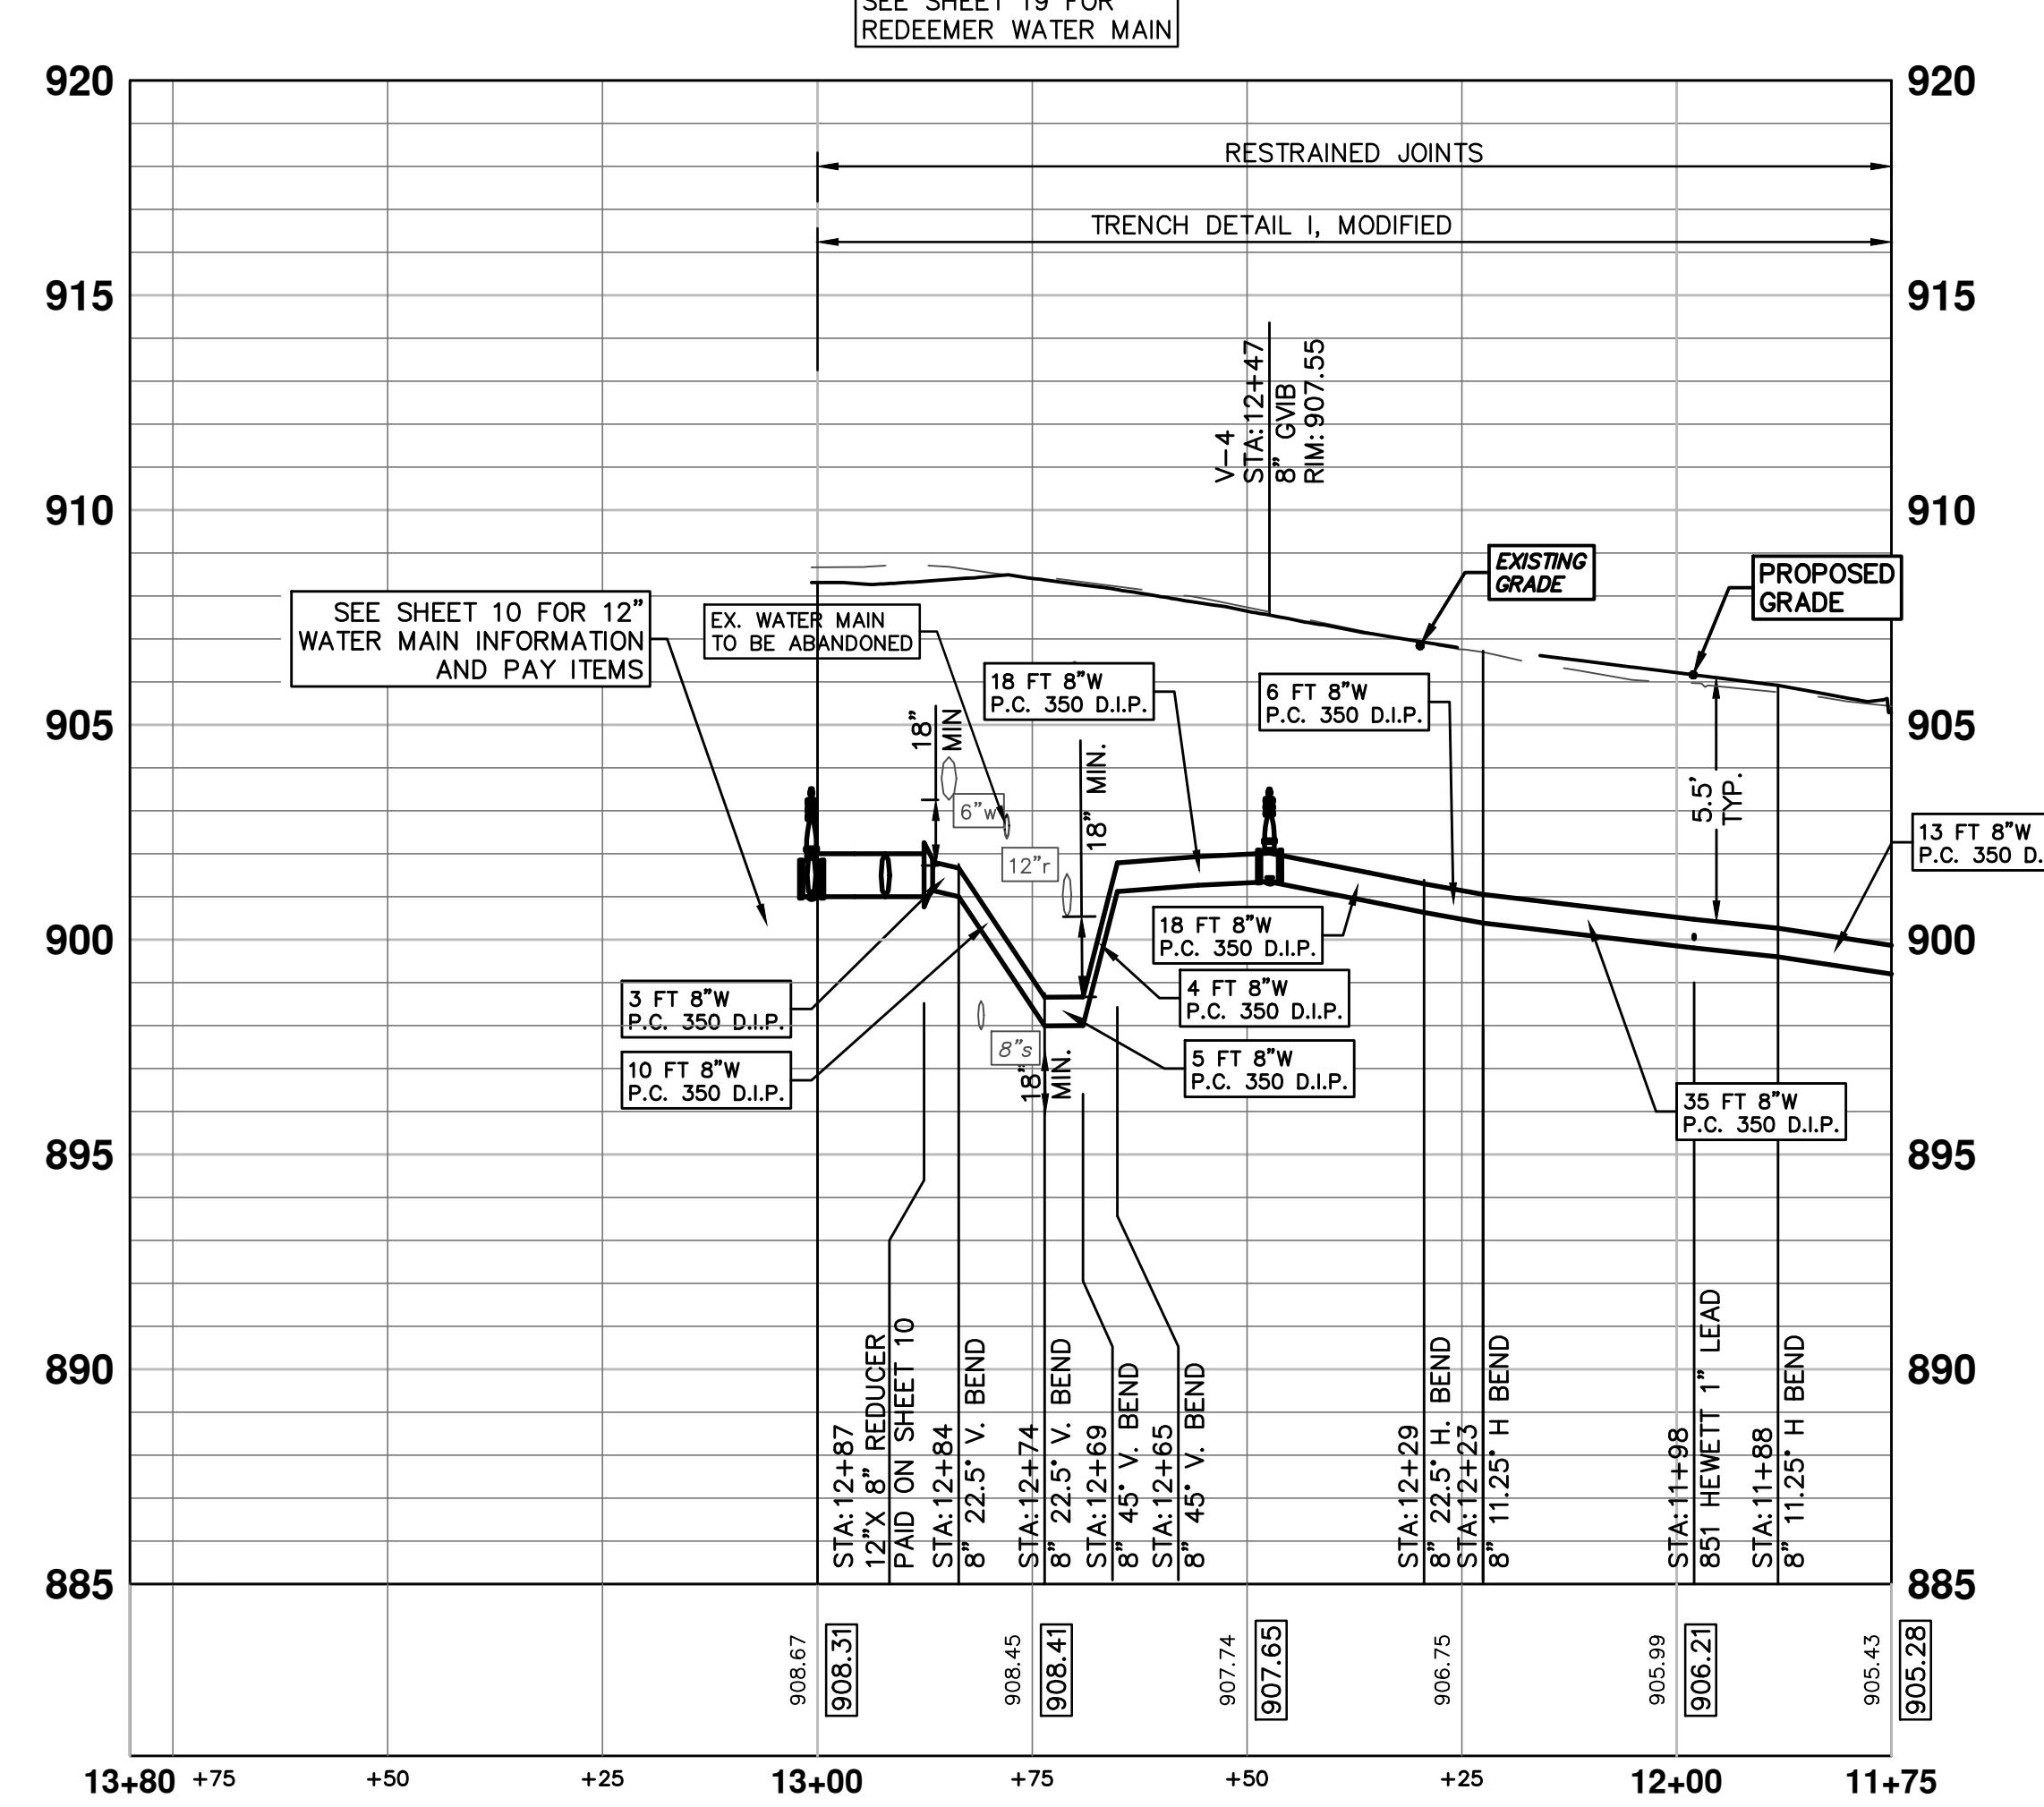

# PROJECT MANAGEMENT - PUBLIC SERVICES - CITY OF ANN ARBOR



CITY OF ANN ARBOR PUBLIC SERVICE 301 EAST HURON STREET	03 ADDENDUM 1	05/01/15	JKA	DAD
02 POST MDEQ 2015 REVIEW	03/18/15	JKA	DAD	

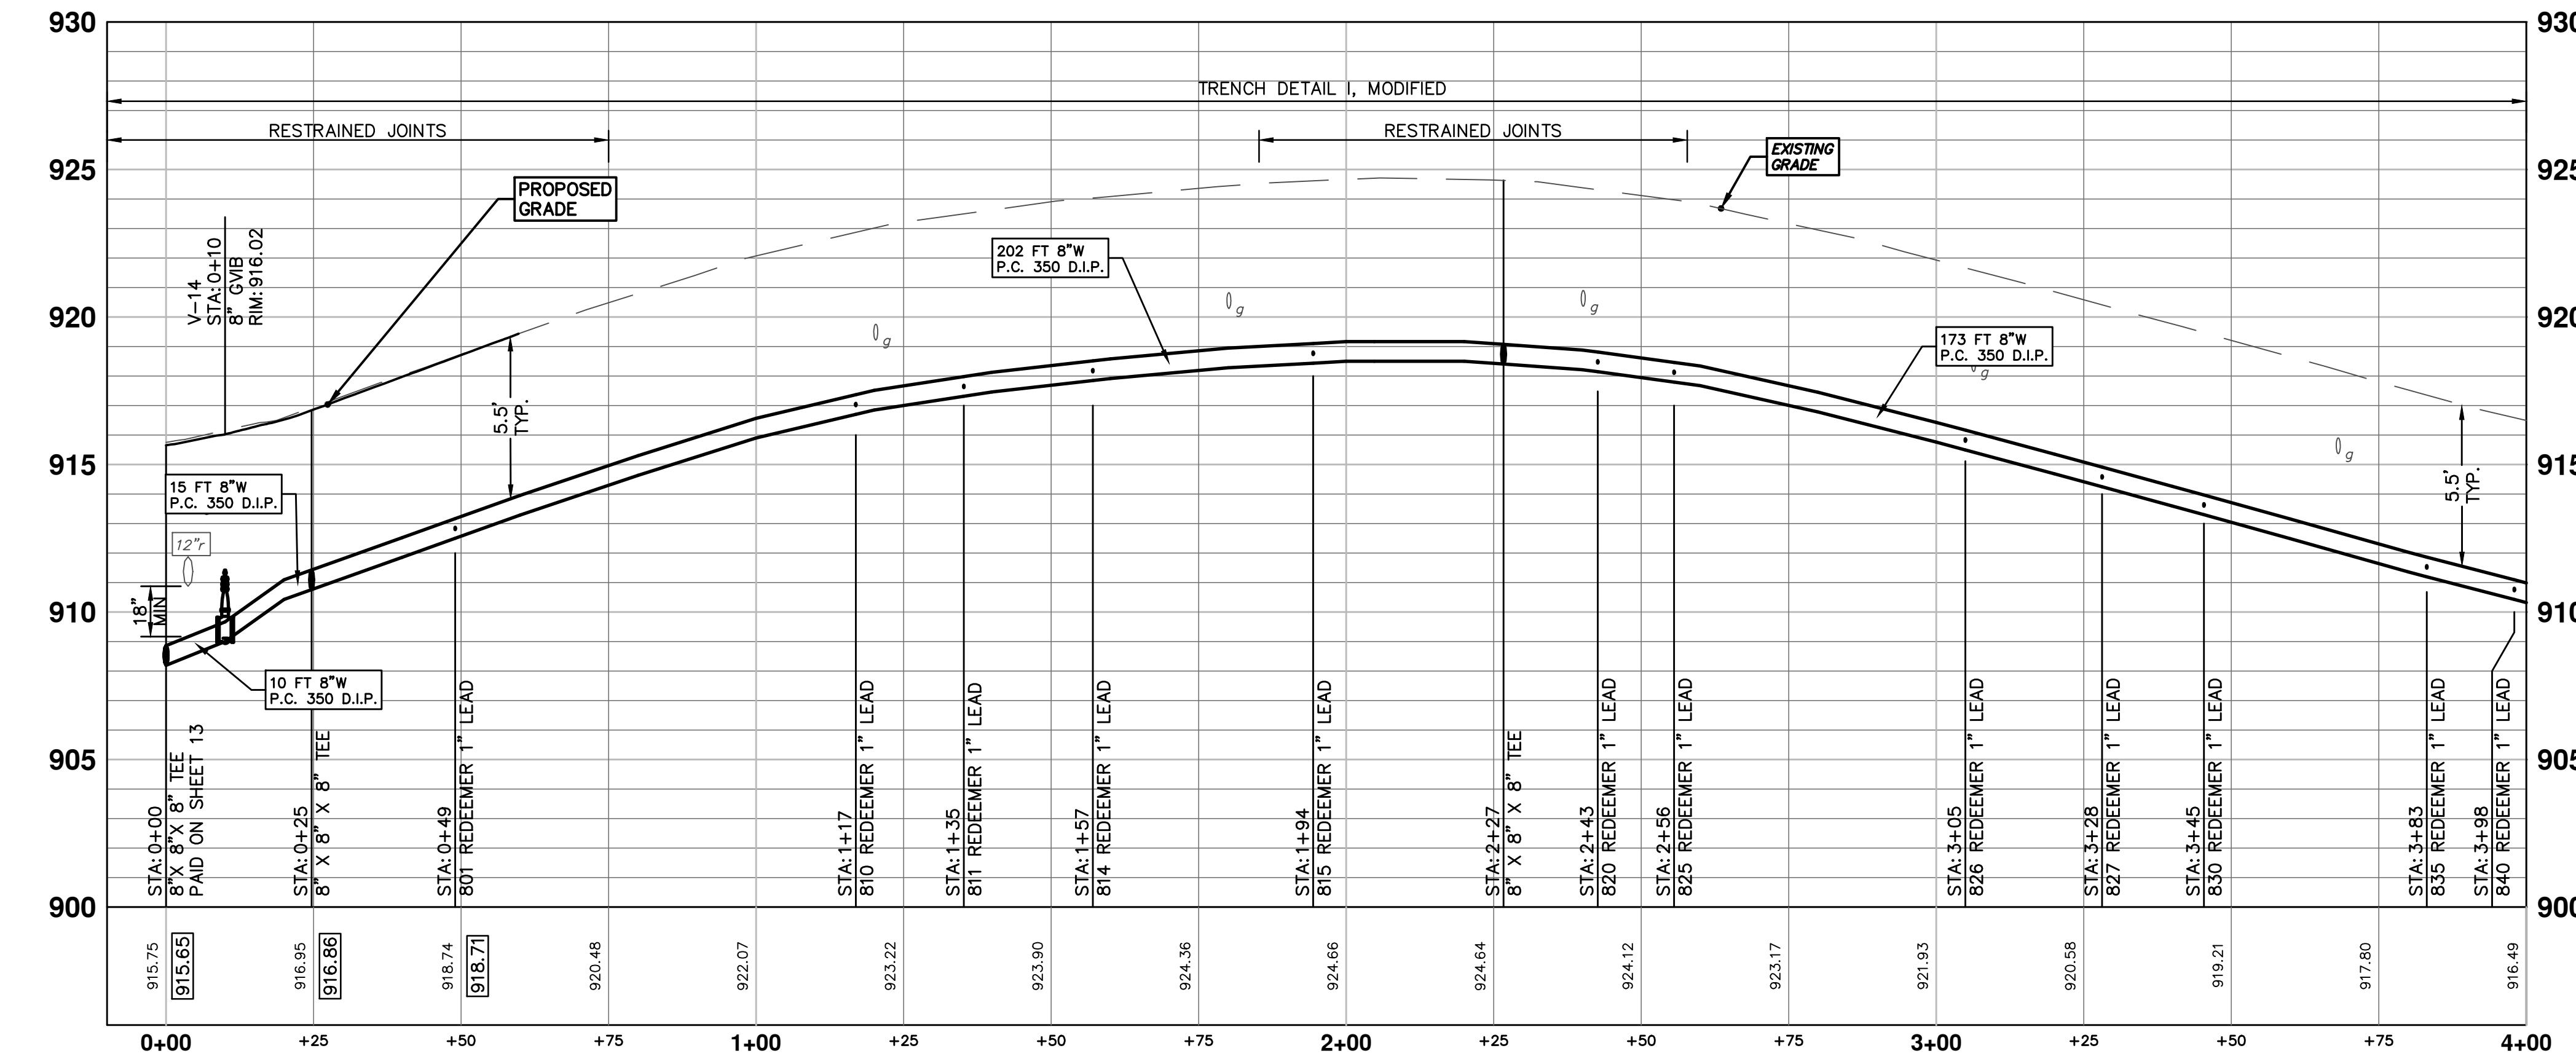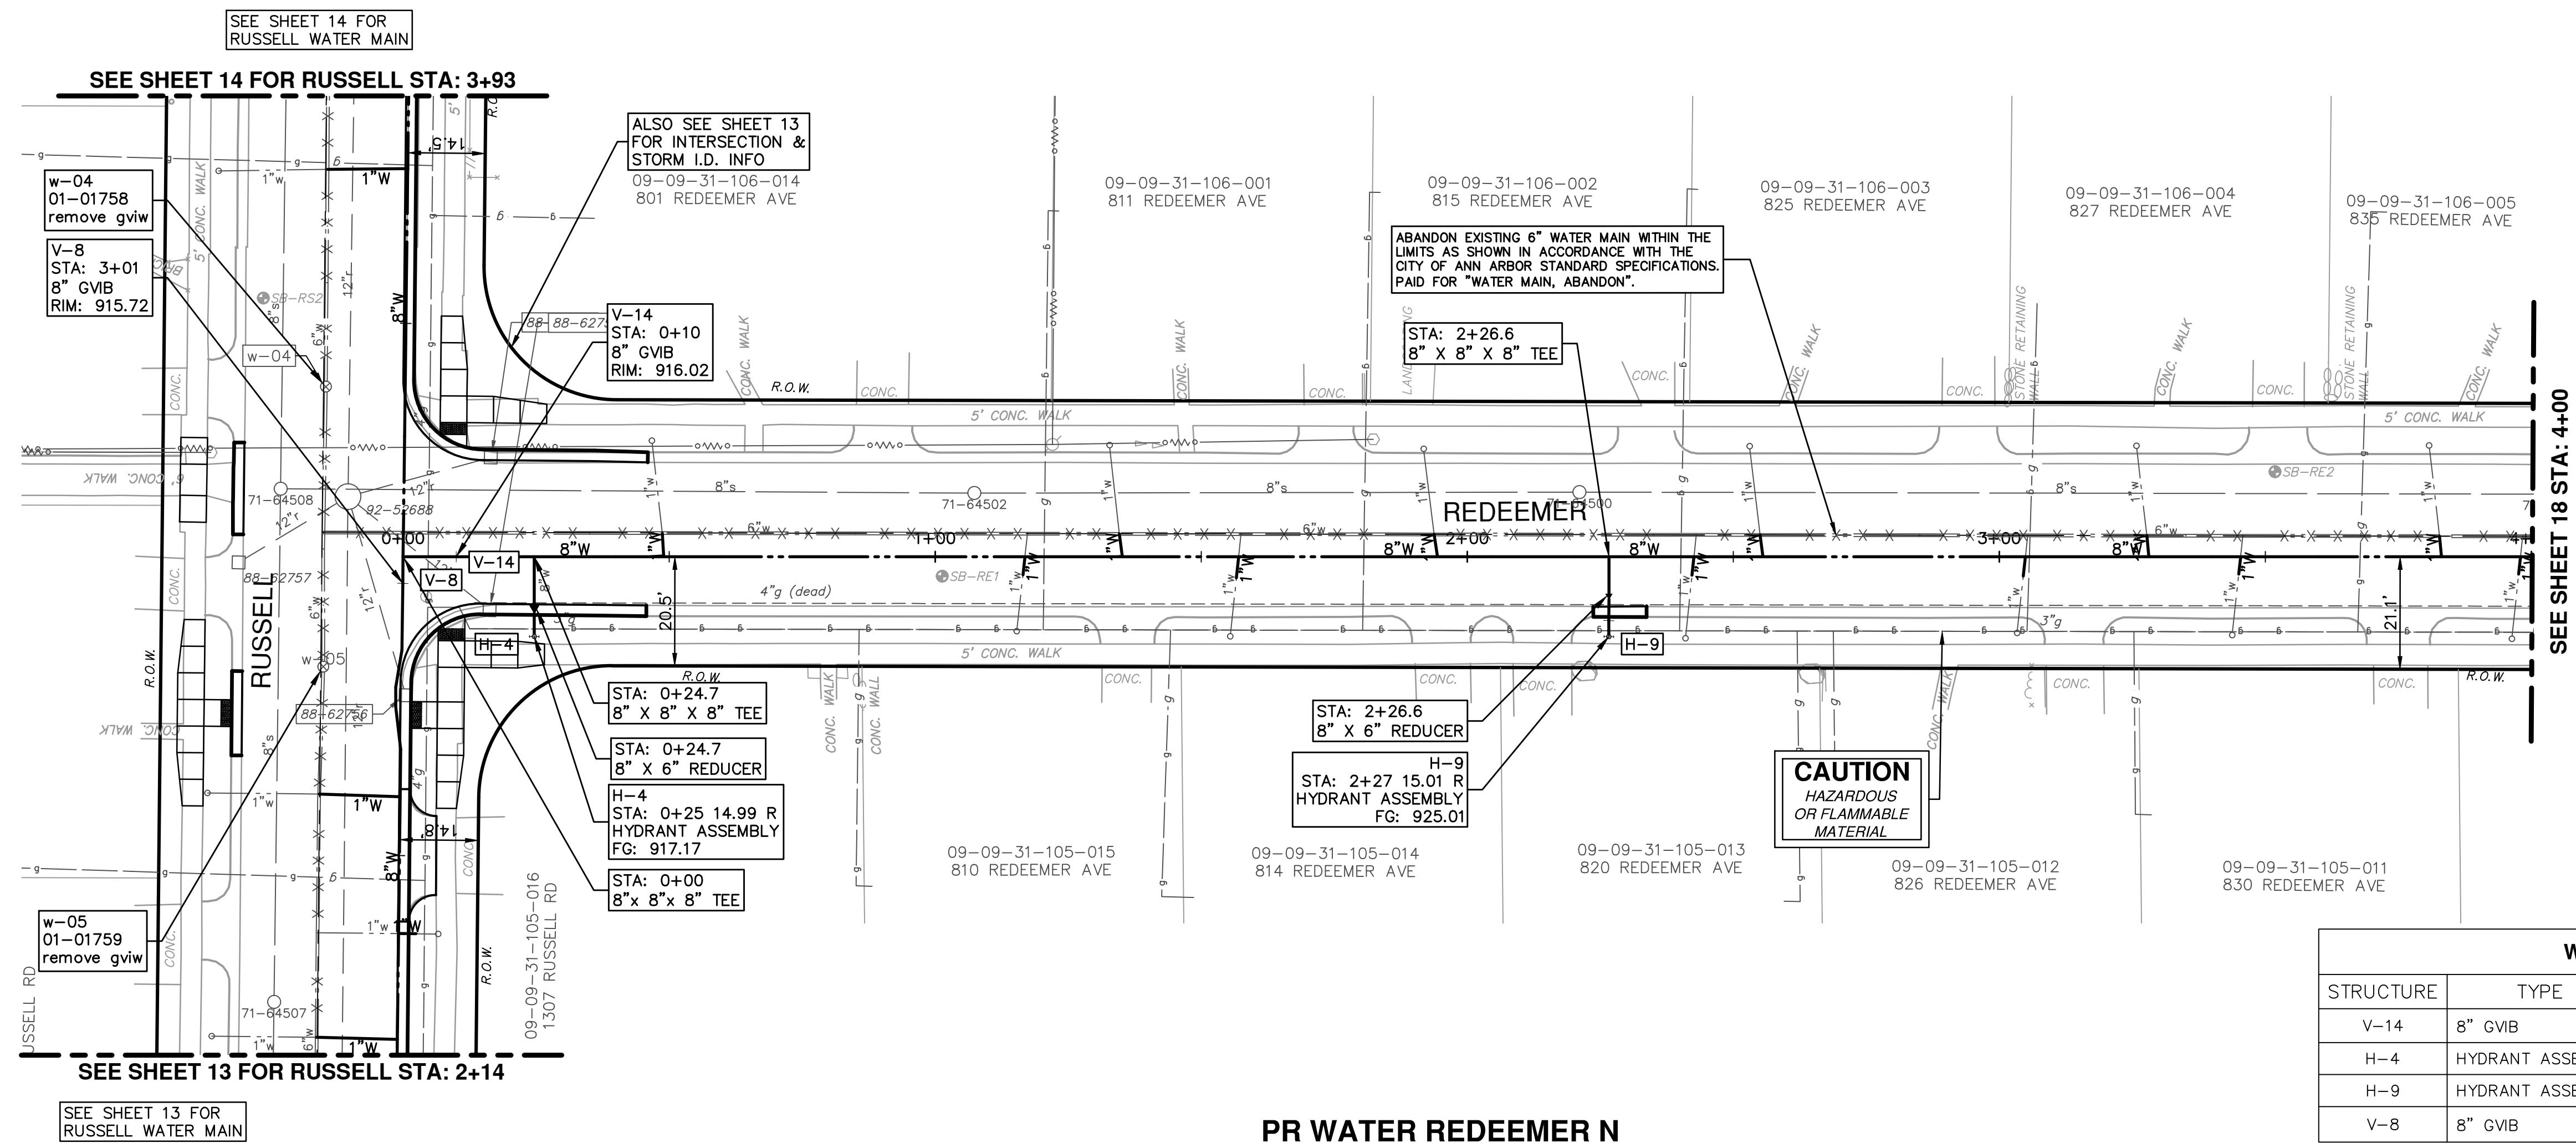



**PROJECT MANAGEMENT - PUBLIC SERVICES - CITY OF ANN ARBOR**

**HEWETT DR, RUSSELL RD & REDEEMER AVE WATER MAIN REPLACEMENT**

**WATER MAIN PLAN & PROFILE REDEEMER (N) STA 0-00 TO 4+00**

SCALE PLAN 1" = 20'	PROFILE 1" = 4'
SHEET No.	DRAWING No.
2013034-17	

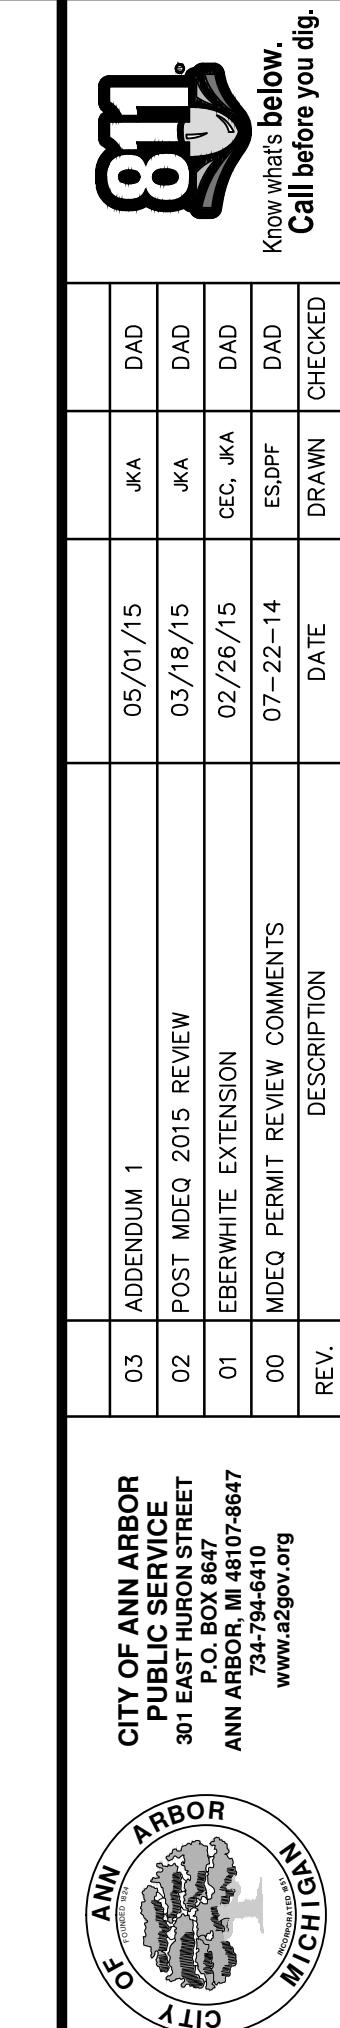


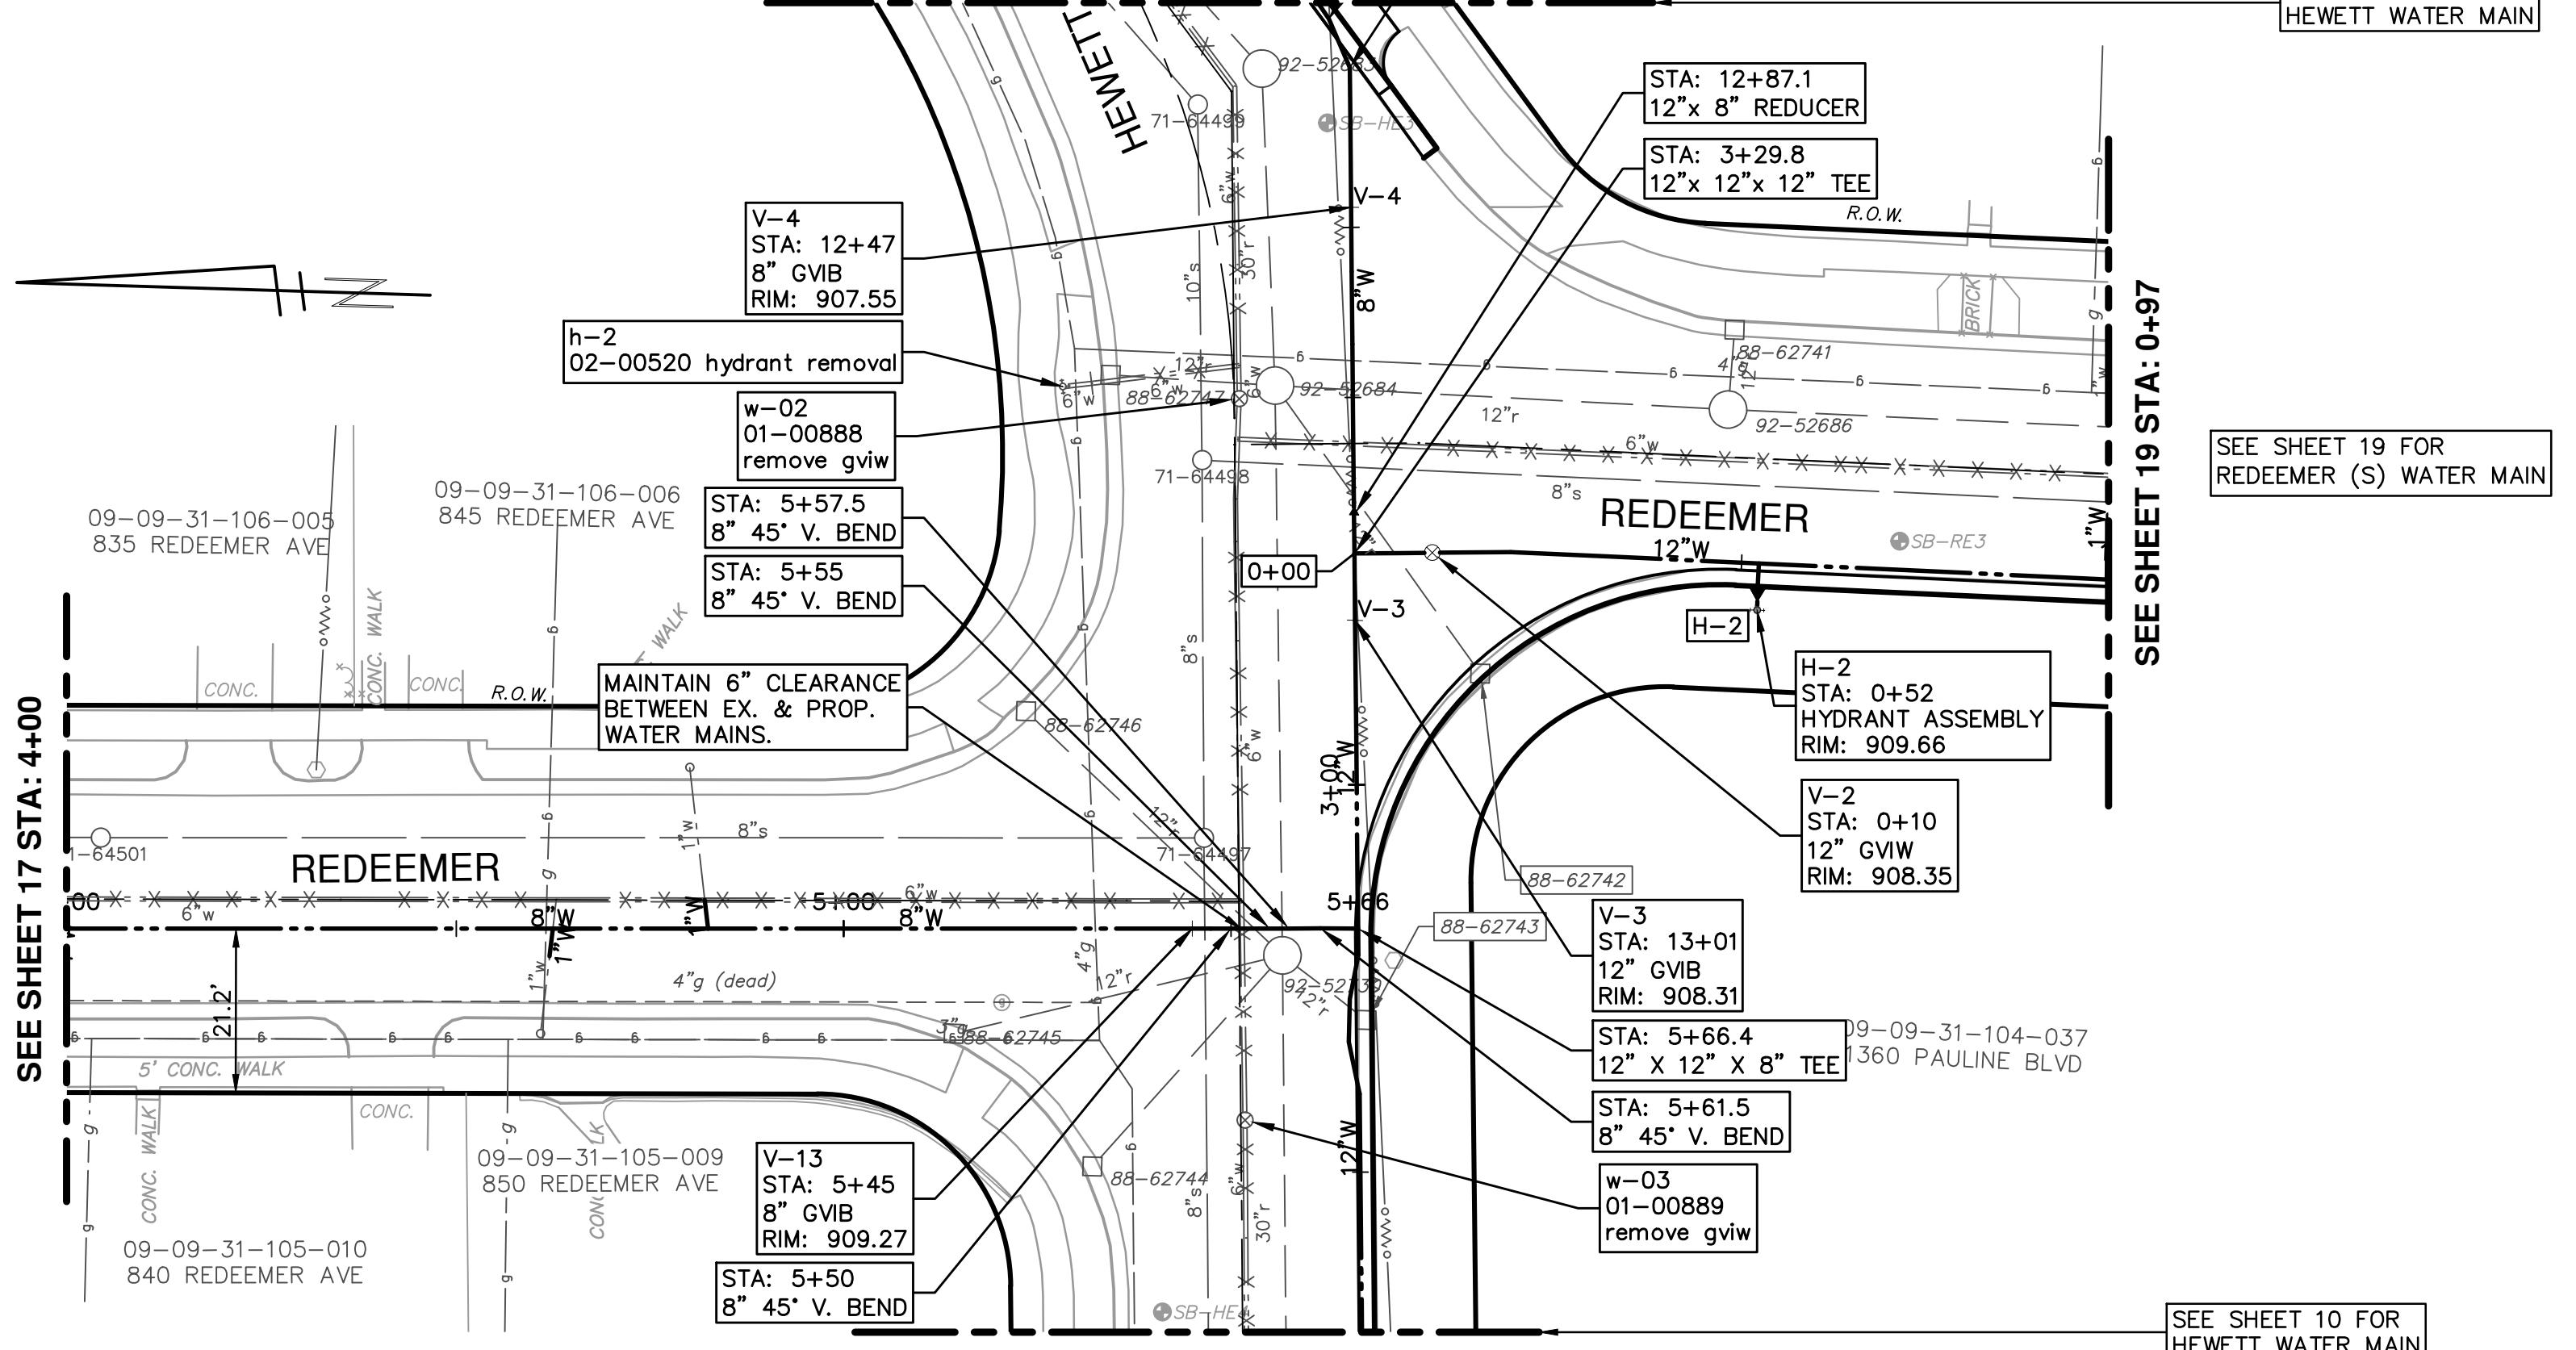



SEE SHEET 17 FOR  
REDEEMER (N) WATER MAIN

SEE SHEET 16 FOR  
HEWETT WATER MAIN



SEE SHEET 19 FOR  
REDEEMER (S) WATER MAIN

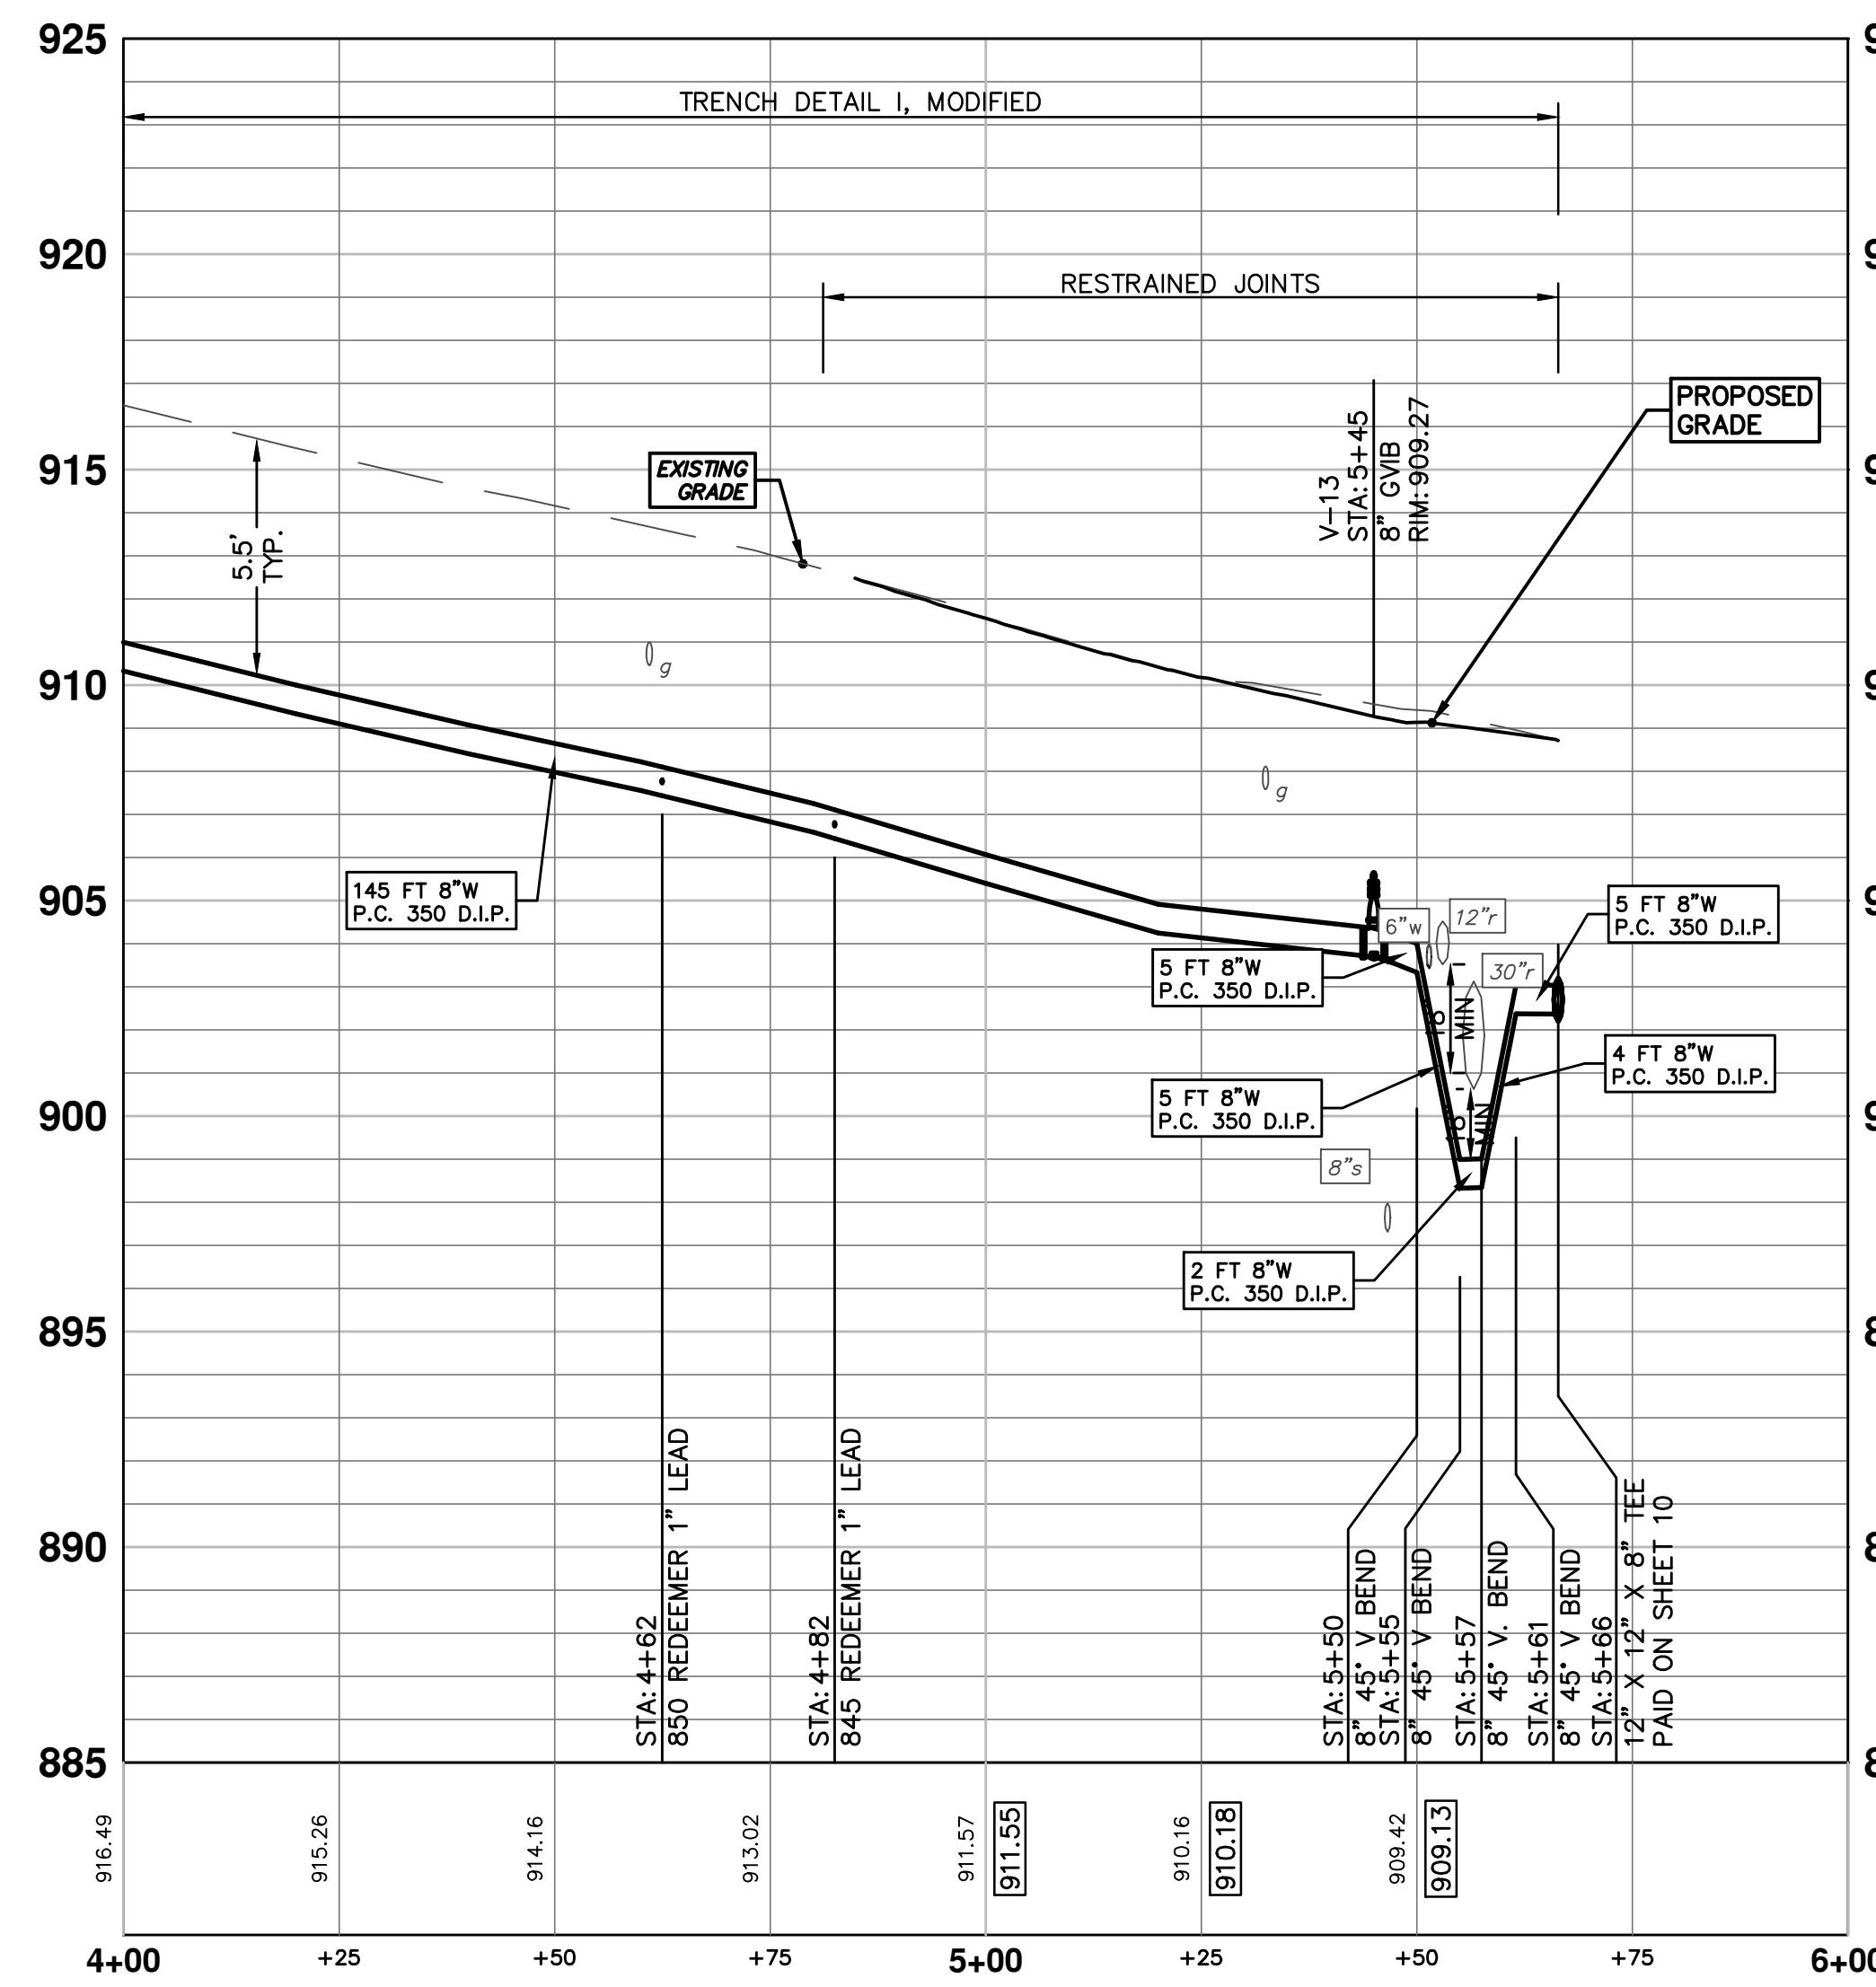

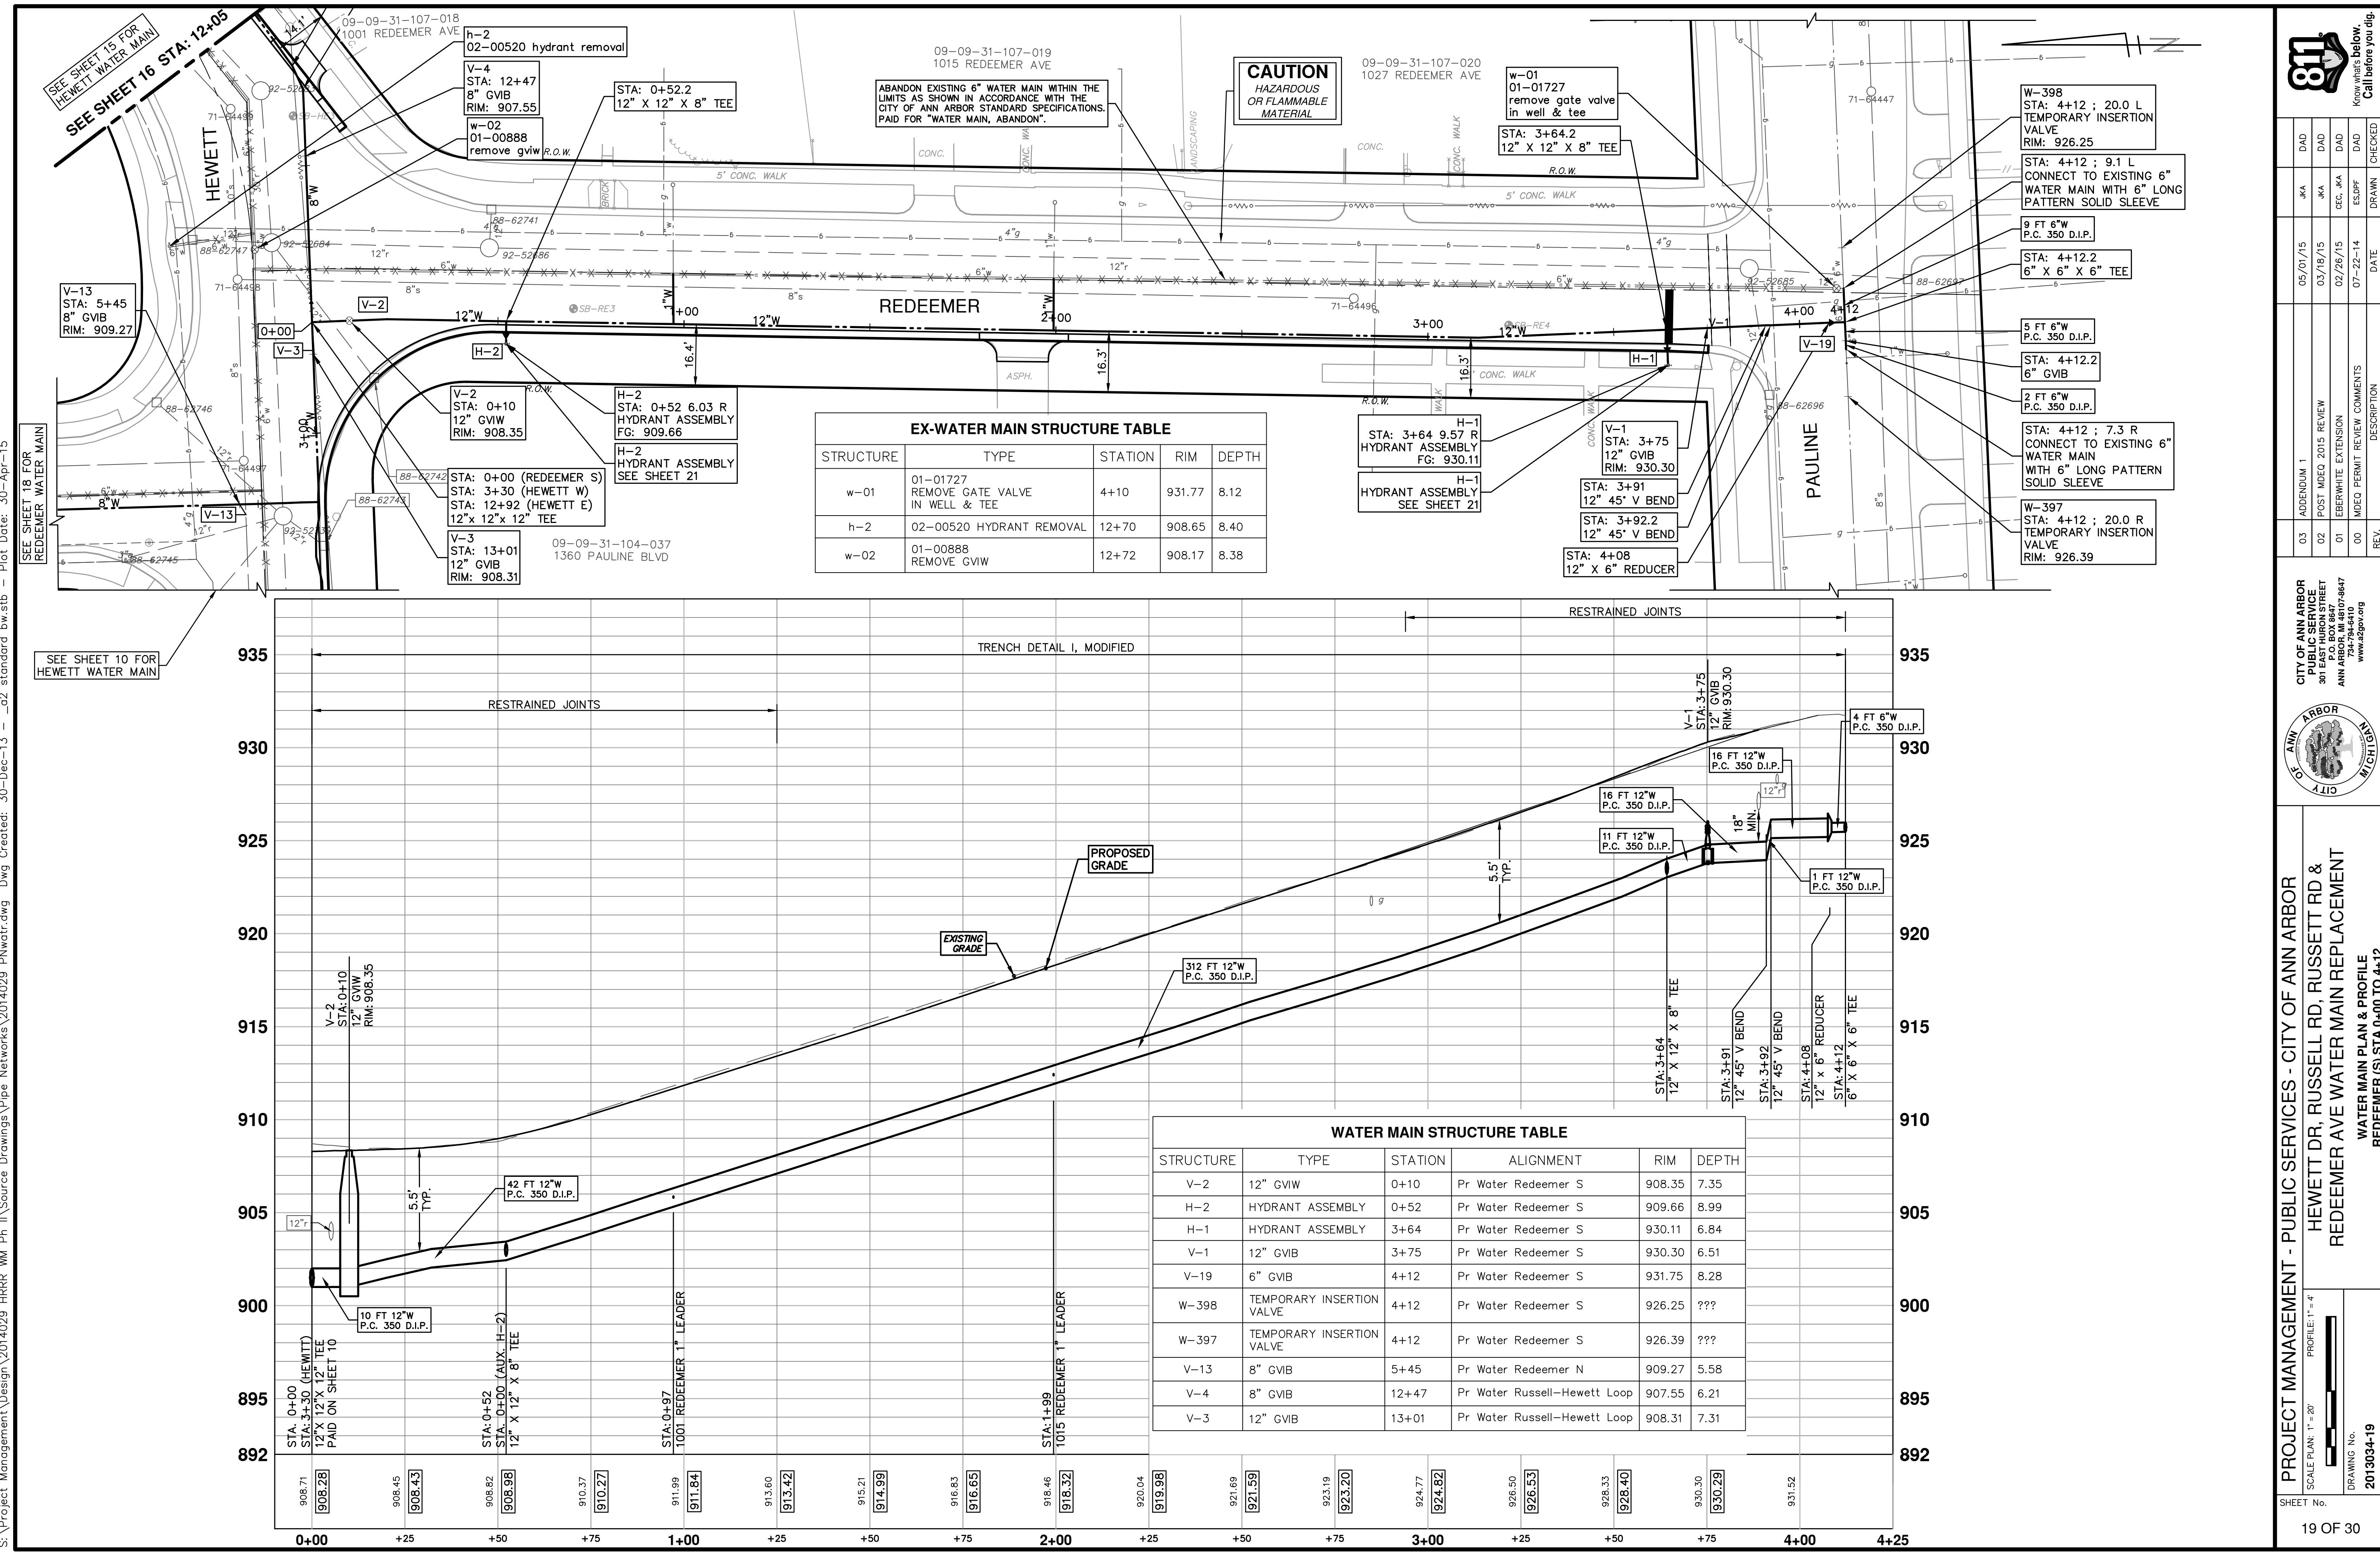

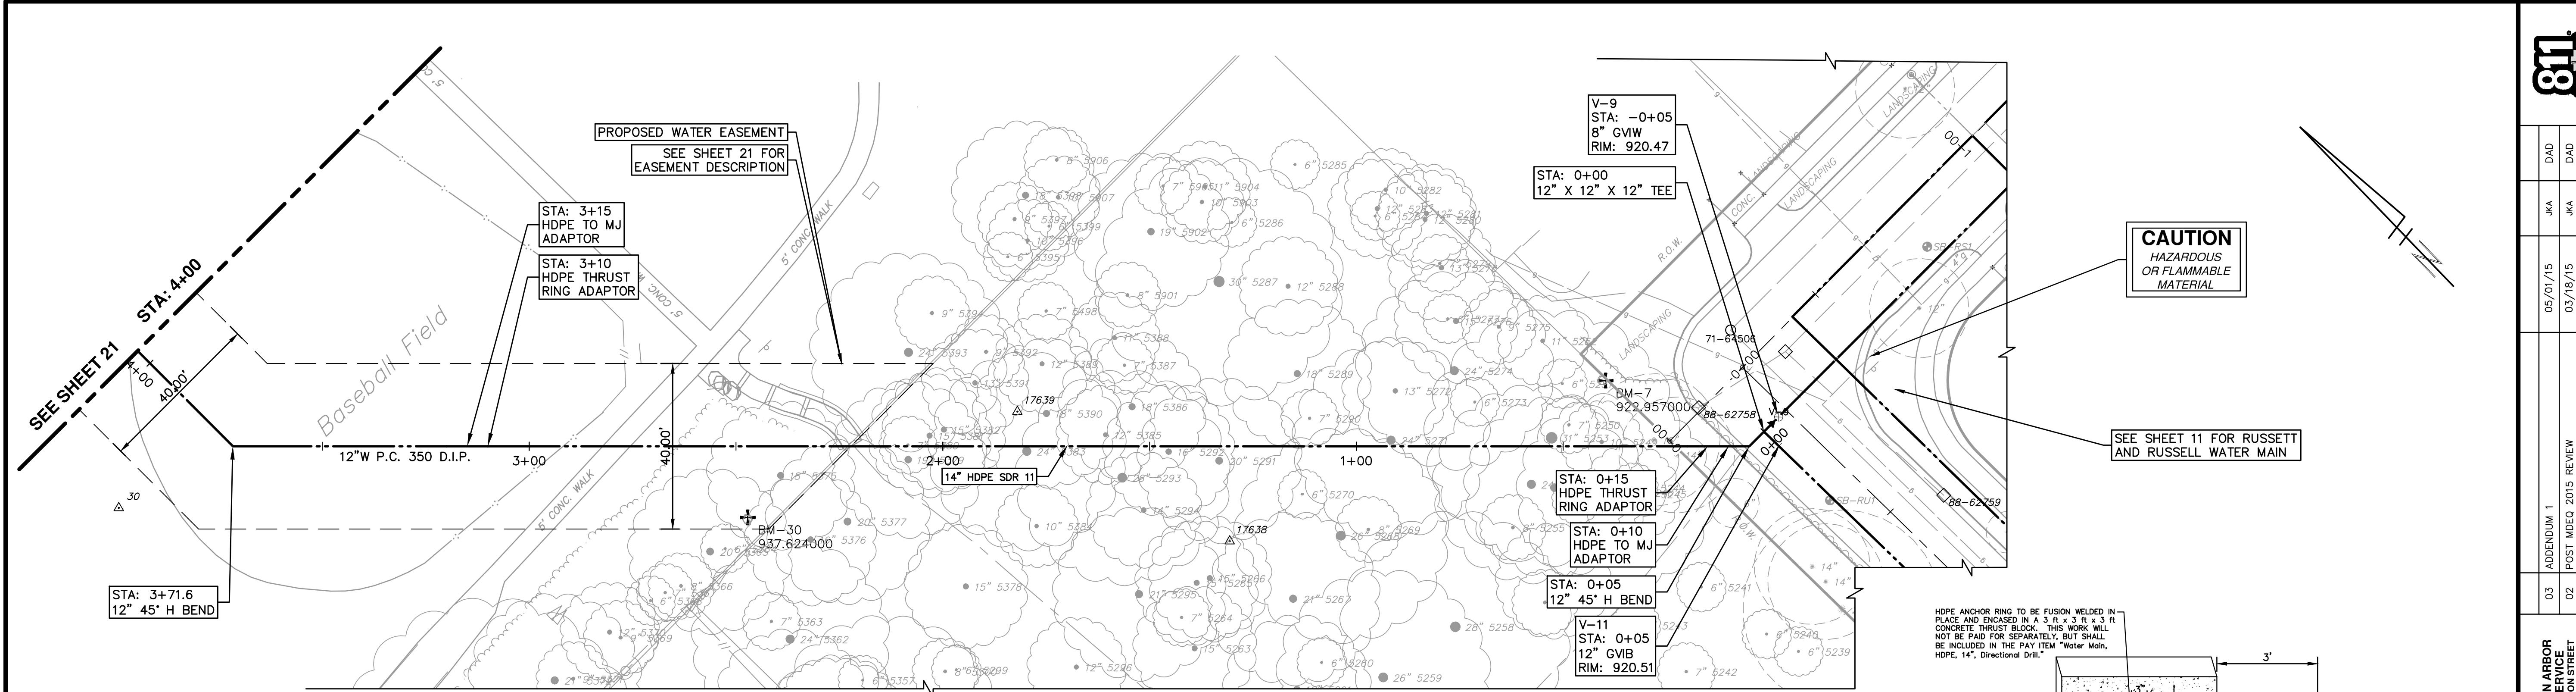

WATER MAIN STRUCTURE TABLE					
STRUCTURE	TYPE	STATION	ALIGNMENT	RIM	DEPTH
V-9	8" GVW	0+05	Pr Water Russell-Hewett Loop	920.47	6.80
V-11	12" GVIB	0+05	Pr Water Russett	920.51	6.46

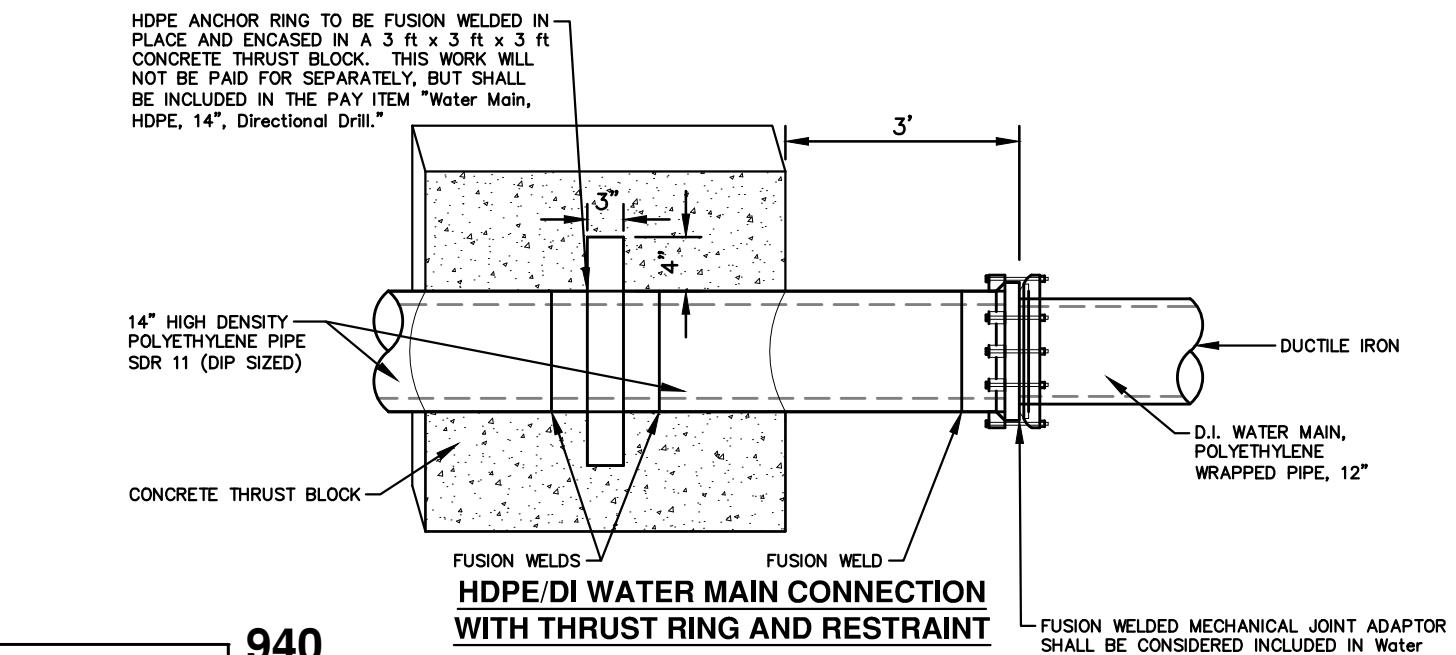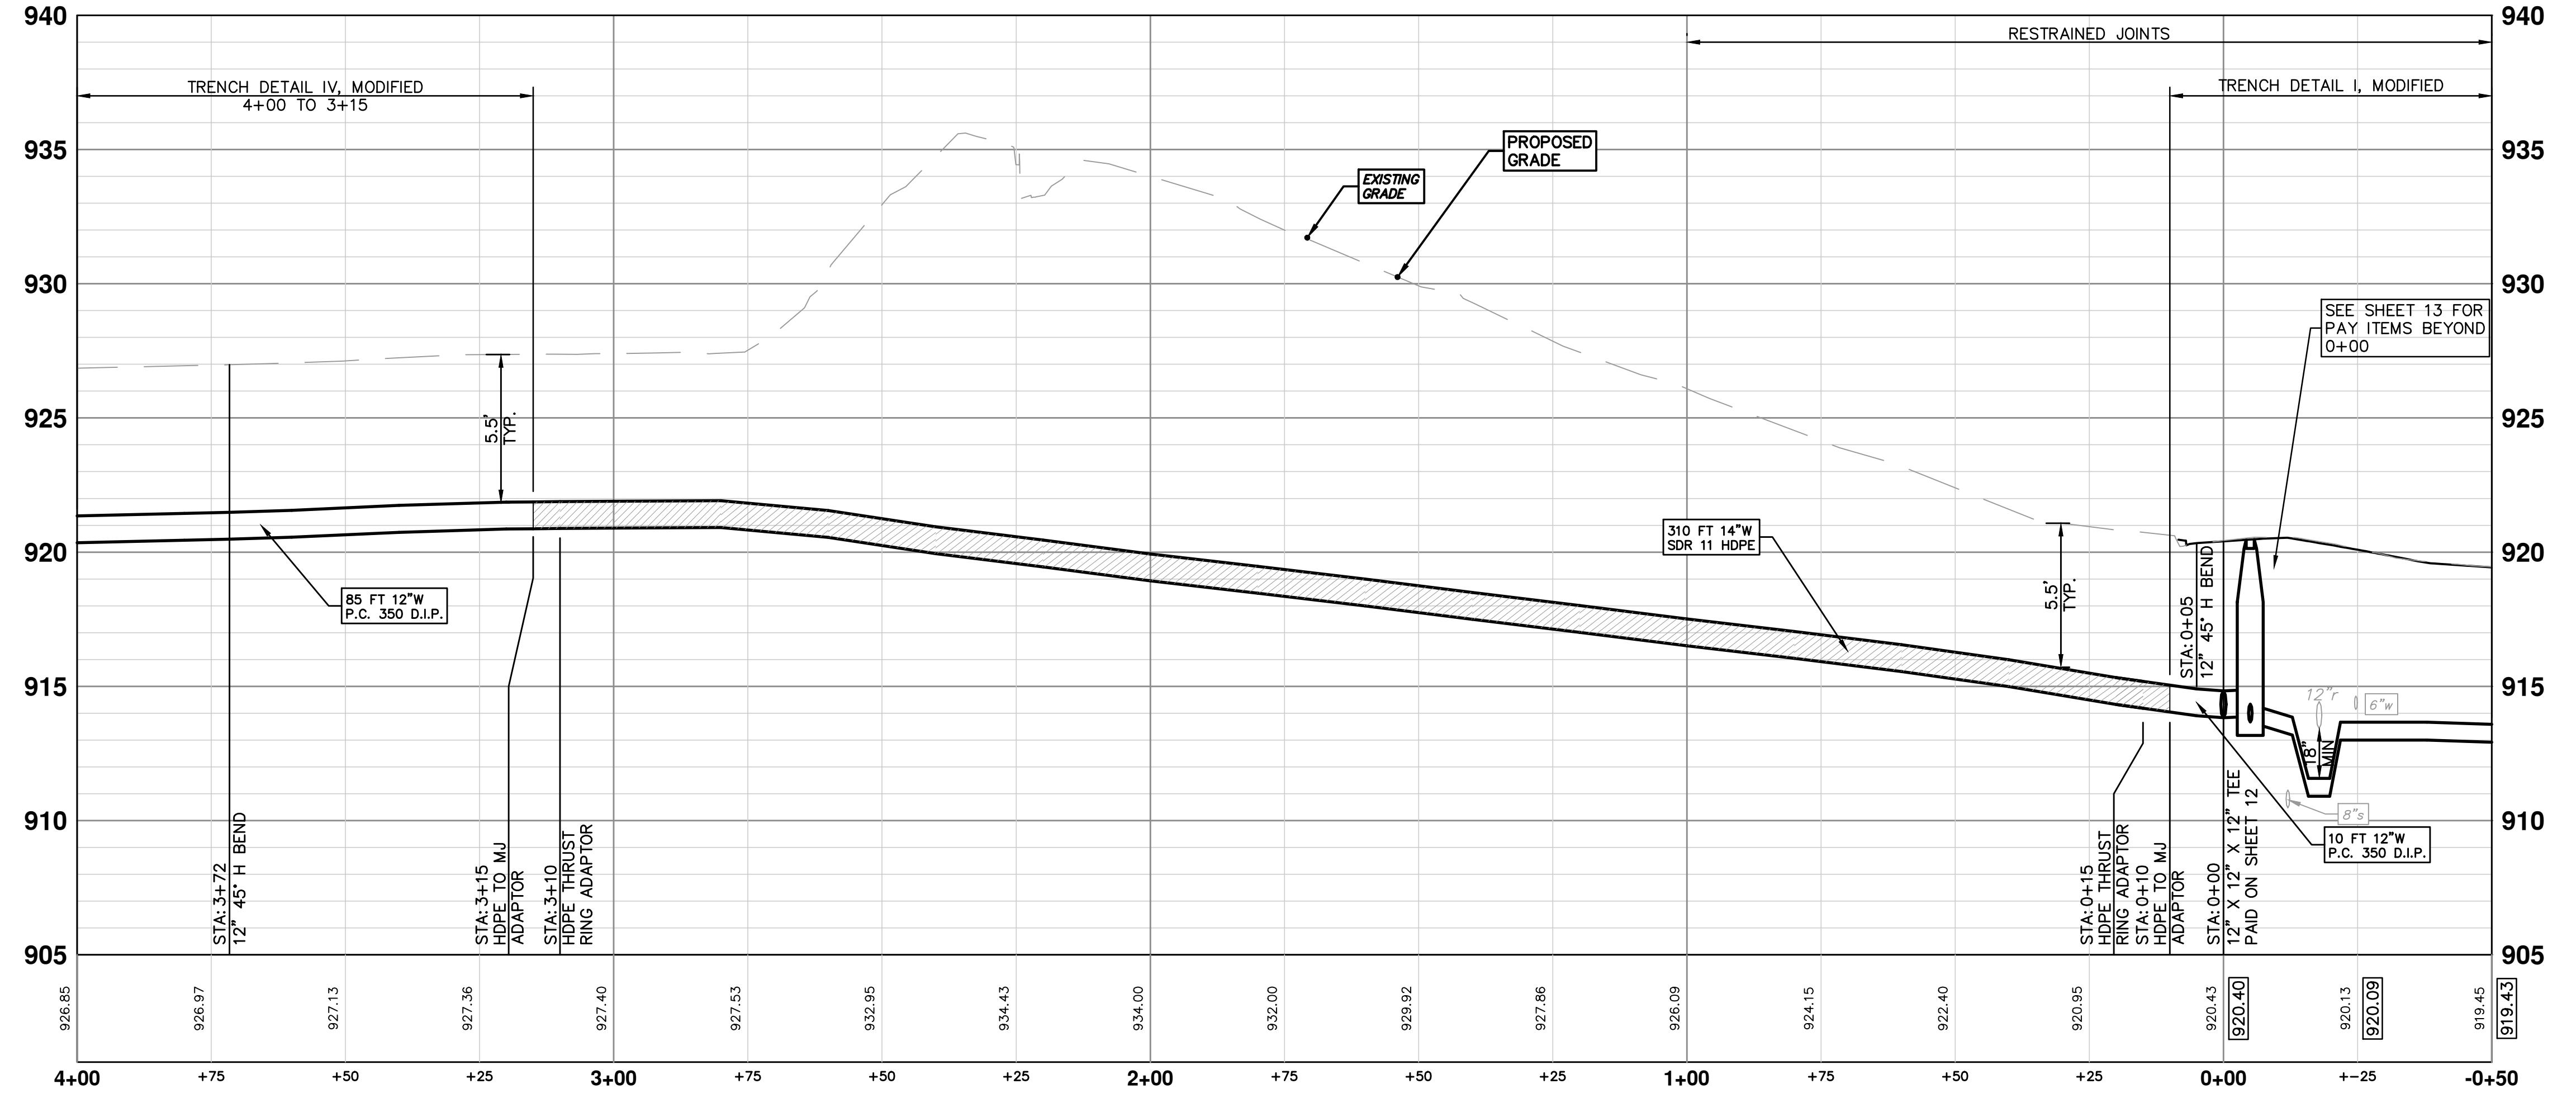


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03 ADENDUM 1	05/01/15	JKA	DAD
02 POST MODE 510 REVIEW	03/18/15	JKA	DAD
01 EBERWHITE EXTENSION	02/26/15	CEC, JKA	DAD
00 MDE PERMIT REVIEW COMMENTS	07-22-14	ES-DPF	DAD
DESCRIPTION	DATE	DRAWN	CHECKED


REV.

CITY OF ANN ARBOR  
PUBLIC SERVICE  
301 EAST LIBRARY STREET  
ANN ARBOR MI 48106-3647  
www.2dig.org

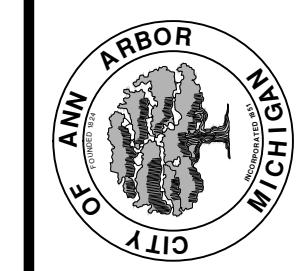

PROJECT MANAGEMENT - PUBLIC SERVICES - CITY OF ANN ARBOR  
HEWETT DR, RUSSELL RD &  
REDEEMER AVE WATER MAIN REPLACEMENT  
WATER MAIN PLAN & PROFILE  
EBERWHITE EXTENSION 0+00 TO 4+00

SCALE PLAN 1" = 20'  
PROFILE 1" = 4'  
DRAWING No. 2013034-20  
SHEET No. 20 OF 30

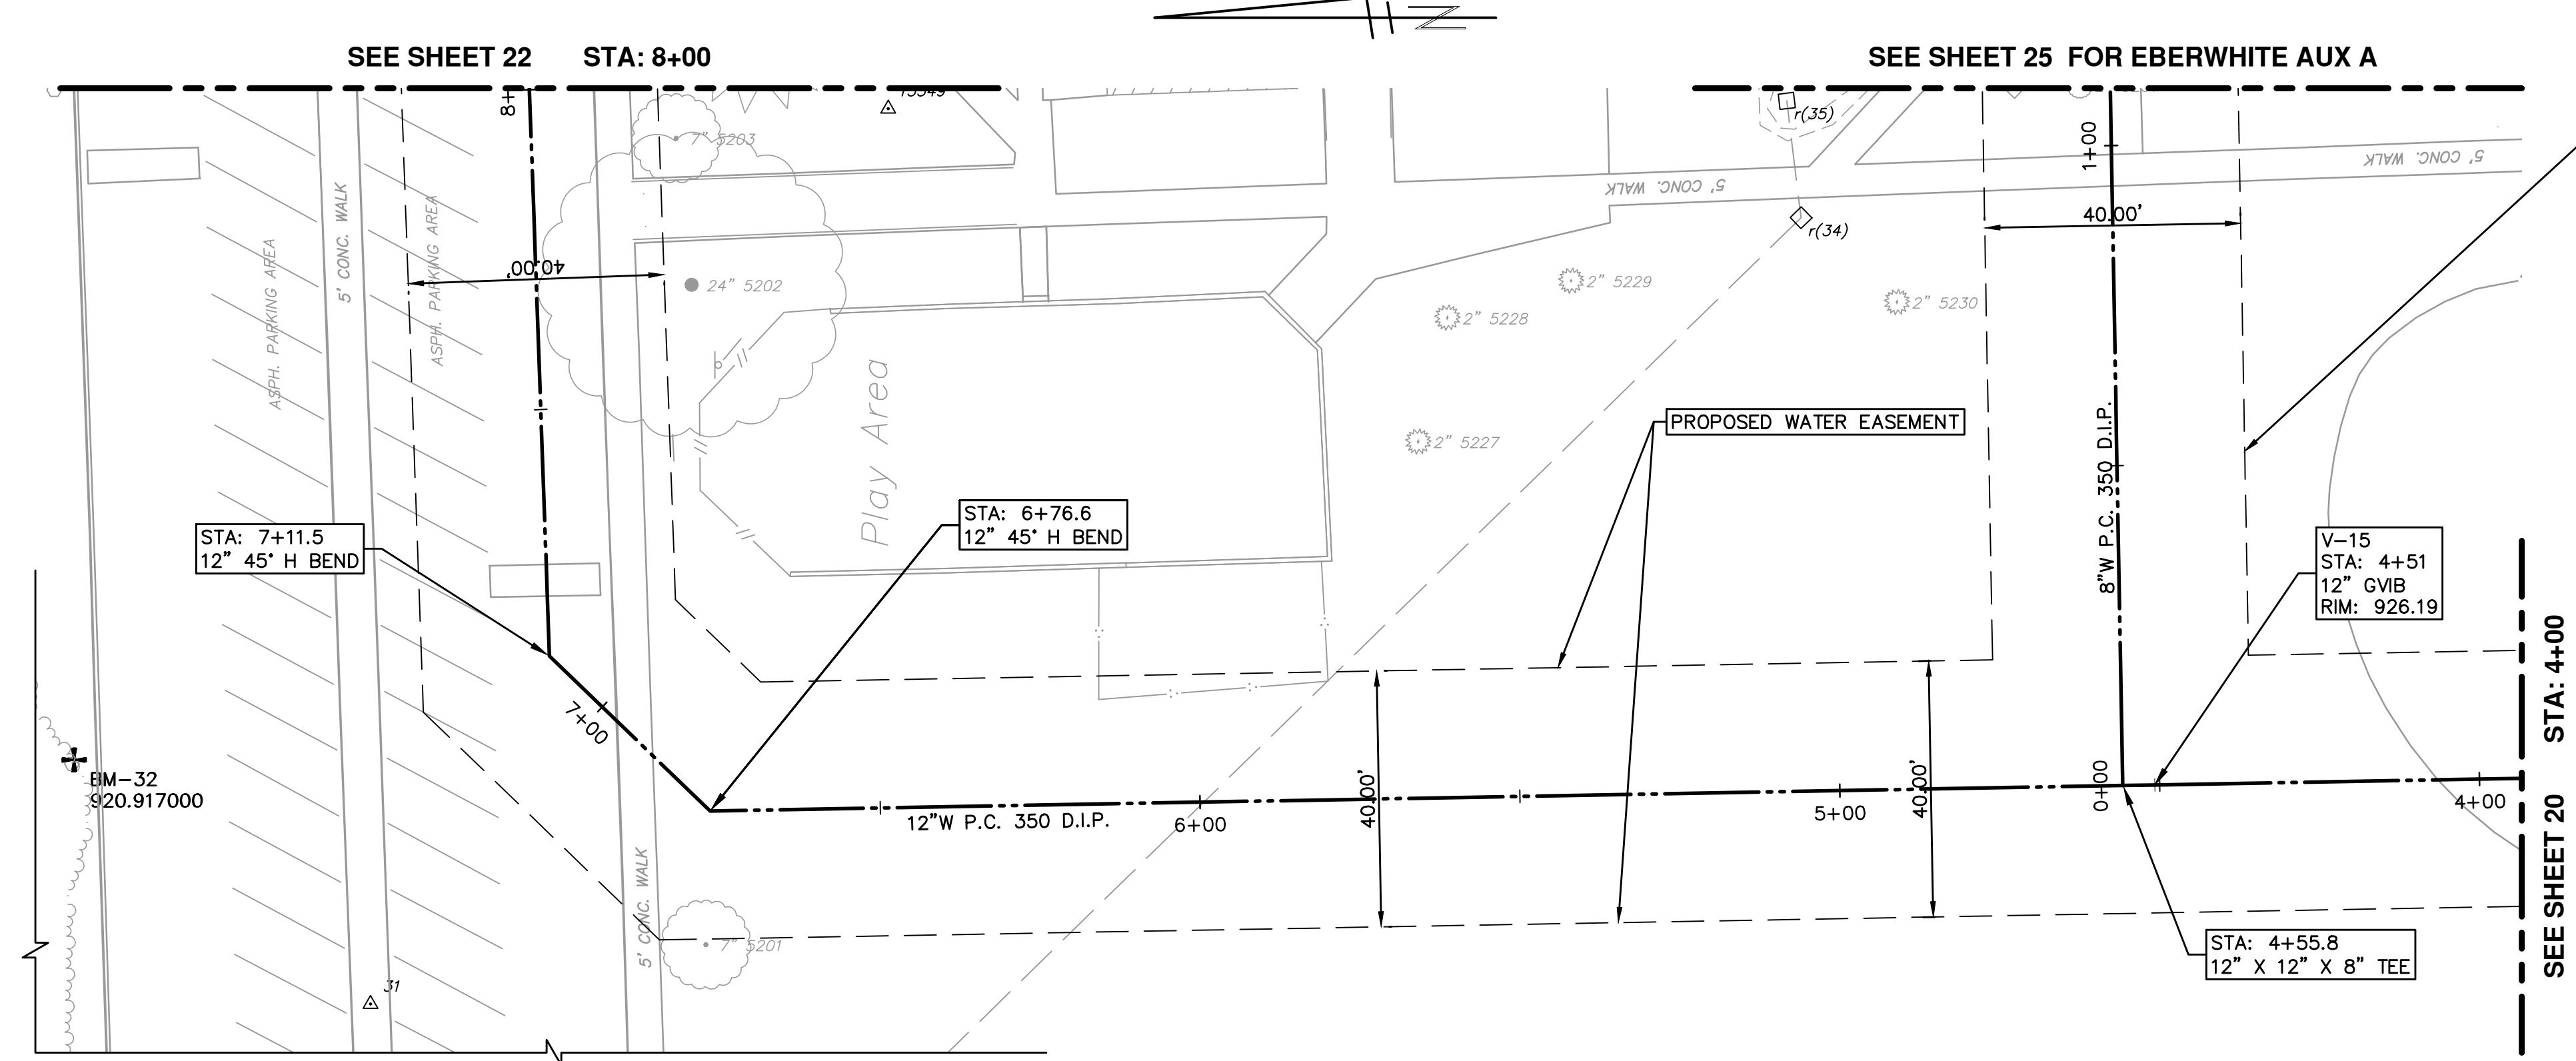

SEE SHEET 20 STA: 4+00


WATER MAIN STRUCTURE TABLE					
STRUCTURE	TYPE	STATION	ALIGNMENT	RIM	DEPTH
V-15	12" GVIB	4+51	Eberwhite	926.19	6.49

<b>PROJECT MANAGEMENT - PUBLIC SERVICES - CITY OF ANN ARBOR</b>	
<b>HEWETT DR, RUSSELL RD &amp; REDEEMER AVE WATER MAIN REPLACEMENT</b>	
WATER MAIN PLAN & PROFILE	
EBERWHITE EXTENSION 4+00 TO 8+00	
SCALING PLAN: 1" = 20'	PROFILE: 1" = 4'
DRAWING No.	
2013034-21	

<b>CITY OF ANN ARBOR</b>	03 ADENDUM 1	05/01/15
PUBLIC SERVICE	02 POST MODE 2015 REVIEW	05/18/15
EAST HURON STREET	01 EBERWHITE EXTENSION	02/26/15
ANN ARBOR MI 48106	00 NEDO PERMIT REVIEW COMMENTS	02/22/14
www.a2gov.org	DESCRIPTION	REV.




Know what's below.  
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SEE SHEET 21 STA: 7+50

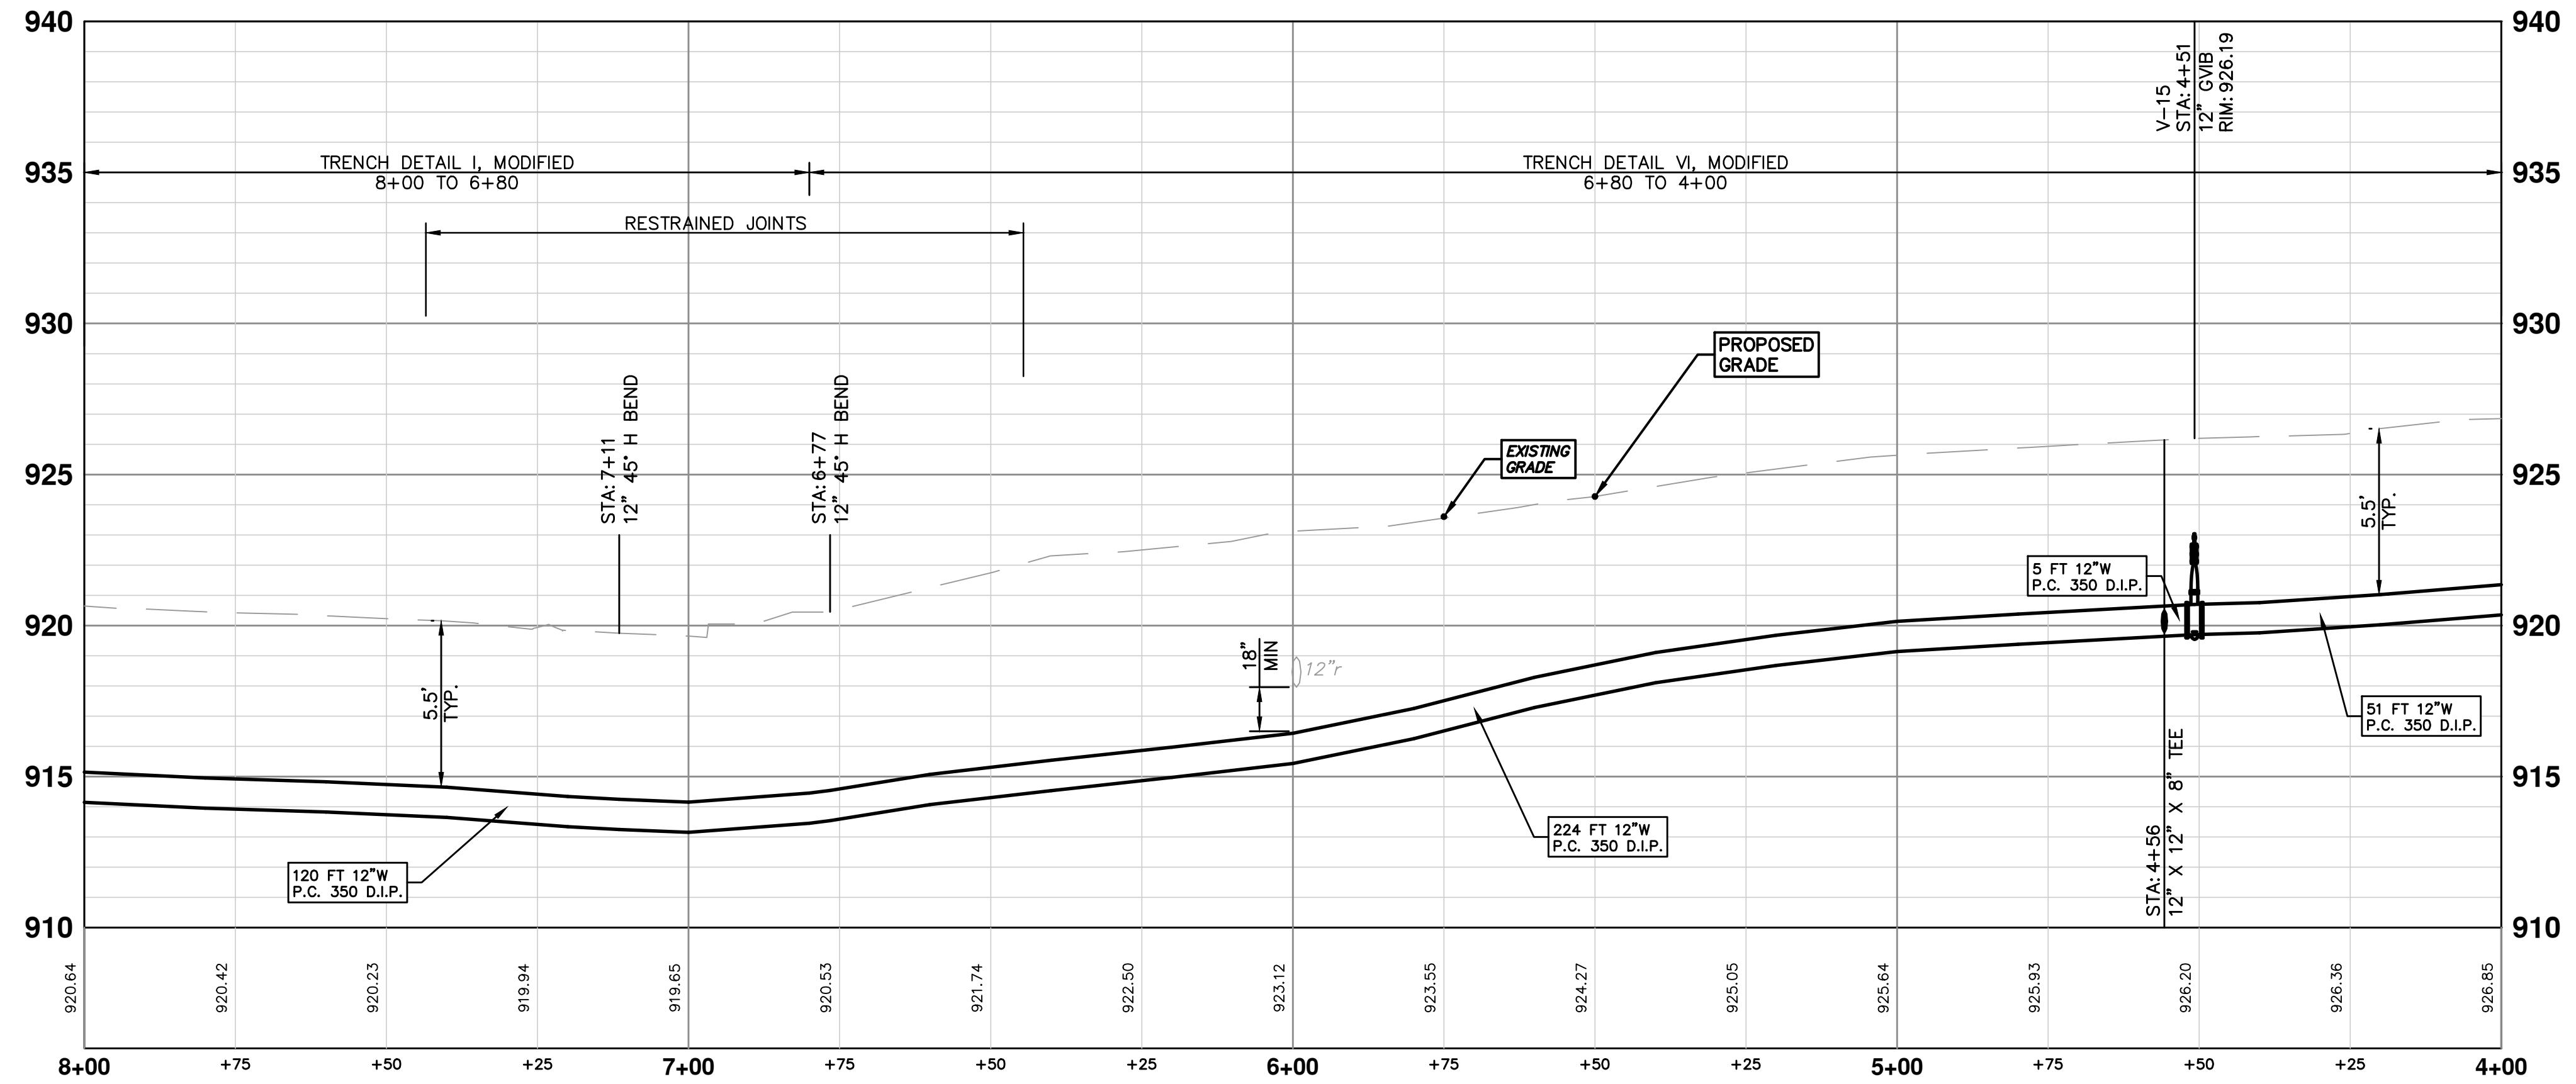SEE SHE

104




SEE SHEET 21 STA: 7+50

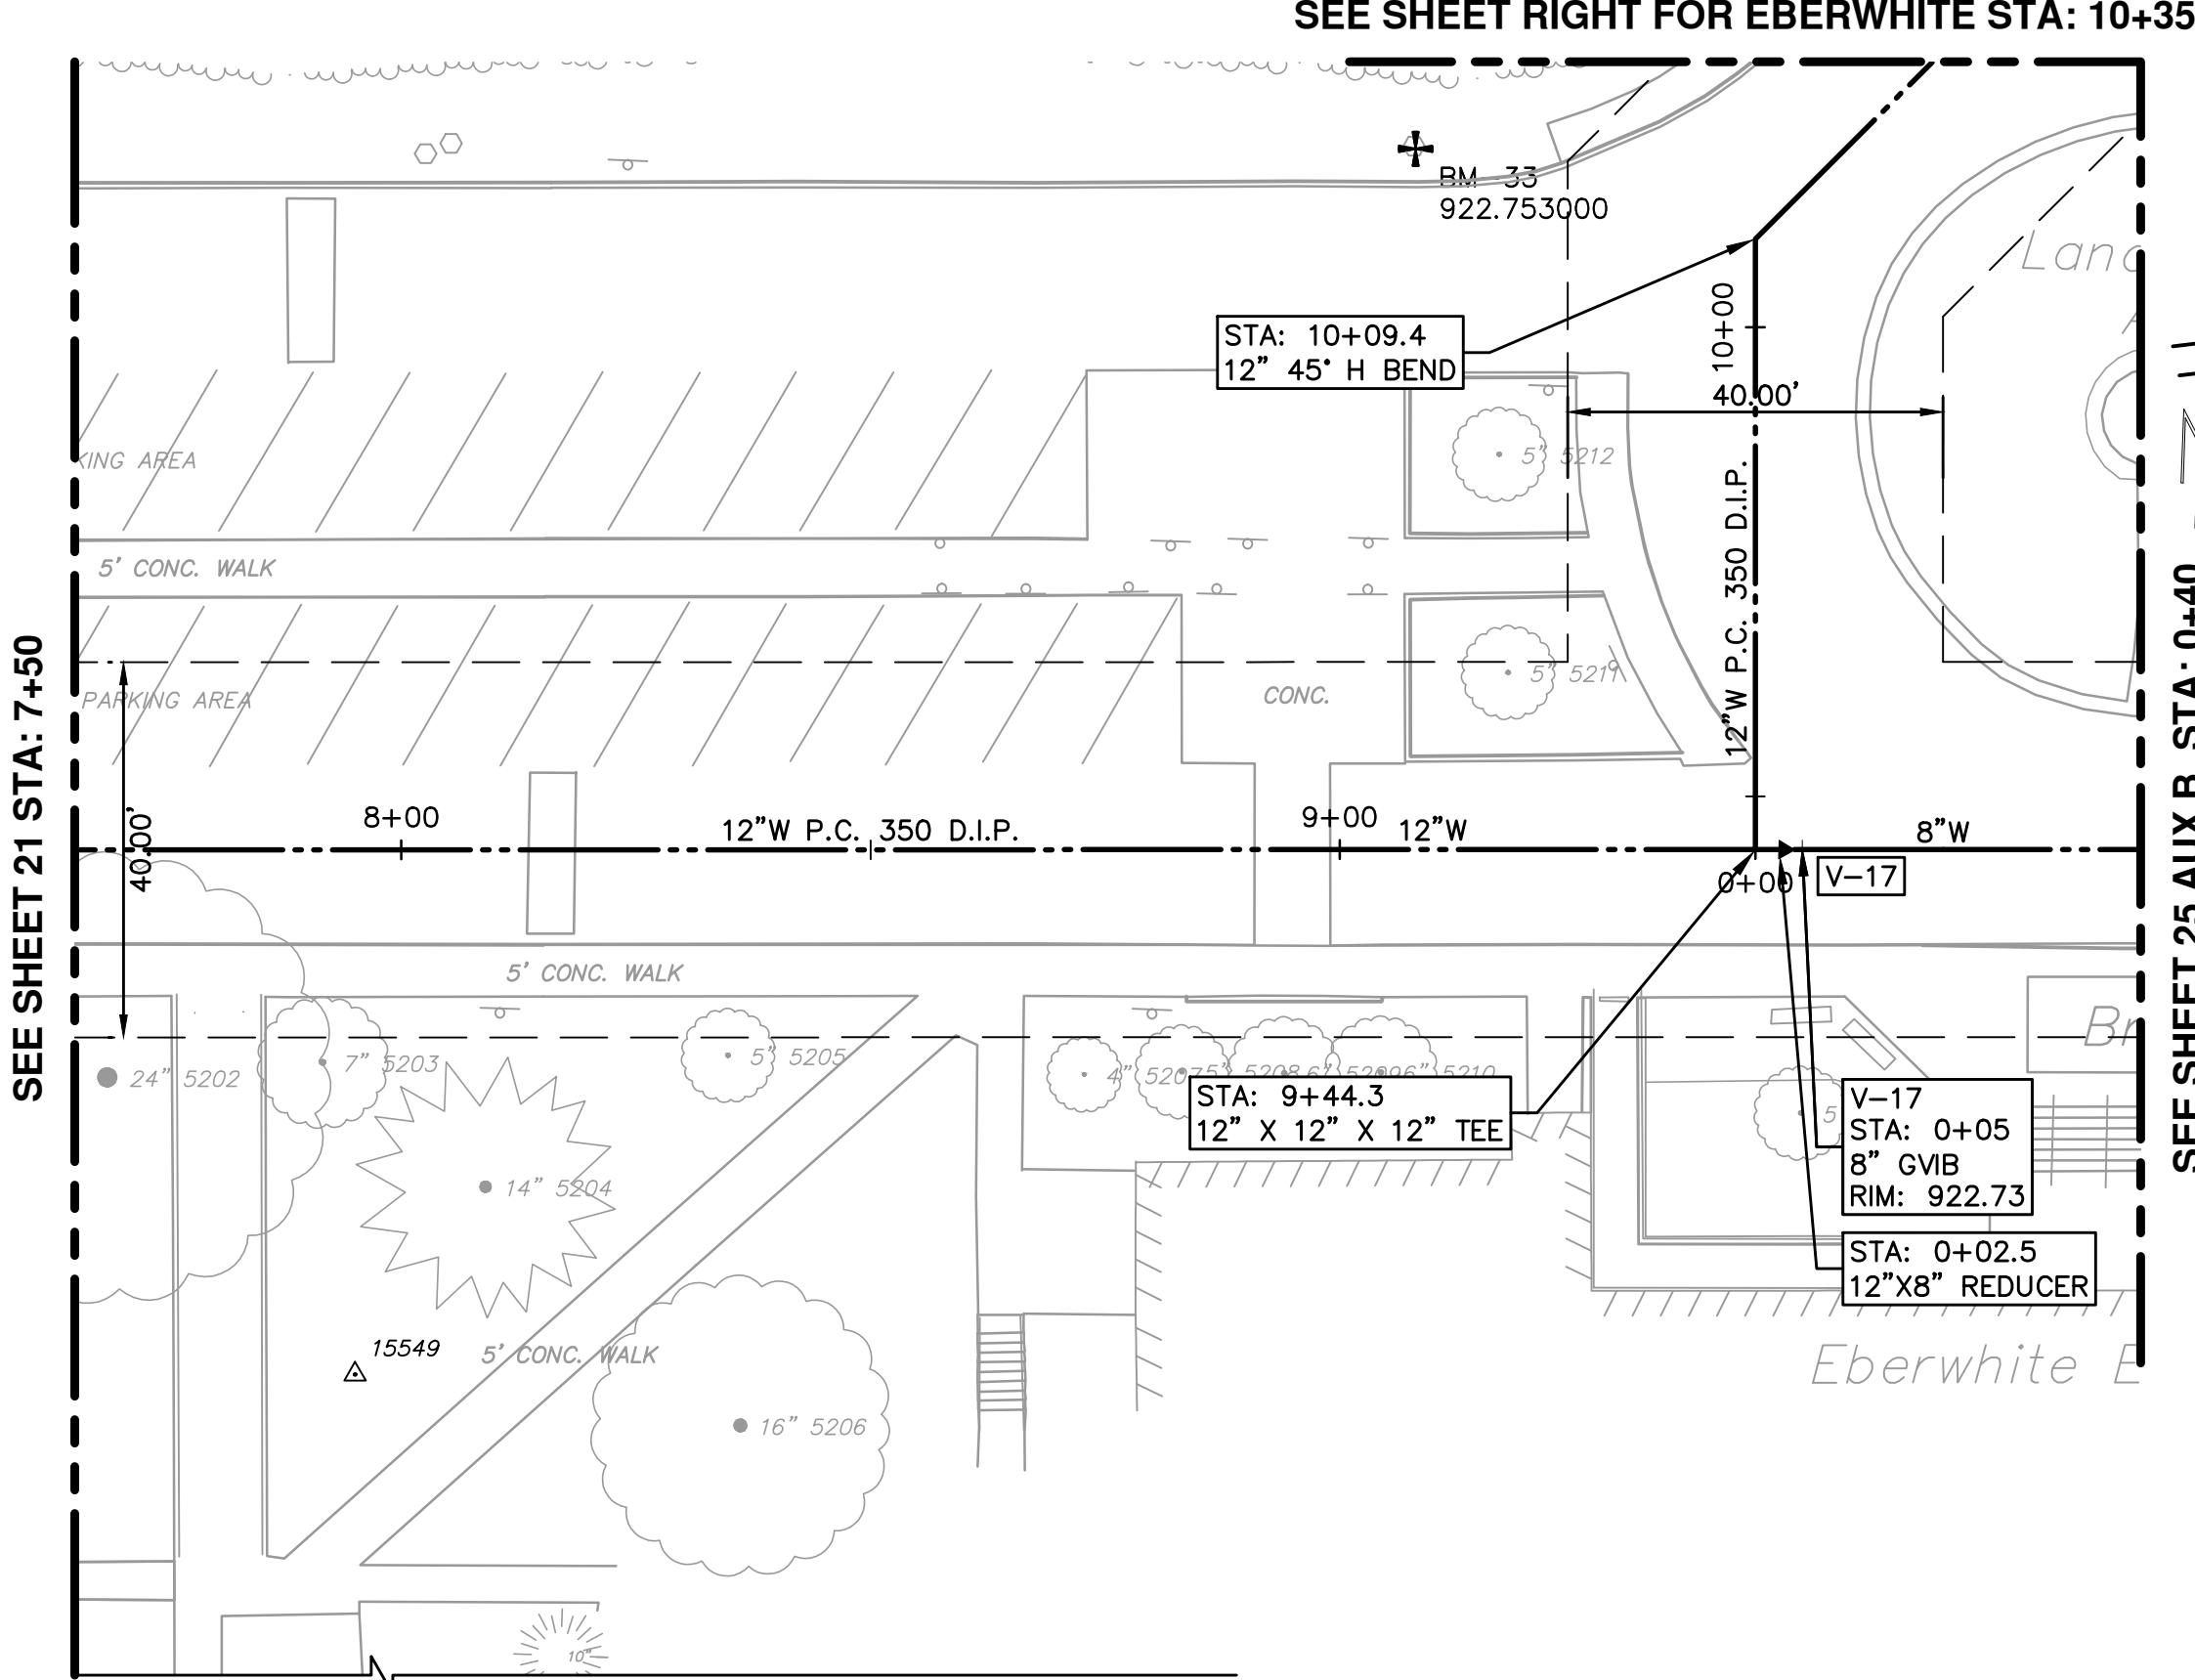3n


SEE SHEET RIGHT FOR EBERWHITE STA: 1

SEE SHEET RIGHT FOR EBERWHITE STA: 1

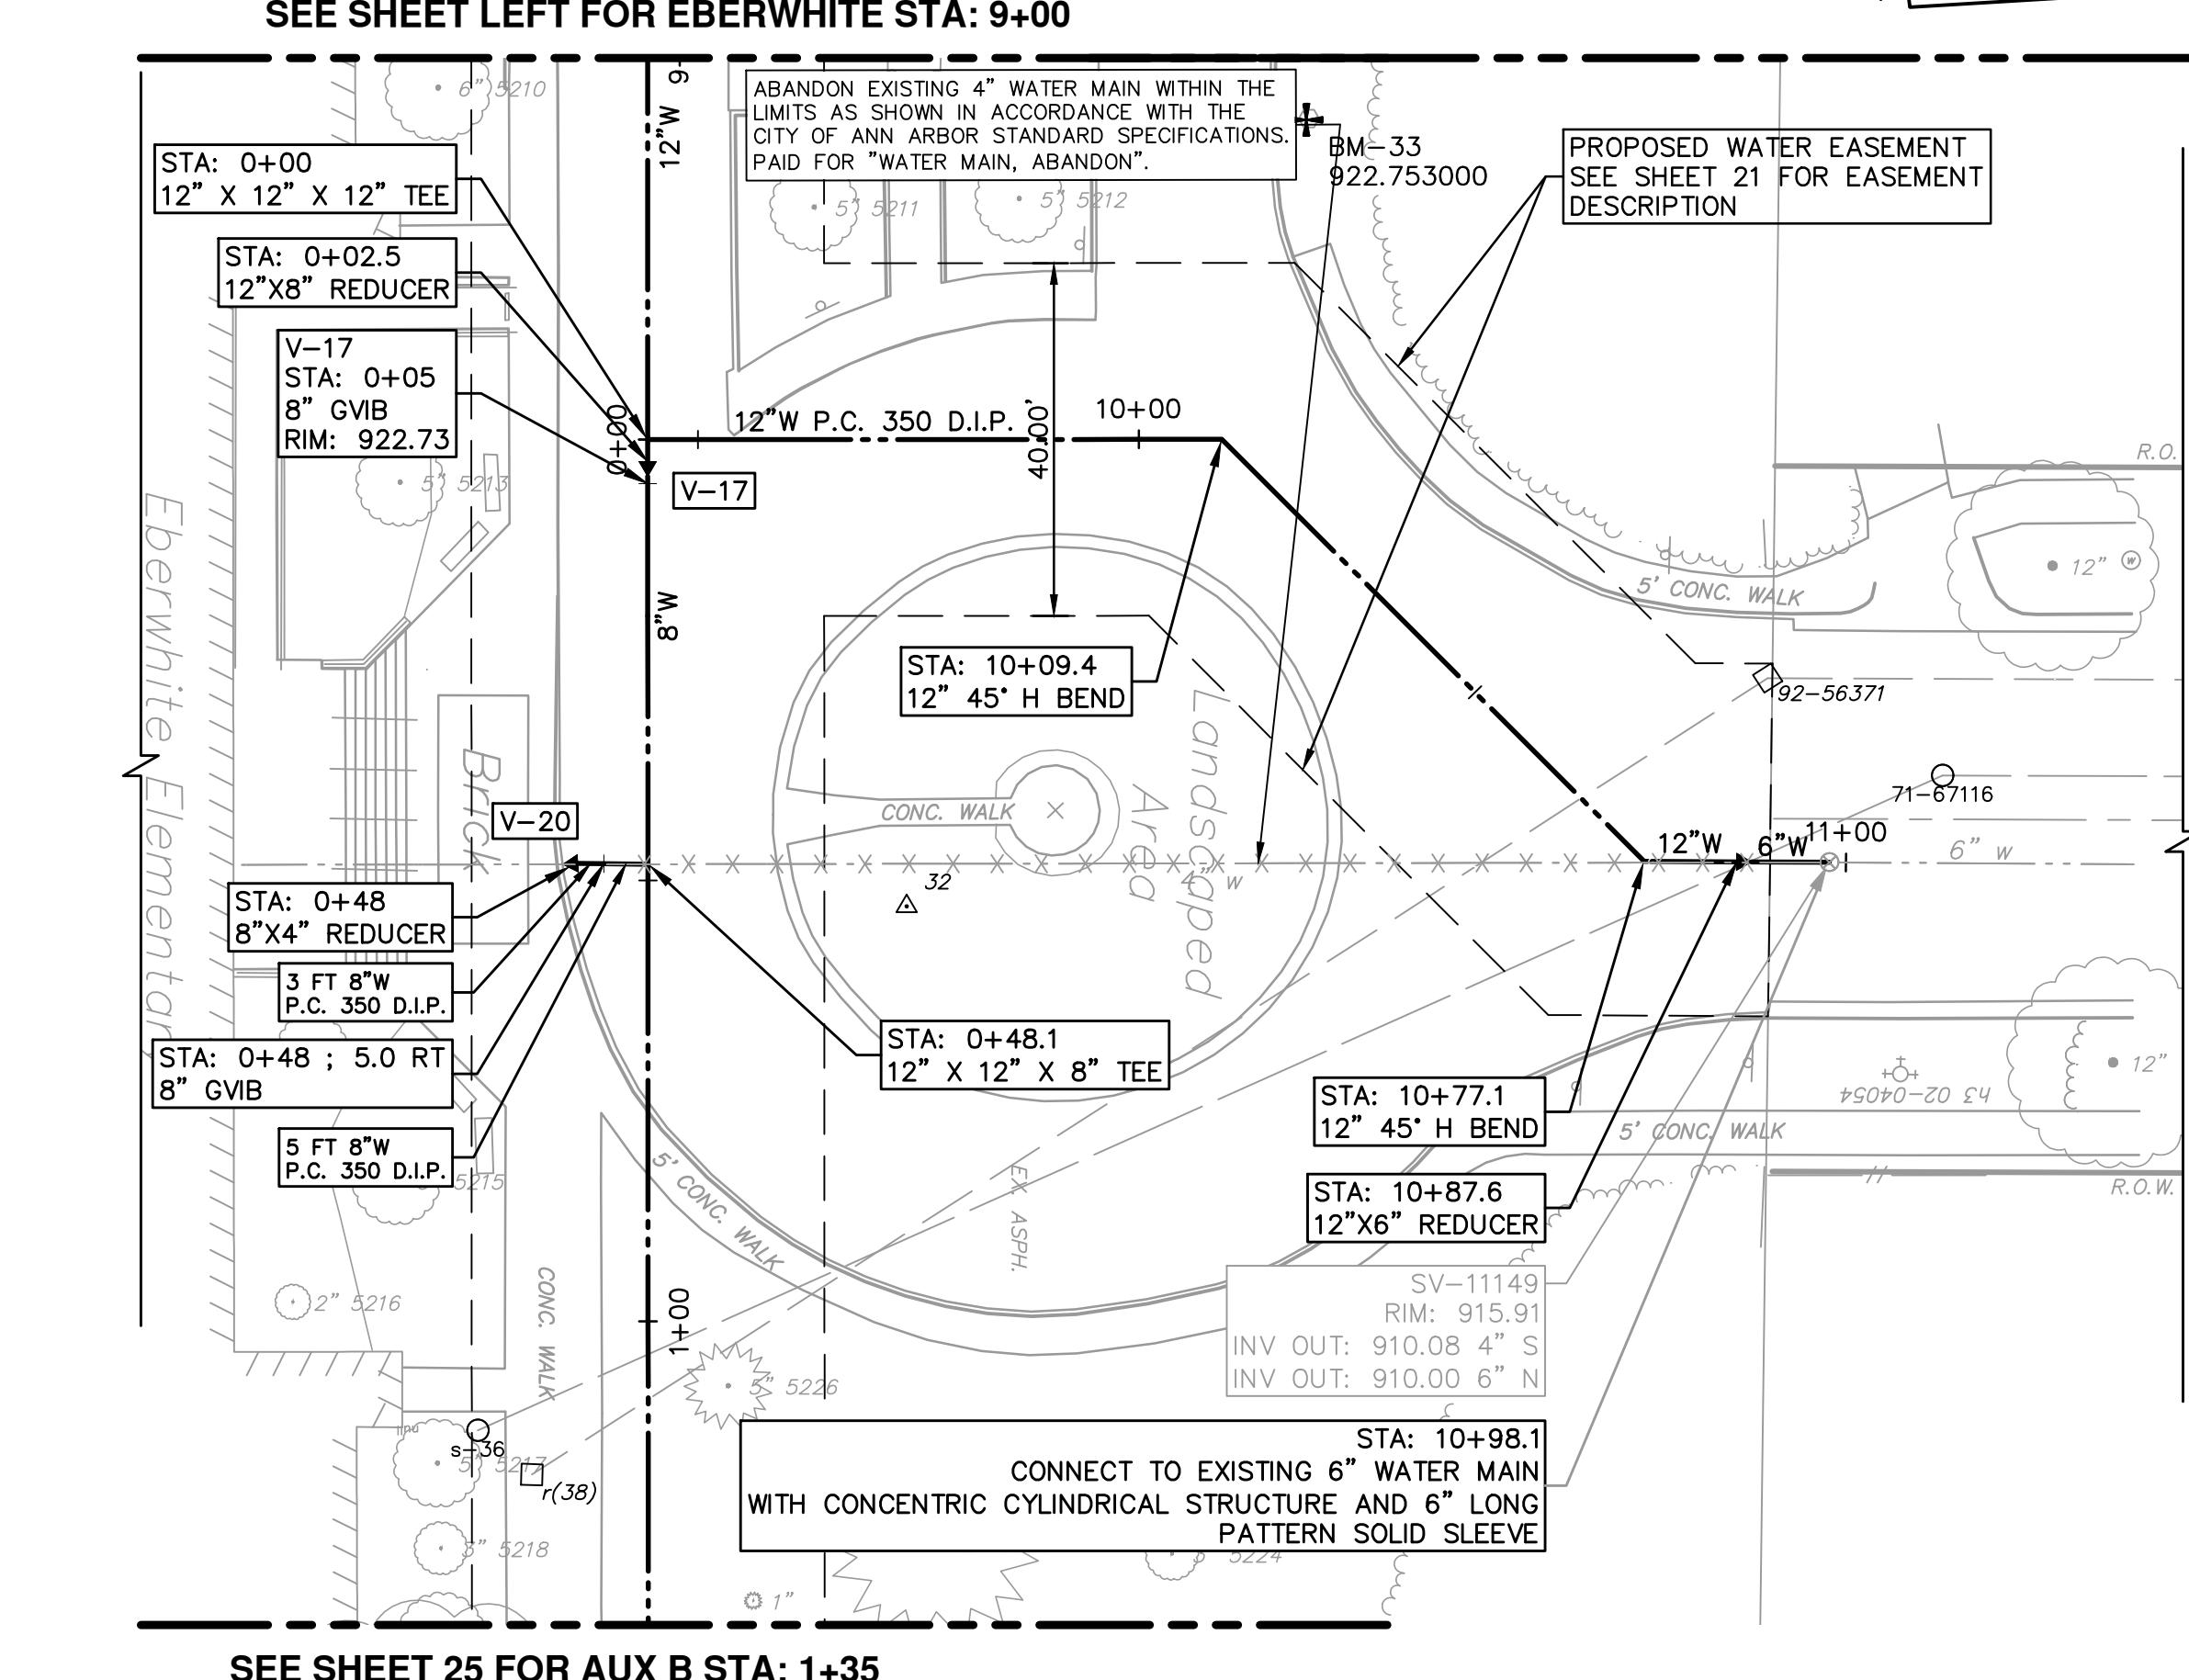

**SEE SHEET 25 FOR AUX B STA: 1+35**

**SEE SHEET LEFT FOR EBERWHITE STA: 9+**

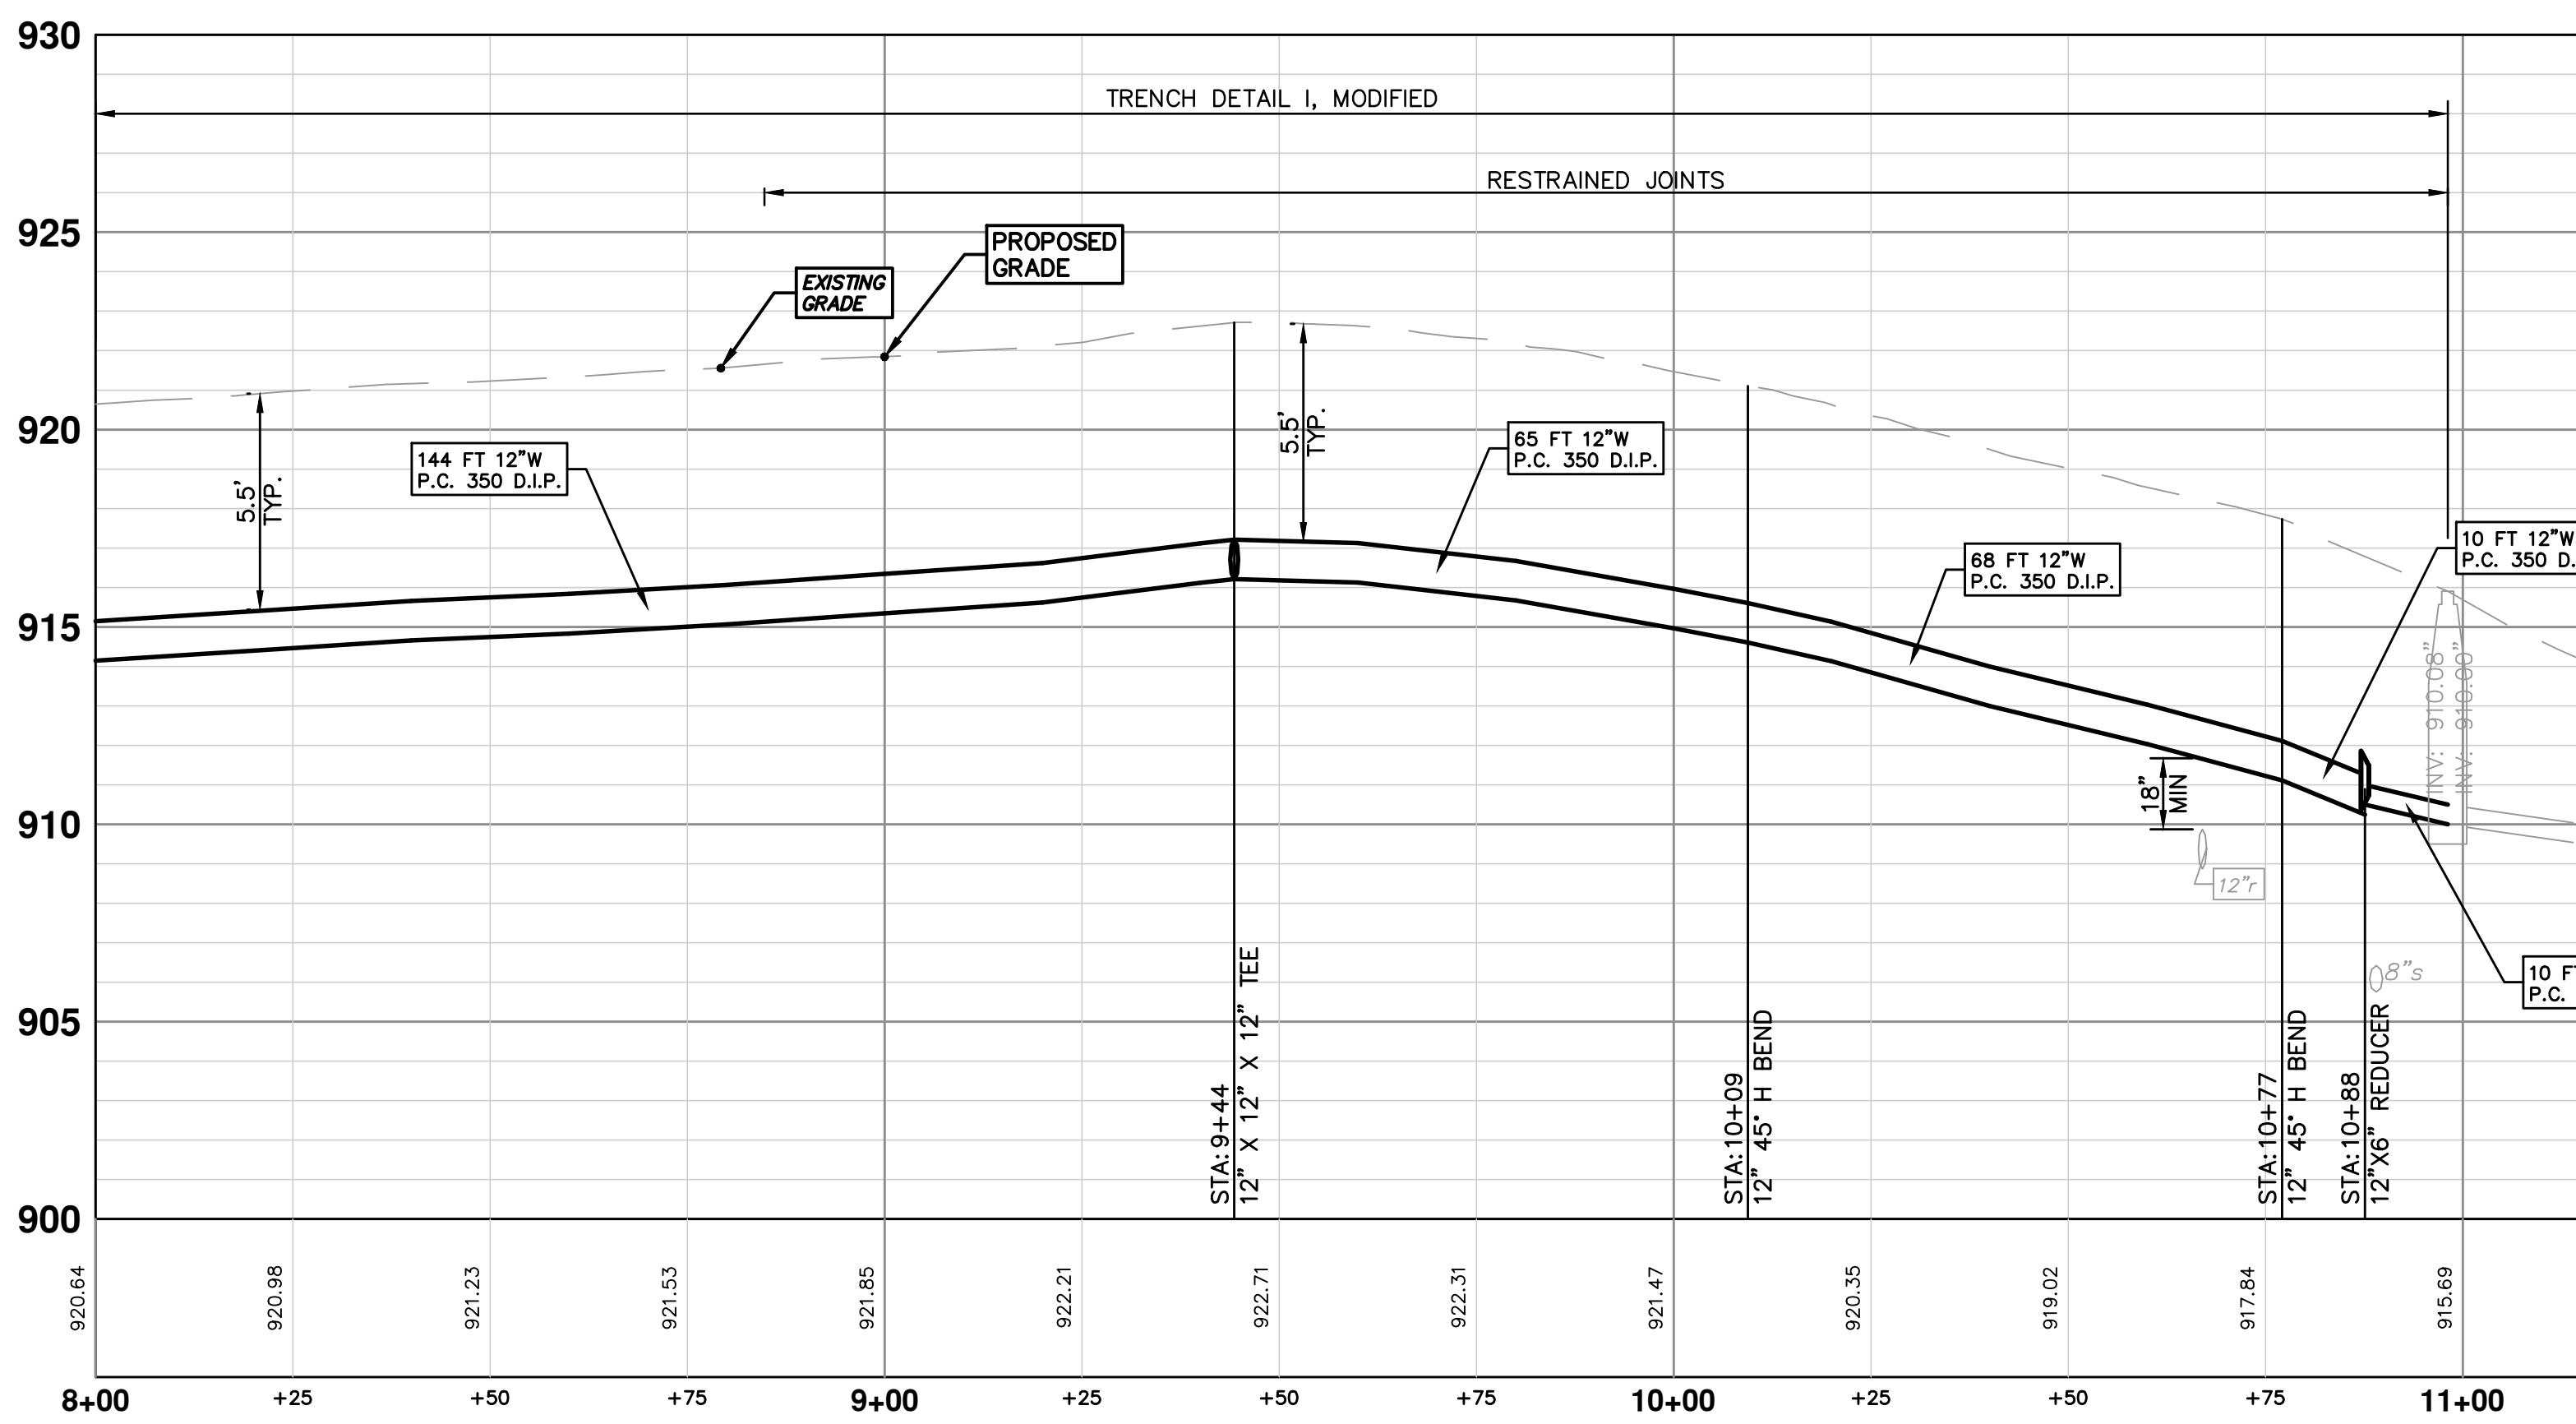

TRENCH DETAIL I, MO

## RESTRAINED JOINTS

STRUCTURE TABLE


STRUCTURE NAME:	DETAILS:	PIPES IN:	PIPES OUT
w-751	48" RIM = 915.91 SUMP = 910.0 INV OUT = 910.08 INV OUT = 910.00		p-(583), 4" TYPE K INV OUT =910.08 p-(567), 6" DIP INV OUT =910.00




## **WATER MAIN STRUCTURE TABLE**

WATER MAIN STRUCTURE TABLE					
STRUCTURE	TYPE	STATION	ALIGNMENT	RIM	DEPTH
V-17	8" GVIB	0+05	Eberwhite-Aux B	922.73	6.14
V-20	8" GVIB	0+48	Eberwhite-Aux B	923.40	8.80


**PROJECT MANAGEMENT - PUBLIC SERVICES - CITY OF ANN ARBOR**

22 OF 30

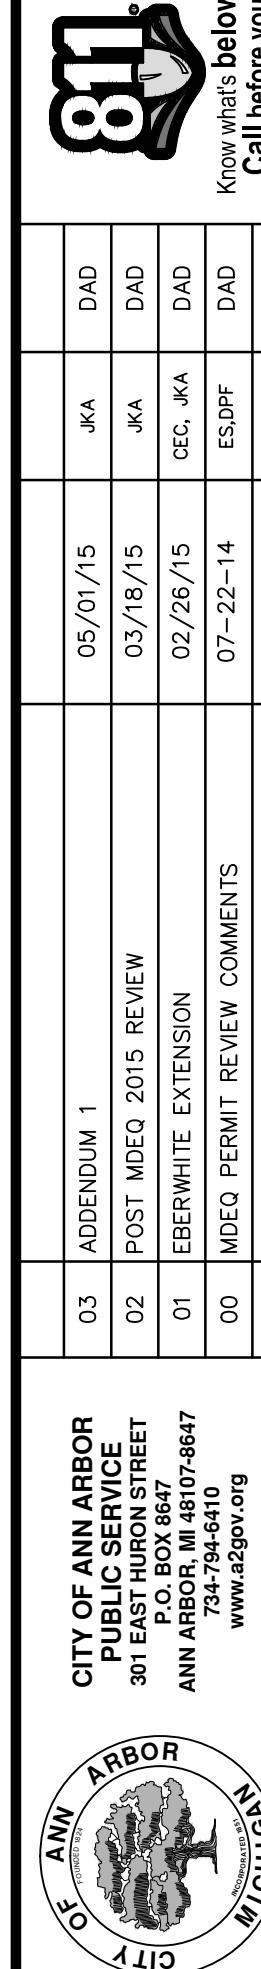


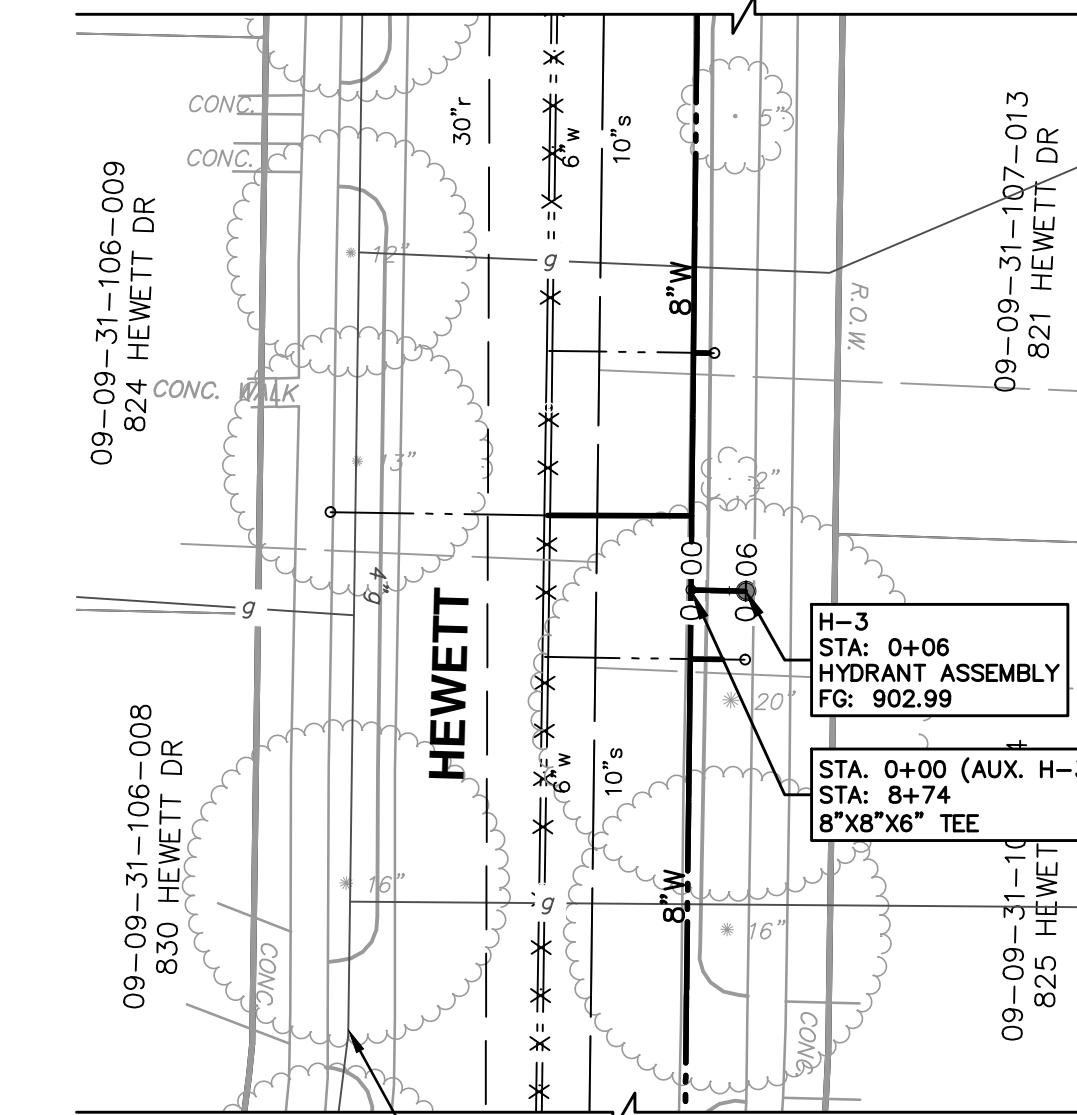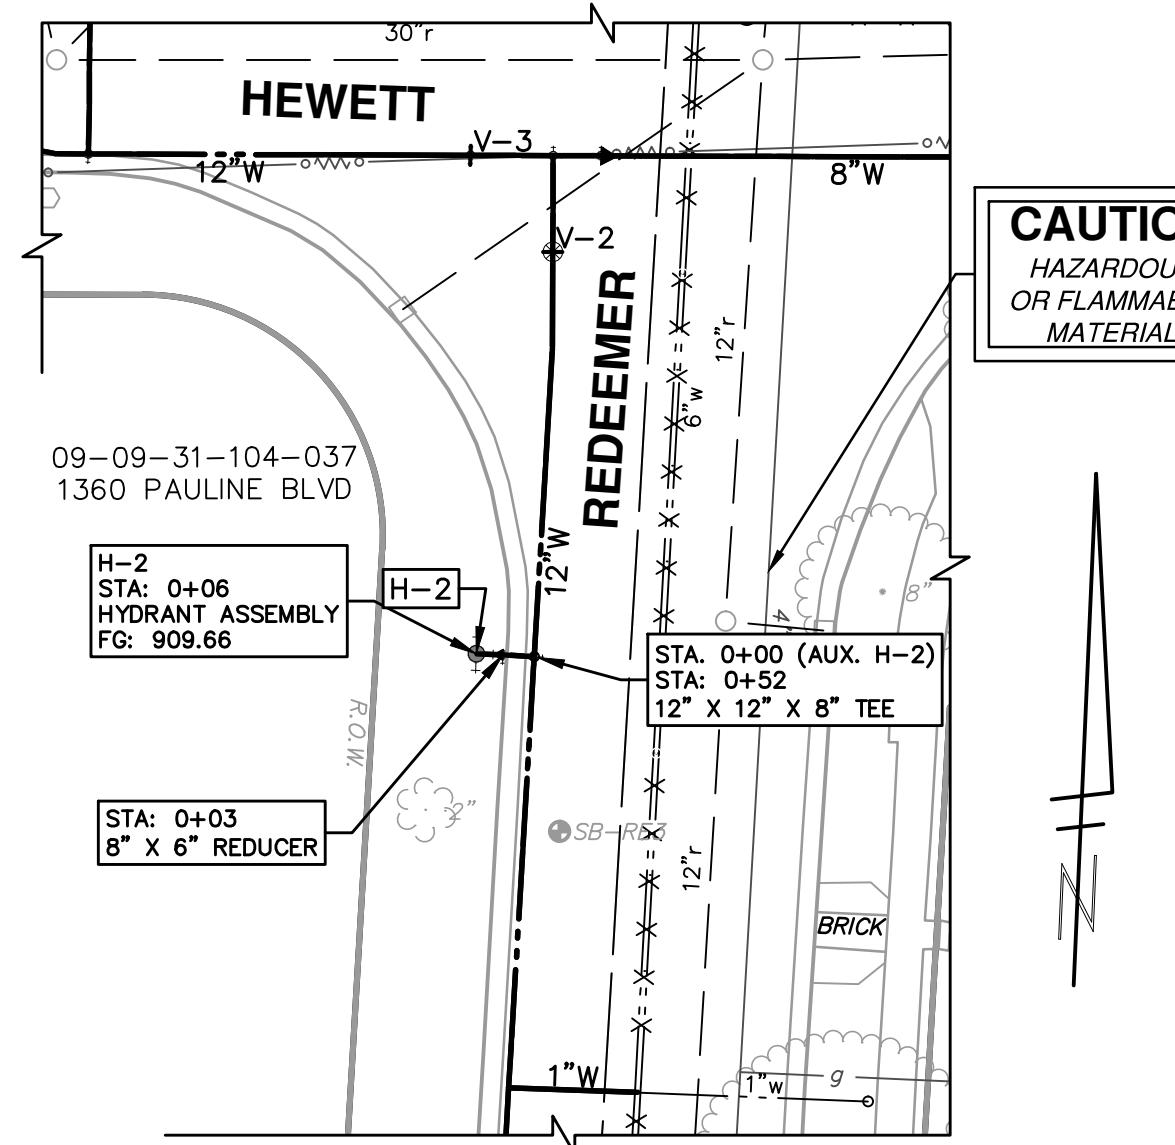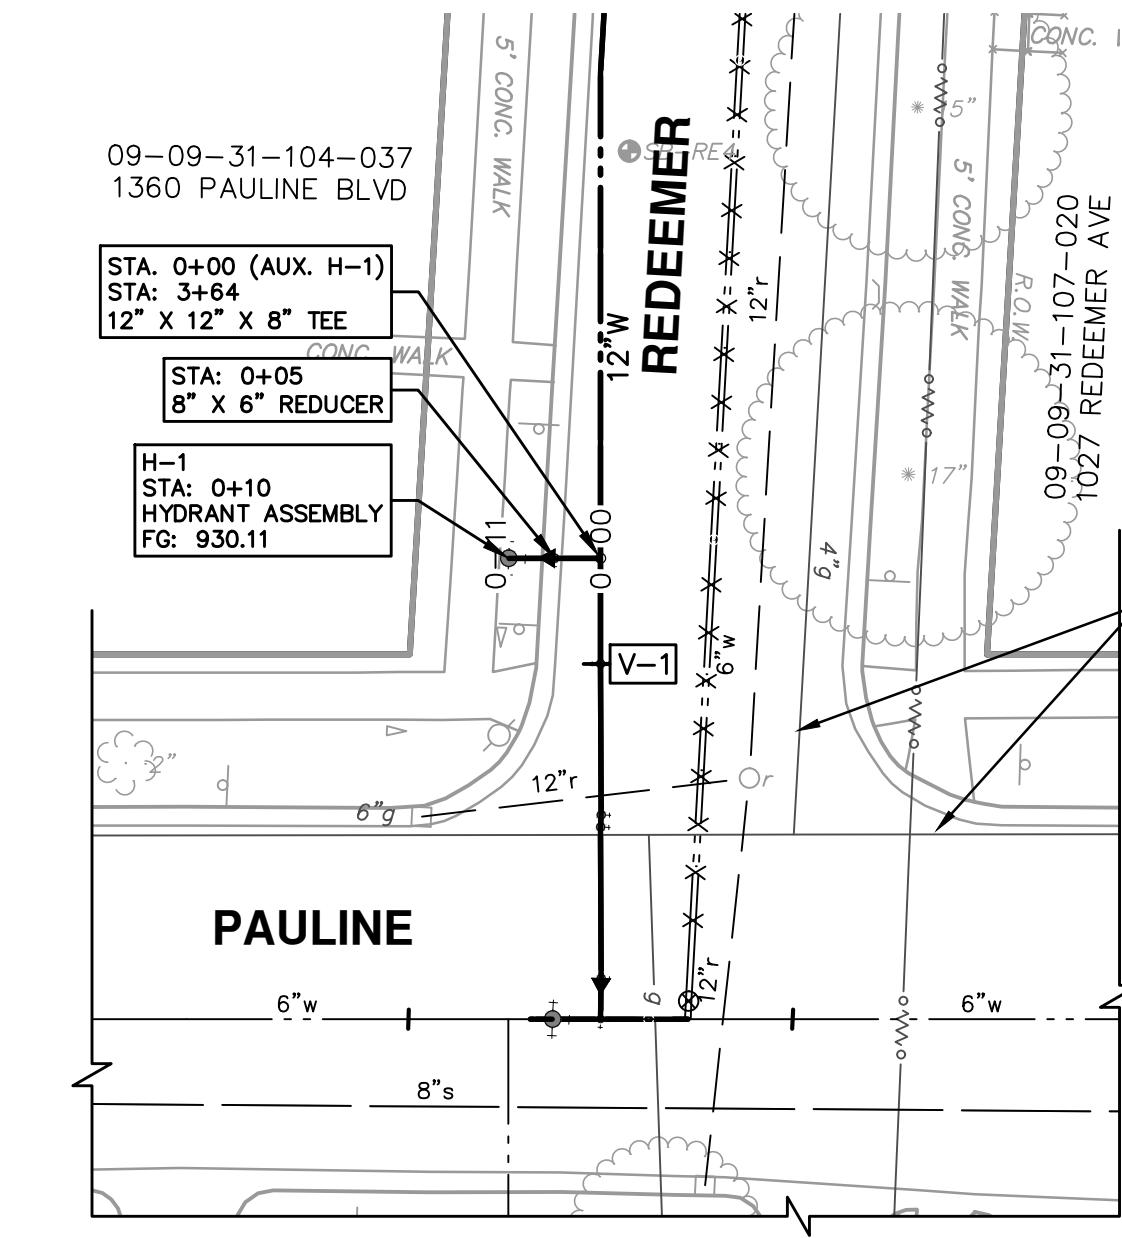


**H-1**

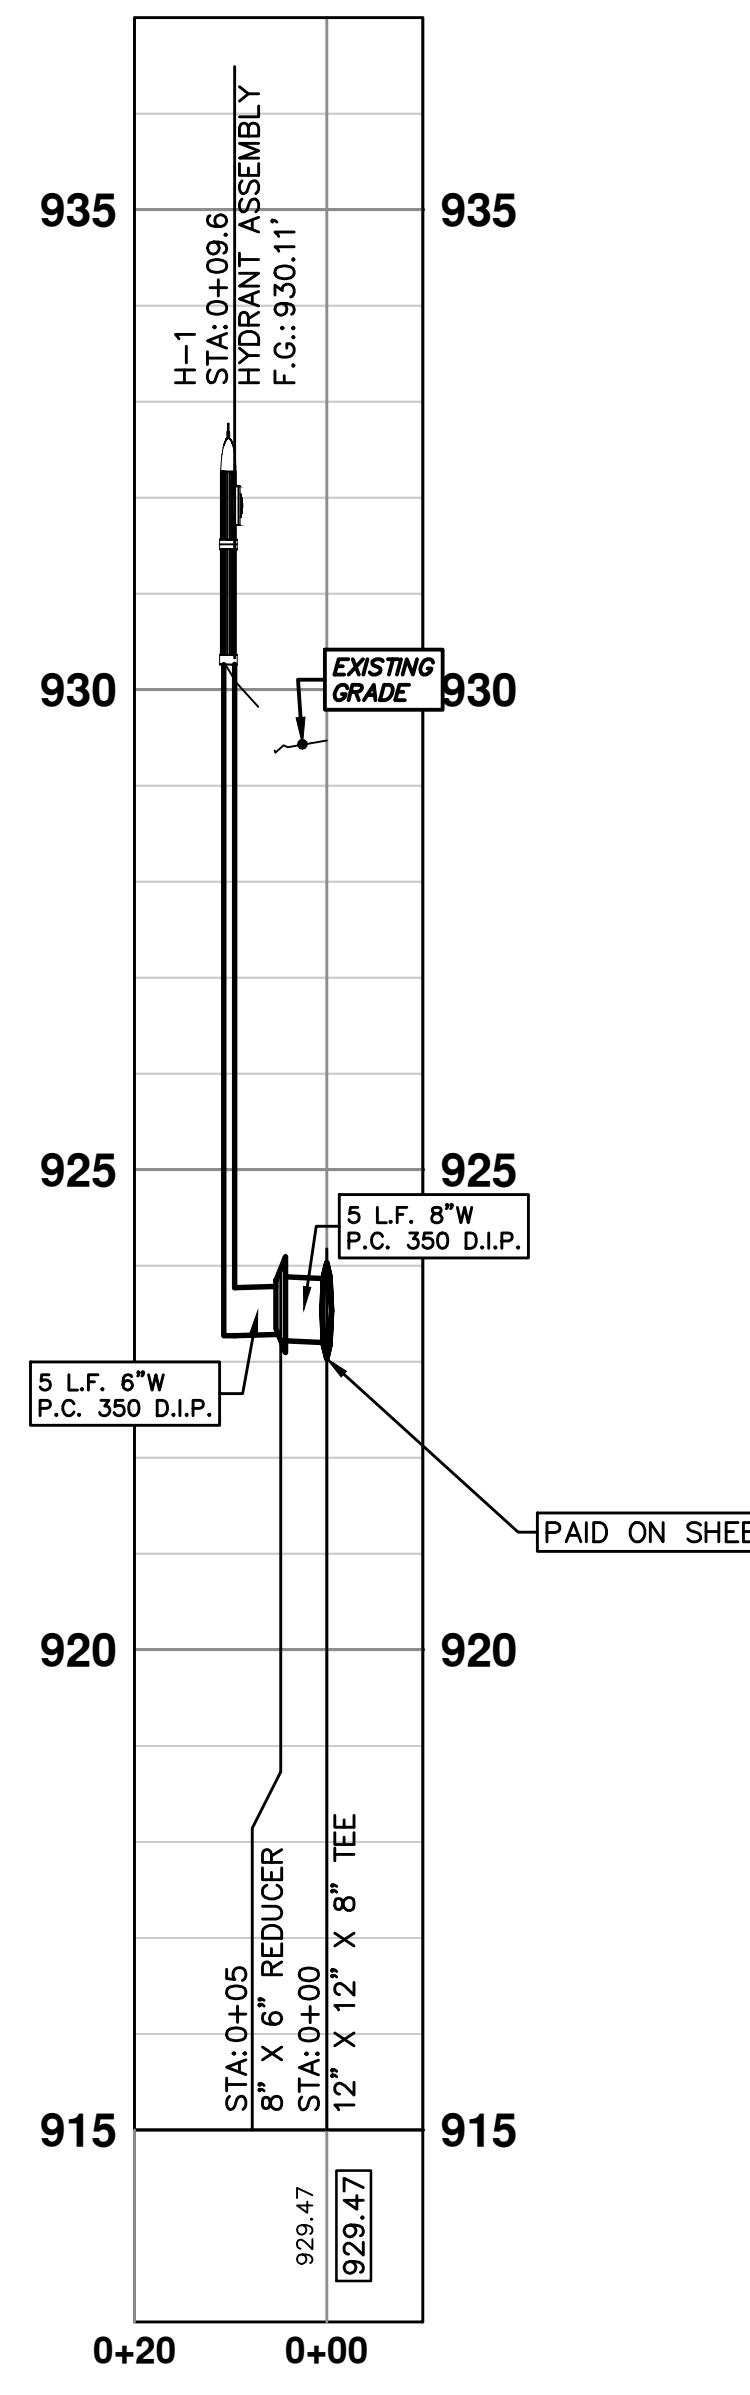

**H-2**

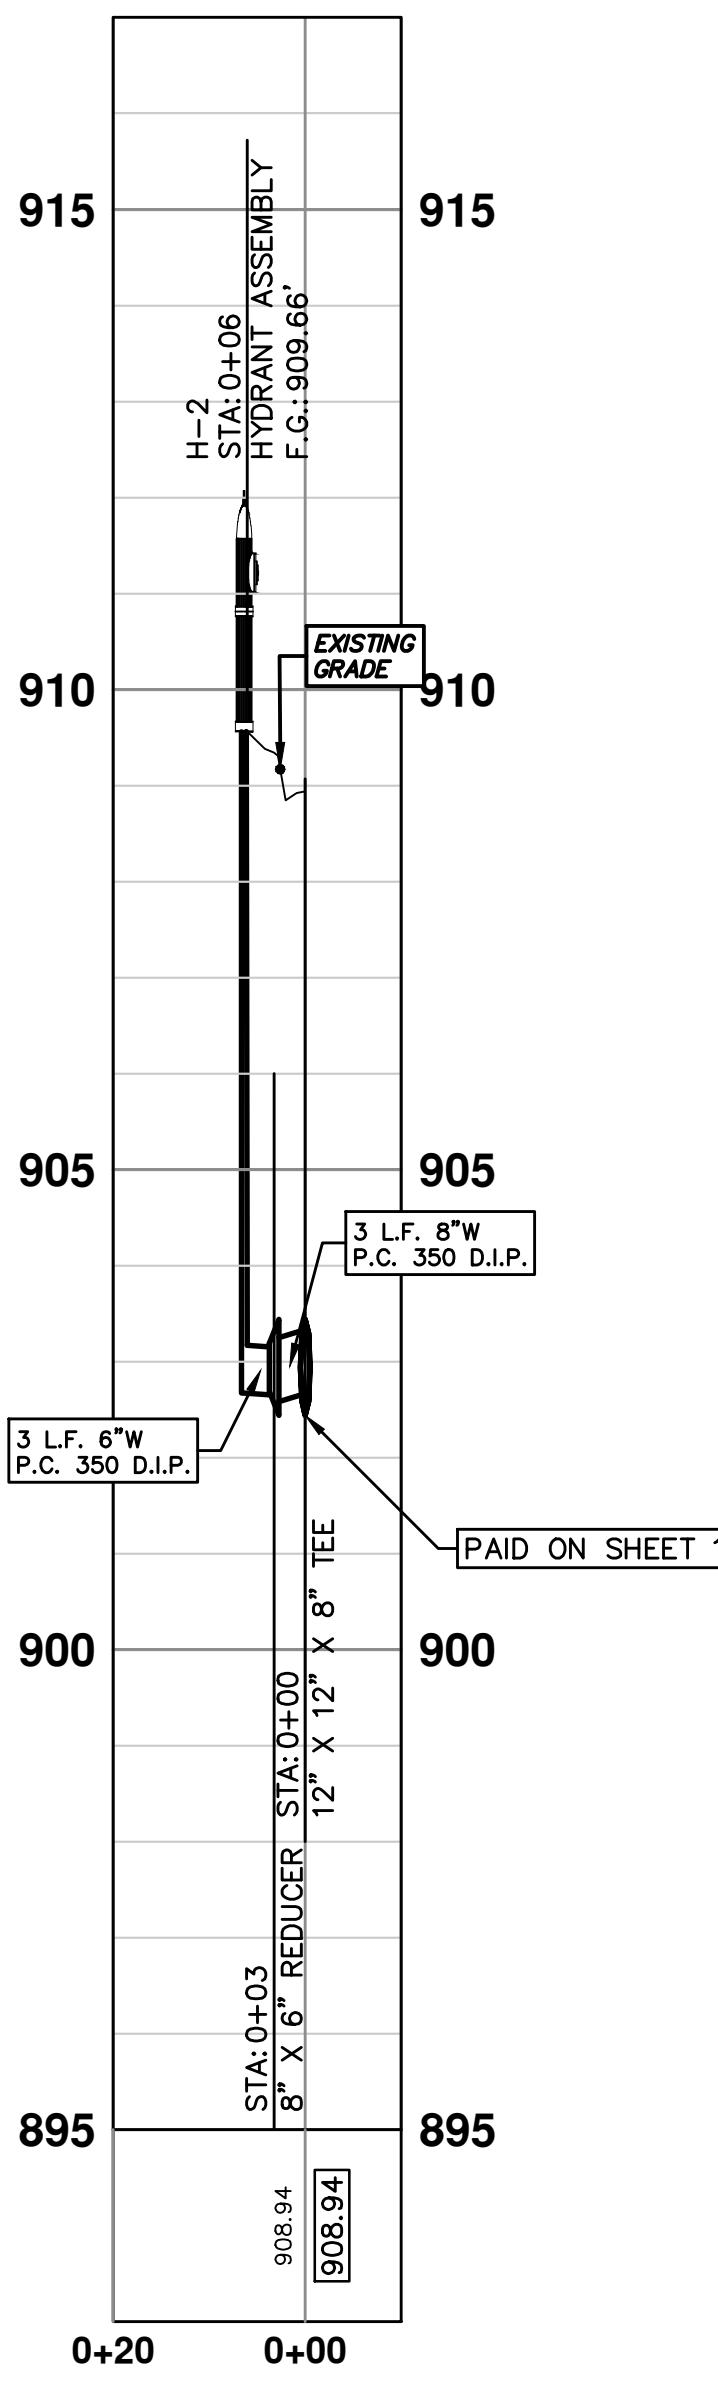


**H-3**

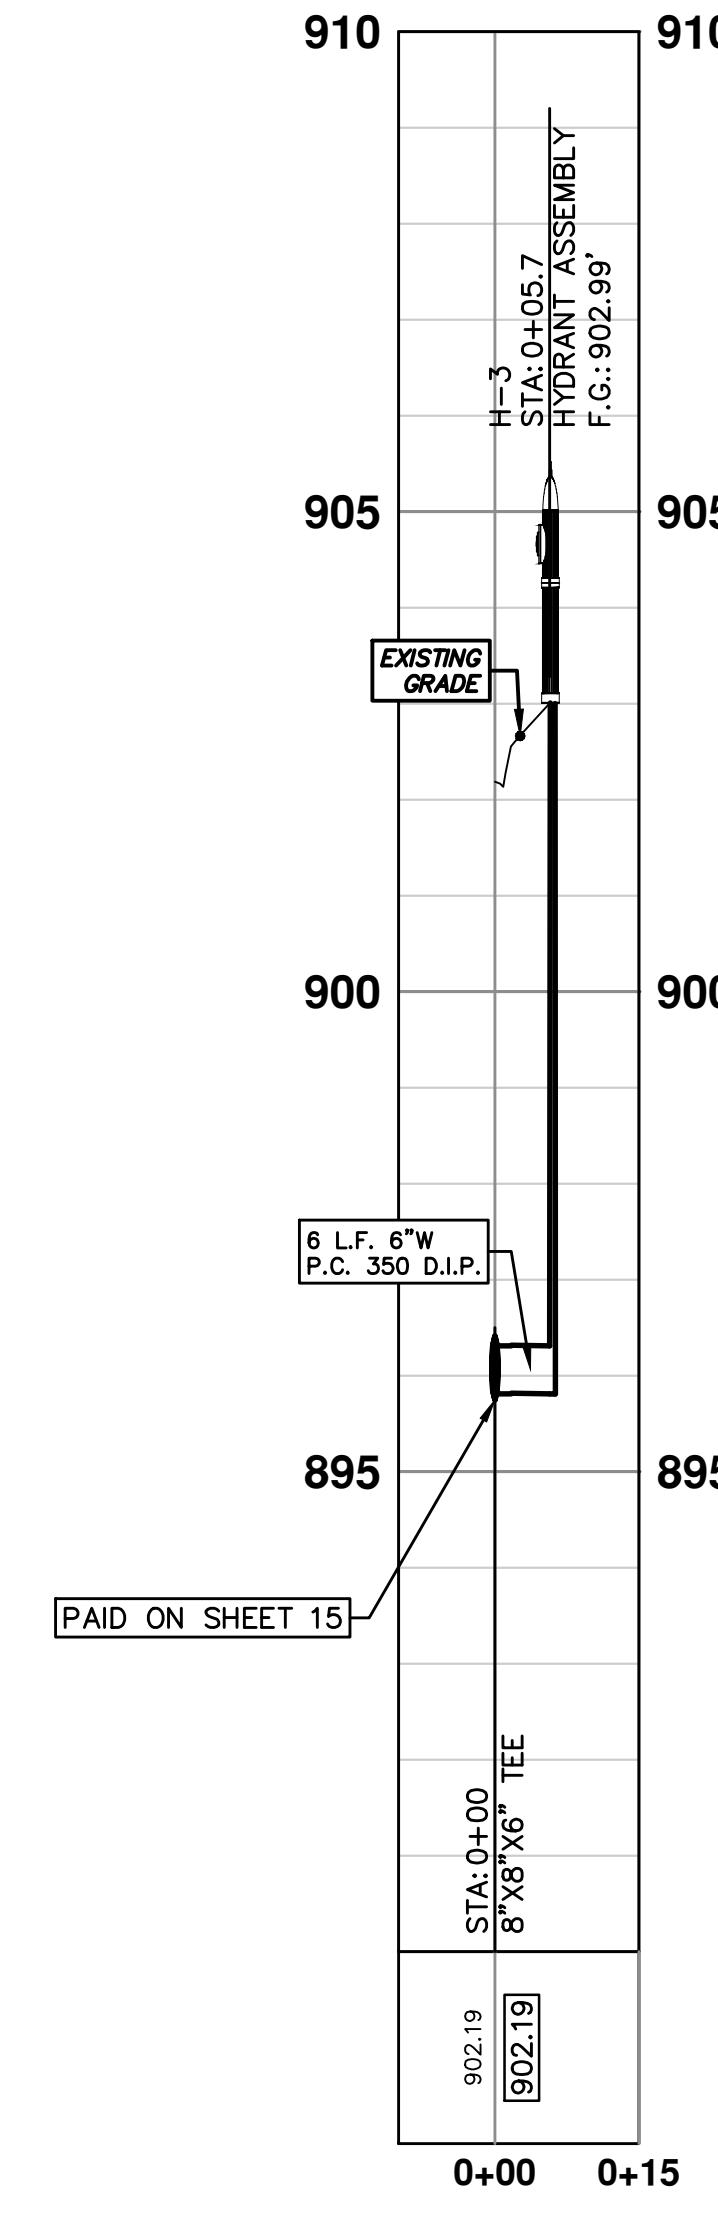

**WATER MAIN STRUCTURE TABLE**





STRUCTURE	TYPE	STATION	ALIGNMENT	FG	DEPTH
H-1	HYDRANT ASSEMBLY	3+64	Pr Water Redeemer S	930.11	6.84
H-2	HYDRANT ASSEMBLY	0+52	Pr Water Redeemer S	909.66	8.99
H-3	HYDRANT ASSEMBLY	8+74	Pr Water Russell-Hewett Loop	902.99	9.18

**PROJECT MANAGEMENT - PUBLIC SERVICES - CITY OF ANN ARBOR**  
**HEWETT DR, RUSSELL RD, RUSSETT RD & REDEEMER AVE WATER MAIN REPLACEMENT**  
WATER MAIN PLAN & PROFILE  
HYDRANT LEADS H1-H3

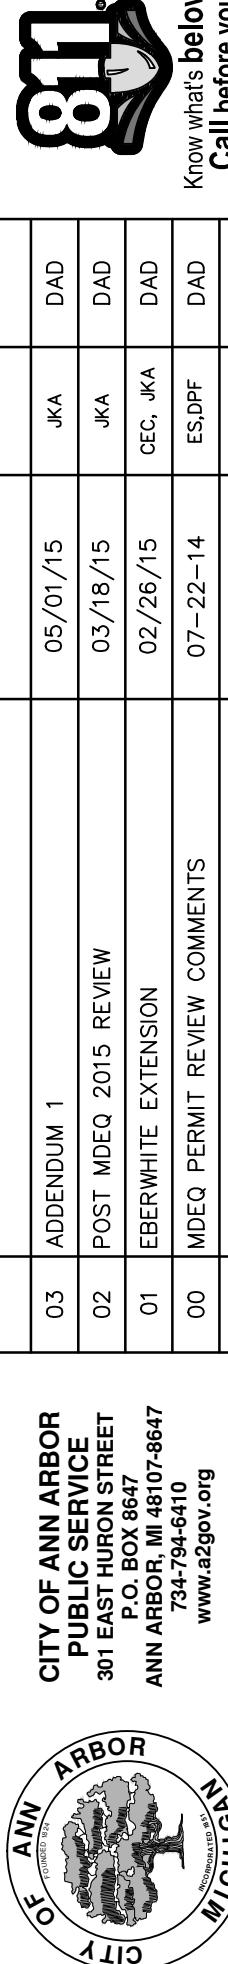


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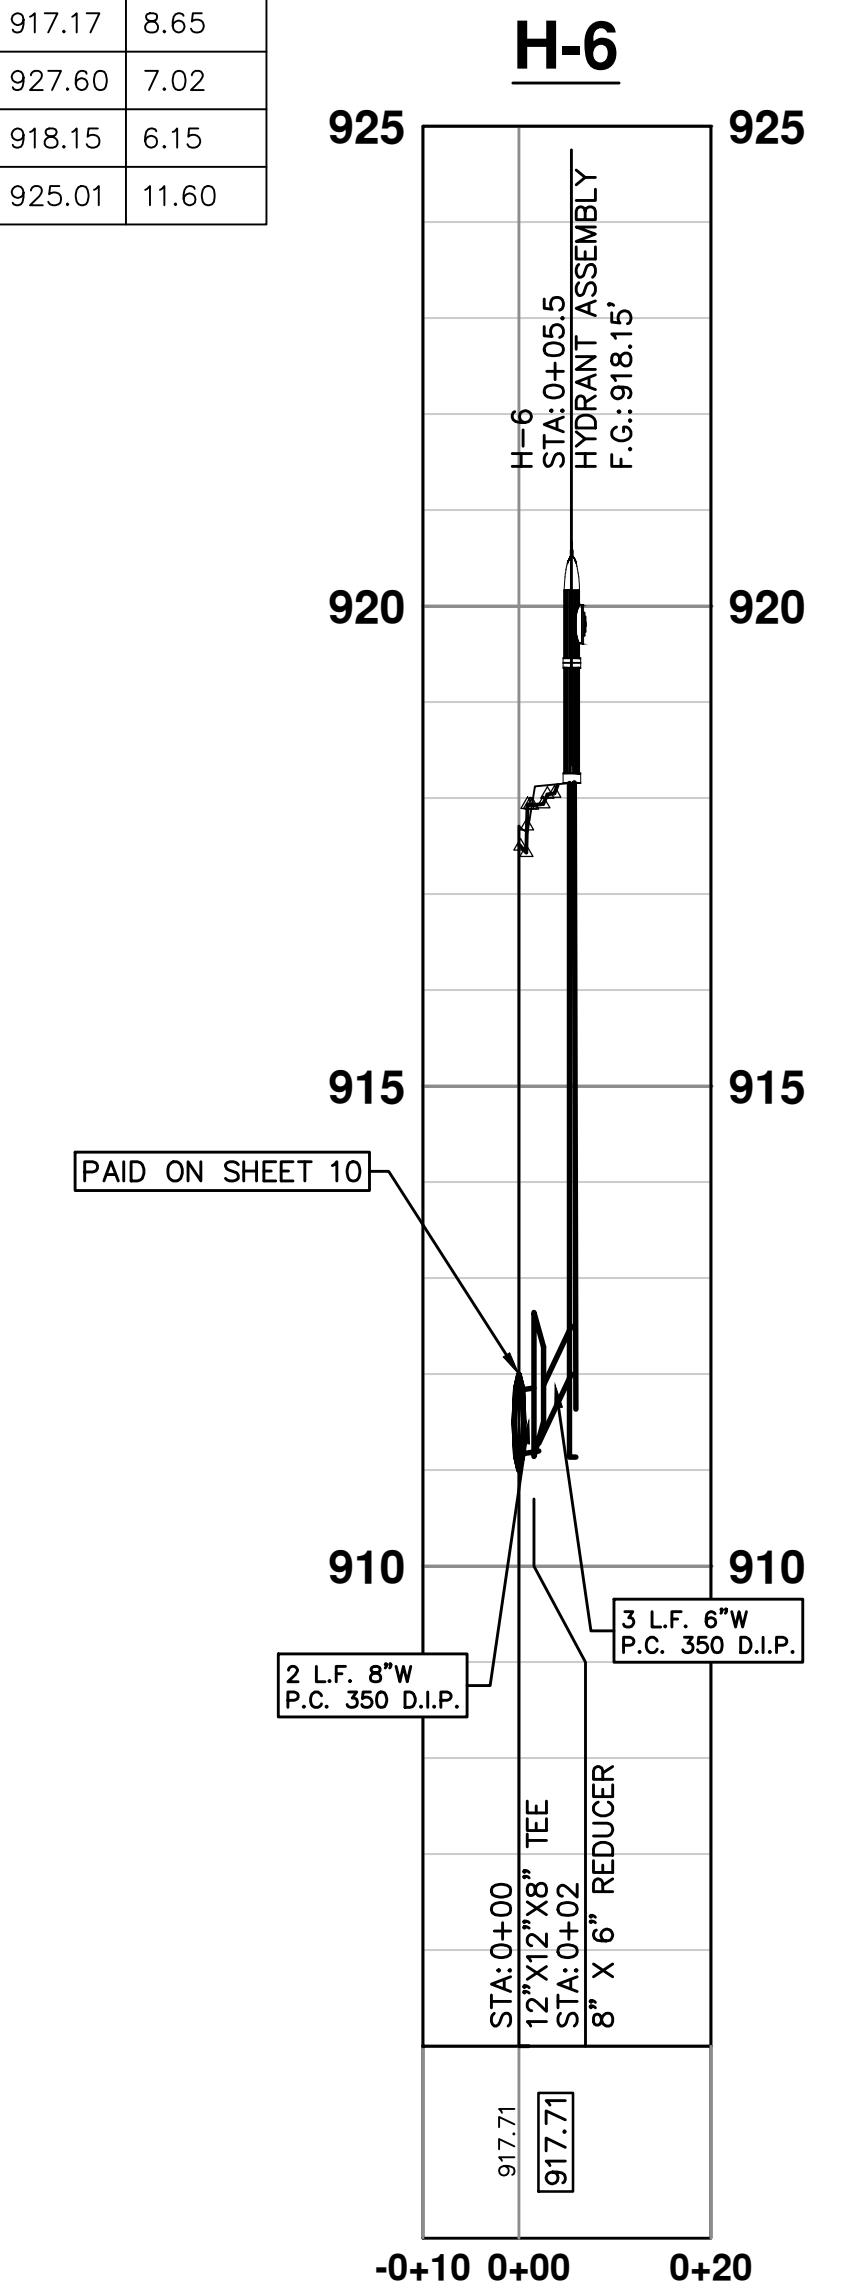
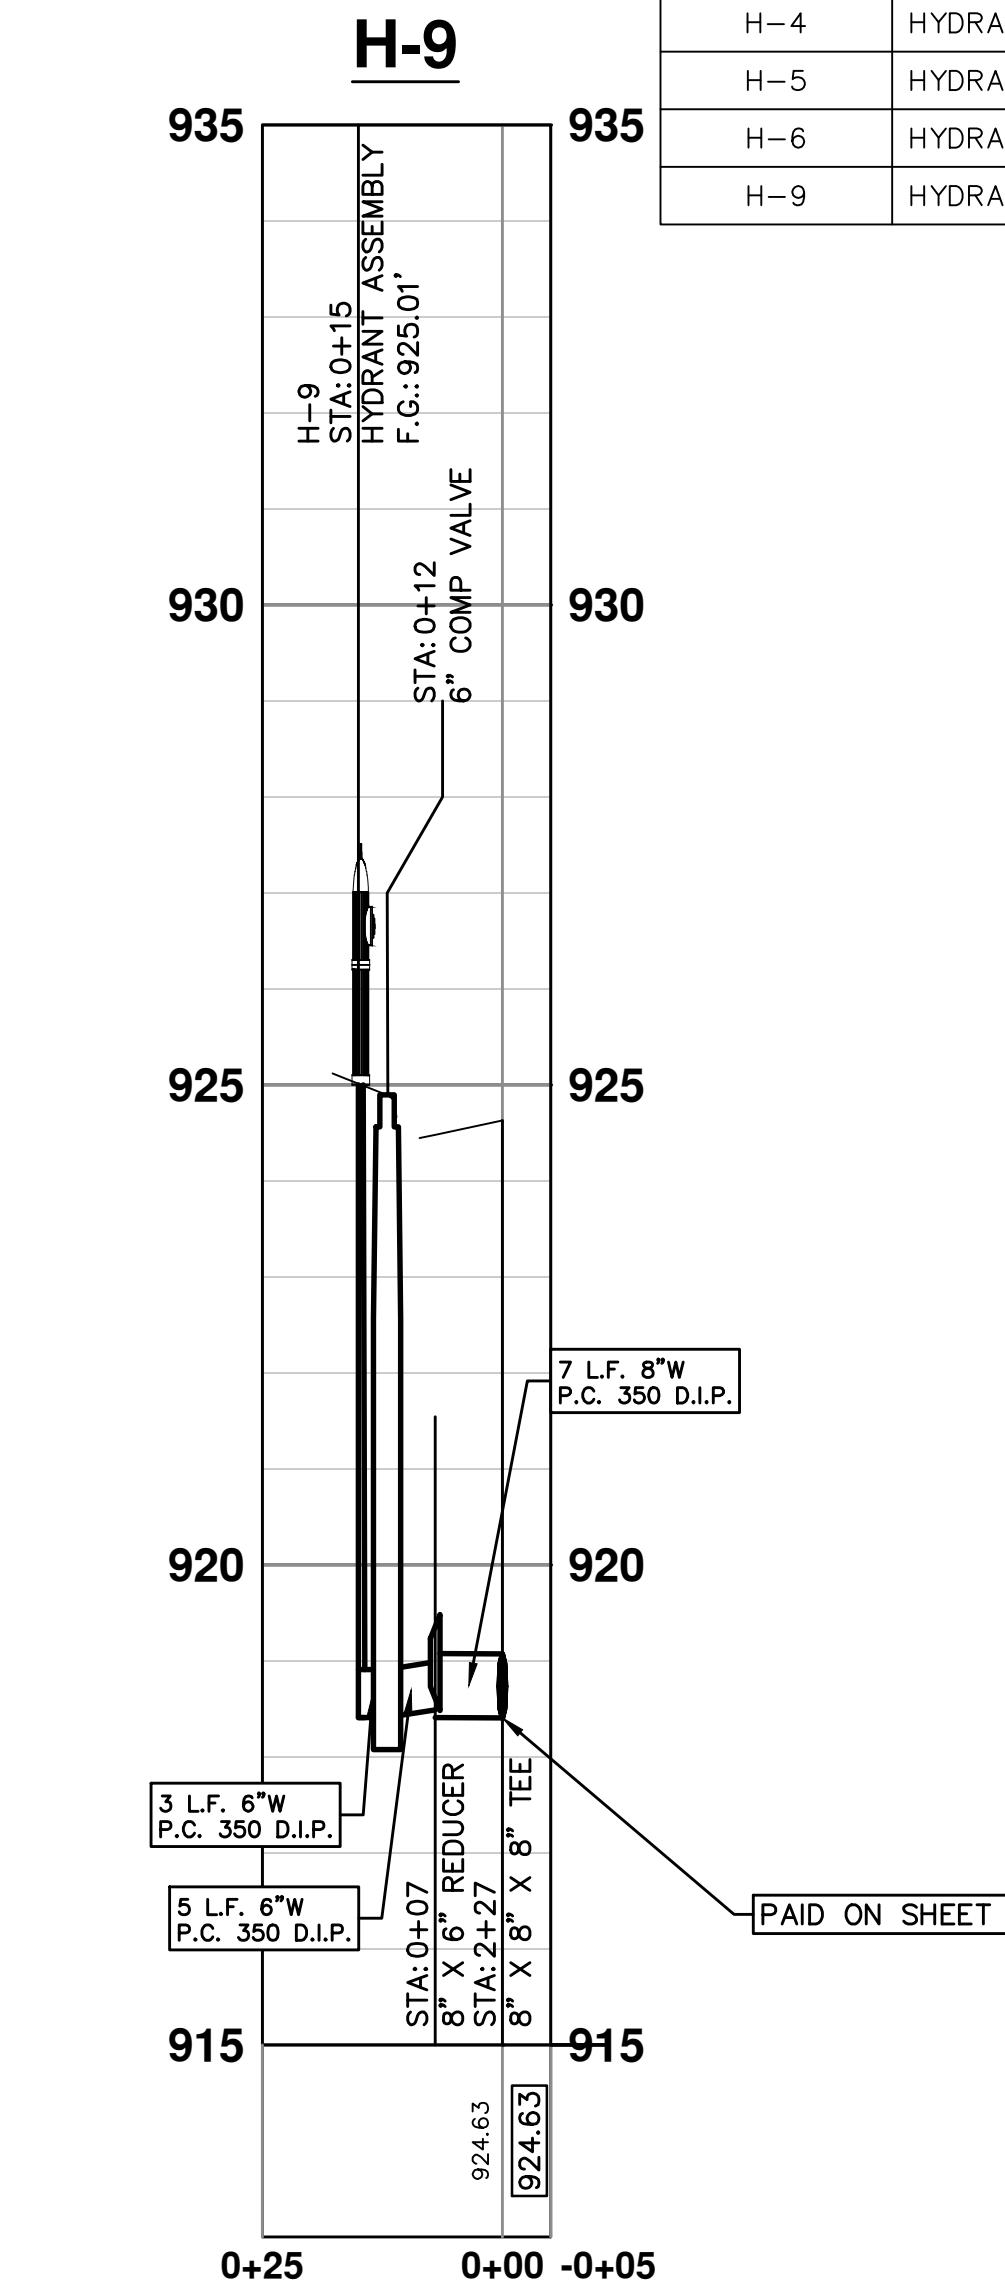
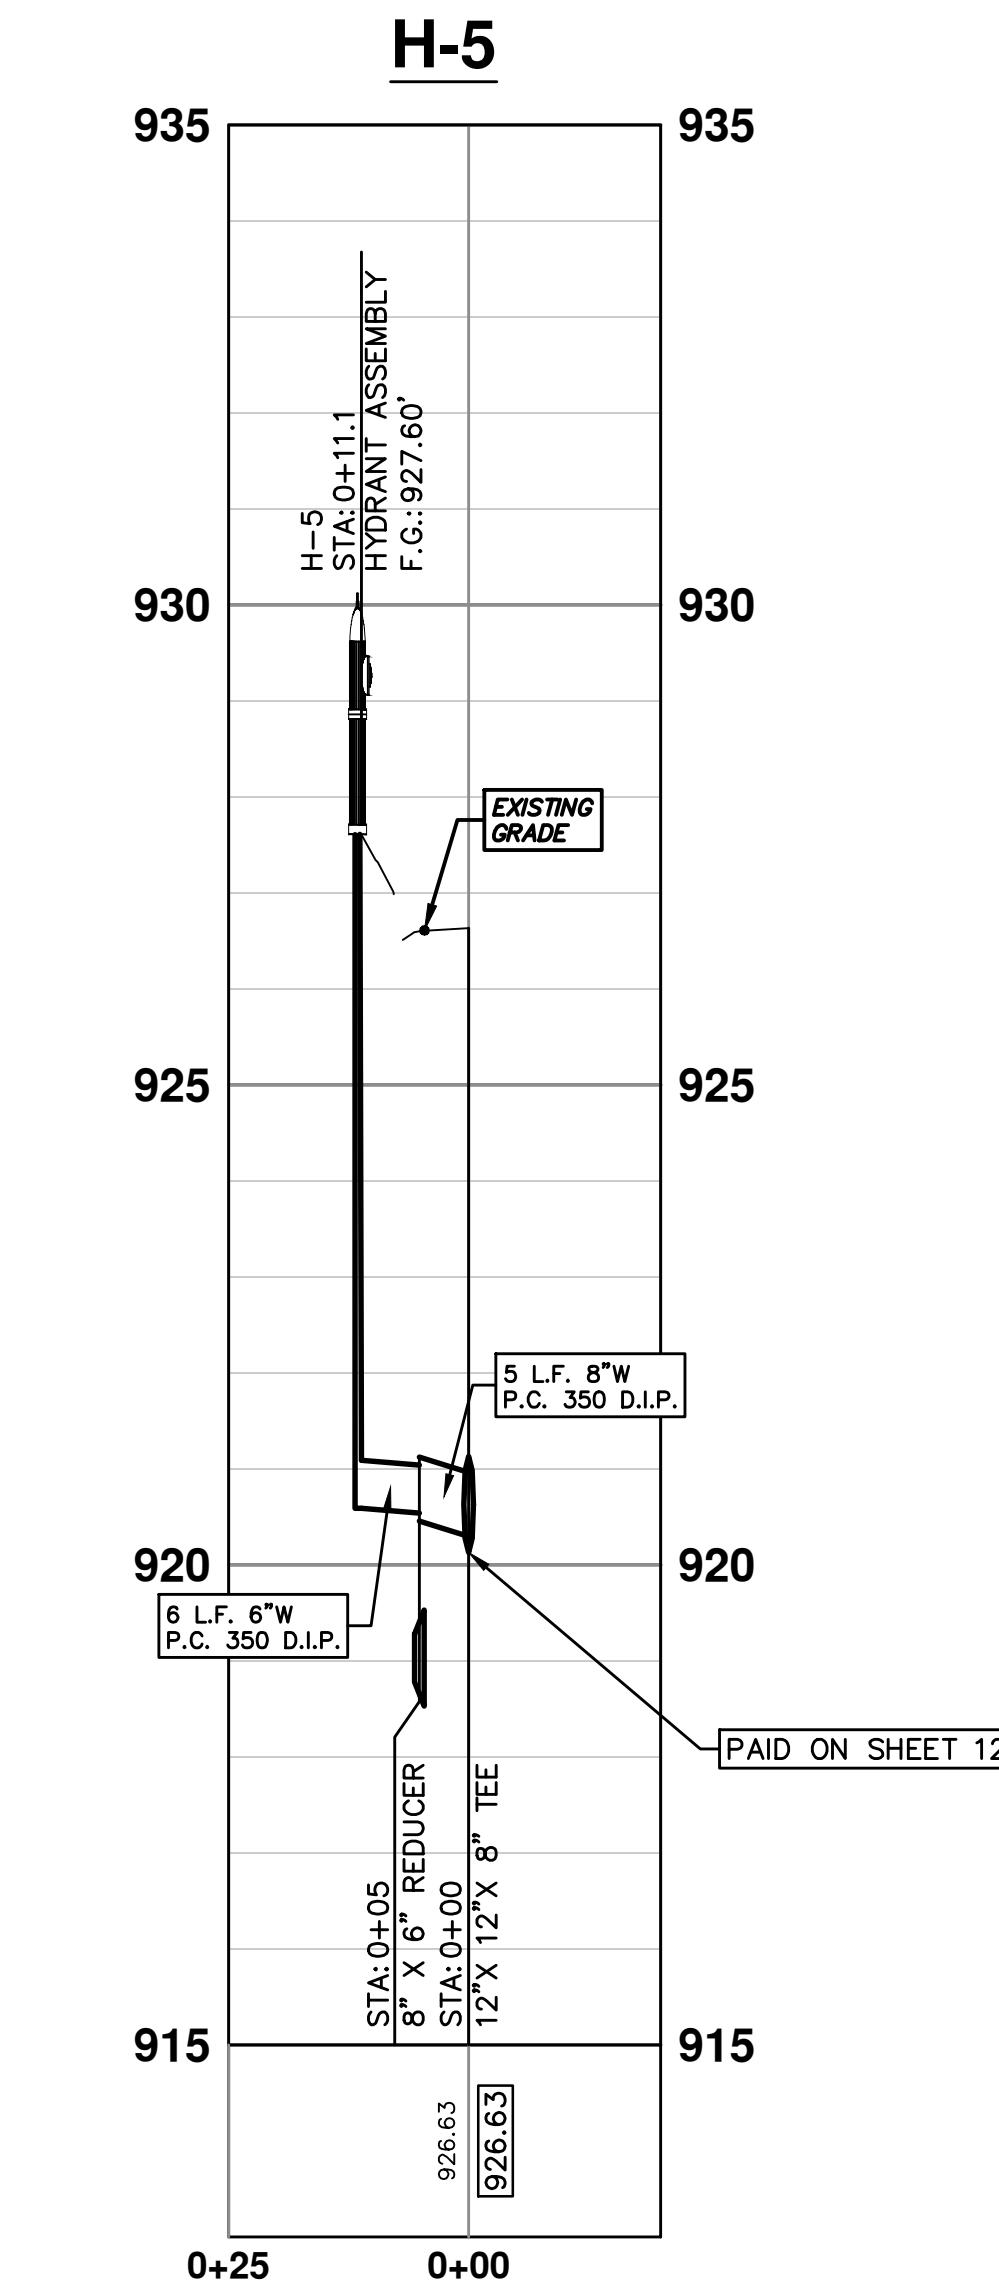
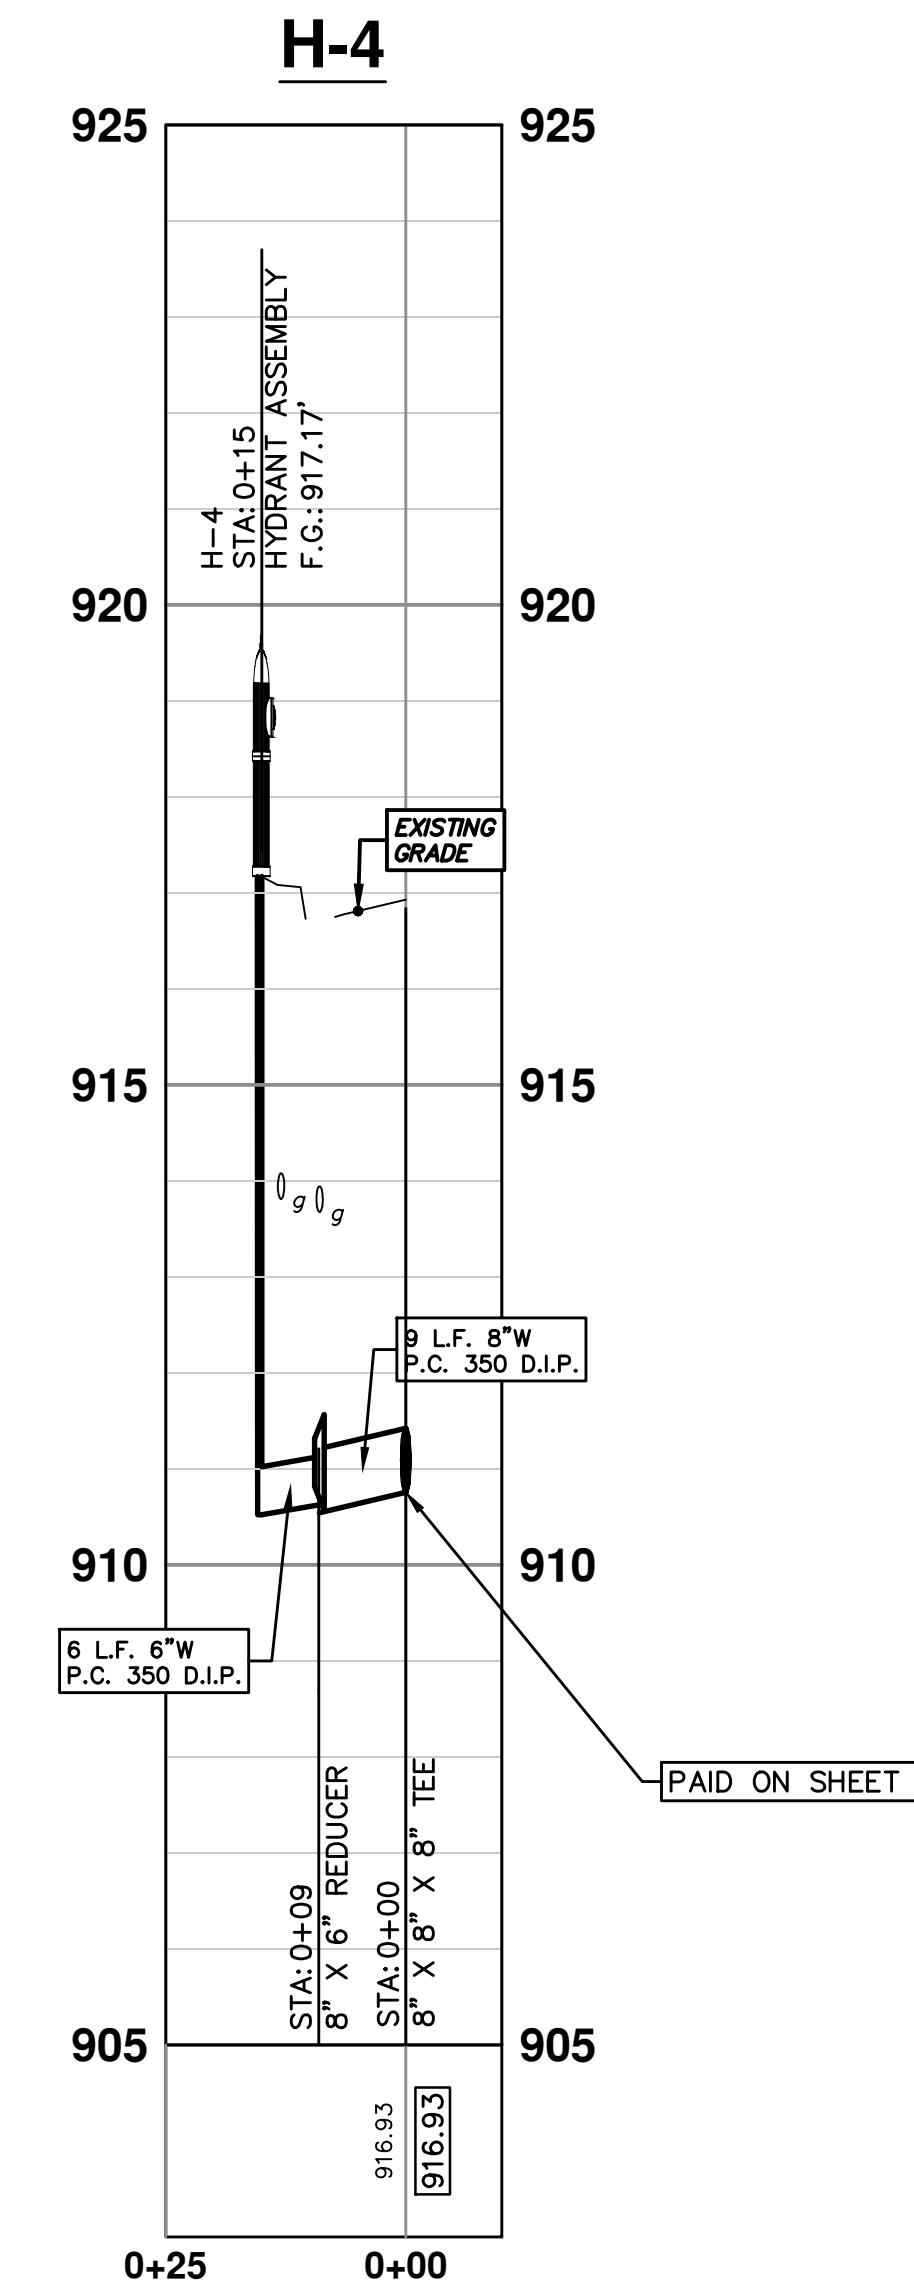
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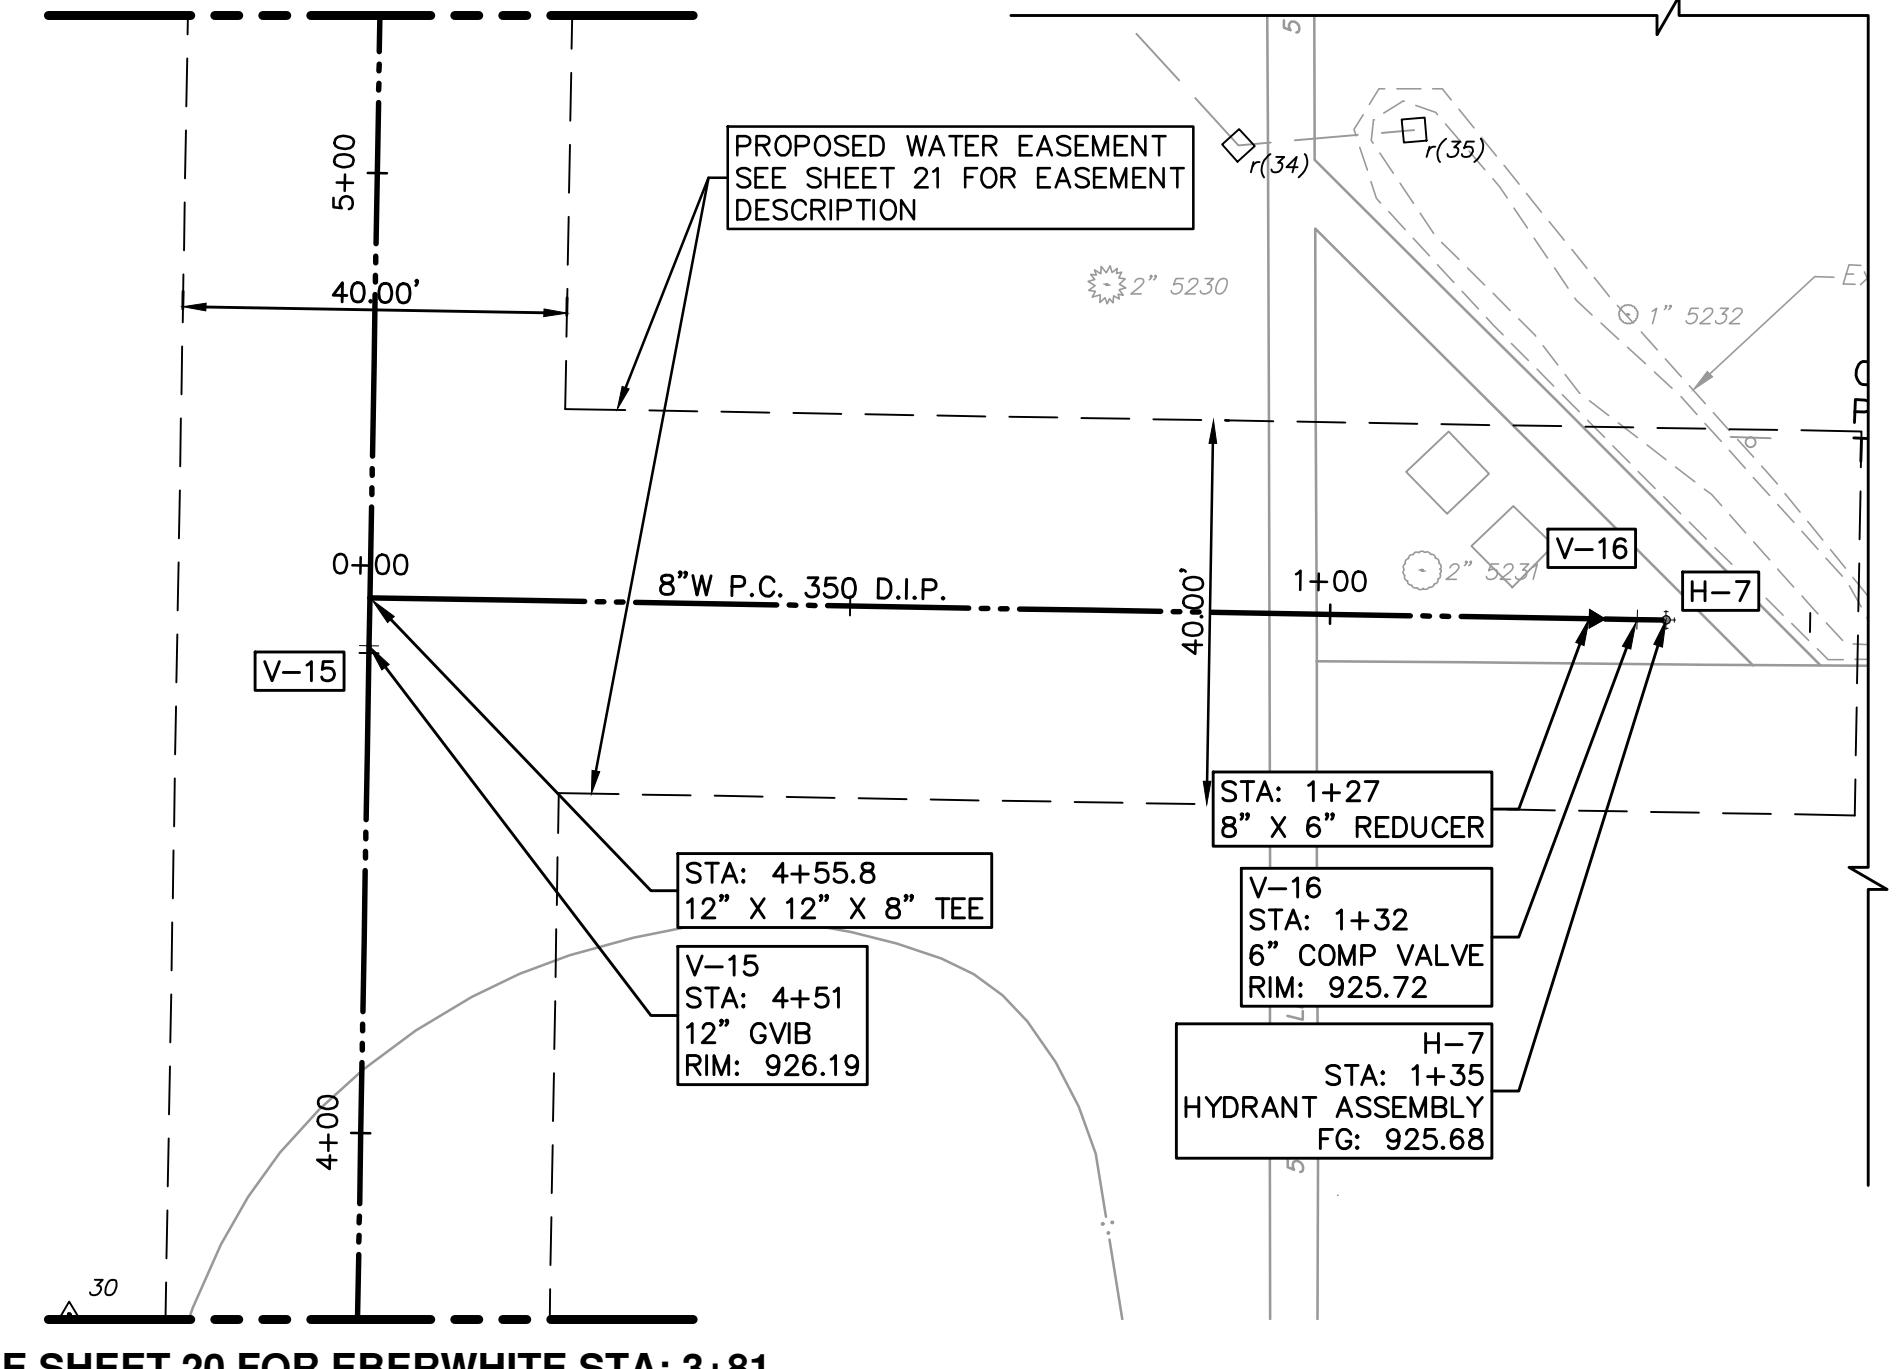
PROJECT MANAGEMENT - PUBLIC SERVICES - CITY OF ANN ARBOR					
<b>HEWETT DR, RUSSETT RD &amp; REDEEMER AVE WATER MAIN REPLACEMENT</b>					WATER MAIN PLAN & PROFILE E
SCALE PLAN: 1" = 20'	PROFILE: 1" = 4"				
DRAWING No.					
2013034-24					
CITY OF ANN ARBOR PUBLIC SERVICE 301 EAST FIFTH STREET ANN ARBOR MI 48103-3647 www.a2gov.org	03 ADENDUM 1	05/01/15	JKA	DAD	
	02 POST MODE 2015 REVIEW	05/08/15	JKA	DAD	
	01 EBWHITE EXTENSION	02/26/15	CEC	A&A	
	00 MDQ PERMIT REVIEW COMMENTS	07-22-14	ES.DPF	DAD	
REV.	DESCRIPTION	DATE	DRAWN	CHECKED	

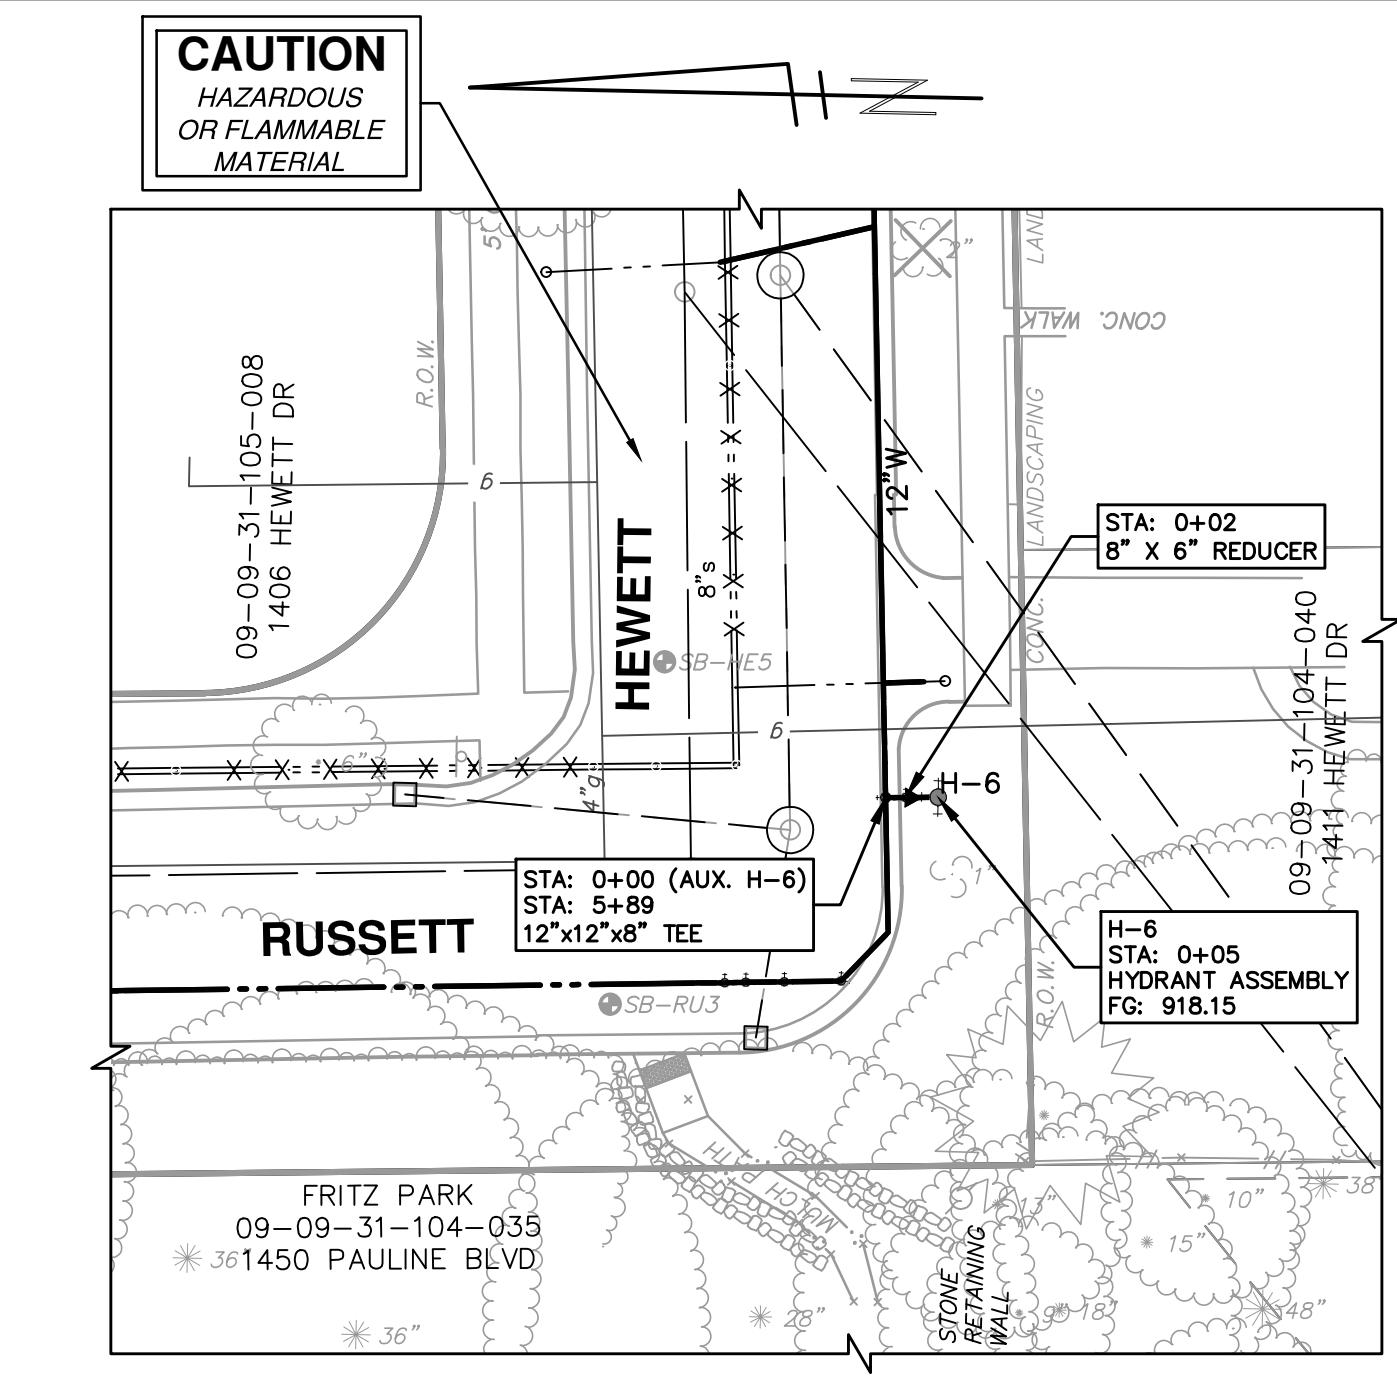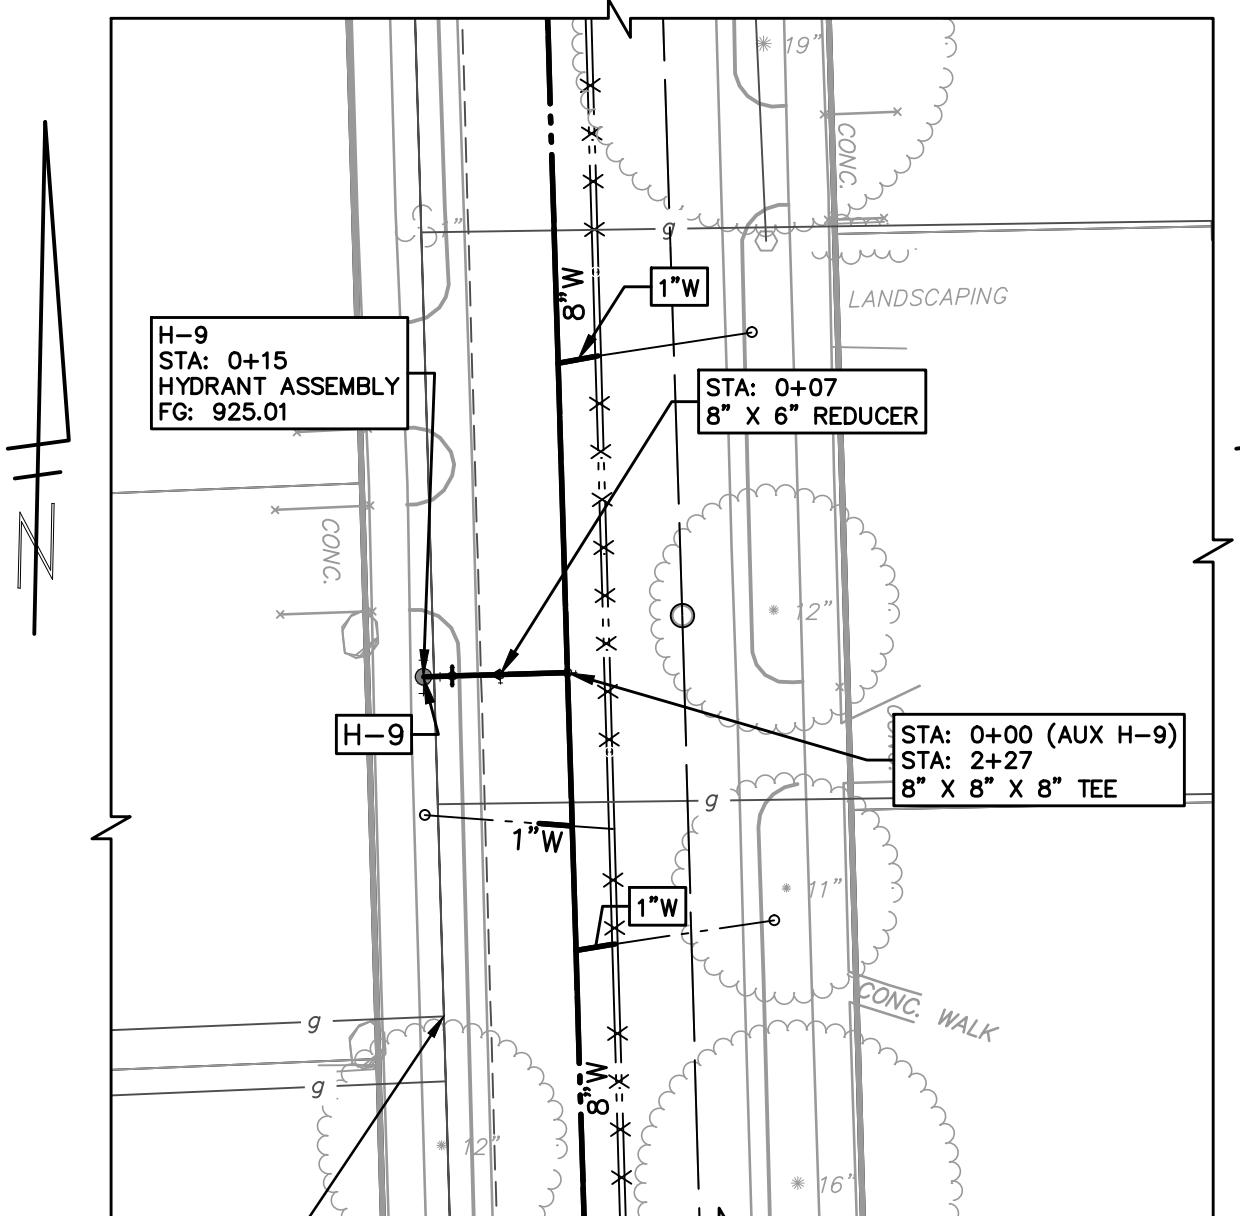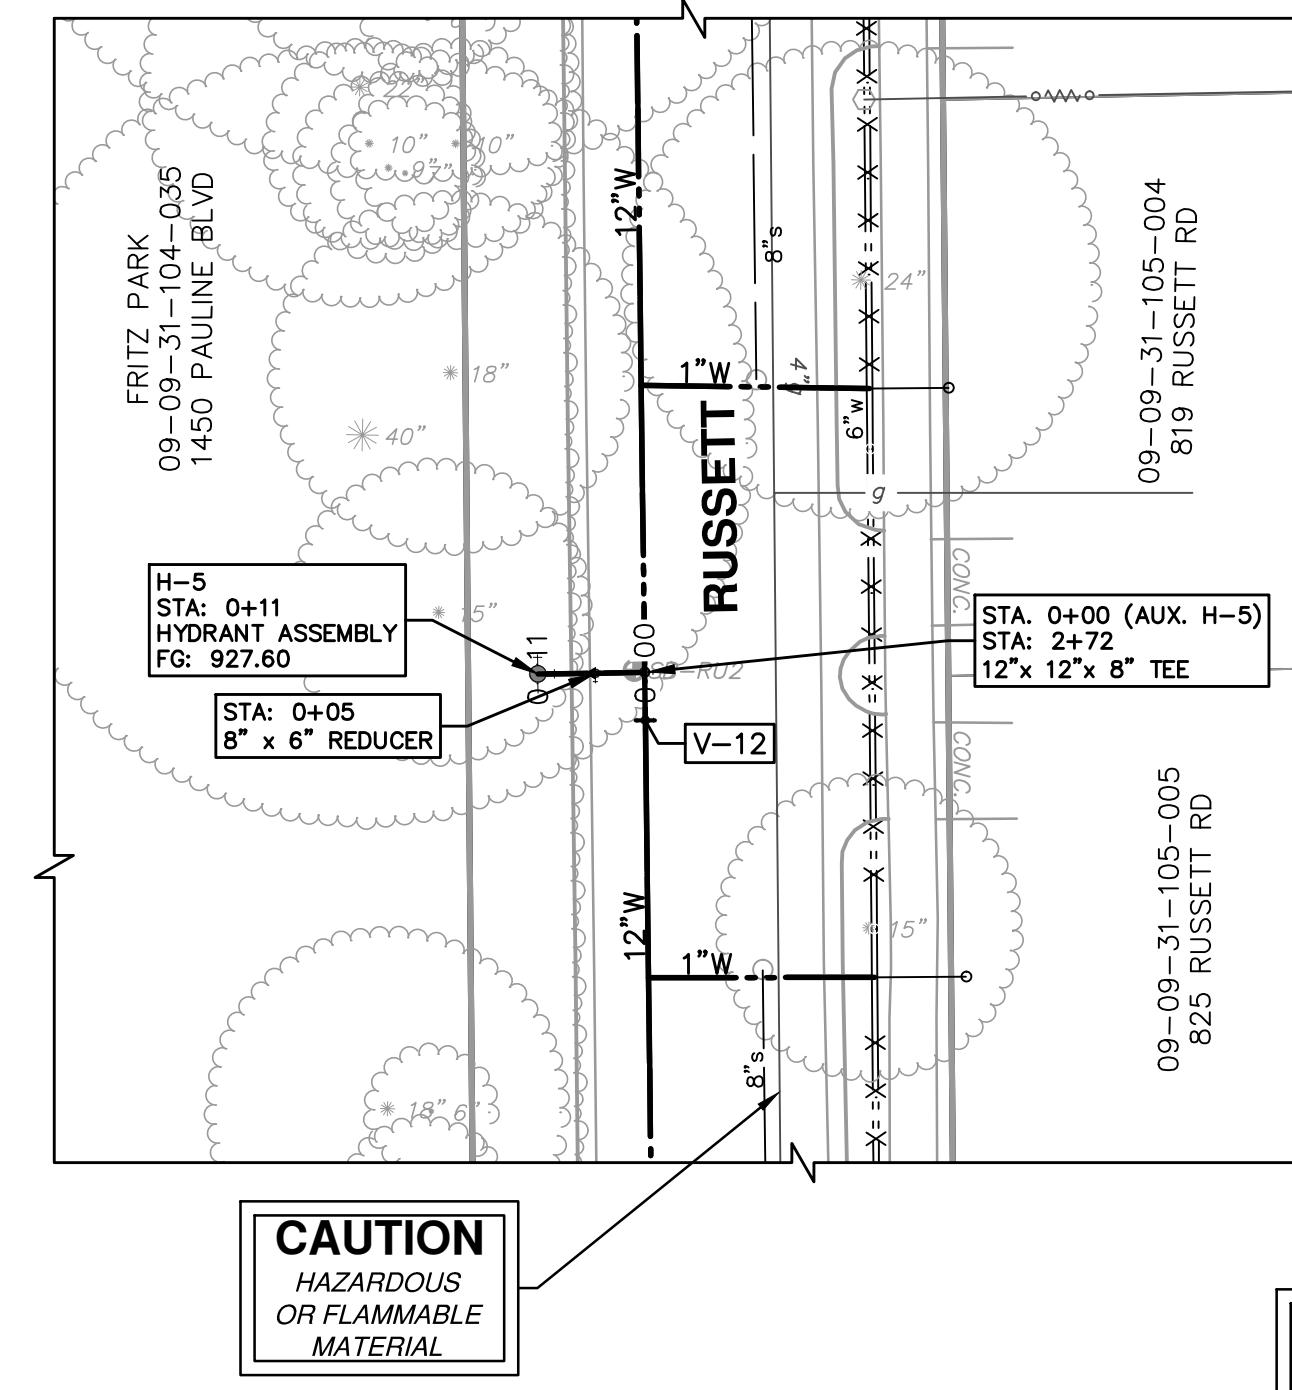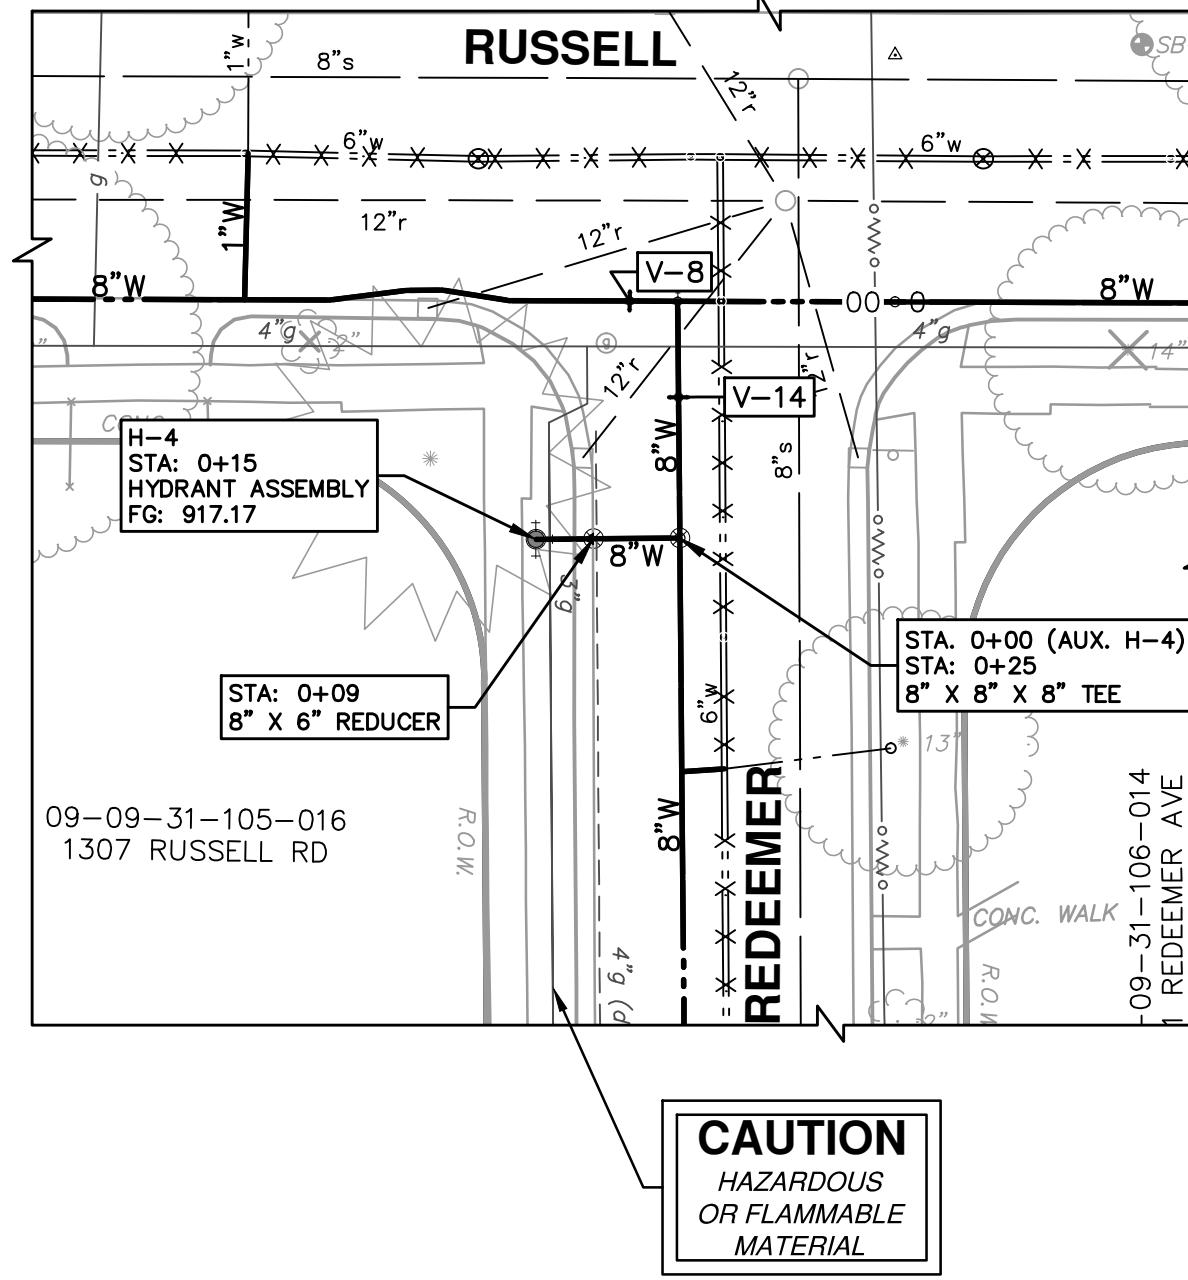

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SEE SHEET 21 FOR EBERWHITE STA: 5+16

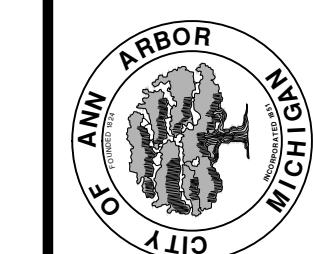


SEE SHEET 20 FOR EBERWHITE STA: 3+81


WATER MAIN STRUCTURE TABLE					
STRUCTURE	TYPE	STATION	ALIGNMENT	RIM	DEPTH
V-16	6" COMP VALVE	1+32	Eberwhite-Aux A	925.72	5.92
H-7	HYDRANT ASSEMBLY	1+35	Eberwhite-Aux A	925.68	7.88
V-15	12" GVIB	4+51	Eberwhite	926.19	6.49

WATER MAIN STRUCTURE TABLE					
STRUCTURE	TYPE	STATION	ALIGNMENT	RIM	DEPTH
V-17	8" GVIB	0+05	Eberwhite-Aux B	922.73	6.14
V-18	6" COMP VALVE	1+47	Eberwhite-Aux B	921.66	5.89
H-8	HYDRANT ASSEMBLY	1+50	Eberwhite-Aux B	921.61	7.83

### EBERWHITE-AUX A

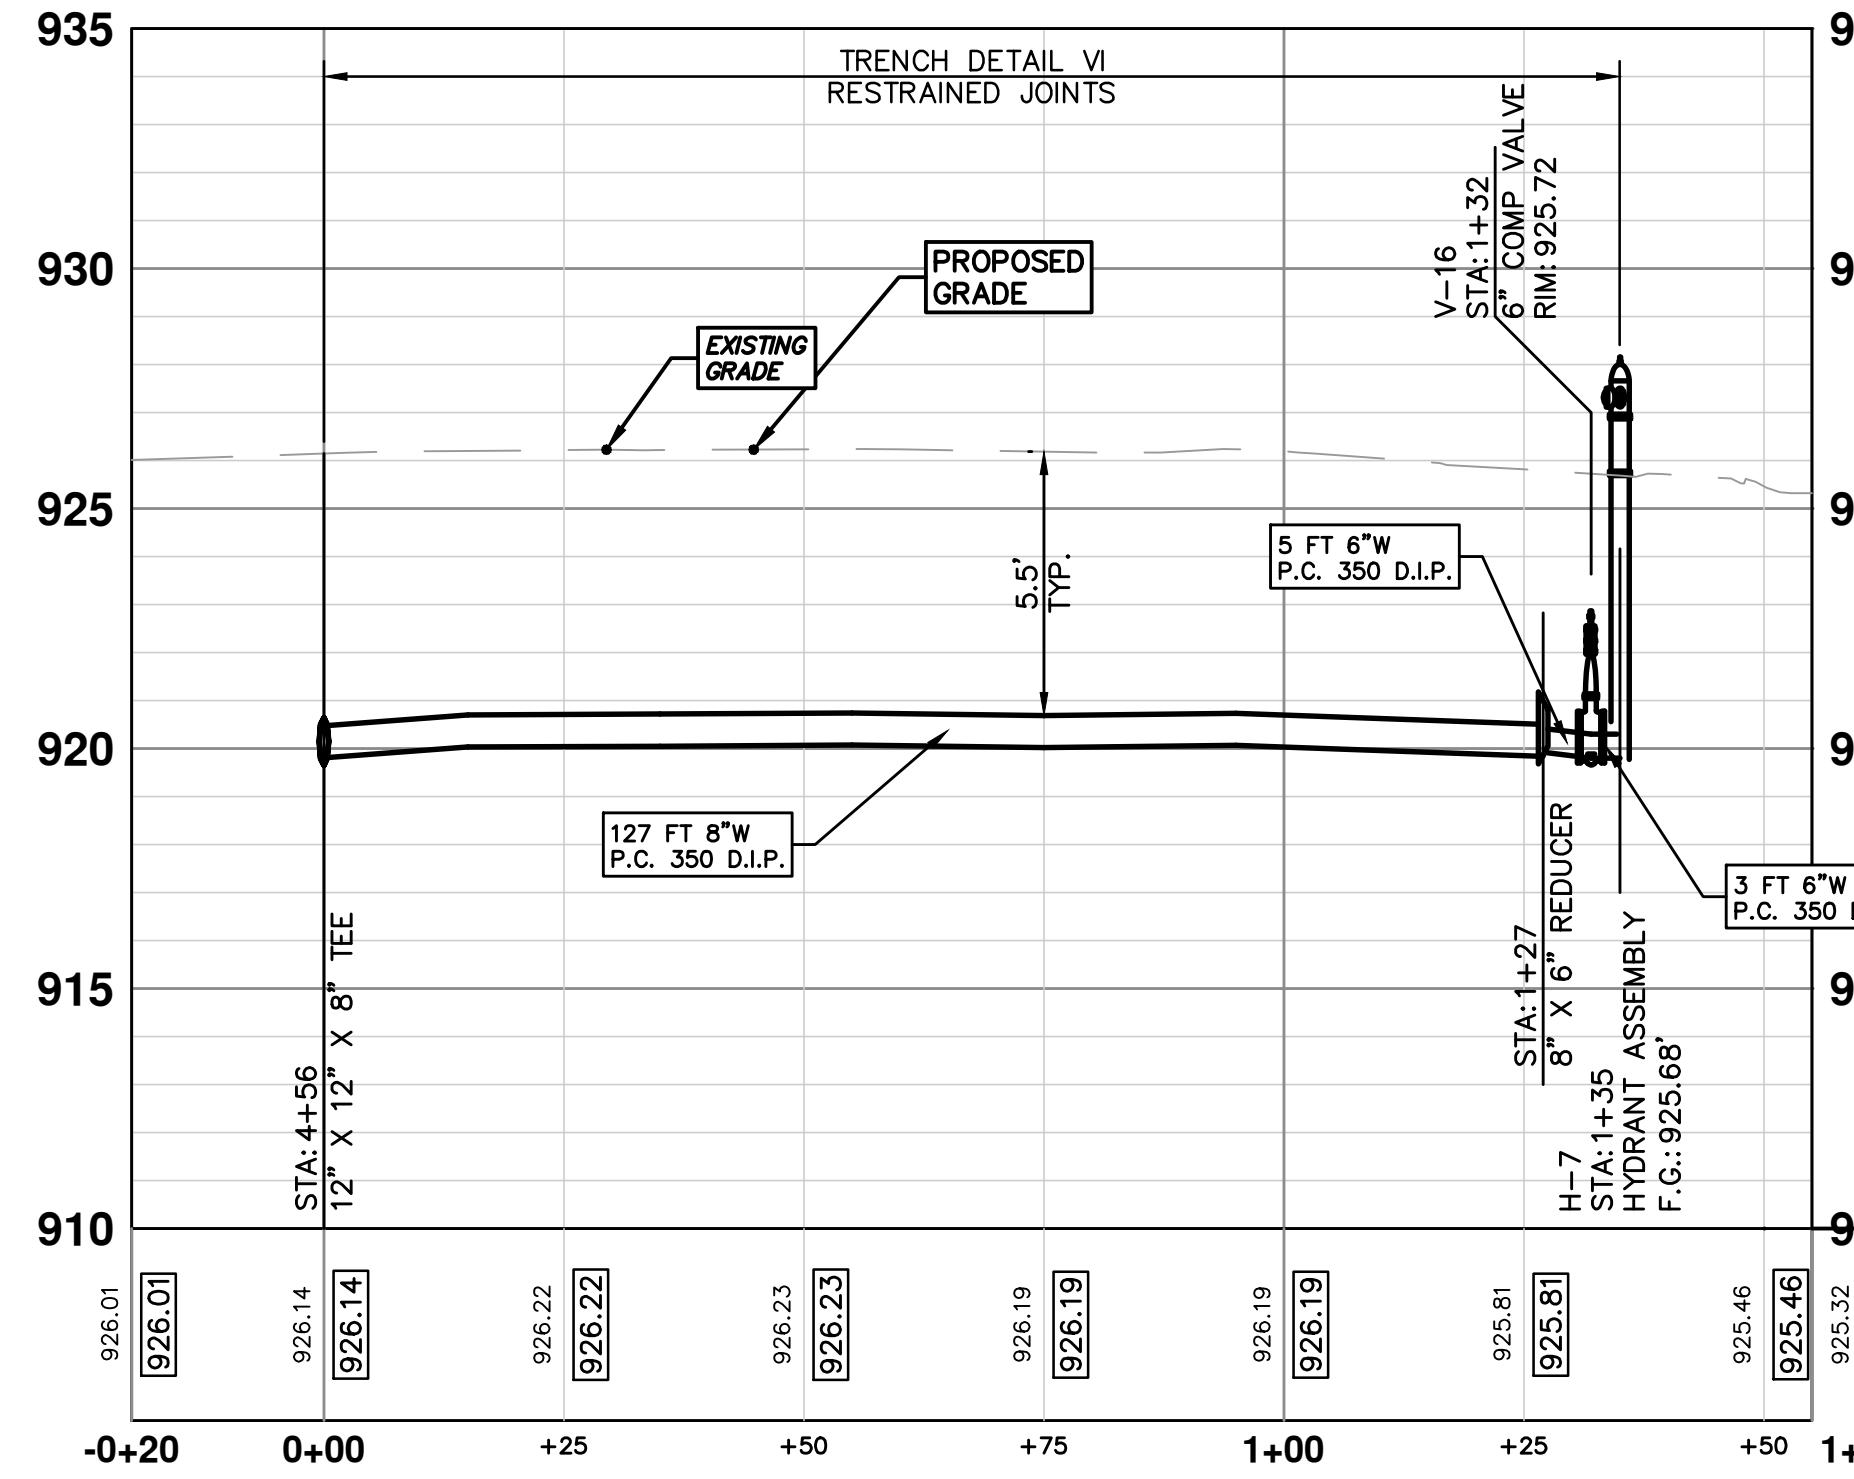


SEE SHEET 22 FOR EBERWHITE STA: 10+35

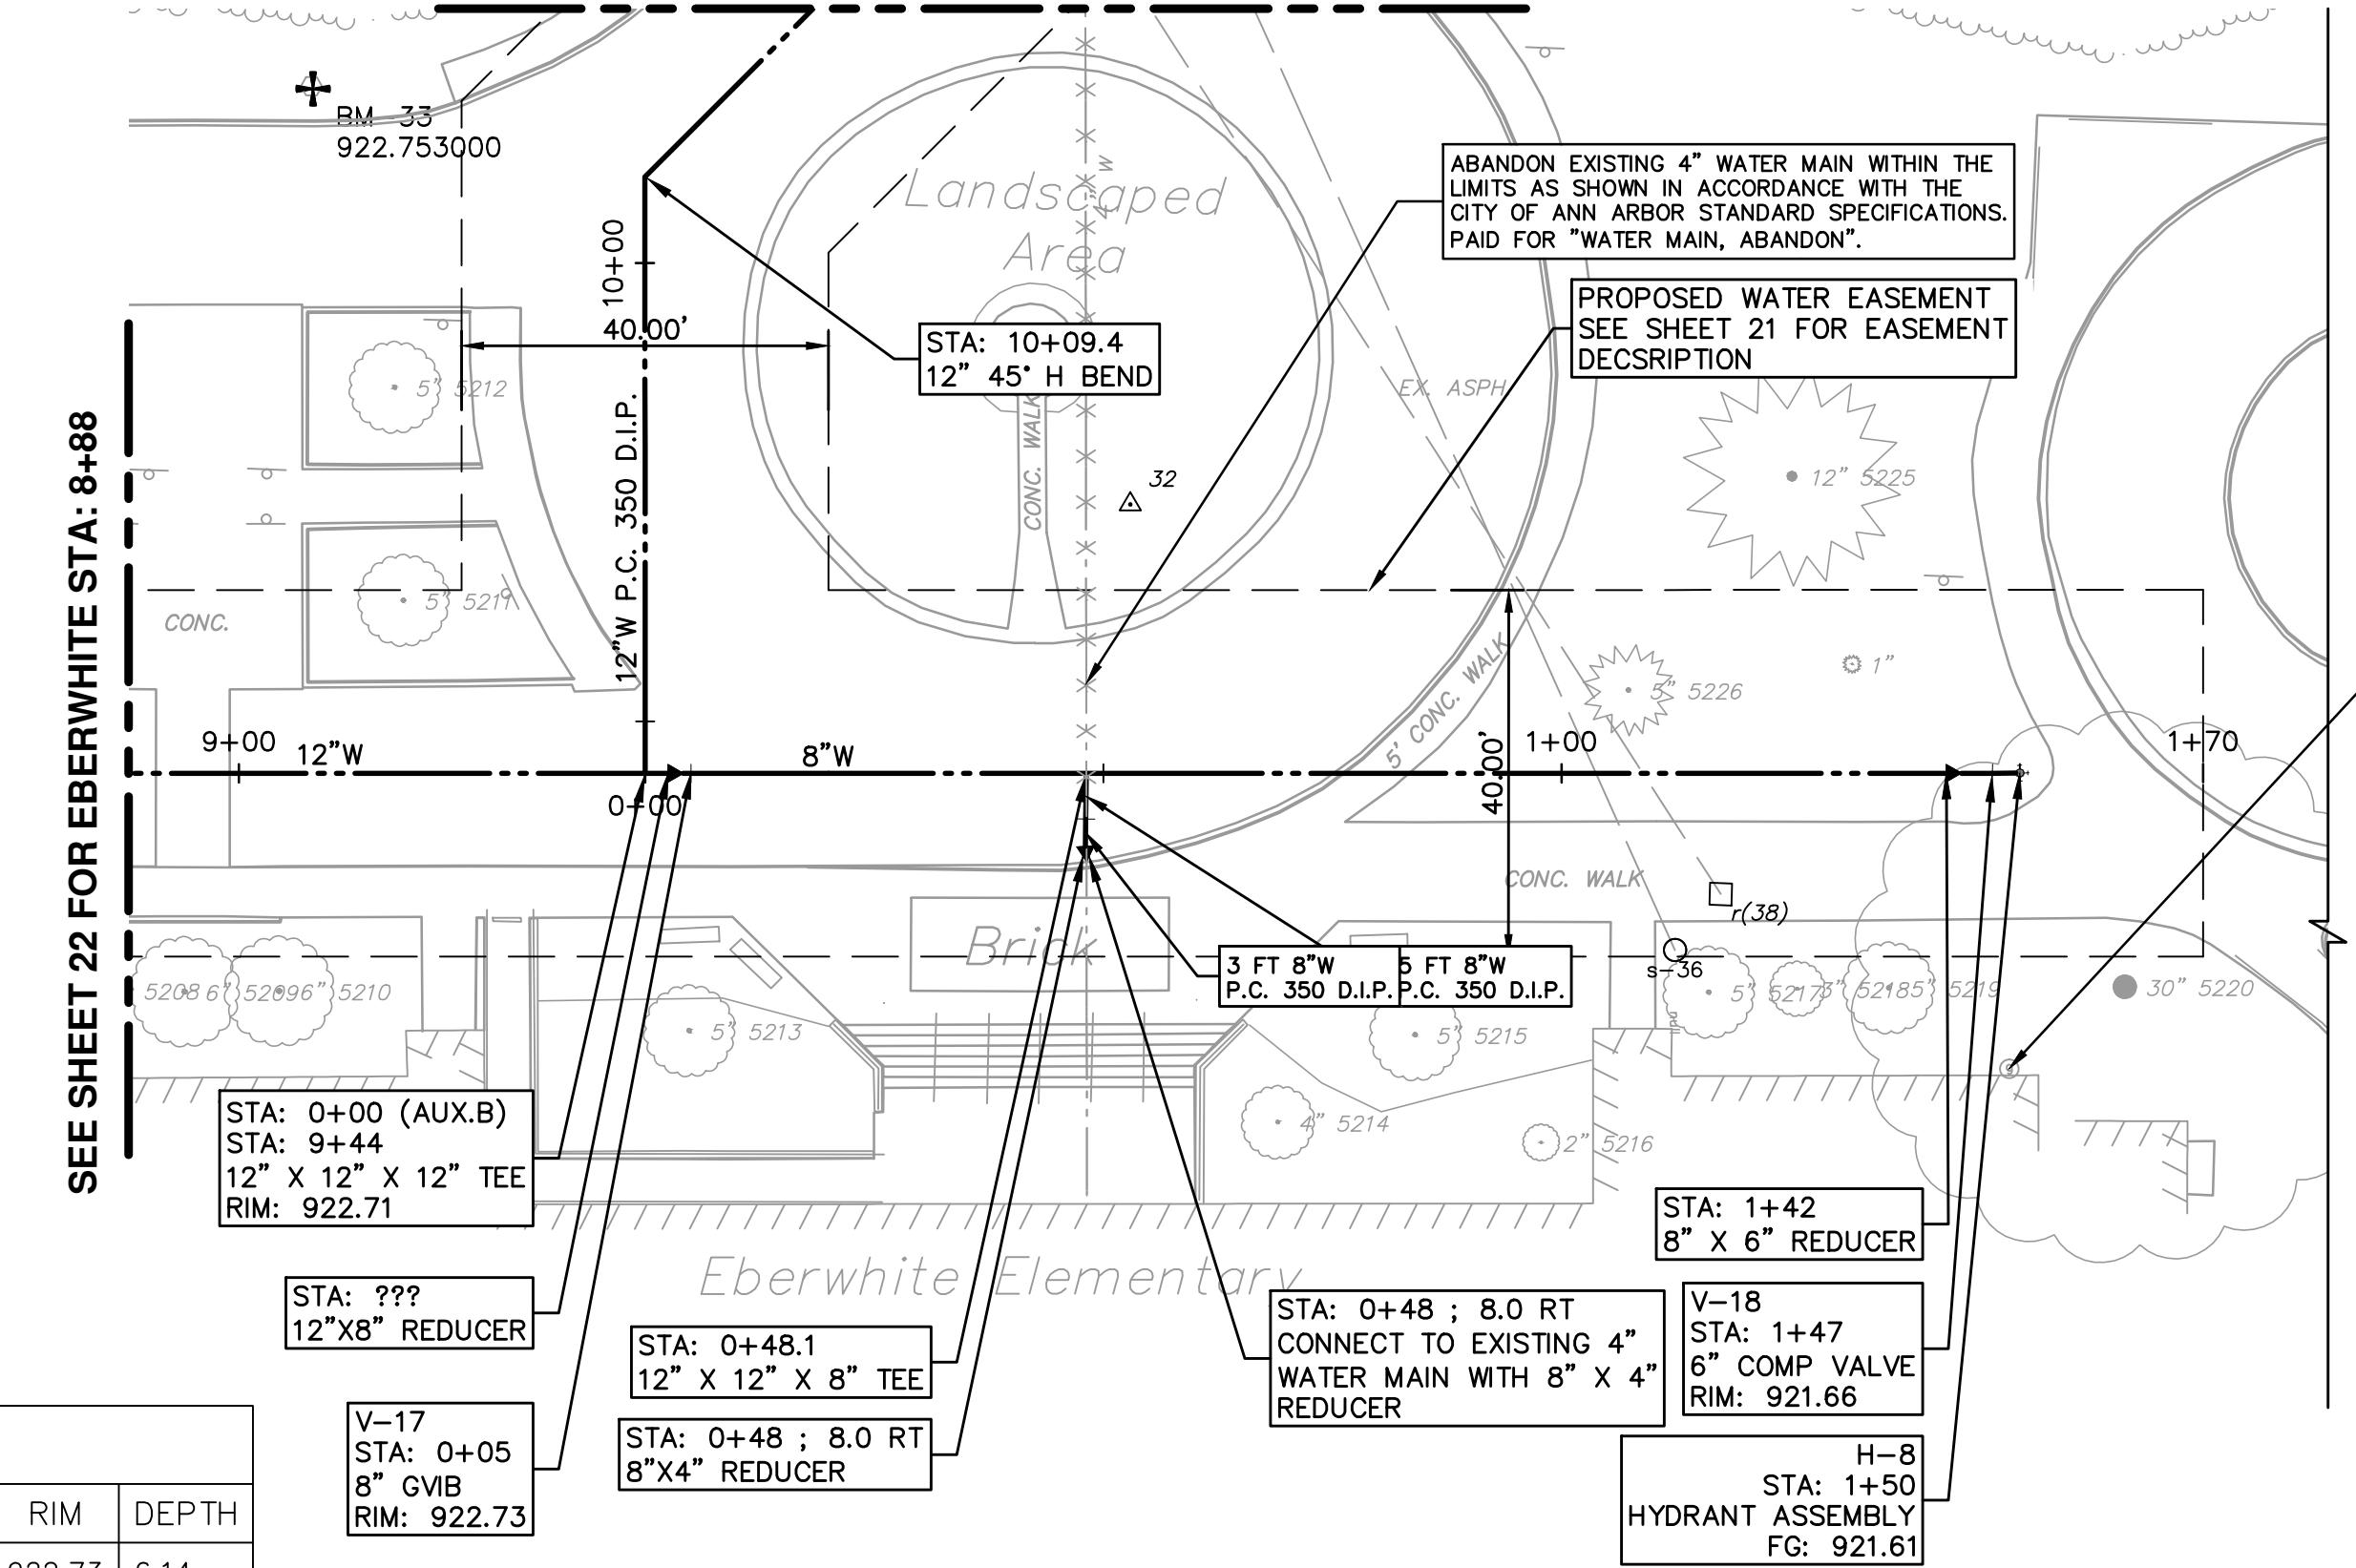


SEE SHEET 22 FOR EBERWHITE STA: 8+88



### EBERWHITE-AUX B

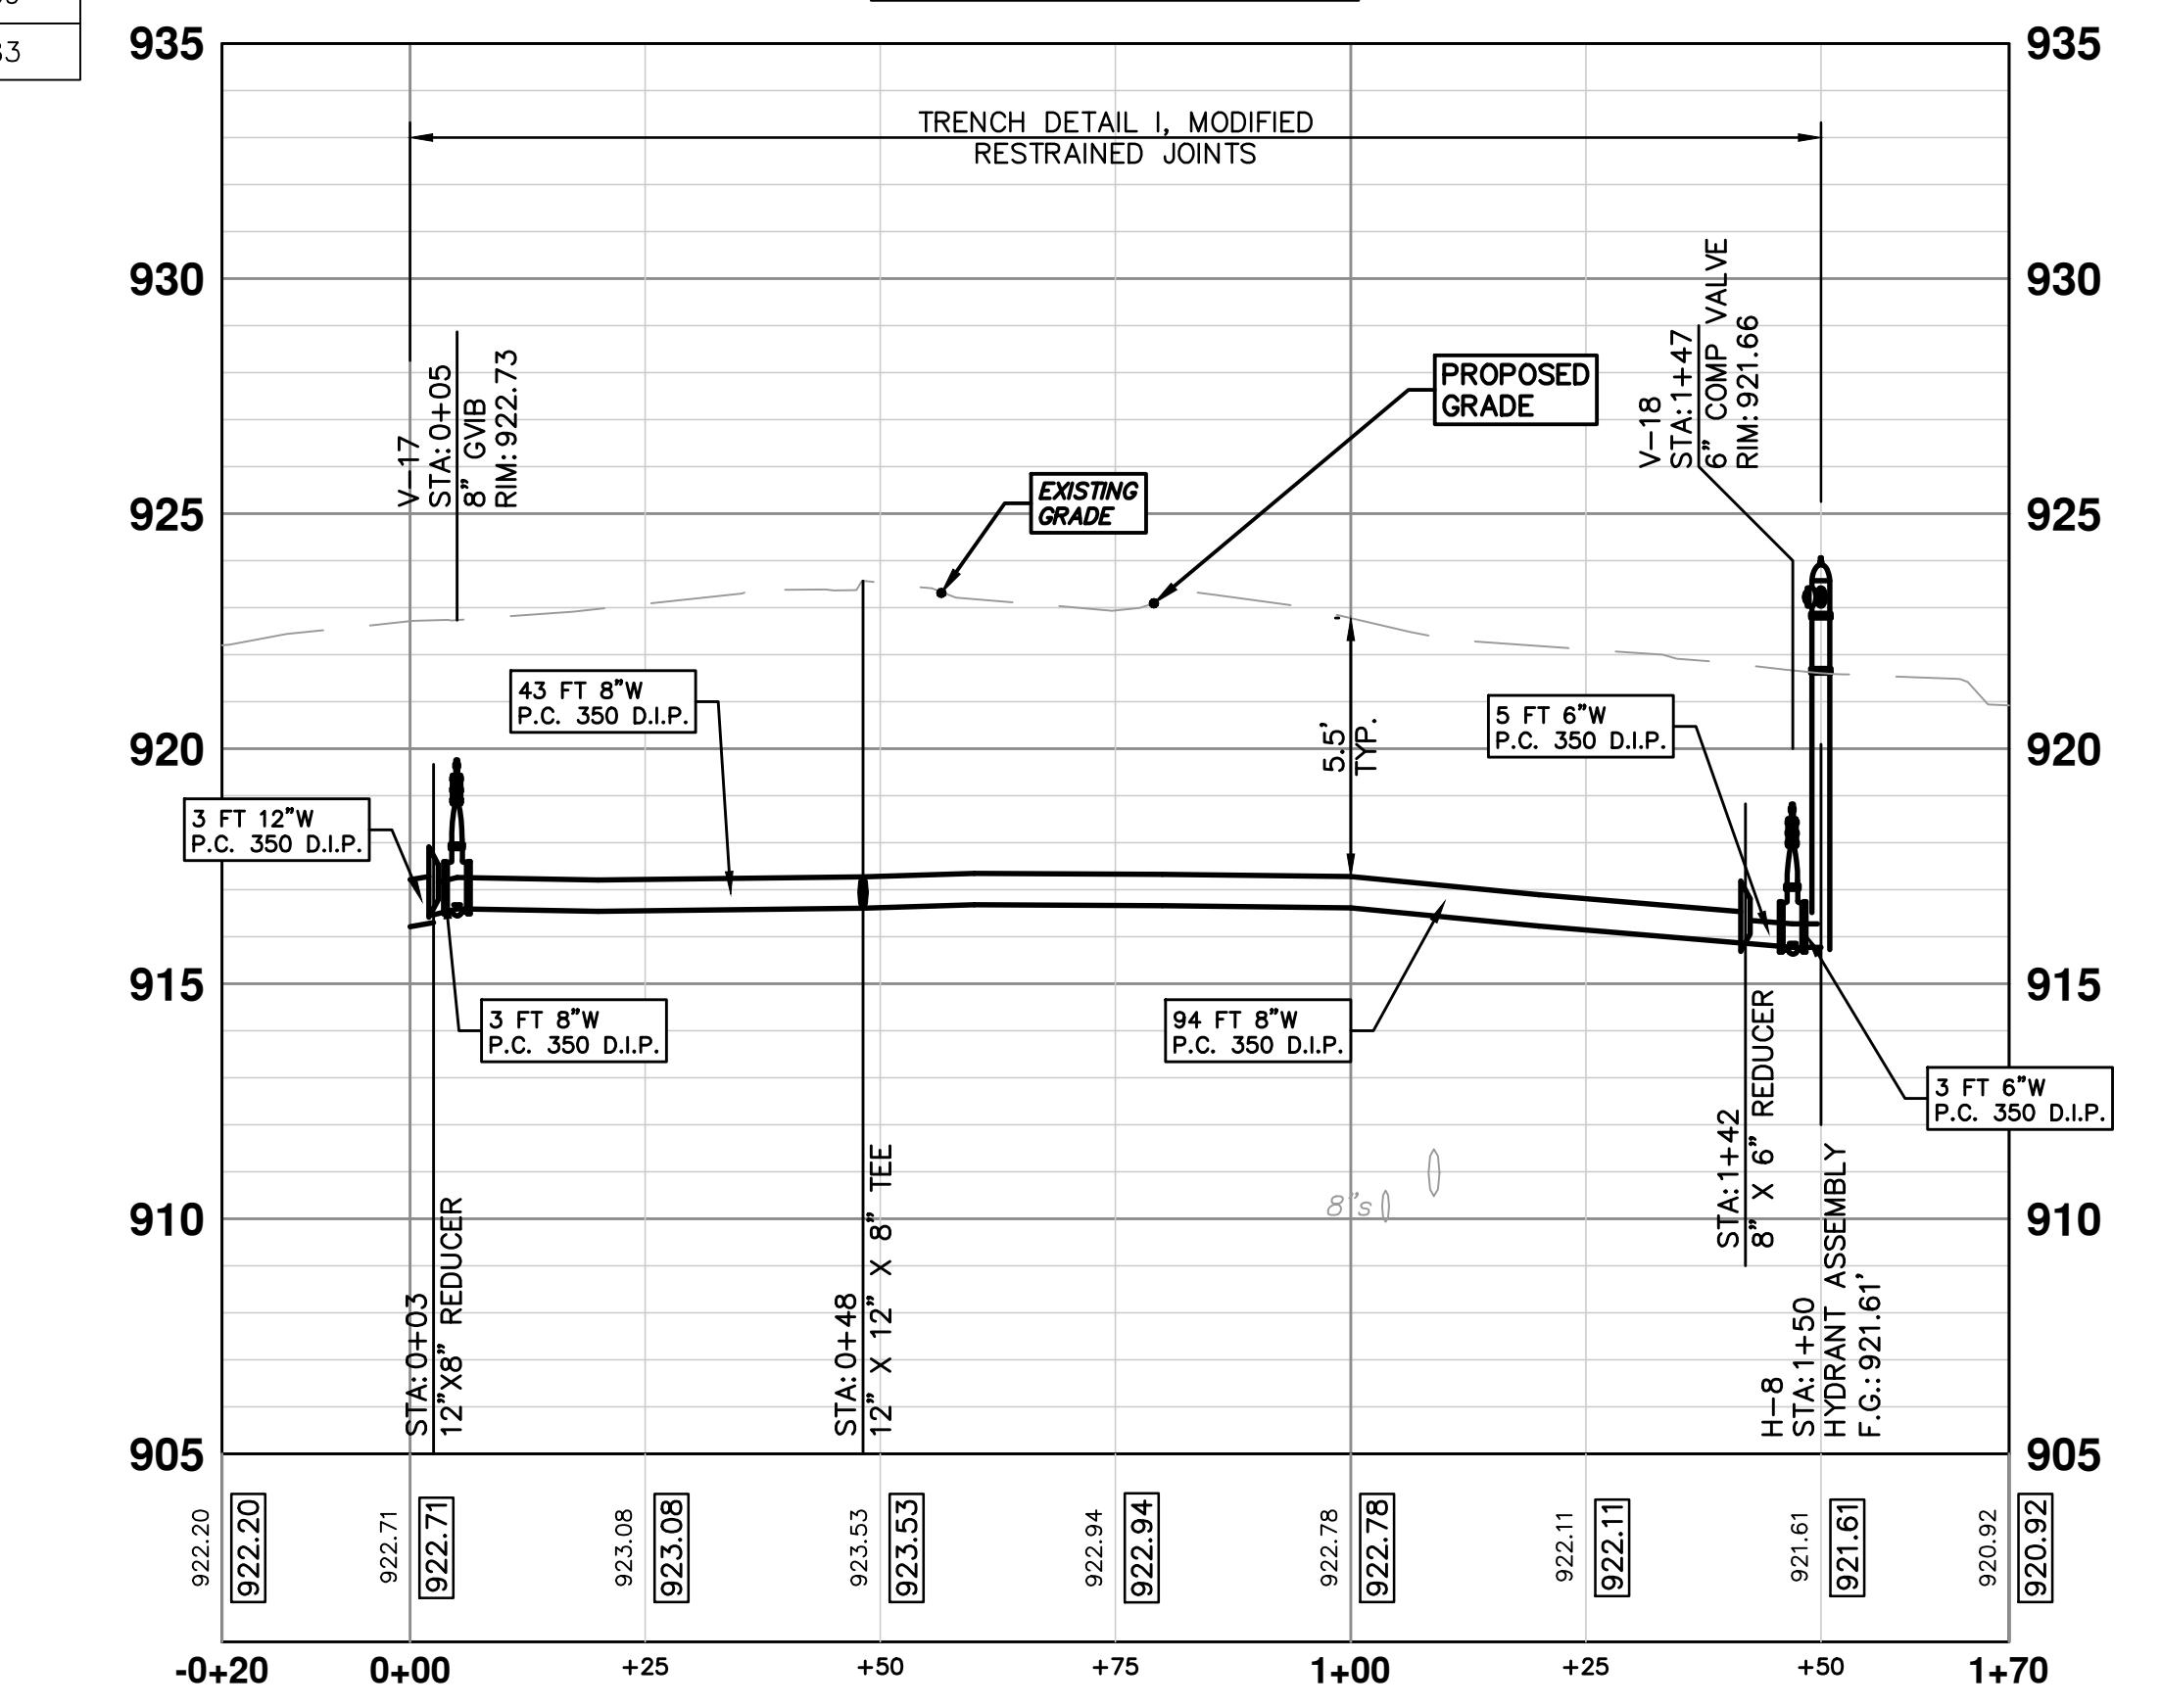

PROJECT MANAGEMENT - PUBLIC SERVICES - CITY OF ANN ARBOR	
SCALE/PLAN: 1" = 20'	PROFILE: 1" = 4'
DRAWING NO.	HEWETT DR, RUSSETT RD & REDEEMER AVE WATER MAIN REPLACEMENT
SHEET NO.	WATER MAIN PLAN & PROFILE
2013034-25	EBERWHITE EXTENSION AUX 'A' & 'B'

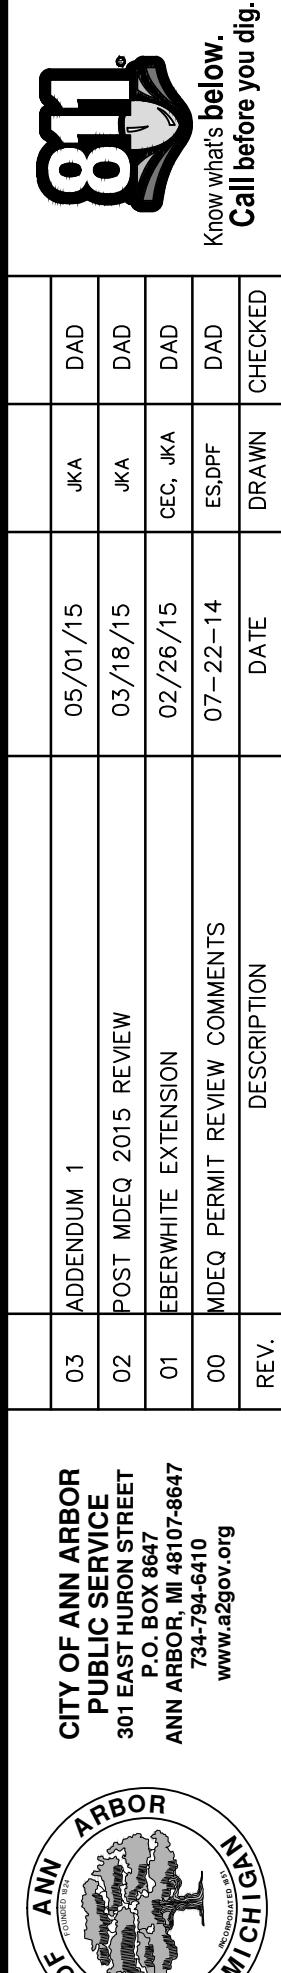

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**PROJECT MANAGEMENT - PUBLIC SERVICES - CITY OF ANN ARBOR**  
**HEWETT DR, RUSSELL RD, RUSSETT RD & REDEEMER AVE WATER MAIN REPLACEMENT**  
**ROAD GRADING**  
**HEWETT STA: 0-00 TO 4+32 RUSSETT STA: 0-50 TO 5-50**

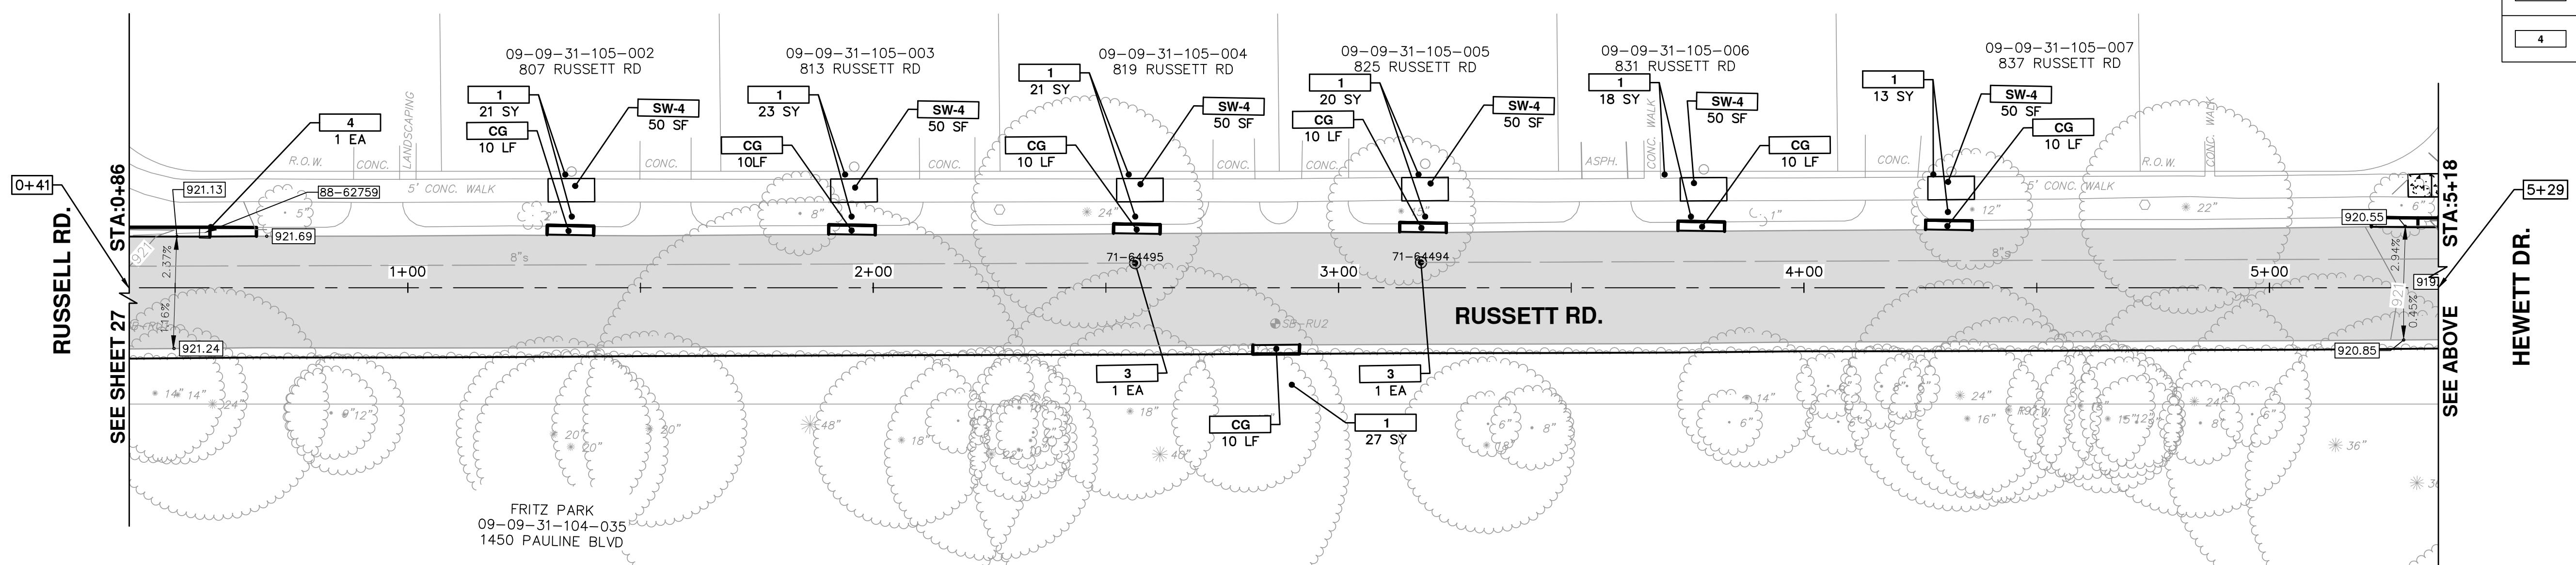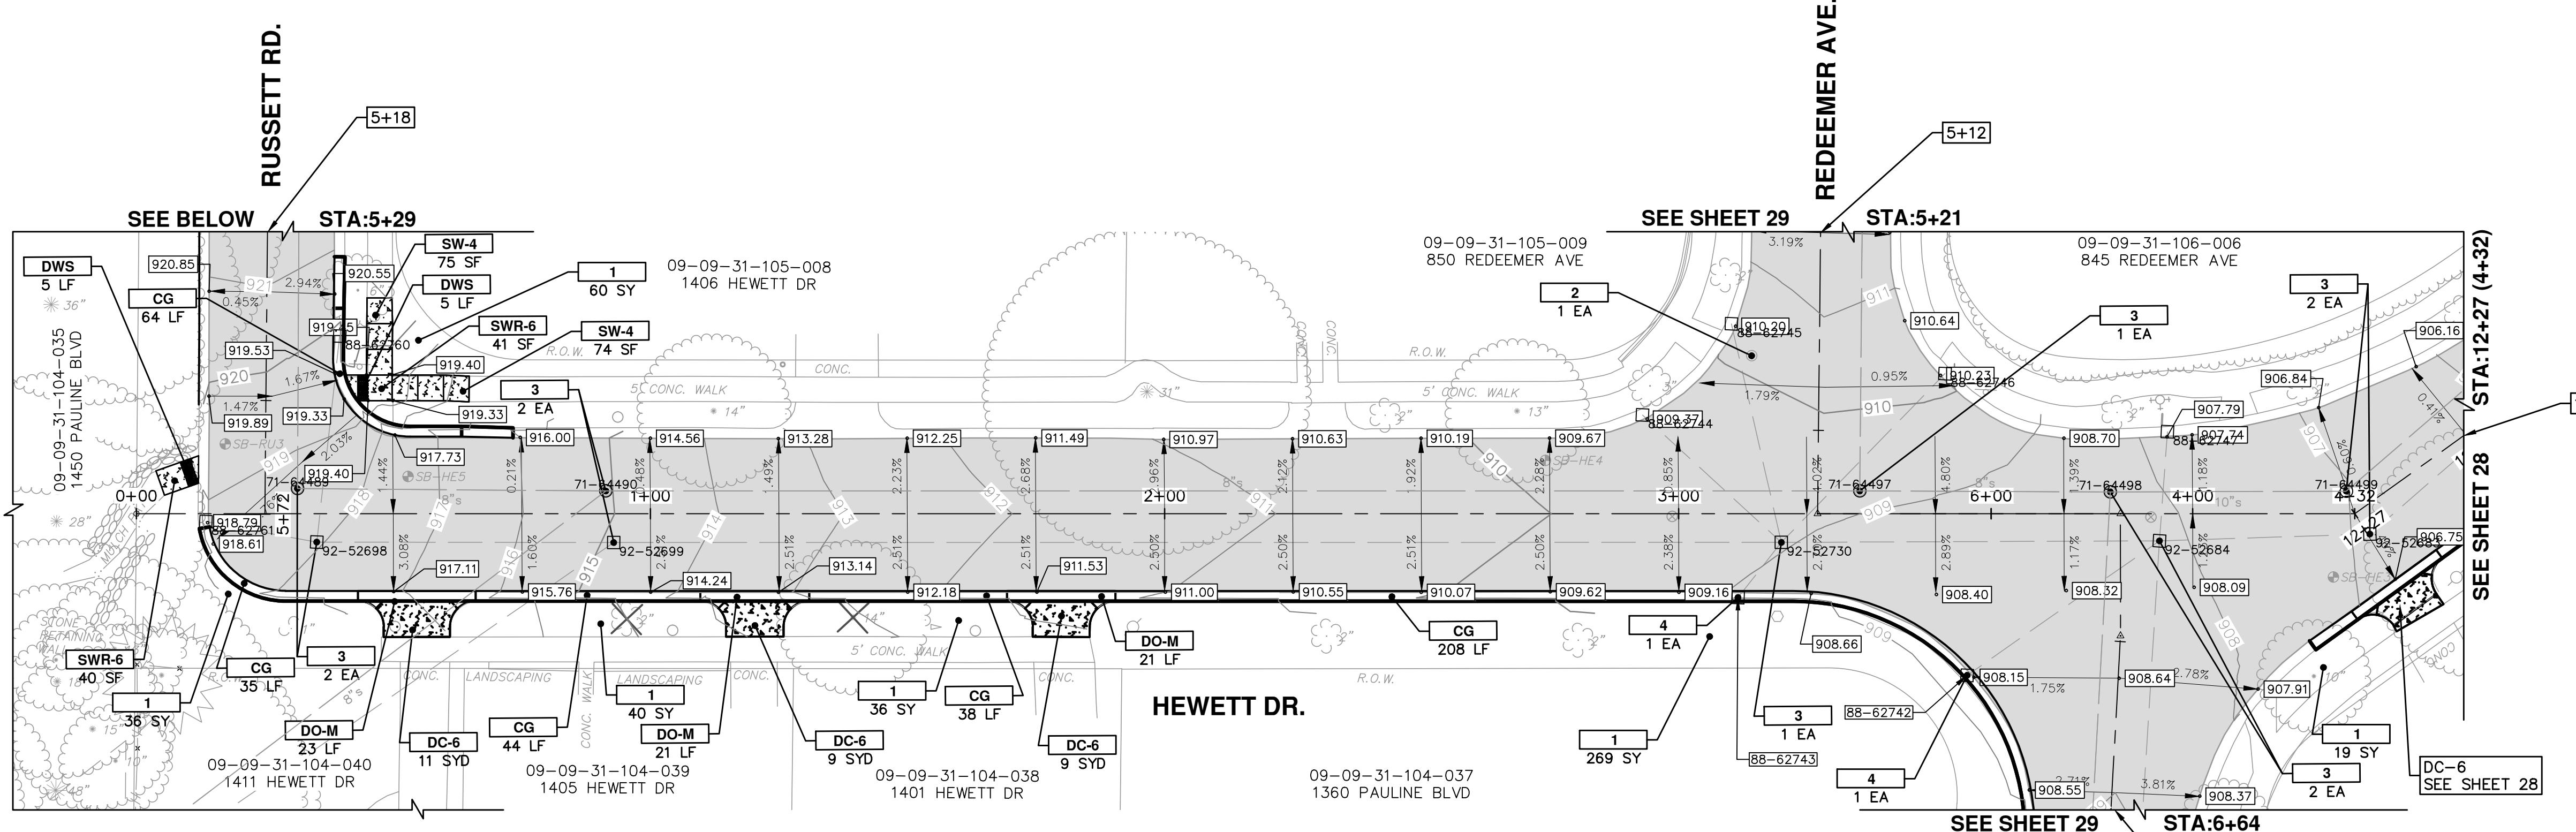
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03 ADENDUM 1	05/01/15	JKA	DAD
02 POST MODE 2015 REVIEW	03/18/15	JKA	DAD
01 EBWHITE EXTENSION	02/26/15	CEC, JKA	DAD
00 MDQ PERMIT REVIEW COMMENTS	02/22-14	ES,DPF	DAD
REV.	DATE	DRAWN	CHECKED

**CITY OF ANN ARBOR**  
**PUBLIC SERVICE**  
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 ANN ARBOR MI 48103-3647  
 734-763-5610  
 www.811gov.org

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**MICHIGAN**

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RUSSETT RD.

SEE SHEET 26

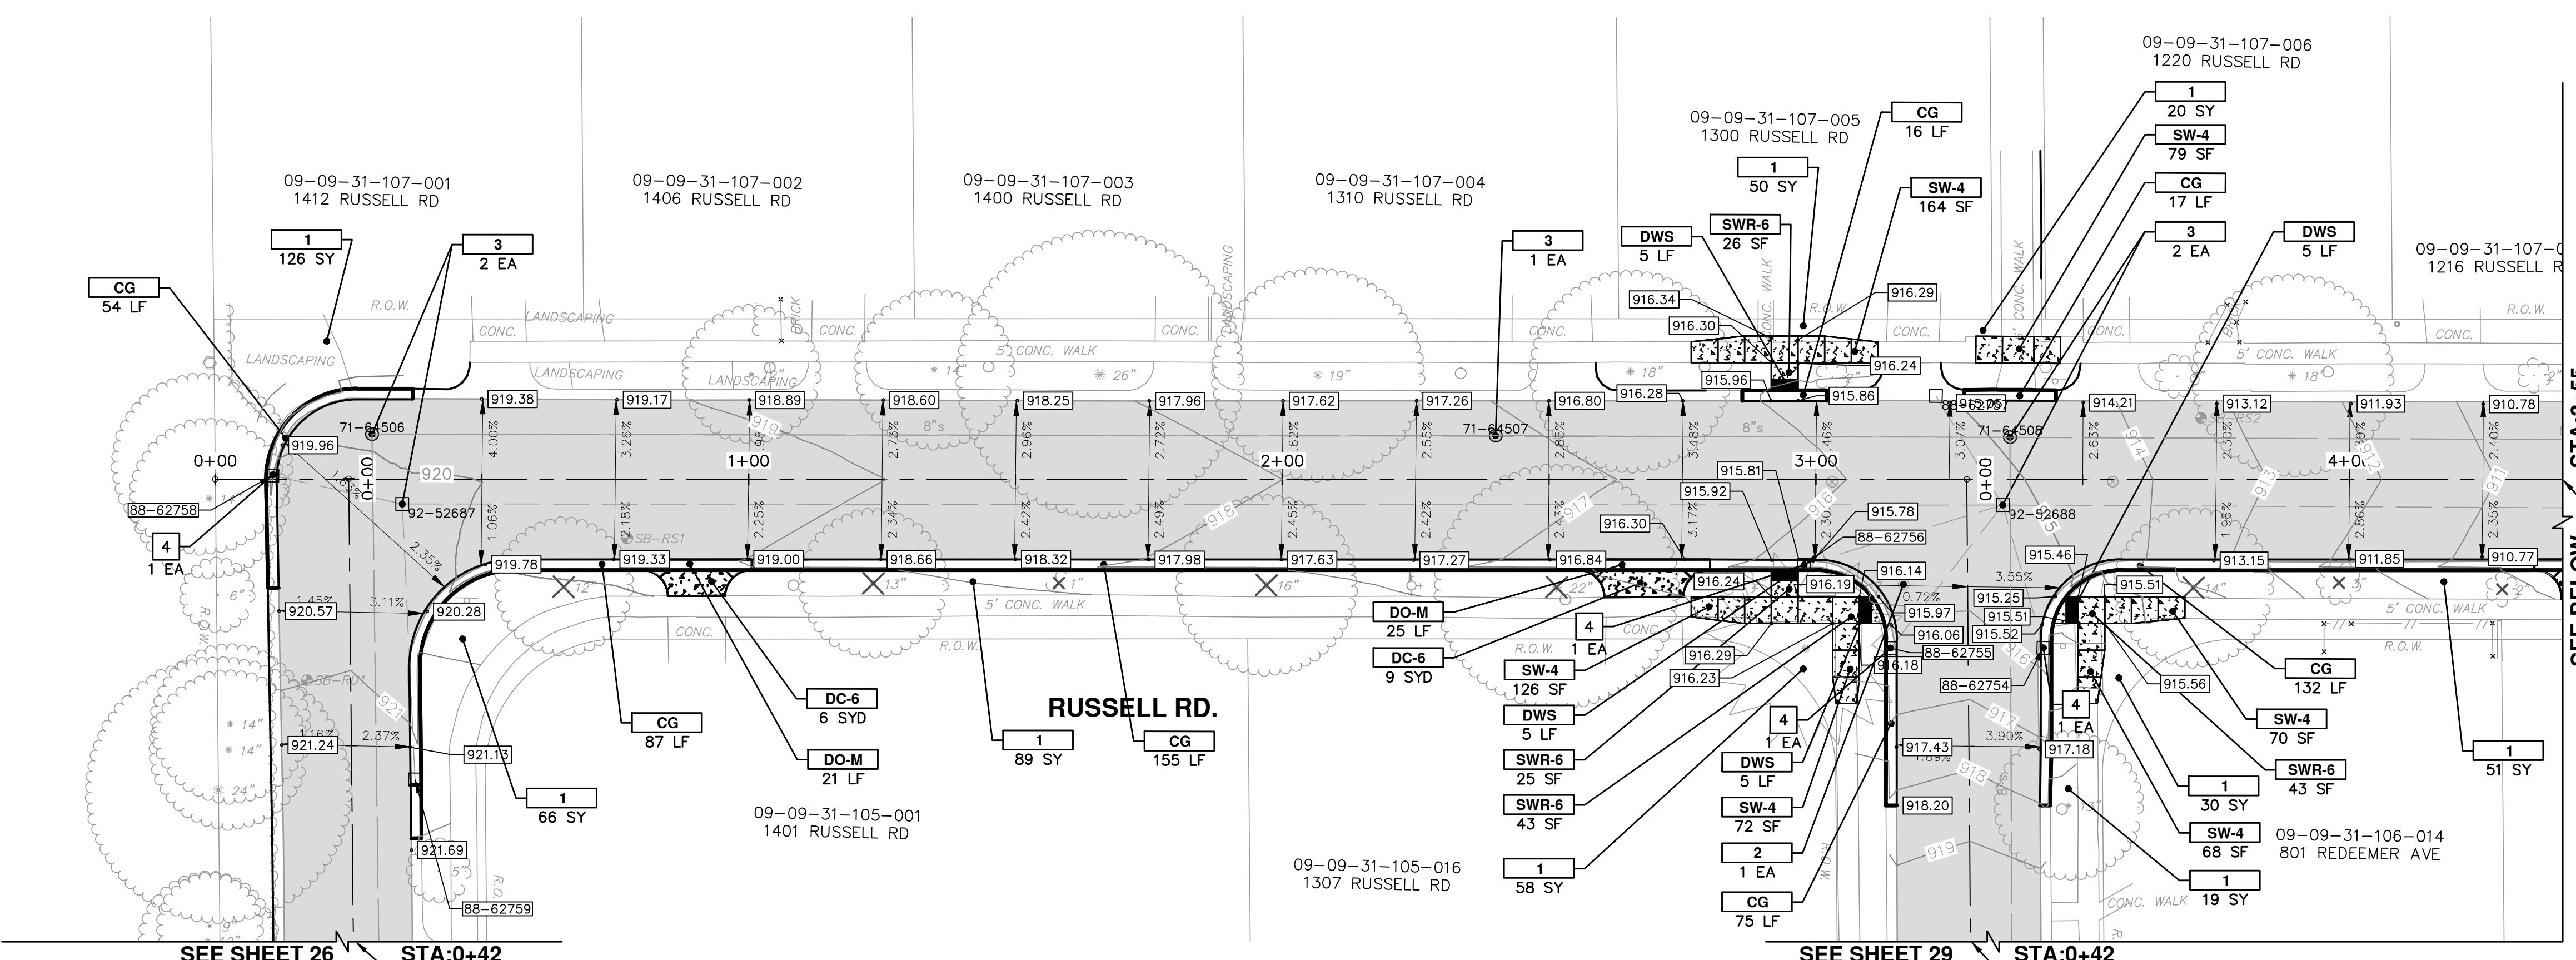STA:4+40

SEE ABOVE

RUSSELL RD.

STORM SEWER STRUCTURE TABLE						
STRUCTURE	UTILITY STATION	ALIGNMENT	INVERT ELEVATION, SIZE & DIRECTION	TOP OF CASTING ELEVATION	DEPTH (Feet)	SIZE
88-62753	6+36 -16.4 LT	RUSSELL	12" SW 901.27	904.88	5.61	24" Dia. CB
88-62754	0+32 -14.1 LT	Redeemer	12" N 912.06	915.70	5.64	24" Dia. CB
88-62755	0+31 14.6 RT	Redeemer	12" NE 911.82	916.16	6.34	24" Dia. CB
88-62756	2+98 16.0 RT	RUSSELL	12" E 911.72	915.70	5.98	24" Dia. CB
88-62758	0+11 -0.7 LT	RUSSELL	12" E 914.56	919.99	7.43	24" Dia. CB

SEE SHEET 29 STA:0+42

REDEEMER AVE.

SEE SHEET 29


0+86

RUSSELL RD.

SEE BELOW STA:3+55

4+40


CONSTRUCTION KEY	
KEY	DESCRIPTION
C	CURB, CONC, DET E4
CG	CURB AND GUTTER, CONC
DO-M	DRIVeway OPENing, CONC, DET M, MODIFIED
DC-6	DRIVeway, NONREINF CONC, 6 INCH, MODIFIED
SW-4	SIDEWALK, CONC, 4 INCH, MODIFIED
SWR-6	SIDEWALK RAMP, CONC, 6 INCH, MODIFIED
SW-6	SIDEWALK, CONC, 6 INCH, MODIFIED
DWS	DETECTABLE WARNING SURFACE, MODIFIED
1	SLOPE RESTORATION
1A	RESTORATION, BASEBALL FIELD
2	ADJUST GATE VALVE BOX, MONUMENT BOX, OR GAS BOX.
3	ADJUST STRUCTURE COVER
4	DR STRUCTURE, 24 INCH DIA & DR STRUCTURE COVER, TYPE K

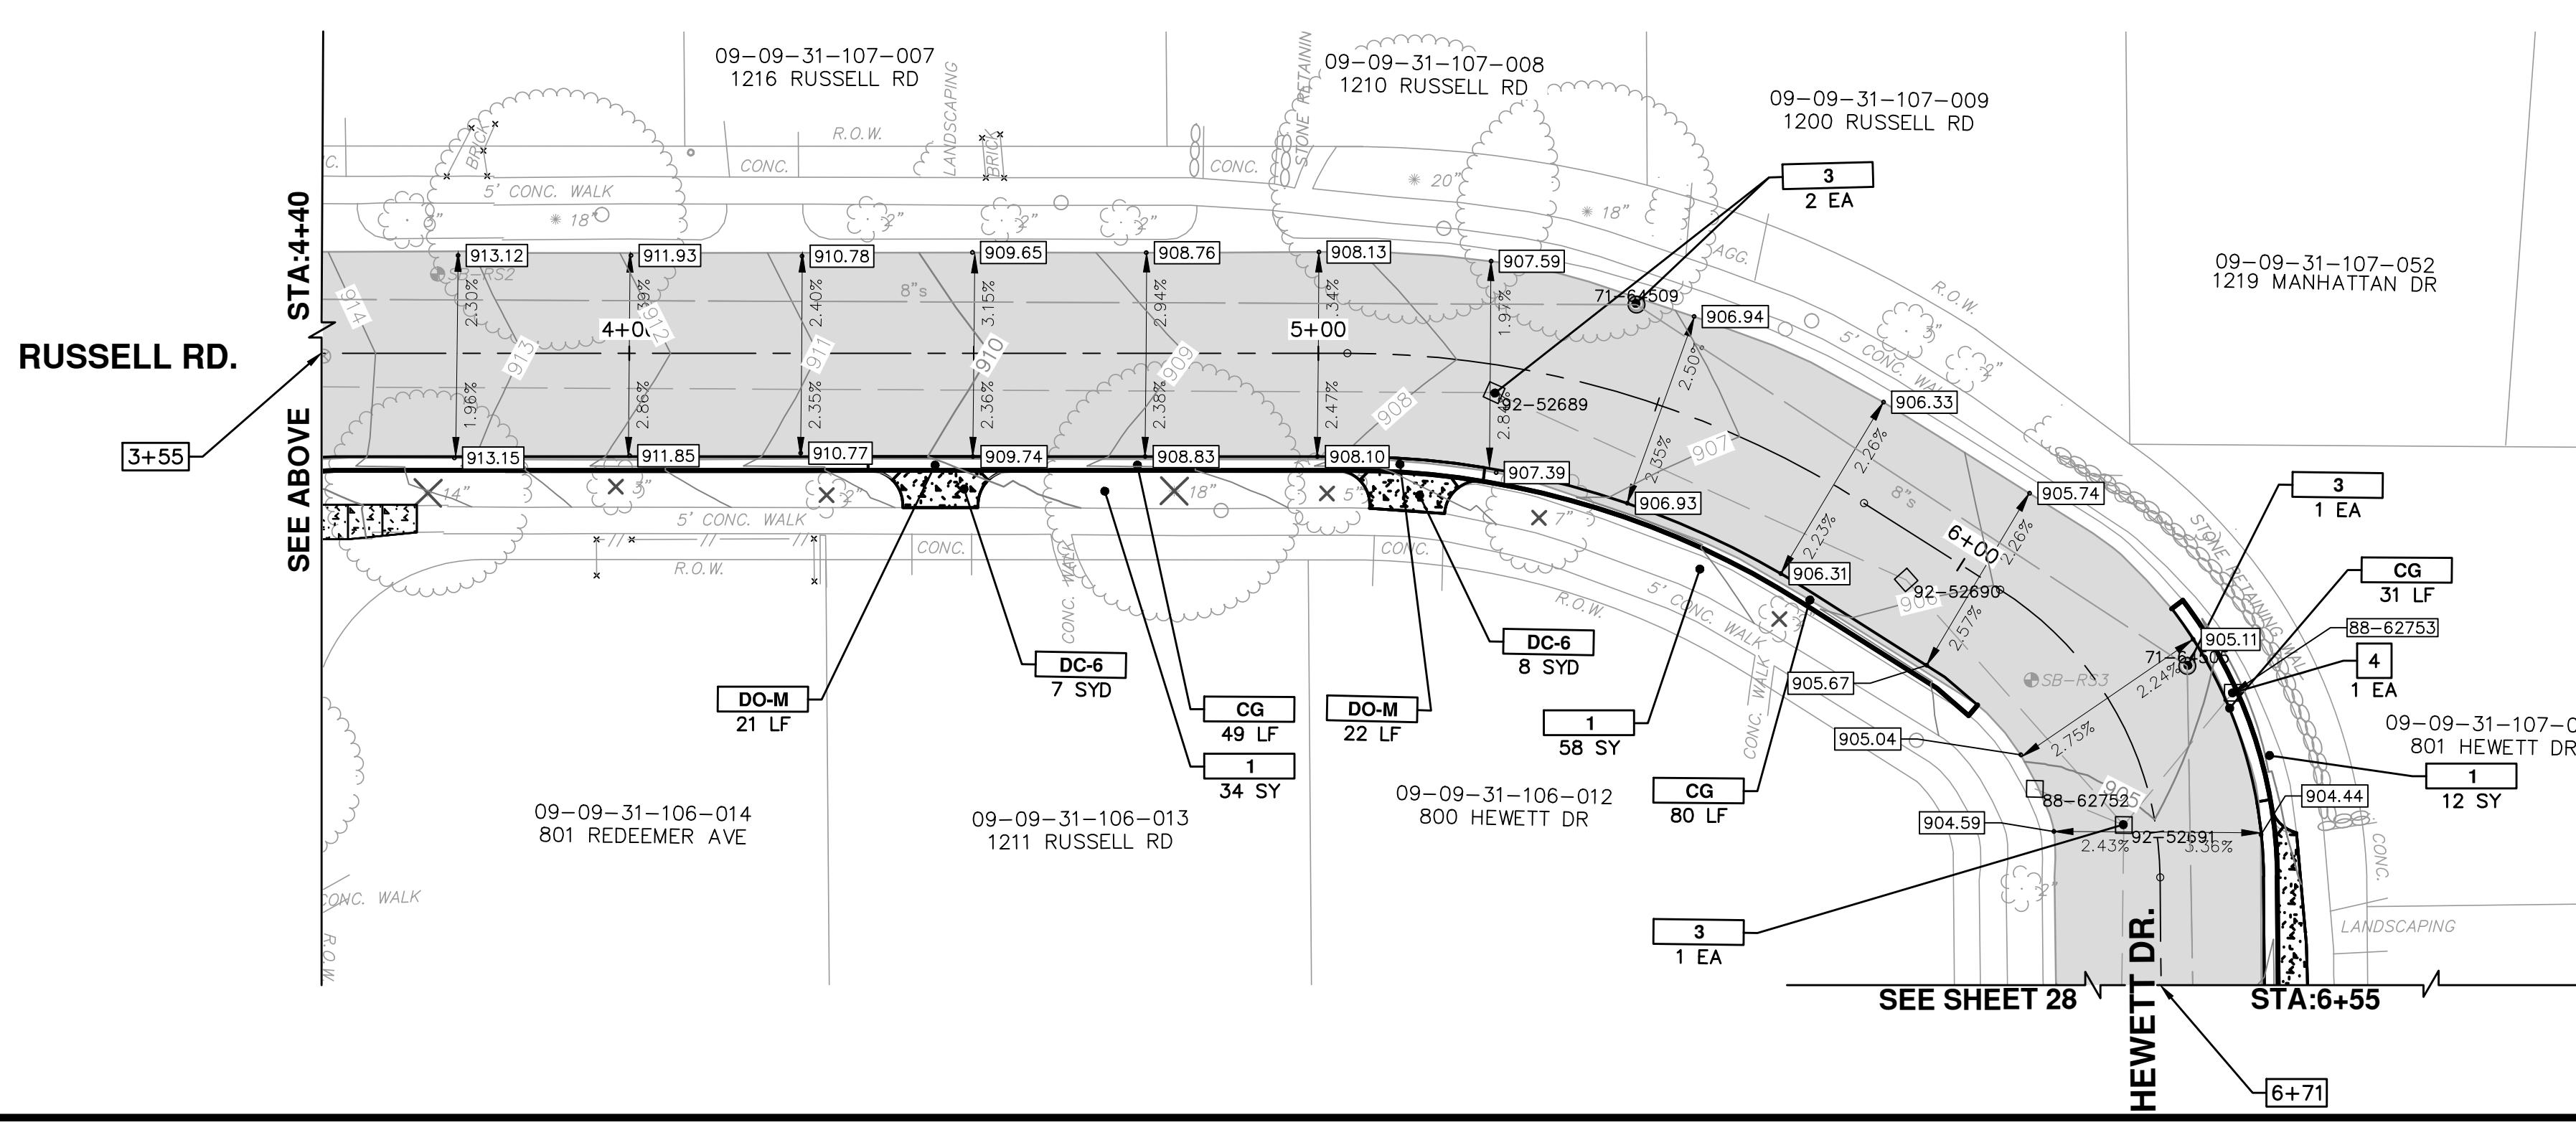



PROJECT MANAGEMENT - PUBLIC SERVICES - CITY OF ANN ARBOR  
HEWETT DR, RUSSETT RD, RUSSELL RD &  
REDEEMER AVE WATER MAIN REPLACEMENT

ROAD GRADING

RUSSELL STA: 0+00 TO 6+50

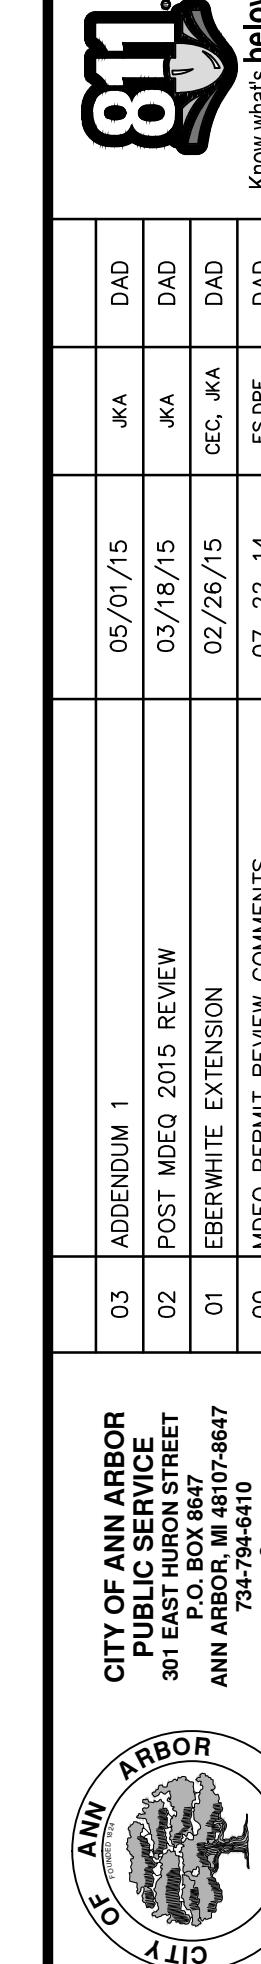



801.  
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03	ADENDUM 1	05/01/15	JKA	DAD
02	POST MODE 2015 REVIEW	05/18/15	JKA	DAD
01	EBERWHITE EXTENSION	02/26/15	CEC, JKA	DAD
00	MDE PERMIT REVIEW COMMENTS	07-22-14	ES, PDF	DAD
	DESCRIPTION	DATE	DRAWN	CHECKED
	REV.			

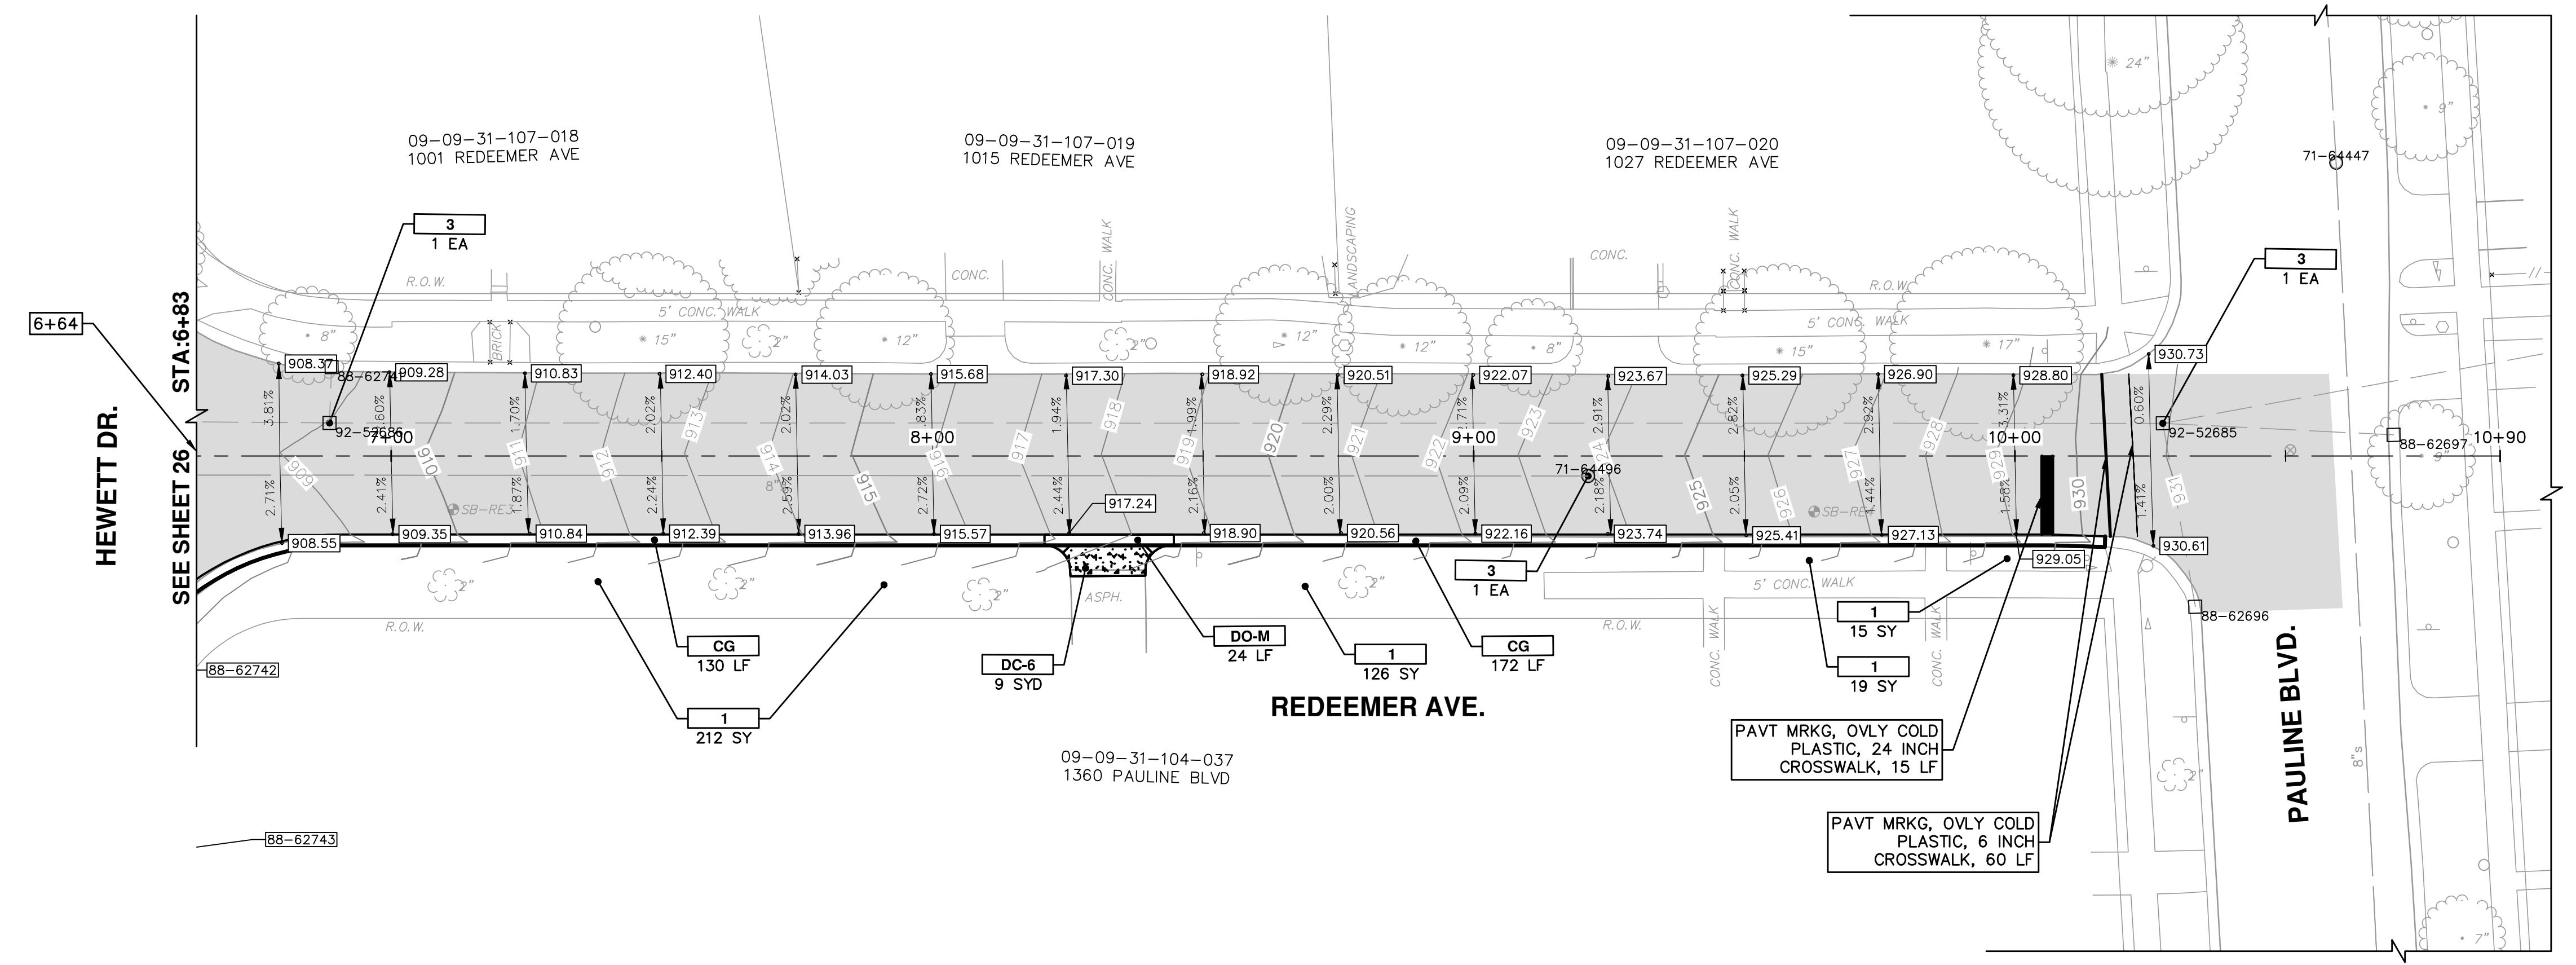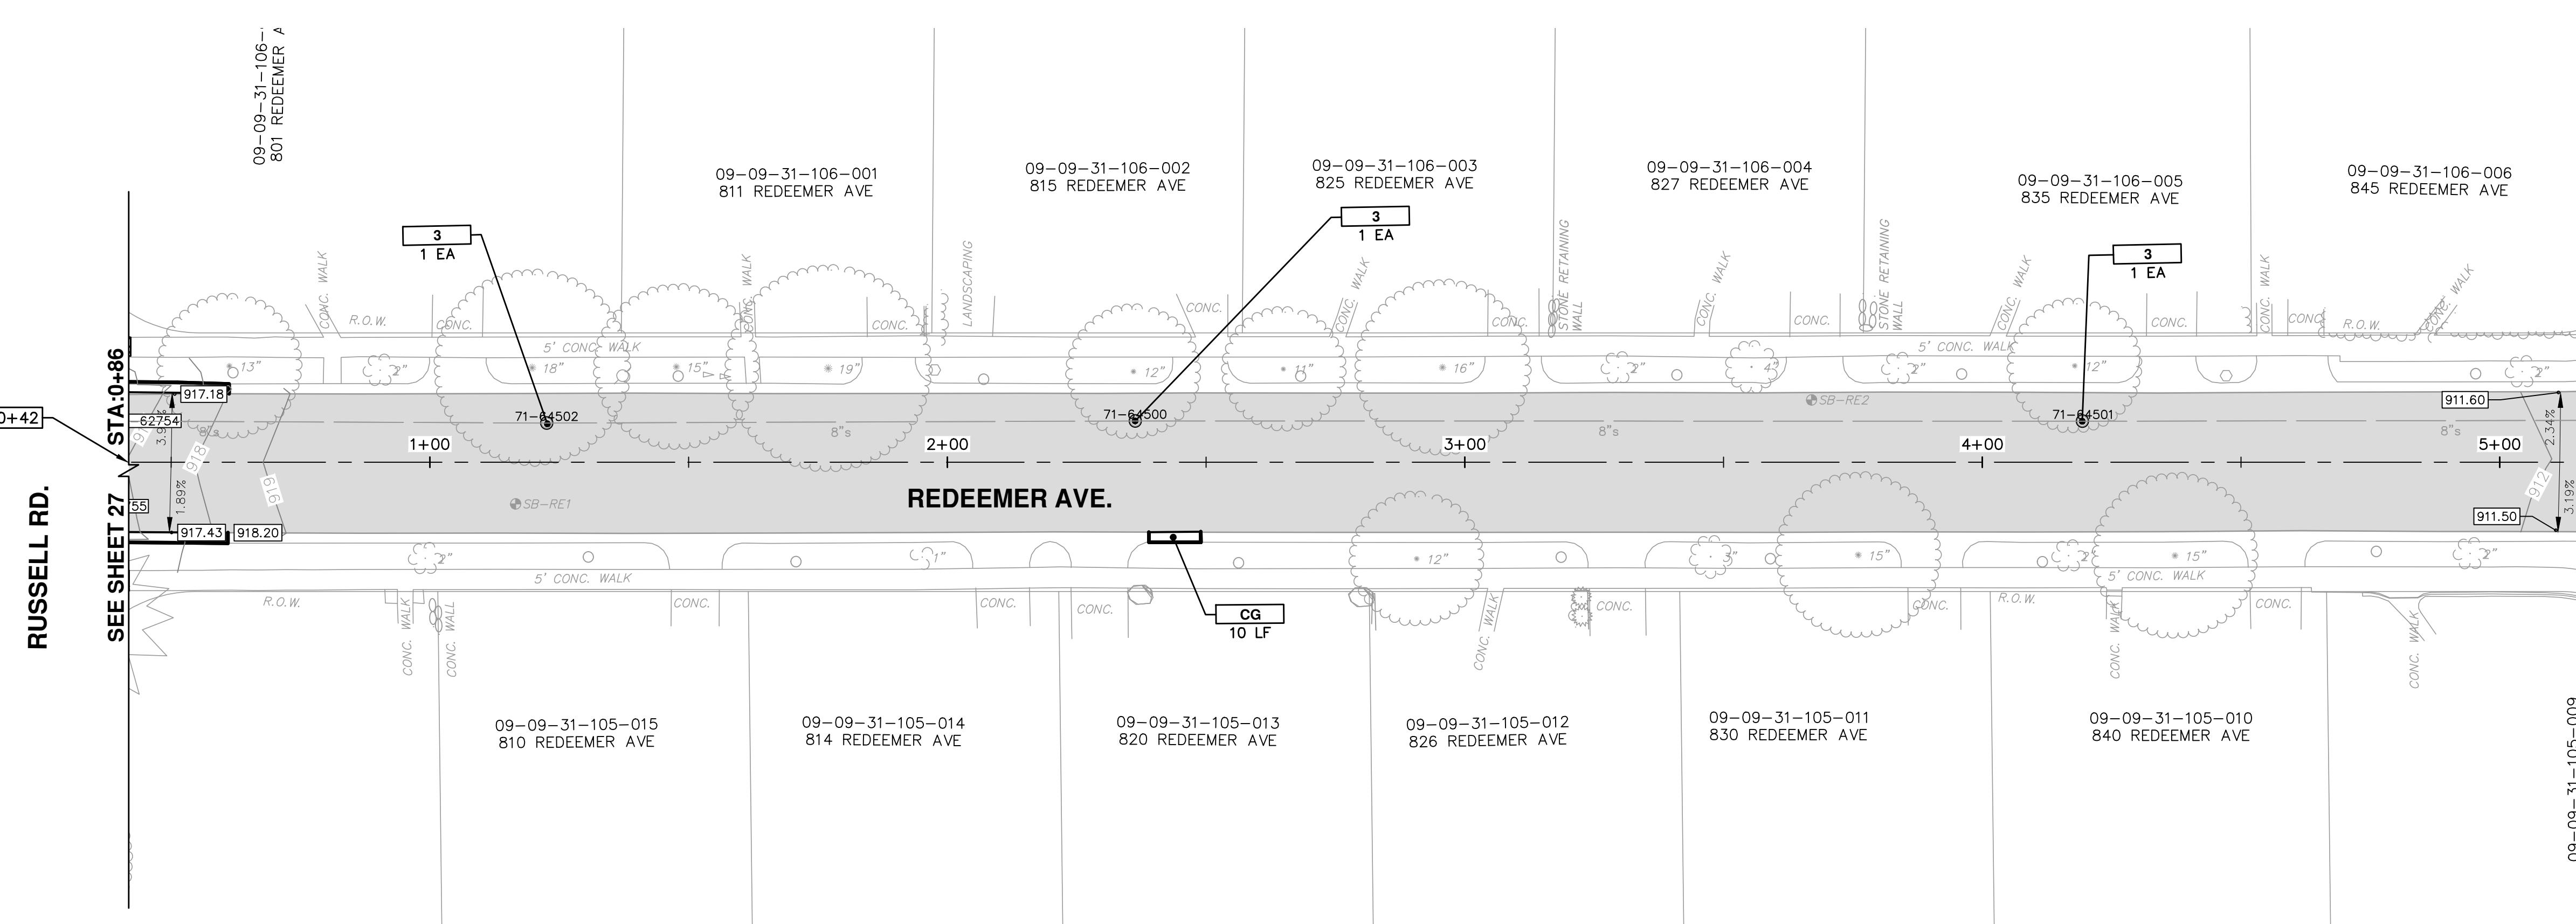**PROJECT MANAGEMENT - PUBLIC SERVICES - CITY OF ANN ARBOR**  
**HEWETT DR, RUSSELL RD, RUSSETT RD &**  
**REDEEMER AVE WATER MAIN REPLACEMENT**  
**ROAD GRADING**  
**REDEEMER STA. 0+50 TO 10+50**






STORM SEWER STRUCTURE TABLE						
STRUCTURE	UTILITY STATION	ALIGNMENT	INVERT ELEVATION, SIZE & DIRECTION	TOP OF CASTING ELEVATION	DEPTH (Feet)	SIZE
88-62748	10+07 -18.3 LT	RUSSELL	12" N 898.43	903.43	7.00	24" Dia. CB
88-62750	7+70 -15.5 LT	RUSSELL	12" NW 898.08	901.70	5.62	24" Dia. CB

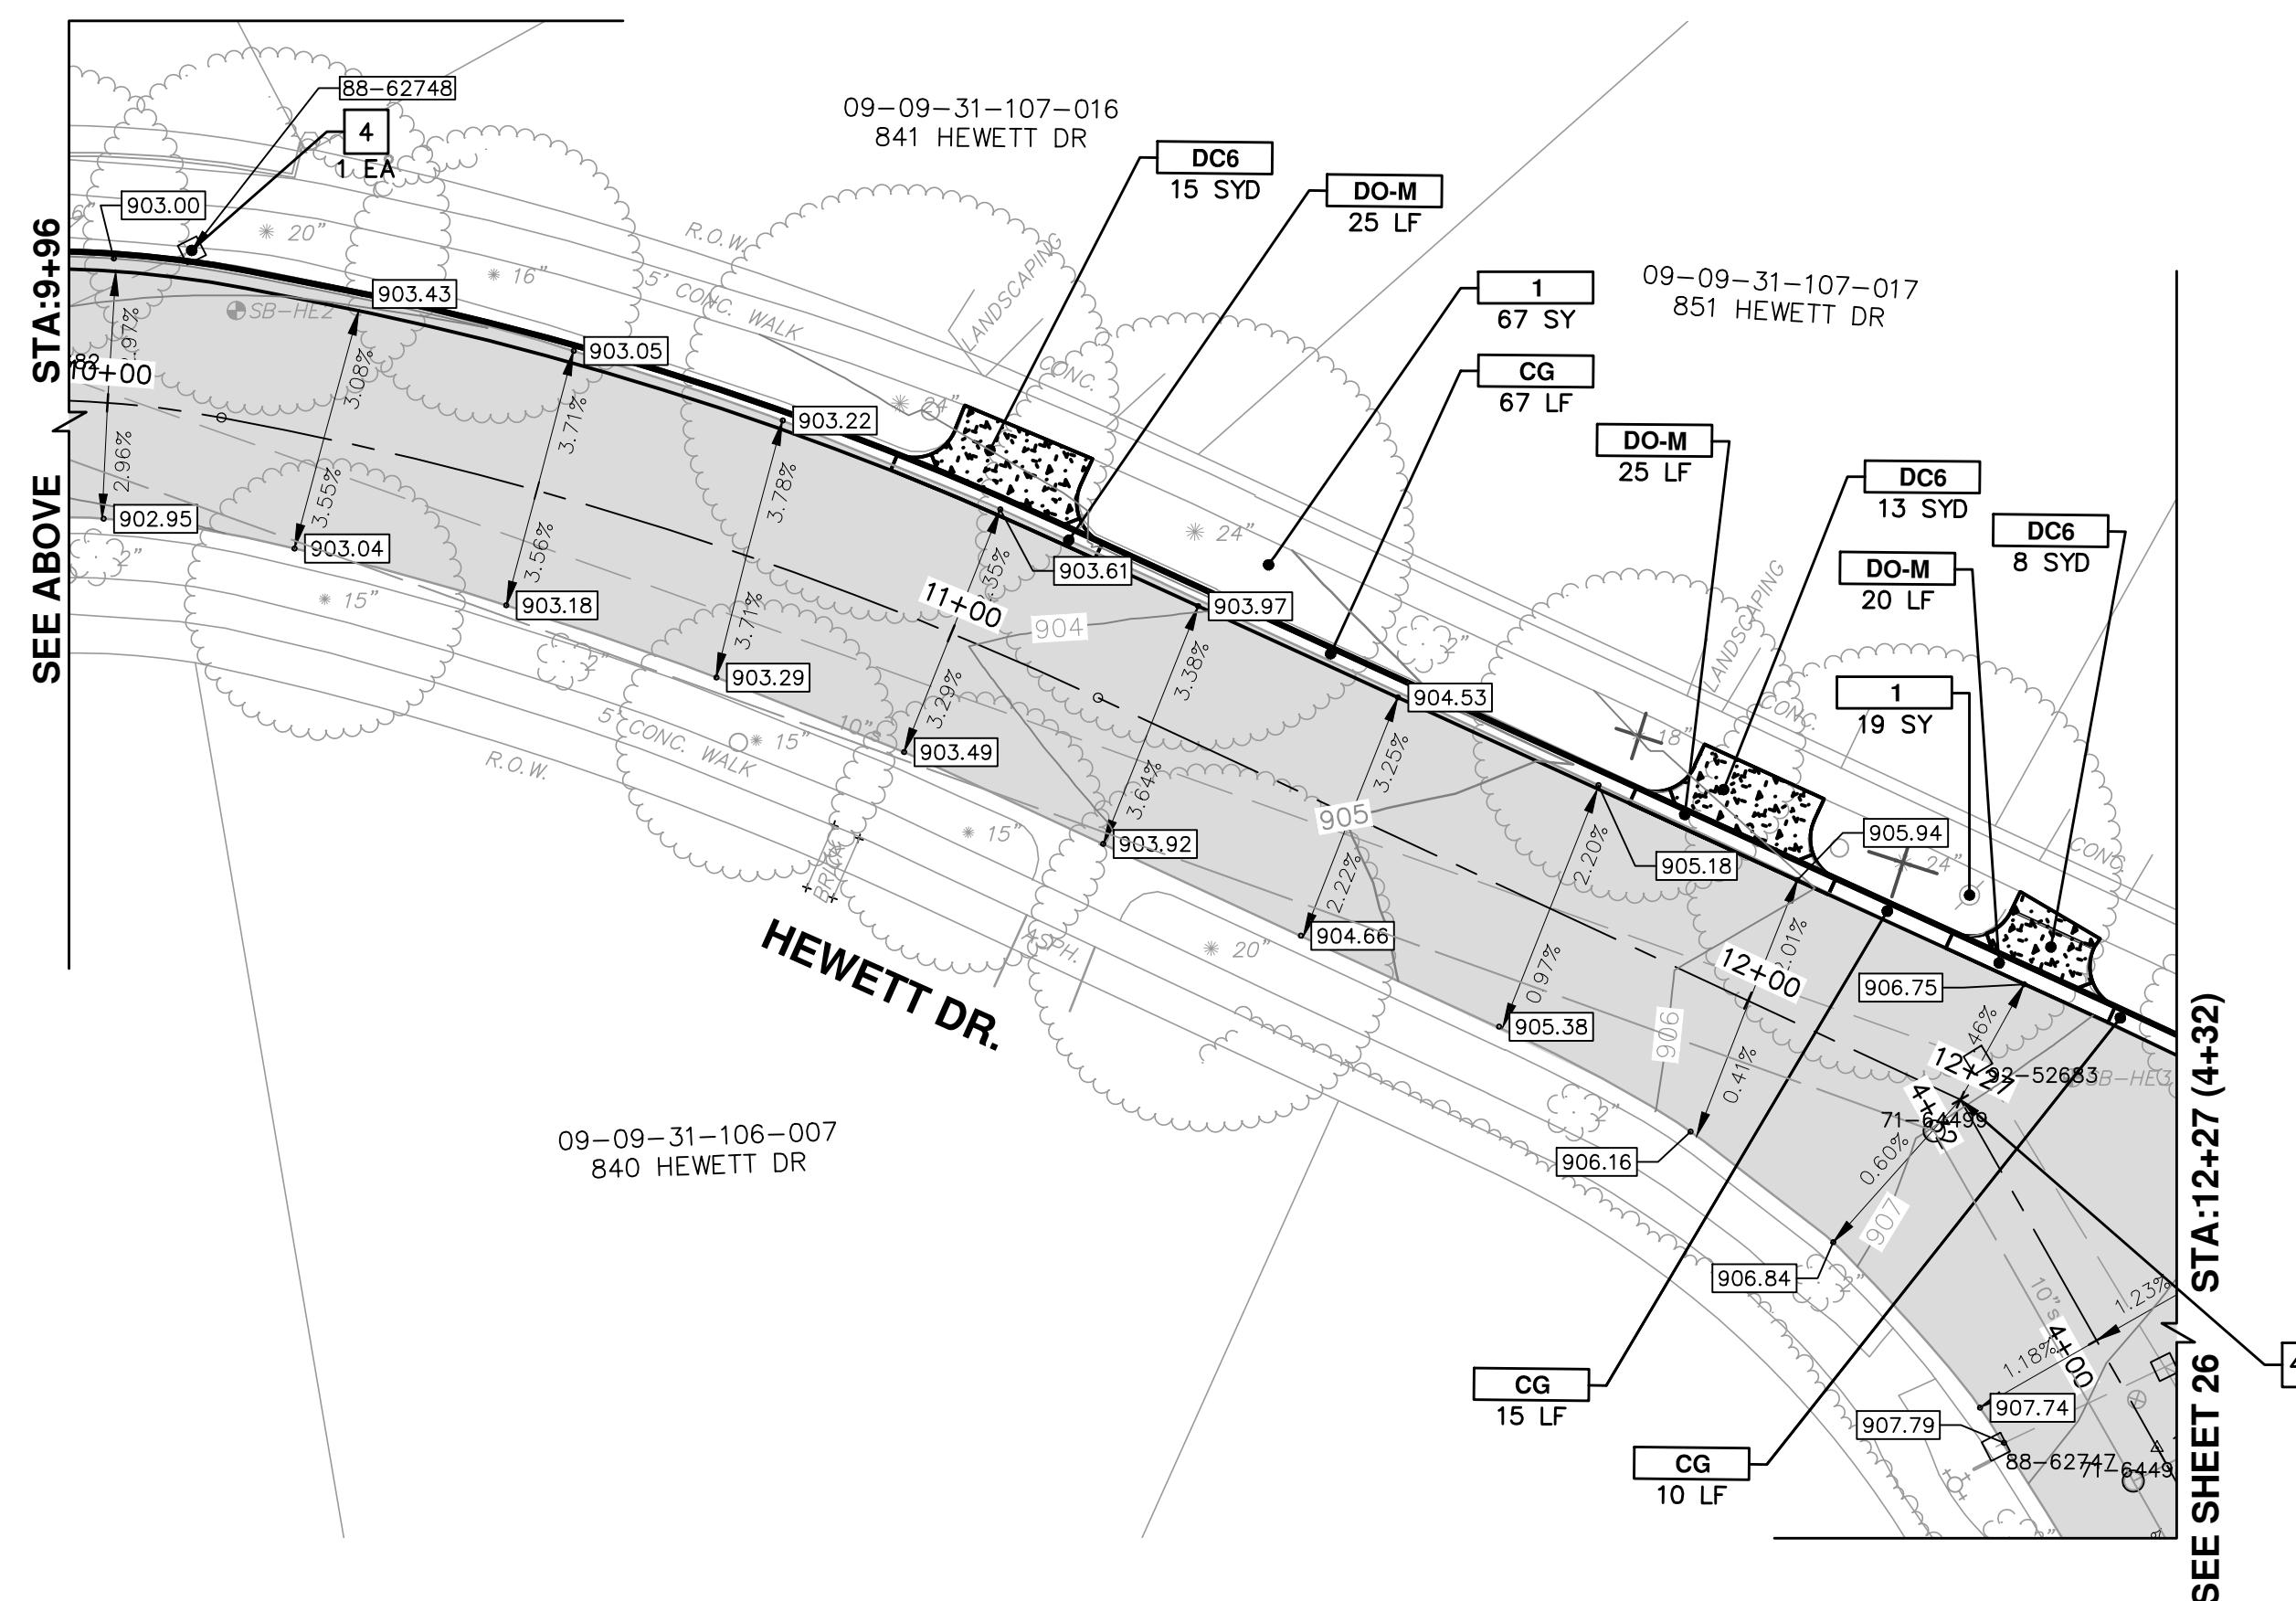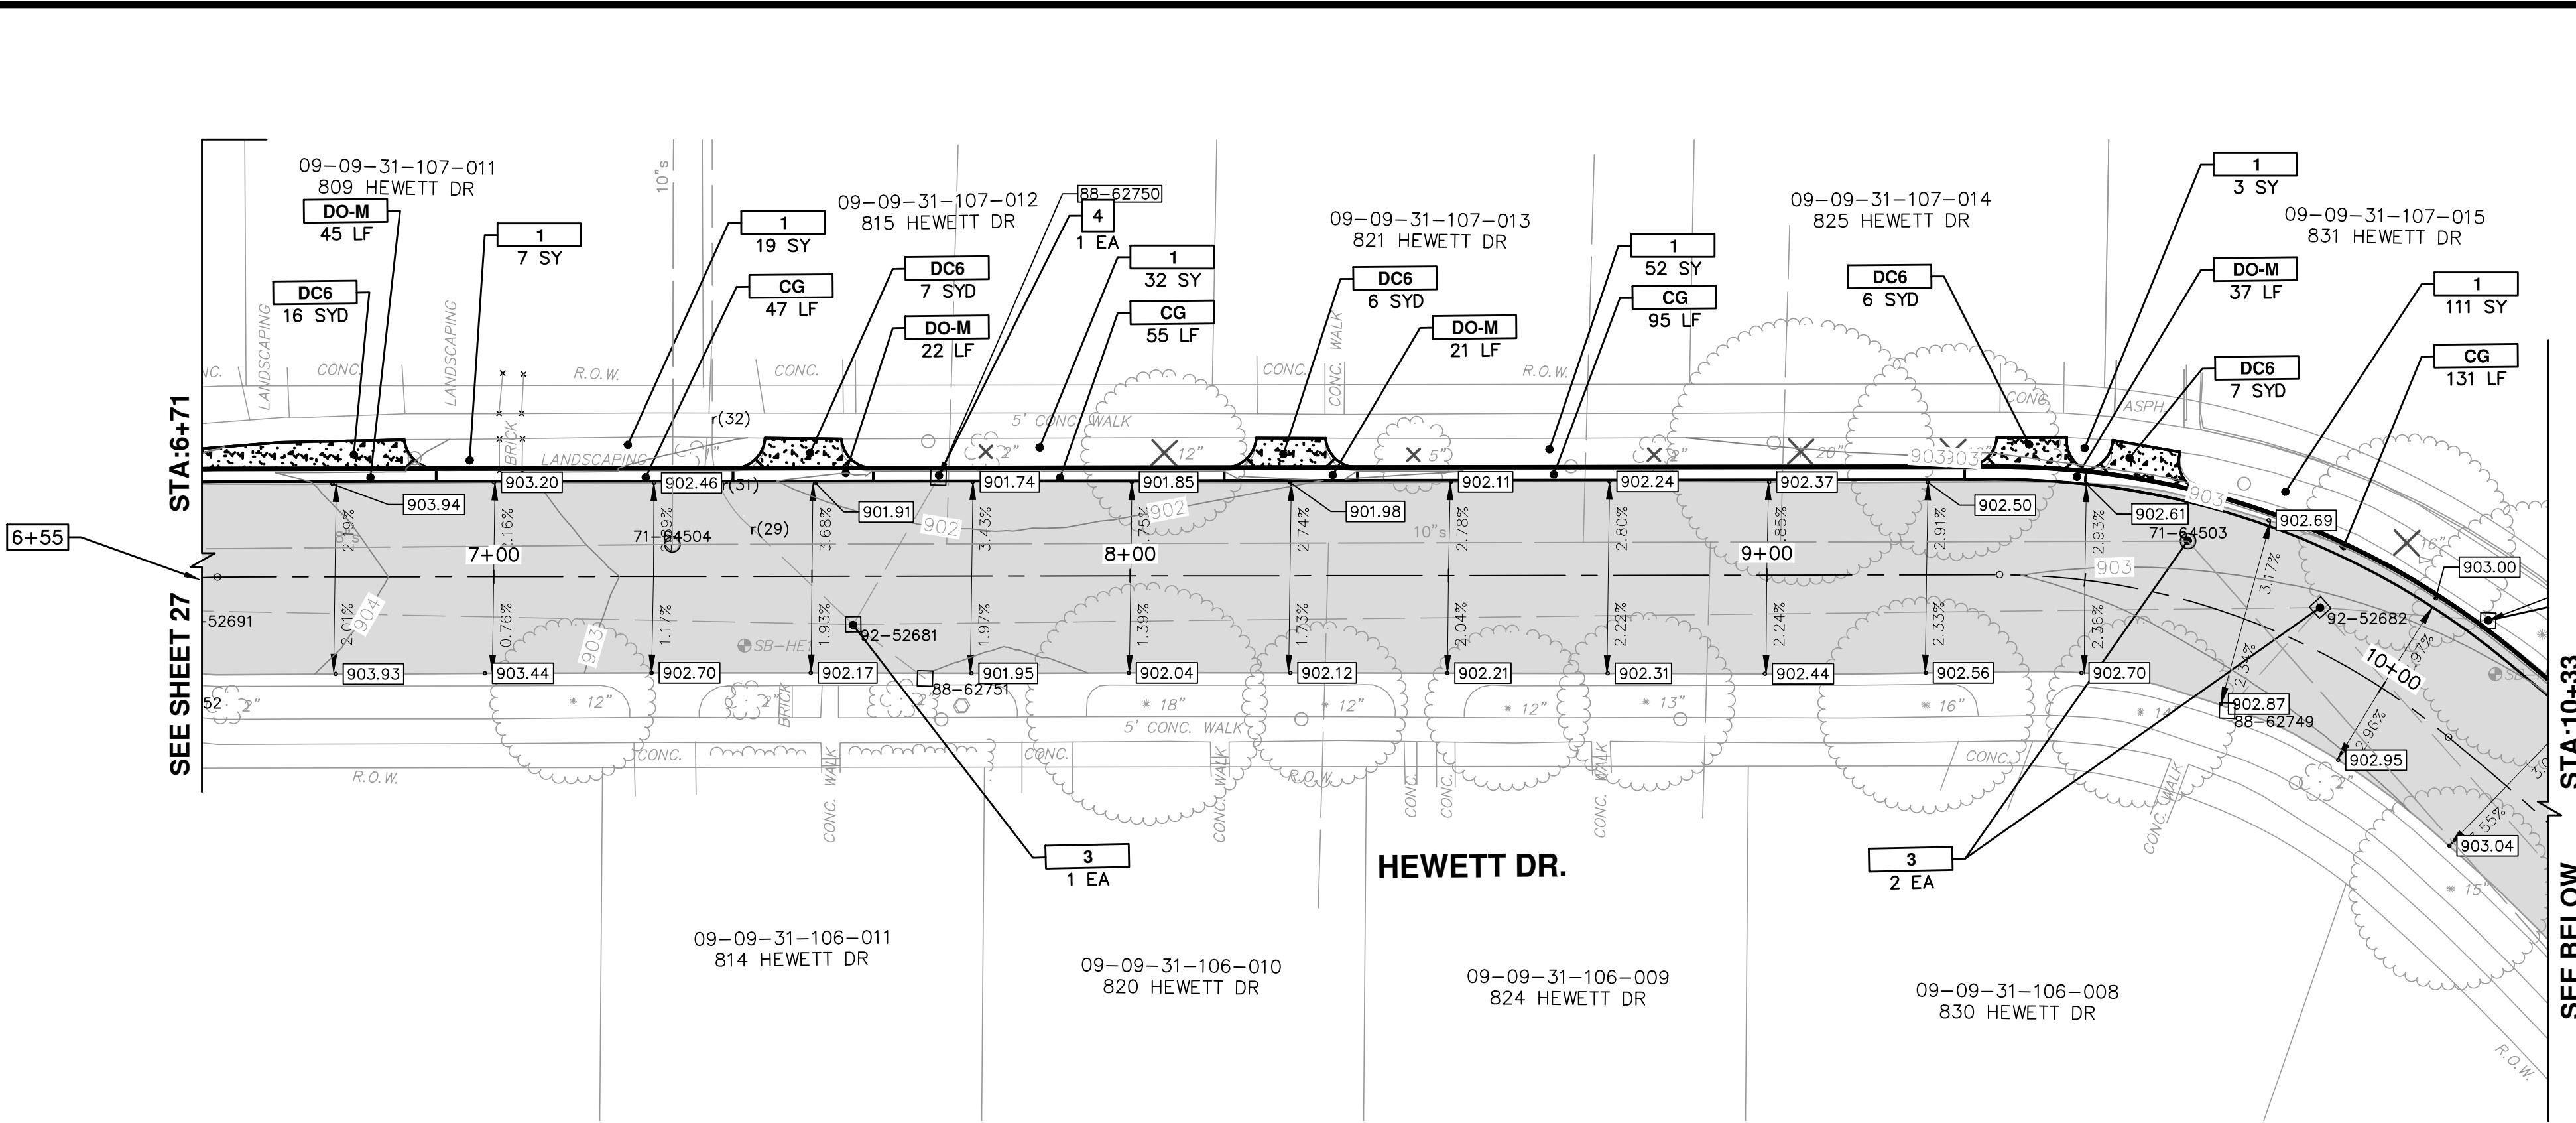CONSTRUCTION KEY	
KEY	DESCRIPTION
C	CURB, CONC, DET E4
CG	CURB AND GUTTER, CONC
DO-M	DRIVeway OPENING, CONC, DET M, MODIFIED
DC-6	DRIVeway, NONREINF CONC, 6 INCH, MODIFIED
SW-4	SIDEWALK, CONC, 4 INCH, MODIFIED
SWR-6	SIDEWALK RAMP, CONC, 6 INCH, MODIFIED
SW-6	SIDEWALK RAMP, CONC, 6 INCH, MODIFIED
DWS	DETECTABLE WARNING SURFACE, MODIFIED
1	SLOPE RESTORATION
1A	RESTORATION, BASEBALL FIELD
2	ADJUST GATE VALVE BOX, MONUMENT BOX, OR GAS BOX.
3	ADJUST STRUCTURE COVER
4	DR STRUCTURE, 24 INCH DIA & DR STRUCTURE COVER, TYPE K

**PROJECT MANAGEMENT - PUBLIC SERVICES - CITY OF ANN ARBOR**  
**HEWETT DR, RUSSELL RD, RUSSETT RD &**  
**REDEEMER AVE WATER MAIN REPLACEMENT**  
**ROAD GRADING**  
**RUSSELL STA. 6+50 TO STA. 12+27**

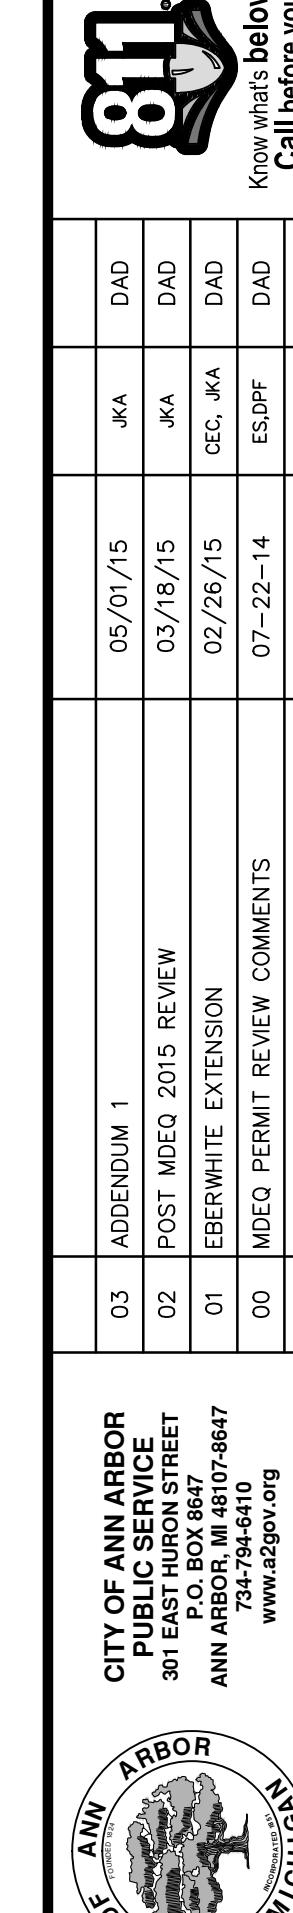

81.  
Know what's below.  
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