



# CITY OF ANN ARBOR PROJECT MANAGEMENT

## COLONY RD, ESSEX RD, AND MANCHESTER RD CONCRETE PAVEMENT REPAIRS

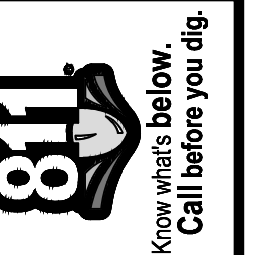
BID No. 4396, FILE No. 2015024

### NOTES

FOR PROTECTION OF UNDERGROUND UTILITIES AND IN CONFORMANCE WITH PUBLIC ACT 53, THE CONTRACTOR SHALL CALL 811 OR 1-800-482-7171 A MINIMUM OF THREE FULL WORKING DAYS, EXCLUDING SATURDAYS, SUNDAYS, AND HOLIDAYS, PRIOR TO BEGINNING EACH EXCAVATION IN AREAS WHERE PUBLIC UTILITIES HAVE NOT BEEN PREVIOUSLY LOCATED. MEMBERS WILL THUS BE ROUTINELY NOTIFIED. THIS DOES NOT RELIEVE THE CONTRACTOR OF THE RESPONSIBILITY OF NOTIFYING UTILITY OWNERS WHO MAY NOT BE A PART OF THE "MISS DIG" ALERT SYSTEM.

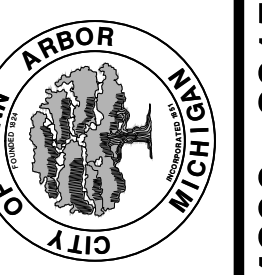
THE UNDERGROUND LOCATIONS SHOWN FOR NATURAL GAS, TELEPHONE, ELECTRICAL POWER, CABLE TV AND FIBER OPTIC LINES ARE APPROXIMATE. THE CITY OF ANN ARBOR ASSUMES NO RESPONSIBILITY FOR THEIR ACCURATE REPRESENTATION IN THIS DRAWING. MISS DIG MUST BE CONTACTED PRIOR TO CONSTRUCTION TO LOCATE THESE UTILITIES.

THE IMPROVEMENTS COVERED BY THESE PLANS SHALL BE PERFORMED IN ACCORDANCE WITH THE MICHIGAN DEPARTMENT OF TRANSPORTATION 2012 STANDARD SPECIFICATIONS FOR CONSTRUCTION (INCLUDING REFERENCED M.D.O.T. PUBLICATIONS) AND THIS PROJECT'S CONTRACT DOCUMENTS.



REV.	DESCRIPTION	DATE	DRAWN	CHECKED

CITY OF ANN ARBOR  
PUBLIC SERVICES  
301 EAST HURON STREET  
ANN ARBOR, MI 48106-0667  
www.a2gov.org



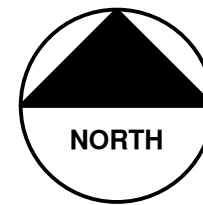
PROJECT MANAGEMENT - PUBLIC SERVICES - CITY OF ANN ARBOR  
CONCRETE PAVEMENT REPAIRS

SCALE  
DRAWING No.  
2015024-1  
SHEET No.  
1 OF 27

© COLONY ESSEX MANCHESTER CONCRETE PAVEMENT REPAIR; BID No. 4396; 2015024

S:\Project Management\Design\2015024\_Colony Essex Manchester\Plan Production\Primary\2015024COV.dwg - Plot Date: 6/18/2015 9:08:17 PM - \_a2\_standard\_bw.stb

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VICINITY MAP

**PROJECT MANAGEMENT SERVICE UNIT**

PREPARED UNDER THE SUPERVISION OF

*David Arthur Dykman*  
DAVID ARTHUR DYKMAN, P.E. - MI LICENSE No. 52912  
PROJECT MANAGER

6/18/2015  
DATE

**CONSTRUCTION NOTES:**

- Driveways and entrances to buildings, real property, and the like shall not be blocked unless approved by the Engineer. Vehicular and pedestrian access shall be maintained at all times. It shall be the Contractor's responsibility to coordinate all necessary driveway closures with the property owner(s) and resident(s) in the areas of construction.
- The location and depth of all existing utilities and service leads are to be field verified by the Contractor prior to construction.
- Location and depth of utilities as depicted on the plans is approximate and shown according to the best information available. It is the Contractor's responsibility to excavate ahead and adjust depth of conflict utilities accordingly. Any damage to utilities is the Contractor's responsibility to avoid and/or repair as necessary.
- "No Parking" signs shall be installed by the Contractor at locations as approved or directed by the Engineer. All signs shall be installed in accordance with the detailed specification.
- Postal delivery and refuse pickup service shall be maintained at all times by the Contractor.
- All curb, sidewalk, driveway approach removals shall be approved by Engineer before the work is done.
- The location of material stock piles and on-site staging areas to be approved by the Engineer.
- All structures within concrete pavement repairs areas shall receive new castings as directed by the Engineer, as specified on the standard casting schedule. The existing castings are the property of the City of Ann Arbor. The Contractor shall deliver to City of Ann Arbor Field Operations and Maintenance Facility at the W.R. Wheeler Service Center located at 4251 Stone School Road.
- Payment for drainage structure sumps, where specified, shall be included in the payment for the various drainage structure sizes and or types.
- Where sewer pipes of different sizes or materials are joined, Fernco flexible couplings with stainless steel shear rings shall be used. The Contractor's purchase price for these devices, including shipping, shall be paid as an extra. Prior to payment for this item, the Contractor shall submit receipts for the Engineer's review and approval. All other costs associated with the installation of these devices shall be included in the payment for the sewer.
- Existing street name, guide, and regulatory signs, and mailboxes which conflict with the proposed construction shall be removed prior to construction, stored in a manner which will prevent damage, and re-set in locations as directed by the Engineer. This work will not be paid for separately, but shall be included in "General Conditions."

SOIL EROSION & SEDIMENT CONTROL GENERAL NOTES:

NOTIFY THE CITY OF ANN ARBOR SOIL EROSION CONTROL OFFICE 48 HOURS PRIOR TO BEGINNING WORK ON THE PROJECT. PHONE: 734-794-6265.

- THE CONTRACTOR SHALL IMPLEMENT AND MAINTAIN SOIL EROSION CONTROL MEASURES AS DIRECTED BY THE ENGINEER AT ALL TIMES DURING CONSTRUCTION. ANY MODIFICATIONS OR ADDITIONS TO THE SOIL EROSION CONTROL MEASURES DUE TO CONSTRUCTION OR CHANGED CONDITIONS SHALL BE AS DIRECTED AND APPROVED BY THE ENGINEER.
- ALL SOIL EROSION AND SEDIMENTATION CONTROL WORK SHALL CONFORM TO THE PERMIT REQUIREMENTS OF THE CITY OF ANN ARBOR, CITY ORDINANCE CHAPTER 63, CITY OF ANN ARBOR STANDARDS DIVISION VII, THE LAWS OF THE STATE OF MICHIGAN, AND THE REQUIREMENTS OF THE CONTRACT DOCUMENTS.
- DAILY, OR AFTER ANY STORM EVENT, INSPECTIONS OF EROSION CONTROL MEASURES SHALL BE MADE BY THE CONTRACTOR. PERIODIC INSPECTIONS MAY BE MADE BY THE ENGINEER TO DETERMINE THE EFFECTIVENESS OF EROSION AND SEDIMENTATION CONTROL MEASURES. ANY NECESSARY CORRECTIONS SHALL BE MADE WITHOUT DELAY, AND WITHOUT ADDITIONAL COST TO THE CITY OF ANN ARBOR.
- EROSION AND SEDIMENTATION FROM WORK ON THE SITE SHALL BE CONTAINED ON THE SITE AND NOT BE ALLOWED TO COLLECT ON ANY OFF-SITE AREAS, ROADWAYS OR WATERWAYS.
- ALL MUD/DIRT TRACKED ONTO ROADWAYS FROM THE SITE DUE TO CONSTRUCTION, SHALL BE PROMPTLY REMOVED BY THE CONTRACTOR. IF SO ORDERED, THE CONTRACTOR SHALL PROVIDE AND OPERATE A VACUUM-TYPE STREET SWEEPER, AT NO ADDITIONAL COST TO THE CITY OF ANN ARBOR, WITHIN FOUR (4) HOURS OF BEING SO ORDERED.
- RESTORATION OF ALL DISTURBED AREAS, INCLUDING PLACEMENT OF TOPSOIL, SEED, FERTILIZER AND MULCH AND/OR SOD SHALL BE PERFORMED WITHIN FIVE (5) DAYS OF THE COMPLETION OF FINAL GRADE.
- CONSTRUCTION OPERATIONS SHALL BE SCHEDULED AND PERFORMED SO THAT PREVENTATIVE SOIL EROSION CONTROL MEASURES ARE IN PLACE PRIOR TO EXCAVATION IN CRITICAL AREAS AND TEMPORARY STABILIZATION MEASURES ARE IN PLACE IMMEDIATELY FOLLOWING BACKFILLING OPERATIONS.
- SPECIAL PRECAUTIONS WILL BE TAKEN IN THE USE OF CONSTRUCTION EQUIPMENT TO PREVENT SITUATIONS THAT PROMOTE EROSION.
- PROPER DUST CONTROL SHALL BE MAINTAINED DURING CONSTRUCTION BY USE OF WATER TRUCKS AND/OR DUST PALLIATIVE AS REQUIRED.
- THE CONTRACTOR SHALL BE RESPONSIBLE FOR MAINTAINING ALL TEMPORARY SOIL EROSION CONTROL MEASURES AND REMOVAL OF SOME MEASURES UPON AUTHORIZED COMPLETION OF THE PROJECT. FINAL COMPLETION OF PROJECT WILL NOT BE AUTHORIZED UNTIL ALL SITE WORK AND UTILITY CONSTRUCTION IS COMPLETE AND ALL SOILS ARE STABILIZED.
- THE CONTRACTOR SHALL NOT GRADE INTO ADJACENT PROPERTIES. SILT AND PROTECTIVE FENCE SHALL BE INSTALLED AND MAINTAINED TO PREVENT GRADING, EROSION AND SEDIMENTATION INTO THE ADJACENT PROPERTIES.
- TREE PROTECTION FENCING MUST REMAIN INTACT UNTIL RESTORATION OF THE SITE IS COMPLETE.

SEQUENCE OF EROSION CONTROL MEASURES:

- THE CONTRACTOR IS TO SUBMIT TO THE ENGINEER, A SEQUENCE OF CONSTRUCTION WITH RESPECT TO THE SOIL EROSION CONTROL MEASURES FOR REVIEW, COMMENT AND APPROVAL. THIS SCHEDULE IS TO INCLUDE INSPECTION AND REPAIR OF ALL TEMPORARY EROSION CONTROL MEASURES DAILY AND WITHIN 24 HOURS OF A STORM EVENT.

SAMPLE SOIL EROSION AND SEDIMENTATION CONTROL INSTALLATION MINIMUM REQUIREMENTS:

- INSTALL SILT FENCE, TREE PROTECTION FENCING, AND INLET FILTERS ON EXISTING DRAINAGE FEATURES PRIOR TO ANY CLEARING OR EARTH MOVING OPERATION.
- STRIP AND STOCKPILE TOPSOIL. STABILIZE STOCKPILE AS REQUIRED.
- INSTALL WATER MAINS, STORM AND SANITARY SEWERS, AND OTHER ENCLOSED DRAINAGE FEATURES. NEW INLET FILTERS SHALL BE INSTALLED IMMEDIATELY FOLLOWING INSTALLATION OF NEW DRAINAGE INLETS.
- PERFORM MACHINE GRADING OPERATIONS AND CONSTRUCT PAVEMENTS (MAINLINE, SIDEWALKS, DRIVES, ETC.).
- CONTINUALLY MAINTAIN EROSION AND SEDIMENTATION CONTROL MEASURES, AS REQUIRED TO ALLOW DRAINAGE AND SEDIMENT REMOVAL. REMOVE ANY ACCUMULATED SEDIMENT IMMEDIATELY.
- COMPLETE ALL GRADING AND FINE GRADING.
- TEMPORARY SEED AND INSTALL EROSION CONTROL BLANKET IN ALL DISTURBED AREAS.
- CLEAN OUT STORM SEWER SYSTEMS.
- REMOVE ALL TEMPORARY SOIL EROSION CONTROL MEASURES UPON FINAL INSPECTION AND APPROVAL BY THE ENGINEER.
- REMEDY ANY NOTED DEFECTS TO THE SATISFACTION OF THE CITY OF ANN ARBOR'S SOIL EROSION AND SEDIMENTATION CONTROL OFFICIAL.

NOTE: THIS SEQUENCE IS FOR INFORMATION ONLY. IT IS INTENDED TO SHOW THE SEQUENCE OF CONSTRUCTION WITH RESPECT TO THE SOIL EROSION AND SEDIMENTATION CONTROL MEASURES. THE CONTRACTOR IS RESPONSIBLE FOR SUBMITTING THEIR OWN DETAILED CONSTRUCTION SEQUENCE AND SCHEDULE TO THE ENGINEER FOR REVIEW, COMMENT, AND APPROVAL.

TEMPORARY SEEDING:

- SEED IN ACCORDANCE WITH PROJECT DRAWINGS AND SPECIFICATIONS.
- ANY DISTURBED AREA NOT PAVED, SEEDED, MULCHED, SODDED OR BUILT UPON BY NOVEMBER 15TH OR JUNE 30TH IS TO BE TEMPORARILY STABILIZED PER SPECIFICATIONS.

TREE PROTECTION

- CONTRACTOR SHALL NOT STORE OR PLACE EQUIPMENT AND/OR MATERIALS INSIDE DRIP LINE OF ANY CITY TREE. MECHANICAL DAMAGE TO CITY OWNED TREES (I.E. BARK DAMAGE, BRANCH BREAKAGE) IS NOT PERMITTED. CONTRACTOR IS RESPONSIBLE FOR PROPERLY PRUNING TREES TO PREVENT DAMAGE. IF BRANCHES GREATER THAN 2" IN DIAMETER REQUIRE PRUNING, CONTRACTOR TO CONTACT FORESTRY FOR CONSULTATION AND EVALUATION AT (734) 794-6350. NO ROOTS OF CITY-OWNED TREES GREATER THAN 2 INCHES IN DIAMETER ARE TO BE CUT. IF CONTRACTOR ENCOUNTERS CITY-OWNED TREES WITH ROOTS GREATER THAN 2 INCHES IN DIAMETER THAT THEY DETERMINE NEED TO BE CUT, CONTACT FORESTRY IMMEDIATELY FOR EVALUATION. ALL TRENCHING AND BORE PITS OF ANY KIND SHALL BE CLEAR OF TREE DRIP LINES. IF ANY CITY-OWNED STREET TREES ARE DAMAGED BY THIS WORK, THE CONTRACTOR MUST CONTACT FORESTRY AS SOON AS POSSIBLE SO THAT THE DAMAGE CAN BE ASSESSED. CONTRACTOR WILL BE RESPONSIBLE FOR ALL COSTS ASSOCIATED WITH DAMAGE REMEDIATION.

**EXISTING LEGEND**

	FIRE HYDRANT		WATER MAIN
	GATE VALVE IN BOX		STORM SEWER
	GATE VALVE IN WELL		SANITARY SEWER
	STOP BOX		GAS MAIN
	WATER VAULT		ELECTRICAL OVER HEAD
	WELL		ELECTRICAL UNDER GROUND
	CATCH BASIN (SQ)		BOUNDARY
	CATCH BASIN (RD)		BUILDING
	STORM MANHOLE		CENTERLINE OF DITCH
	NON-CURB CATCH BASIN (SQ)		CENTERLINE/CROWN OF ROAD
	SANITARY MANHOLE		EDGE OF WATER
	CLEAN-OUT		FENCE
	POST		GRAVEL
	PEDESTRIAN SIGNAL		STONE WALL
	SIGN		R.O.W.
	HAND HOLE		TREELINE
	ORNAMENTAL LIGHT		WETLAND
	FLOOD LIGHT		TREE (DECIDUOUS)
	UNKNOWN MANHOLE		TREE (CONIFEROUS)
	TELEPHONE MANHOLE		STUMP
	TELEPHONE RISER		SHRUB (DECIDUOUS)
	GAS VALVE		
	GAS VENT		
	GAS BOX		
	ELECTRICAL RISER		
	TRANSFORMER		
	UTILITY POLE		
	LAMP POLE		
	GUY ANCHOR		
	GUY POLE		
	MONITORING WELL		
	MAILBOX		
	SOIL BORING		
	TRAVERSE POINT		
	BENCH MARK		
	IRON PIPE		
	MON BOX		

**PROPOSED LEGEND**

	HYDRANT (PLAN)		WATER MAIN
	WATER GATE WELL		STORM SEWER
	REDUCER		SANITARY SEWER
	WATER GATE VALVE		CENTERLINE OF DITCH
	WATER STOP BOX		CENTERLINE OF ROAD
	WATER VAULT		FENCE
	INLET		SILT FENCE
	DOUBLE INLET		LOT/UNIT
	INLET JUNCTION CHAMBER		CURB
	ROUND CATCH BASIN		TEMPORARY GRADING PERMIT
	STORM MANHOLE		WATER EASEMENT
	DRAIN ARROW		STORM EASEMENT
	FLARED END SECTION		SANITARY EASEMENT
	SANITARY MANHOLE		R.O.W.
	CLEAN-OUT		LIMITS OF CONSTRUCTION
	BARREL		STONE WALL
	SIGN		DETECTABLE WARNING
	PUSH BUTTON		ASPHALT
			CONCRETE
			SIDEWALK
			TREE (DECIDUOUS)
			TREE (CONIFEROUS)

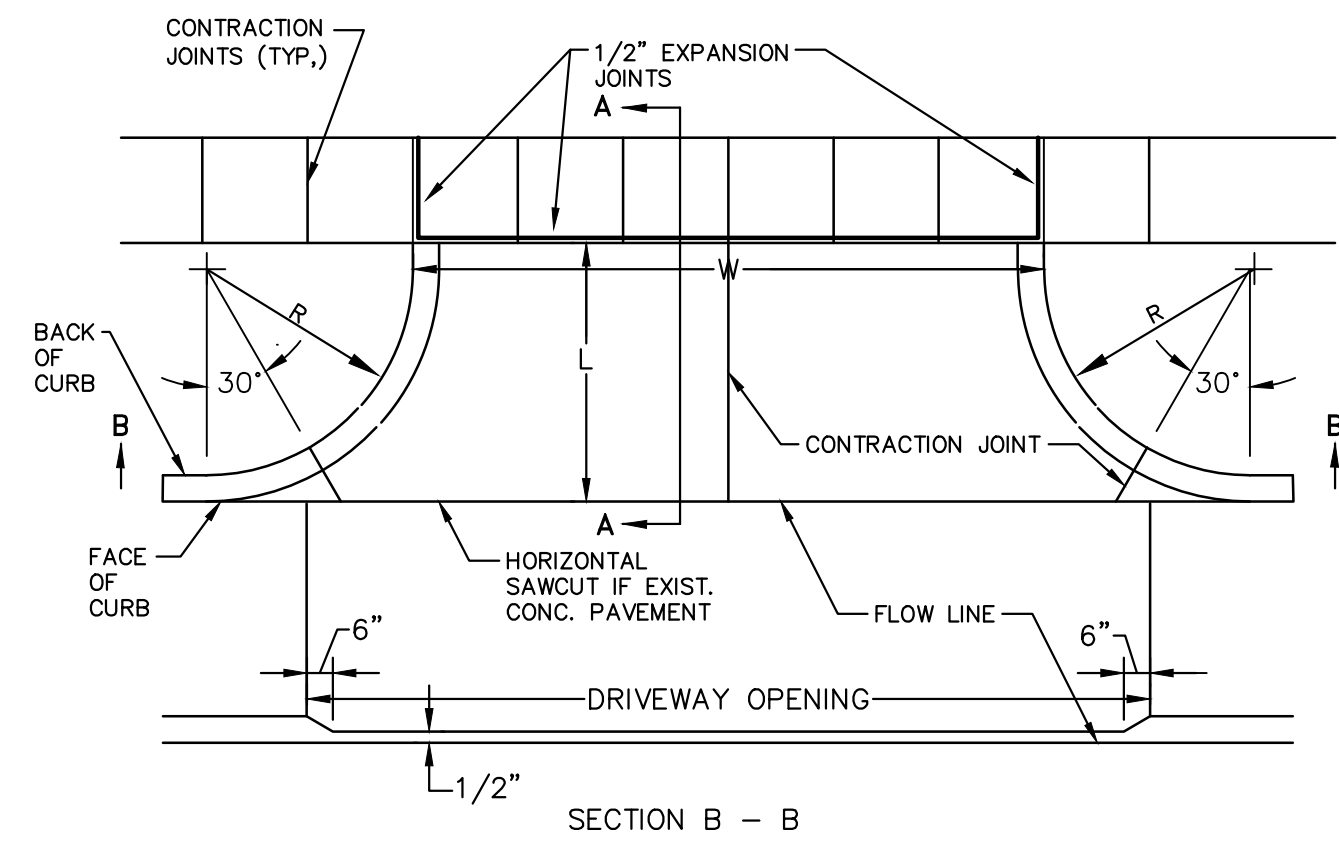
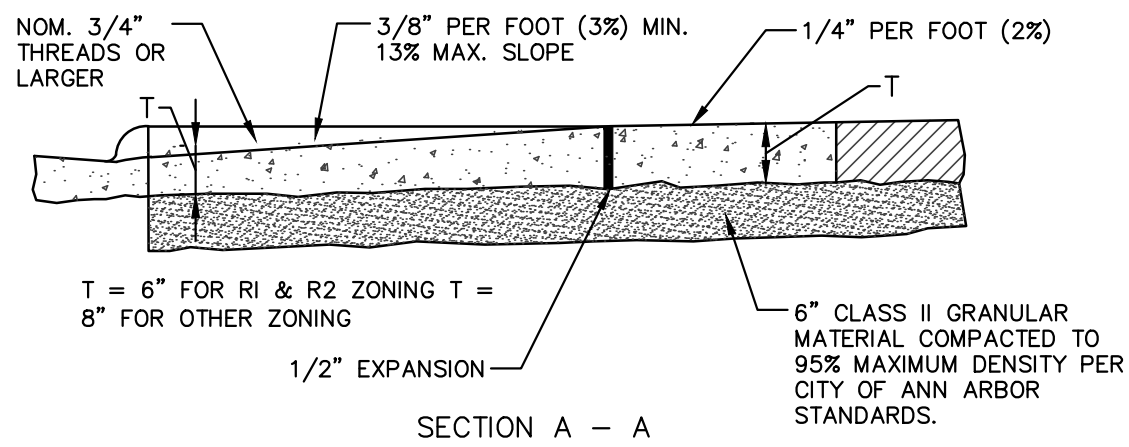
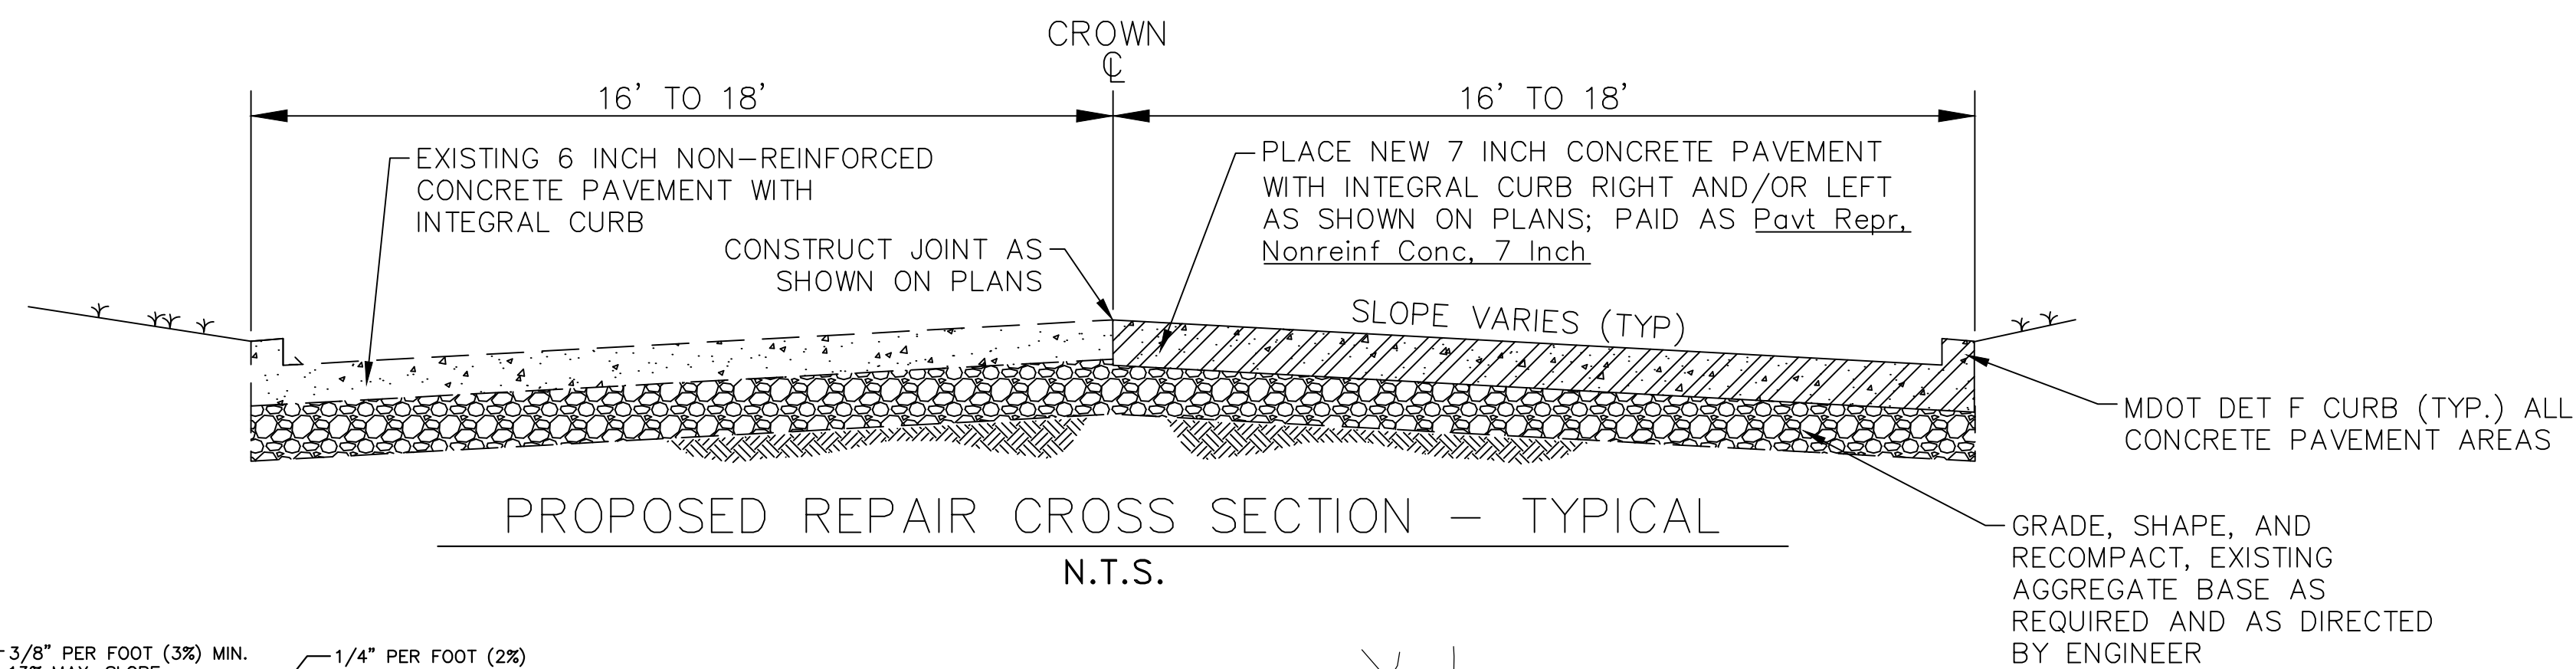
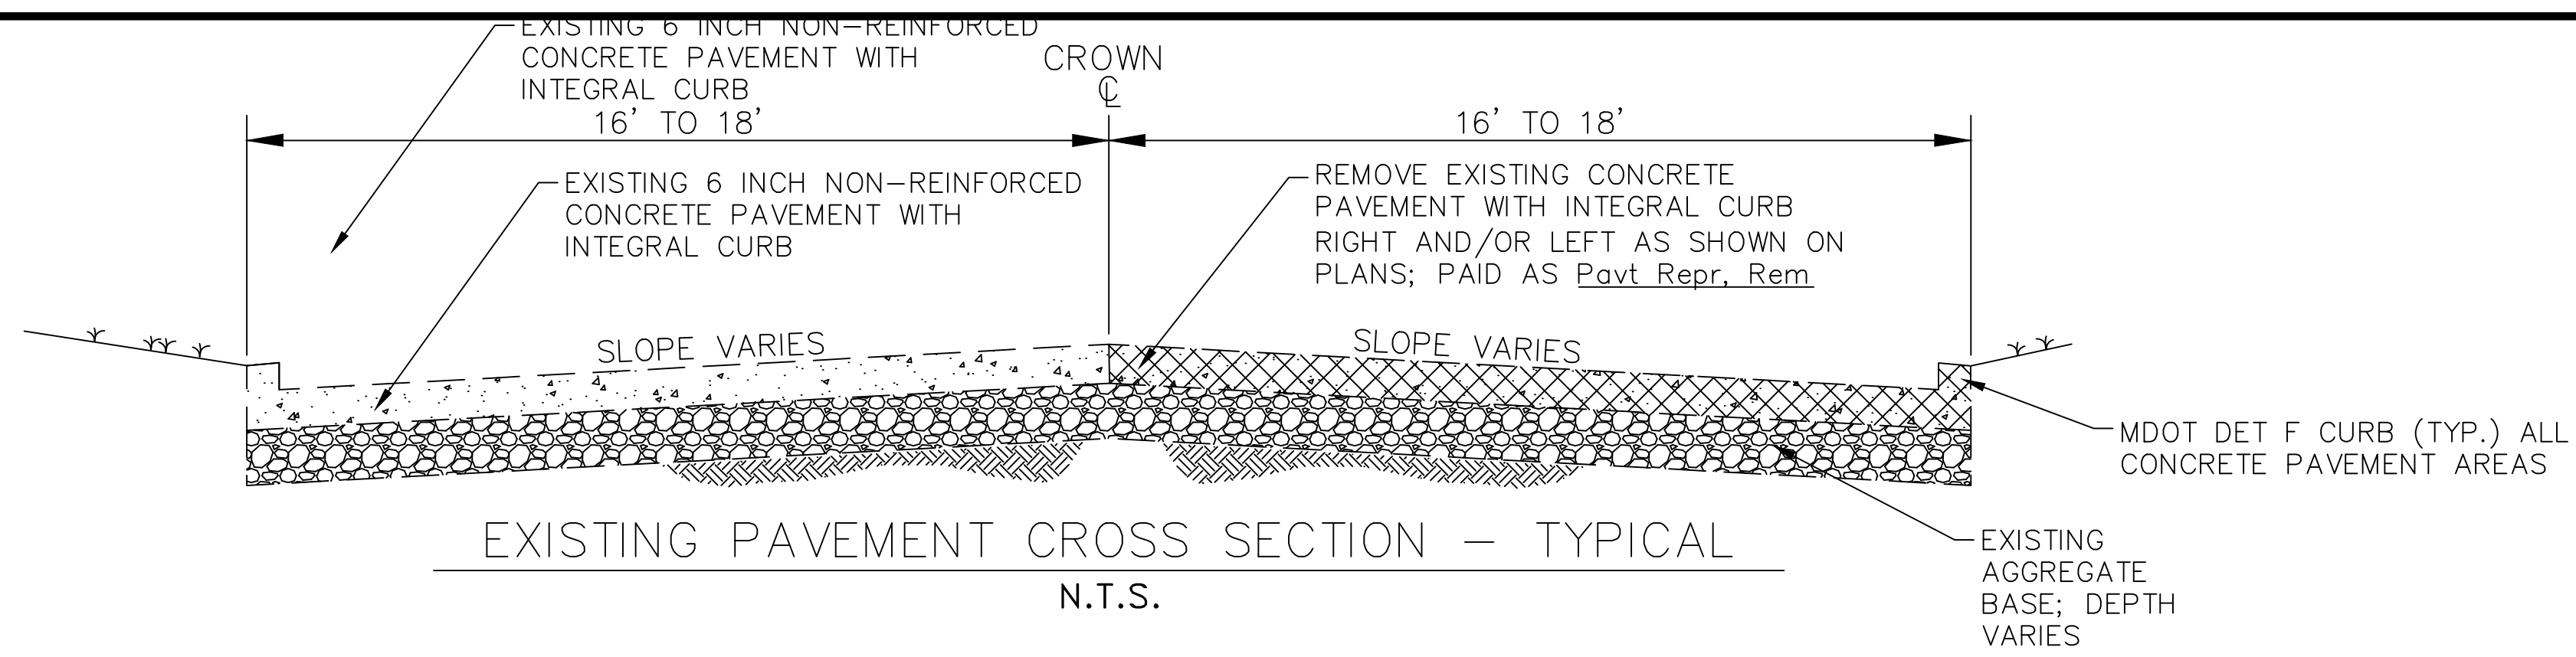
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**CITY OF ANN ARBOR PUBLIC SERVICES**  
 301 EAST HURON STREET  
 P.O. BOX 8667  
 ANN ARBOR, MI 48107-8667  
 www.aagov.org

**PROJECT MANAGEMENT - PUBLIC SERVICES - CITY OF ANN ARBOR**  
**COLONY ESSEX MANCHESTER**  
**CONCRETE PAVEMENT REPAIR**  
 NOTES AND LEGEND

SCALE PLAN: #####  
 DRAWING No. 2015024-2  
 SHEET No. 2 OF 27

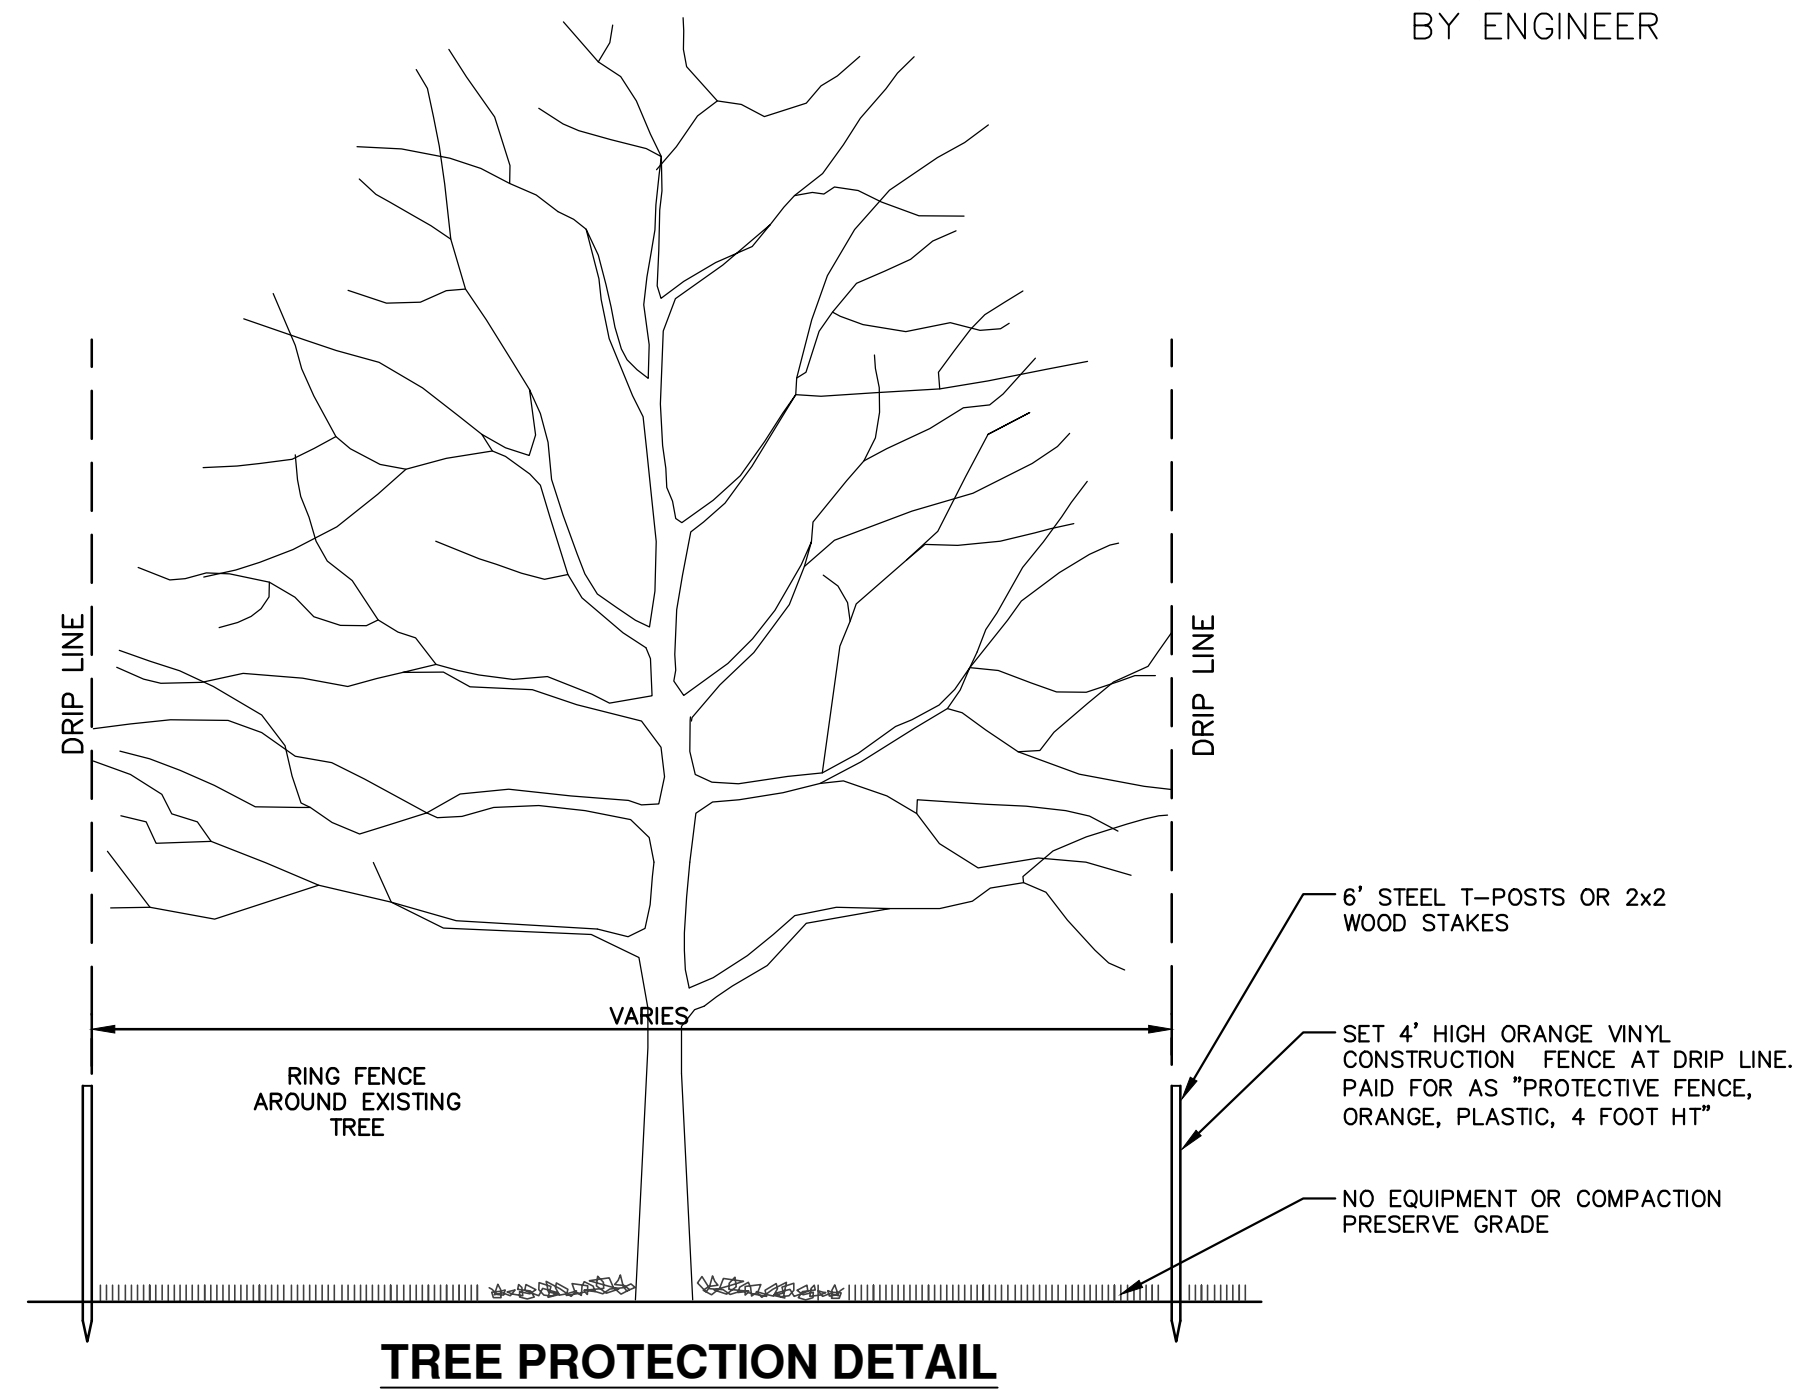
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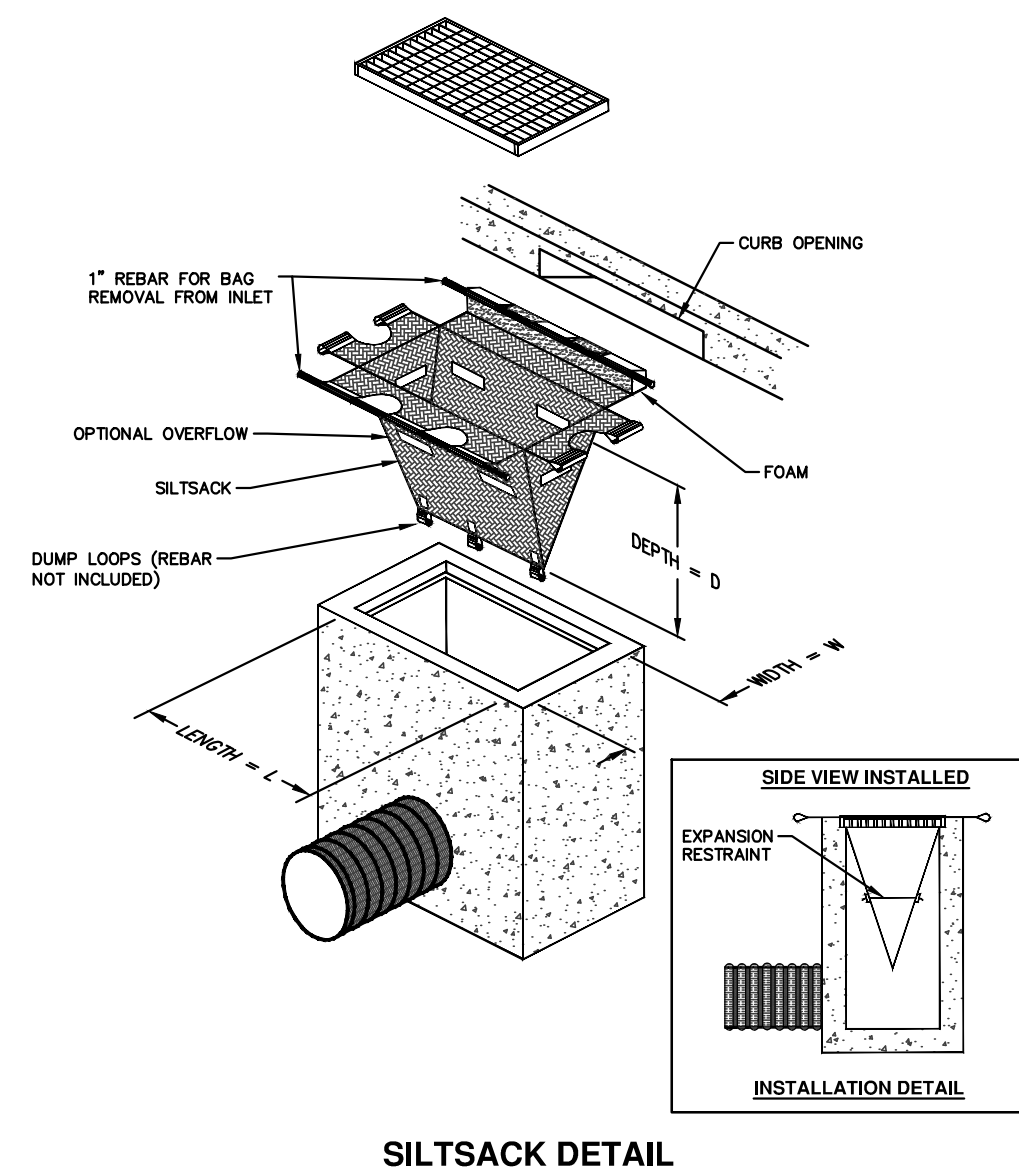
MEASUREMENT OF AREA:  
W x L = AREA

NOTE: R(RADIUS) AND W(DRIVE WIDTH) AS REQUIRED FOR ZONING BY CITY CODE.  
NOTE: DRIVE APPROACH TO BE CLASS 'A' CONCRETE.

**DRIVEWAY OPENING/APPROACH DETAIL**



CONTRACTOR SHALL NOT STORE OR PLACE EQUIPMENT AND/OR MATERIALS INSIDE DRIP LINE OF ANY CITY TREE. MECHANICAL DAMAGE TO CITY OWNED TREES (I.E. BARK DAMAGE, BRANCH BREAKAGE) IS NOT PERMITTED. CONTRACTOR IS RESPONSIBLE FOR PROPERLY PRUNING TREES TO PREVENT DAMAGE. IF BRANCHES GREATER THAN 2" IN DIAMETER REQUIRE PRUNING, CONTRACTOR TO CONTACT FORESTRY FOR CONSULTATION AND EVALUATION AT (734) 794-6350. NO ROOTS OF CITY-OWNED TREES GREATER THAN 2 INCHES IN DIAMETER ARE TO BE CUT. IF CONTRACTOR ENCOUNTERS CITY-OWNED TREES WITH ROOTS GREATER THAN 2 INCHES IN DIAMETER THAT THEY DETERMINE NEED TO BE CUT, CONTACT FORESTRY IMMEDIATELY FOR EVALUATION. ALL TRENCHING AND BORE PITS OF ANY KIND SHALL BE CLEAR OF TREE DRIP LINES. IF ANY CITY-OWNED STREET TREES ARE DAMAGED BY THIS WORK, THE CONTRACTOR MUST CONTACT FORESTRY AS SOON AS POSSIBLE SO THAT THE DAMAGE CAN BE ASSESSED. CONTRACTOR WILL BE RESPONSIBLE FOR ALL COSTS ASSOCIATED WITH DAMAGE REMEDIATION.



NOTE: THE SILTSACK WILL BE MANUFACTURED FROM A WOVEN POLYPROPYLENE FABRIC THAT MEETS OR EXCEEDS THE FOLLOWING SPECIFICATIONS.

**REGULAR FLOW SILTSACK**

(FOR AREAS OF LOW TO MODERATE PRECIPITATION AND RUN-OFF)

PROPERTIES	REQUIRED VALUE	TEST METHOD
GRAB TENSILE STRENGTH	ASTM D-4632	300 LBS
GRAB TENSILE ELONGATION	ASTM D-4632	20%
PUNCTURE	ASTM D-4833	130 LBS
MULLEN BURST	ASTM D-3786	800 PSF
TRAPEZOID TEAR	ASTM D-4533	150 LBS
UV RESISTANCE	ASTM D-4355	80%
APPARENT OPENING SIZE	ASTM D-4751	40 US SIEVE
FLOW RATE	ASTM D-4491	40 GAL/MIN/SQ FT
PERMITTIVITY	ASTM D-4491	0.55 SEC -1

**HI-FLOW SILTSACK**

(FOR AREAS OF MODERATE TO HEAVY PRECIPITATION AND RUN-OFF)

PROPERTIES	REQUIRED VALUE	TEST METHOD
GRAB TENSILE STRENGTH	ASTM D-4632	265 LBS
GRAB TENSILE ELONGATION	ASTM D-4632	20%
PUNCTURE	ASTM D-4833	135 LBS
MULLEN BURST	ASTM D-3786	420 PSF
TRAPEZOID TEAR	ASTM D-4533	45 LBS
UV RESISTANCE	ASTM D-4355	90%
APPARENT OPENING SIZE	ASTM D-4751	20 US SIEVE
FLOW RATE	ASTM D-4491	200 GAL/MIN/SQ FT
PERMITTIVITY	ASTM D-4491	1.5 SEC-1

**OIL-ABSORBANT SILTSACK**

(FOR AREAS WHERE THERE IS A CONCERN FOR OIL RUN-OFF OR SPILLS)

IT IS THE INTENT OF THE PLANS AND SPECIFICATIONS THAT THE CONTRACTOR INSTALL THE REBAR AS SHOWN IN THIS DETAIL TO PROVIDE A FULLY FUNCTIONING UNIT. ALL COSTS ASSOCIATED WITH FURNISHING, CLEANING AS MANY TIMES AS REQUIRED, DISPOSAL OF SEDIMENT, AND REMOVING THE INLET FILTER WHEN NO LONGER NEEDED IS INCLUDED IN THE ITEM OF WORK AND WILL NOT BE PAID FOR SEPARATELY.

**PERMITS REQUIRED TO BE OBTAINED BY THE CONTRACTOR PRIOR TO THE BEGINNING OF CONSTRUCTION.**

PERMIT	ISSUING AUTHORITY
LANE CLOSURE PERMIT	CITY OF ANN ARBOR PROJECT MANAGEMENT UNIT
"NO PARKING" SIGNS PERMIT	CITY OF ANN ARBOR PROJECT MANAGEMENT UNIT
RIGHT-OF-WAY PERMIT	CITY OF ANN ARBOR CUSTOMER SERVICE
* NO COST TO CONTRACTOR	

**CONTACT INFORMATION**

PUBLIC UTILITIES	OWNER	CONTACT
WATER		DAN WOODEN (734) 794-6350
SANITARY		MARK COZART (734) 794-6350
STORM	CITY OF ANN ARBOR FIELD OPERATIONS SERVICE UNIT W.R. WHEELER SERVICE CENTER 4251 STONE SCHOOL ROAD ANN ARBOR, MI 48108	KEVIN ERNST (734) 794-6350
FORESTRY		STEVEN GOEBEL (734) 794-6350
SIGNS SIGNALS STREET LIGHTS		CHUCK FOJTIK (734) 794-6361
PRIVATE UTILITIES	OWNER	CONTACT
GAS	DTE ENERGY 3150 E. MICHIGAN AVE, YPSILANTI TOWNSHIP, MI 48198	ROBERT CZAPIEWSKI (734) 544-7818
ELECTRIC	DTE ENERGY WESTERN WAYNE SERVICE CENTER 8001 HAGGERTY ROAD BELLEVILLE, MI 48111	CLAY COMBEE (734) 397-4112
CABLE	COMCAST 27800 FRANKLIN ROAD SOUTHFIELD, MI 48034	RON SUTHERLAND (313) 999-8300
PHONE	AT&T 550 S. MAPLE ROAD ANN ARBOR, MI 48103	(734) 996-2135
FIBER OPTIC	MCI 2800 N. GLENFILLE ROAD RICHARDSON, TX 75082	DEAN BOYERS (972) 729-6016

**811**  
Know what's below.  
Call before you dig.

DATE	DESCRIPTION	REV.

CITY OF ANN ARBOR  
PUBLIC SERVICES  
301 EAST HURON STREET  
ANN ARBOR, MI 48106  
734-794-4410  
www.a2gov.org

**PROJECT MANAGEMENT - PUBLIC SERVICES - CITY OF ANN ARBOR**

**COLONY ESSEX MANCHESTER  
CONCRETE PAVEMENT REPAIR**

TYPICAL SECTIONS AND DETAILS

SCALE PLAN: #####

DRAWING No. 2015024-3

SHEET No. 3 OF 27

**SYMBOL (Cp) AND (C3p)**

SYMBOL	LOAD TRANSFER	JOINT USE
(Cp)	YES	PAVEMENT
(C3p)	NO	SHOULDER

**SYMBOL (W)**

**SYMBOL (E2), (E3) AND (E4)**

**SYMBOL (H)**

**SYMBOL (H)**

**SYMBOL (B)**

**SYMBOL (D) AND (S)**

**SYMBOL (L2)**

**SYMBOL (H)**

**SYMBOL (L2)**

**SYMBOL (H)**

**TRANSVERSE AND INTERSECTION PLANE OF WEAKNESS JOINTS**

DEPARTMENT DIRECTOR: *John T. Stouck*  
 PREPARED BY: *John C. Frazee*  
 DESIGN DIVISION: *John C. Frazee*  
 CHECKED BY: *John C. Frazee*

MICHIGAN DEPARTMENT OF TRANSPORTATION  
 BUREAU OF HIGHWAY DEVELOPMENT STANDARD PLAN FOR  
**TRANSVERSE PAVEMENT JOINTS (PLAIN CONCRETE PAVEMENT)**

9-10-2010 8-9-2010 R-39-1 SHEET 1 OF 4

**SYMBOL (B)**

**LONGITUDINAL BULKHEAD JOINT - SYMBOL (B)**

ALL SYMBOL (B) JOINTS SHALL BE SAWS AND SEALED EXCEPT JOINTS WITHOUT LANE TIES AND JOINTS PARALLEL TO VERTICAL FACES WHICH WOULD PROHIBIT SAWING.

**SYMBOL (D) AND (S)**

**LONGITUDINAL LANE TIE JOINT - SYMBOL (D)**  
**LONGITUDINAL SMOOTH LANE TIE JOINT - SYMBOL (S)**

MAXIMUM ALLOWABLE LANE TIE SPACING (SYMBOLS (B), (D), (L2), AND (S))	GRADE 40	GRADE 50
1'-11"	1'-7"	12" OR LESS
1'-5"	1'-3"	OVER 12" THROUGH 17"
1'-2"	1'-1"	OVER 17" THROUGH 24"
1'-0"	1'-0"	OVER 24" THROUGH 36"
1'-0"	1'-0"	36" OR GREATER

**MAXIMUM ALLOWABLE LANE TIE SPACING**

DEPARTMENT DIRECTOR: *John T. Stouck*  
 PREPARED BY: *Randy V. Poff*  
 DESIGN DIVISION: *Randy V. Poff*  
 CHECKED BY: *Randy V. Poff*

MICHIGAN DEPARTMENT OF TRANSPORTATION  
 BUREAU OF HIGHWAY DEVELOPMENT STANDARD PLAN FOR  
**LONGITUDINAL PAVEMENT JOINTS**

9-30-2014 4-22-2013 R-41-H SHEET 1 OF 2

**SYMBOL (E2), (E3) AND (E4)**

NOTE: THE FINAL WIDTH OF THE GROOVE SHALL BE 1" ± 1/4" PLUS ANY INCREASE OR MINUS ANY DECREASE IN THE WIDTH OF THE RELIEF CUT. THE FINAL SAW CUT SHALL BE TO THE TOP OF THE FIBER FILLER WITH A MINIMUM DEPTH AS SHOWN AND SHALL BE CENTERED OVER THE FIBER FILLER WITH A HORIZONTAL TOLERANCE OF 1/4". FIBER FILLER FOR EXPANSION JOINTS IN CONCRETE SHOULDERS SHALL BE FREE OF HOLES OR OTHER DEFECTS AND TRIMMED TO FIT SHOULDER CONFIGURATIONS.

SYMBOL	LOAD TRANSFER ASSEMBLY	JOINT USE
(E2)	YES	PAVEMENT
(E3)	NO	PAVEMENT & SHOULDER
(E4)	NO	SHOULDER

**SYMBOL (H)**

**TRANSVERSE END OF POUR JOINT (SPLIT HEADER METHOD)**

**SYMBOL (H)**

**TRANSVERSE END OF POUR JOINT (PLASTIC TUBE METHOD)**

DEPARTMENT DIRECTOR: *John T. Stouck*  
 PREPARED BY: *John C. Frazee*  
 DESIGN DIVISION: *John C. Frazee*  
 CHECKED BY: *John C. Frazee*

MICHIGAN DEPARTMENT OF TRANSPORTATION  
 BUREAU OF HIGHWAY DEVELOPMENT STANDARD PLAN FOR  
**TRANSVERSE PAVEMENT JOINTS (PLAIN CONCRETE PAVEMENT)**

9-10-2010 8-9-2010 R-39-1 SHEET 2 OF 4

**SYMBOL (L2)**

**LONGITUDINAL BULKHEAD JOINT**

**METHOD OF EDGING**

NOTE: THE FIRST SLAB SHALL BE EDGED WITH AN EDGING MACHINE HAVING A 1" LIP AND A RADIUS OF 1/4" TO 1/2".

NOTE: ALL LANE TIE BARS SHALL BE DEFORMED EXCEPT SYMBOL (S) WHICH WILL BE SMOOTH.

NOTE: THE EPXY COATED S BARS ARE TO BE FACTORY COATED WITH AN APPROVED BOND RELEASE AGENT, UNIFORMLY APPLIED BY DIPPING AND WITHOUT EXCESSIVE DROPS OR THICKNESS.

NOTE: THE INSTALLATION OF LANE TIE BARS AND THE SAWING OF LONGITUDINAL JOINTS WILL NOT BE REQUIRED FOR TEMPORARY CONCRETE PAVEMENT UNLESS SPECIFIED ON PLANS OR IN THE PROPOSAL. THE EDGING OF TEMPORARY CONCRETE PAVEMENT WILL NOT BE REQUIRED.

NOTE: FOR JOINT LAYOUT DETAILS, SEE STANDARD PLAN R-42-SERIES.

NOTE: SAWING PROCEDURES AND RELATED OPERATIONS ARE DESCRIBED IN THE CURRENT STANDARD SPECIFICATIONS.

NOTE: NO SAWS OR SEALED JOINT SHALL BE CONSTRUCTED BETWEEN THE PAVEMENT AND CURB OR PAVEMENT AND SHOULDER, WHERE THESE ITEMS ARE CAST INTERSECTINGLY.

NOTE: WHEN JOINTED PLAIN CONCRETE IS SPECIFIED AT INTERSECTIONS, SYMBOL (S) JOINTS ARE TO BE USED FOR THE LONGITUDINAL JOINT BETWEEN THE E2 JOINT AT THE SPRINGLINE OF THE SIDE STREET AND THE THROUGH LANE GUTTER PAN LINE. WHEN THE E2 JOINT IS MOVED TO THE THROUGH LANE GUTTER PAN LINE, SYMBOL (D) JOINT AS NORMALLY REQUIRED.

DEPARTMENT DIRECTOR: *John T. Stouck*  
 PREPARED BY: *Randy V. Poff*  
 DESIGN DIVISION: *Randy V. Poff*  
 CHECKED BY: *Randy V. Poff*

MICHIGAN DEPARTMENT OF TRANSPORTATION  
 BUREAU OF HIGHWAY DEVELOPMENT STANDARD PLAN FOR  
**LONGITUDINAL PAVEMENT JOINTS**

9-30-2014 4-22-2013 R-41-H SHEET 2 OF 2

**SYMBOL (H)**

**TRANSVERSE END OF POUR JOINT (SPLIT HEADER METHOD)**

**SYMBOL (H)**

**TRANSVERSE END OF POUR JOINT (PLASTIC TUBE METHOD)**

DEPARTMENT DIRECTOR: *John T. Stouck*  
 PREPARED BY: *John C. Frazee*  
 DESIGN DIVISION: *John C. Frazee*  
 CHECKED BY: *John C. Frazee*

MICHIGAN DEPARTMENT OF TRANSPORTATION  
 BUREAU OF HIGHWAY DEVELOPMENT STANDARD PLAN FOR  
**TRANSVERSE PAVEMENT JOINTS (PLAIN CONCRETE PAVEMENT)**

9-10-2010 8-9-2010 R-39-1 SHEET 3 OF 4

**SYMBOL (H)**

**INTEGRAL CURB & GUTTER**

**SECTION A - A INTEGRAL CURB & GUTTER, DETAIL B**

**SECTION A - A INTEGRAL CURB & GUTTER, DETAIL C**

**SECTION A - A INTEGRAL CURB & GUTTER, DETAIL D**

**SECTION A - A INTEGRAL CURB & GUTTER, DETAIL F**

**SECTION B - B EXPANSION JOINT**

**SECTION B - B CONTRACTION JOINT**

**SECTION C - C INTEGRAL CURB & GUTTER, DETAIL B**

**SECTION C - C INTEGRAL CURB & GUTTER, DETAIL C**

**SECTION C - C INTEGRAL CURB & GUTTER, DETAIL D**

**SECTION C - C INTEGRAL CURB & GUTTER, DETAIL F**

**PLAN AT TRANSVERSE JOINT**

**PLAN IN CATCH BASIN AREA**

NOTE: DETAILS OF CURB FACES ARE SPECIFIED ON STANDARD PLAN R-39-SERIES.

NOTE: WHEN THE CURB PROFILE IS PROVIDED SEPARATE FROM THE INTEGRAL PAVEMENT AND GUTTER, AND DELAY EXCEEDS 30 MINUTES, EPXY COATED ANCHORING BARS SPACED AT 1'-0" CENTER TO CENTER SHALL BE USED TO TIE CURB AND UNDERLYING CONCRETE.

NOTE: AGGREGATE BASE, WHEN SPECIFIED ON TYPICAL CROSS SECTIONS, SHALL EXTEND 2'-0" BEYOND THE BACK OF INTEGRAL CURB AND GUTTER. EVEN IF THE GRADING SECTION MUST BE WIDENED TO DO SO, NO PAVEMENT WILL BE MADE FOR THE ADDITIONAL AGGREGATE BASE THAT IS REQUIRED TO CONSTRUCT THE INTEGRAL CURB AND GUTTER ALTERNATE.

NOTE: TRANSVERSE JOINTS IN THE INTEGRAL CURB SHALL BE AS SPECIFIED ON THIS STANDARD PLAN.

NOTE: FIBER FILLER USED FOR PAVEMENT EXPANSION JOINTS SHALL EXTEND TO BACK OF CURB.

NOTE: CATCH BASIN "COVER B" OR OTHER APPROVED COVERS SHALL BE SUBSTITUTED FOR COVERS SPECIFIED ON THE PLANS ONLY WHEN THE INTEGRAL CURB AND GUTTER ALTERNATE IS USED.

DEPARTMENT DIRECTOR: *John T. Stouck*  
 PREPARED BY: *Randy V. Poff*  
 DESIGN DIVISION: *Randy V. Poff*  
 CHECKED BY: *Randy V. Poff*

MICHIGAN DEPARTMENT OF TRANSPORTATION  
 BUREAU OF HIGHWAY DEVELOPMENT STANDARD PLAN FOR  
**INTEGRAL CURB AND GUTTER**

1-25-2013 10-22-2012 R-31-F SHEET 1 OF 2

**SYMBOL (H)**

**TRANSVERSE END OF POUR JOINT (PLASTIC TUBE METHOD)**

DEPARTMENT DIRECTOR: *John T. Stouck*  
 PREPARED BY: *John C. Frazee*  
 DESIGN DIVISION: *John C. Frazee*  
 CHECKED BY: *John C. Frazee*

MICHIGAN DEPARTMENT OF TRANSPORTATION  
 BUREAU OF HIGHWAY DEVELOPMENT STANDARD PLAN FOR  
**TRANSVERSE PAVEMENT JOINTS (PLAIN CONCRETE PAVEMENT)**

9-10-2010 8-9-2010 R-39-1 SHEET 4 OF 4

**SYMBOL (H)**

**INTEGRAL CURB AND GUTTER**

**SECTION A - A INTEGRAL CURB & GUTTER, DETAIL B**

**SECTION A - A INTEGRAL CURB & GUTTER, DETAIL C**

**SECTION A - A INTEGRAL CURB & GUTTER, DETAIL D**

**SECTION A - A INTEGRAL CURB & GUTTER, DETAIL F**

**SECTION B - B EXPANSION JOINT**

**SECTION B - B CONTRACTION JOINT**

**SECTION C - C INTEGRAL CURB & GUTTER, DETAIL B**

**SECTION C - C INTEGRAL CURB & GUTTER, DETAIL C**

**SECTION C - C INTEGRAL CURB & GUTTER, DETAIL D**

**SECTION C - C INTEGRAL CURB & GUTTER, DETAIL F**

**PLAN AT TRANSVERSE JOINT**

**PLAN IN CATCH BASIN AREA**

NOTE: DETAILS OF CURB FACES ARE SPECIFIED ON STANDARD PLAN R-39-SERIES.

NOTE: WHEN THE CURB PROFILE IS PROVIDED SEPARATE FROM THE INTEGRAL PAVEMENT AND GUTTER, AND DELAY EXCEEDS 30 MINUTES, EPXY COATED ANCHORING BARS SPACED AT 1'-0" CENTER TO CENTER SHALL BE USED TO TIE CURB AND UNDERLYING CONCRETE.

NOTE: AGGREGATE BASE, WHEN SPECIFIED ON TYPICAL CROSS SECTIONS, SHALL EXTEND 2'-0" BEYOND THE BACK OF INTEGRAL CURB AND GUTTER. EVEN IF THE GRADING SECTION MUST BE WIDENED TO DO SO, NO PAVEMENT WILL BE MADE FOR THE ADDITIONAL AGGREGATE BASE THAT IS REQUIRED TO CONSTRUCT THE INTEGRAL CURB AND GUTTER ALTERNATE.

NOTE: TRANSVERSE JOINTS IN THE INTEGRAL CURB SHALL BE AS SPECIFIED ON THIS STANDARD PLAN.

NOTE: FIBER FILLER USED FOR PAVEMENT EXPANSION JOINTS SHALL EXTEND TO BACK OF CURB.

NOTE: CATCH BASIN "COVER B" OR OTHER APPROVED COVERS SHALL BE SUBSTITUTED FOR COVERS SPECIFIED ON THE PLANS ONLY WHEN THE INTEGRAL CURB AND GUTTER ALTERNATE IS USED.

DEPARTMENT DIRECTOR: *John T. Stouck*  
 PREPARED BY: *Randy V. Poff*  
 DESIGN DIVISION: *Randy V. Poff*  
 CHECKED BY: *Randy V. Poff*

MICHIGAN DEPARTMENT OF TRANSPORTATION  
 BUREAU OF HIGHWAY DEVELOPMENT STANDARD PLAN FOR  
**INTEGRAL CURB AND GUTTER**

1-25-2013 10-22-2012 R-31-F SHEET 2 OF 2

**PROJECT MANAGEMENT - PUBLIC SERVICES - CITY OF ANN ARBOR**

**COLONY ESSEX MANCHESTER CONCRETE PAVEMENT REPAIR DETAILS**

SCALE PLAN: #####

DRAWING NO: 2015024-4

SHEET NO. 4 OF 27

CITY OF ANN ARBOR  
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**PLAN OF SAWING DIAGRAM**

THIS METHOD OF REPAIRING DISTRESSED CONCRETE SHALL BE USED IN CONNECTION WITH FULL DEPTH CAST-IN-PLACE REPAIRS LESS THAN 50'-0" LONG AND IS OPTIONAL FOR REPAIRS OVER 50'-0" IN LENGTH.

- THESE SAW CUTS SHALL BE FULL DEPTH AND PERPENDICULAR TO THE EDGE OF THE ROADWAY. WITHIN A TOLERANCE OF 1", NO OVERCUTTING INTO ADJACENT LANES SHALL BE MADE UNLESS THE OVERCUT IS WITHIN THE LIMITS OF A SUBSEQUENT REPAIR TO THE ADJACENT LANE. SHOULDER OVERCUTS WILL BE ALLOWED.
- THIS FULL DEPTH SAW CUT IS MADE TO FACILITATE OPENING A TRENCH ACROSS THE SLAB TO RELIEVE COMPRESSION IN THE PAVEMENT PRIOR TO LIFTING OUT THE FAILED AREA. THIS SAW CUT MAY BE OMITTED PROVIDED NO SPALLING OF THE REMAINING CONCRETE OCCURS. IF SPALLING DOES OCCUR, THE CONTRACTOR WILL BE REQUIRED TO MAKE THIS SAW CUT ON SUBSEQUENT REPAIR. WHEN THIS SAW CUT IS USED AND THE ADJACENT LANE IS NOT REPAIRED, NO OVERCUTTING INTO THAT LANE SHALL BE MADE.
- THIS CONDITIONAL FULL DEPTH SAW CUT IS MADE BETWEEN LANES OR BETWEEN ANY COMBINATION OF THE FOLLOWING: LANE, SHOULDER, CURB, CONCRETE SHOULDER, OR PARTIAL LANE WIDTH REPAIR.
- IF REQUIRED, INTERMEDIATE SAW CUTS MAY BE MADE TO REMOVE A SECTION OF PAVEMENT LANE WHICH IS OVER 6'-0" IN LENGTH TO PERMIT LOADING INTO THE HAULING UNITS.

ADDITIONAL SAW CUTS, AT CONTRACTOR'S EXPENSE, MAY BE MADE INSIDE THE REPAIR LIMITS TO REDUCE 6'-0" BY 12'-0" OR LESS SLABS INTO SMALLER PIECES TO FACILITATE REMOVAL.

**SCHEMATIC OF TYPICAL LIFT PIN ASSEMBLY**

**SAWING DIAGRAM & LIFT PIN FOR REMOVING OLD SLAB**

DEPARTMENT DIRECTOR  
RSM T. Sheldahl  
APPROVED BY: *John C. Freund*  
ENGINEER OF DESIGN

PREPARED BY: DESIGN DIVISION  
DRAWN BY: S.L.L.  
CHECKED BY: W.L.P.

MICHIGAN DEPARTMENT OF TRANSPORTATION  
BUREAU OF HIGHWAY DEVELOPMENT STANDARD PLAN FOR  
**CONCRETE PAVEMENT REPAIR**

9-10-2010 8-9-2010 R-44-F SHEET 1 OF 6  
F.S.R.E. APPROVAL PLAN DATE

**LONG REPAIR SHOWING Cp JOINT ALIGNMENTS AND LANE TIES**

**JOINT PATCH ADJACENT TO WIDENING SLAB**

**FULL WIDTH MULTI-LANE REPAIRS WITH OFFSET IN ONE LANE**

**TWO CRACK PANEL REPAIR**

**MID PANEL CRACK REPAIR**

MICHIGAN DEPARTMENT OF TRANSPORTATION  
BUREAU OF HIGHWAY DEVELOPMENT STANDARD PLAN FOR  
**CONCRETE PAVEMENT REPAIR**

9-10-2010 8-9-2010 R-44-F SHEET 4 OF 6  
F.S.R.E. APPROVAL PLAN DATE

**ONE LANE REPAIRS (2-LANE ROADWAY SHOWN)**

**ALL LANES REPAIRED (2-LANE ROADWAY SHOWN)**

**MORE THAN ONE LANE REPAIRED BUT REPAIRS ARE OPPOSITE (3-LANE ROADWAY SHOWN)**

**CAST-IN-PLACE REPAIR JOINTS USING GROUDED DOWEL OR DEFORMED BARS**

MICHIGAN DEPARTMENT OF TRANSPORTATION  
BUREAU OF HIGHWAY DEVELOPMENT STANDARD PLAN FOR  
**CONCRETE PAVEMENT REPAIR**

9-10-2010 8-9-2010 R-44-F SHEET 2 OF 6  
F.S.R.E. APPROVAL PLAN DATE

**SURFACE REPAIR FOR JOINT OR CRACK (TRANSVERSE OR LONGITUDINAL)**

**FULL DEPTH REPAIR FOR JOINT OR CRACK (TRANSVERSE OR LONGITUDINAL)**

MICHIGAN DEPARTMENT OF TRANSPORTATION  
BUREAU OF HIGHWAY DEVELOPMENT STANDARD PLAN FOR  
**CONCRETE PAVEMENT REPAIR**

9-10-2010 8-9-2010 R-44-F SHEET 5 OF 6  
F.S.R.E. APPROVAL PLAN DATE

**DOWEL OR DEFORMED BAR SPACING FOR CONCRETE REPAIRS**

**EPOXY ANCHORED LANE TIE**

**EXPANSION JOINT, Erg**

MICHIGAN DEPARTMENT OF TRANSPORTATION  
BUREAU OF HIGHWAY DEVELOPMENT STANDARD PLAN FOR  
**CONCRETE PAVEMENT REPAIR**

9-10-2010 8-9-2010 R-44-F SHEET 3 OF 6  
F.S.R.E. APPROVAL PLAN DATE

**PRESSURE RELIEF JOINT**

**EXPANSION JOINT, Ebc**

MICHIGAN DEPARTMENT OF TRANSPORTATION  
BUREAU OF HIGHWAY DEVELOPMENT STANDARD PLAN FOR  
**CONCRETE PAVEMENT REPAIR**

9-10-2010 8-9-2010 R-44-F SHEET 6 OF 6  
F.S.R.E. APPROVAL PLAN DATE

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COLONY ESSEX MANCHESTER  
CONCRETE PAVEMENT REPAIR  
DETAILS

SCALE PLAN: #####  
DRAWING NO: 2015024-5  
SHEET NO. 5 OF 27

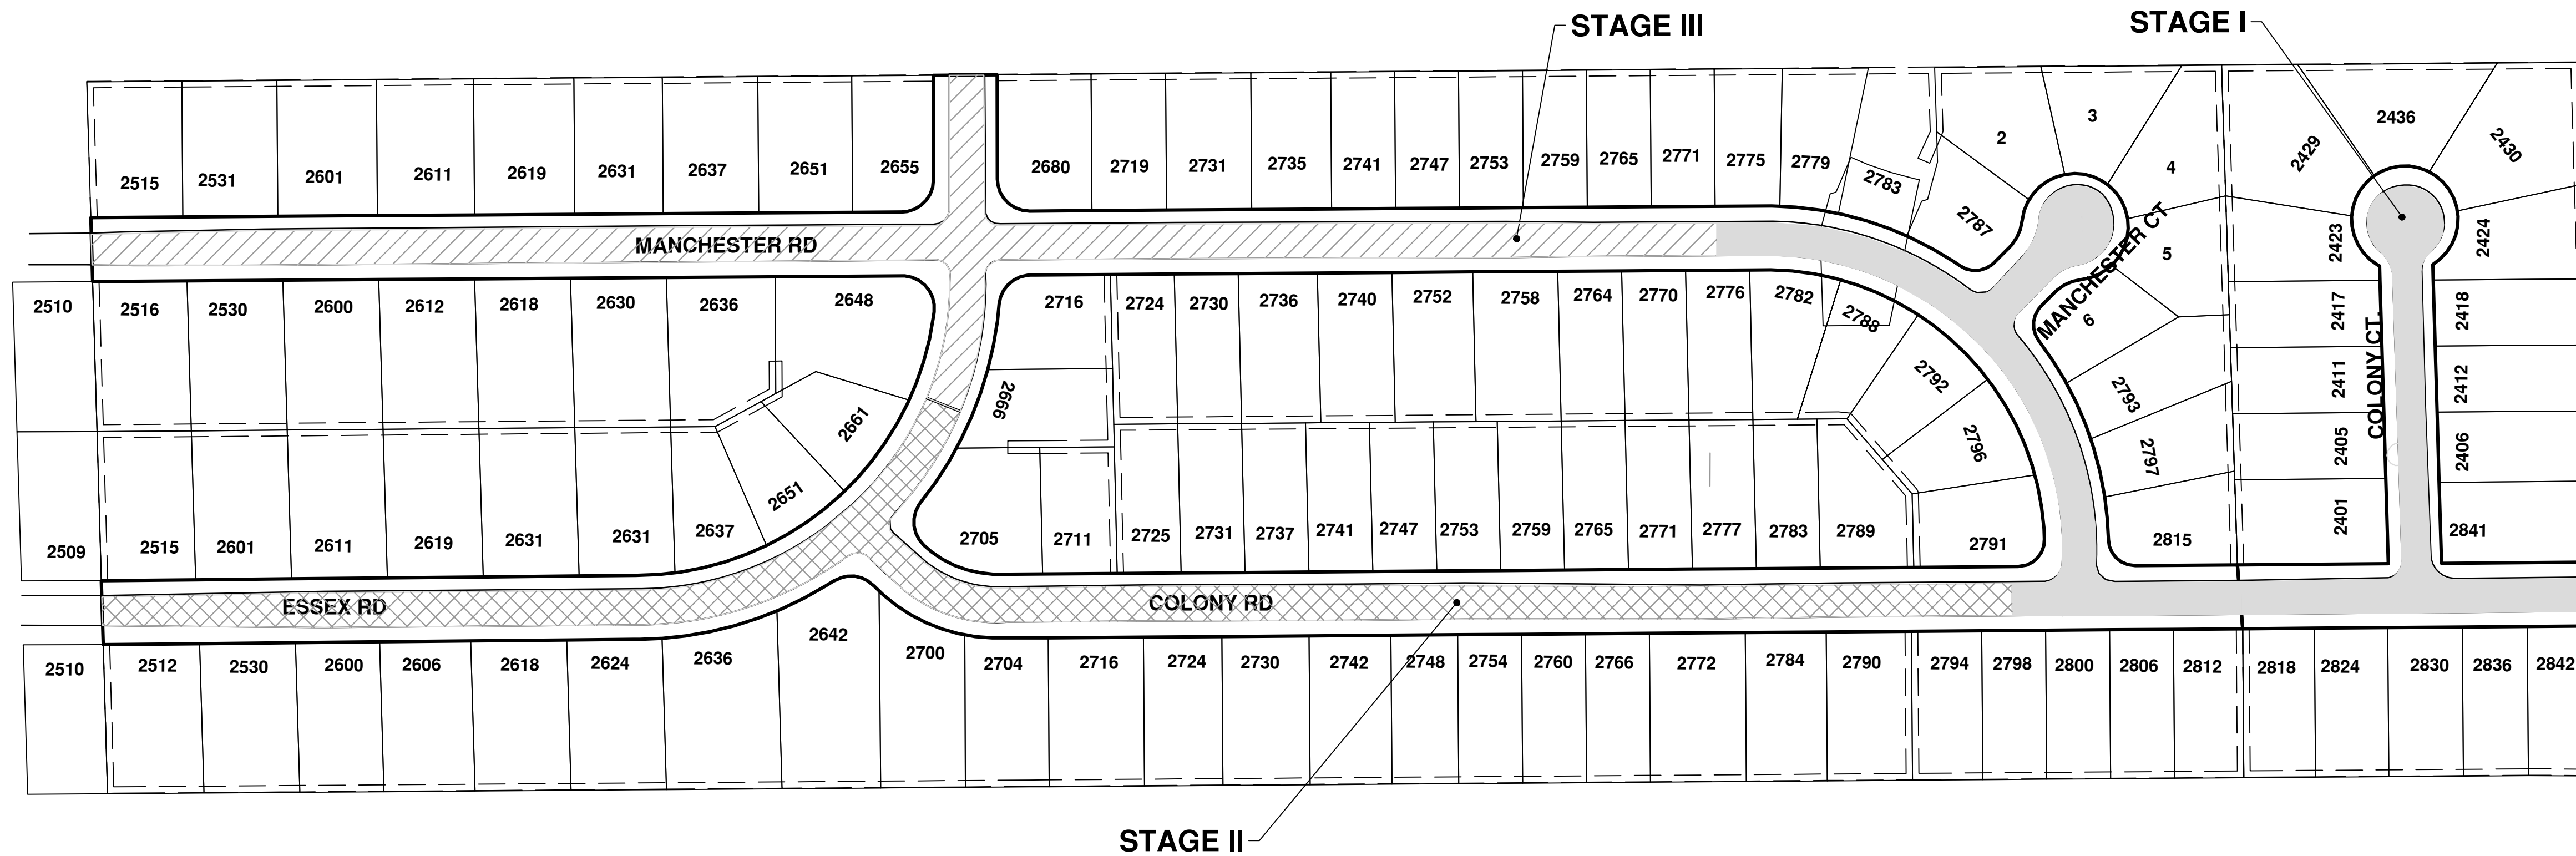
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**CONSTRUCTION SEQUENCE**

THE CONTRACTOR SHALL REVIEW THE TRAFFIC MAINTENANCE PLANS, DETOUR PLANS, AND THE CONTRACT DOCUMENTS AND NOTE THAT EACH OF THE MAJOR STAGES OF CONSTRUCTION (STAGES 1 THROUGH 3) ARE SHOWN FOR THE PURPOSE OF COMPLETING THE CONCRETE PAVEMENT REPAIRS AND SIDEWALK WHILE MAINTAINING ACCESS TO ALL RESIDENCES SOLELY ACCESSED OFF OF COLONY RD, MANCHESTER RD, ESSEX RD, AND COLONY COURT. EACH CONSTRUCTION STAGE SHOWN ON SHEET 4 WILL BE BUILT CONSTRUCTING ONE SIDE OF ROAD AT A TIME. CONTRACTOR WILL BE REQUIRED TO KEEP ONE SIDE OF ROAD OPEN AT ALL TIMES FOR RESIDENTS AND EMERGENCY VEHICLES. CONTRACTOR WILL BE REQUIRED TO REMOVE ONLY ENOUGH OF CONCRETE PAVEMENT THAT CAN BE PLACED BACK IN SAME DAY; 25 FEET OF REMOVAL PROPERLY SECURED IS ALL THAT CAN BE LEFT OPEN AT END OF EACH DAY. WERE STORM SEWER STRUCTURES TO BE REPLACED ARE IN FRONT OF DRIVES, CONTRACTOR TO SCHEDULE REMOVAL, REPLACEMENT, BACKFILL, CONCRETE PLACEMENT, AND CURE TIME TO BE COMPLETED IN NO MORE THAN 5 DAYS FROM START TO FINISH. THE INTENT IS TO HAVE CONTRACTOR ALSO WORKING ON RESTORING LAWN AREAS AS SOON AS POSSIBLE AND COMPLETE WORK IN EACH STAGE BEFORE MOVING ON TO NEXT STAGE. WHEN CONTRACTOR NEEDS TO UTILIZE BOTH LANES TO PLACE CONCRETE REPAIRS FLAG CONTROL WILL BE REQUIRED TO BE USED TO CONTROL ACCESS. CONTRACTOR WILL SUBMIT DETAILED SCHEDULE OF WORK ITEMS AND PROPOSED COMPLETION DATES ON WEEKLY BASIS. THESE WORK ITEMS AND DATES WILL BE DISCUSSED AND ADJUSTED AS NEEDED AT WEEKLY PROGRESS MEETING. THE CONTRACTOR MAY CHOOSE TO ADJUST THE LIMITS OR SEQUENCING OF CONSTRUCTION IN ORDER TO COMPLETE THE WORK MORE EFFICIENTLY. HOWEVER, CHANGES TO THE RECOMMENDED STAGES MUST BE APPROVED IN WRITING BY THE ENGINEER PRIOR TO CONSTRUCTION AND MUST ASSURE THAT ACCESS IS MAINTAINED AS DESCRIBED ABOVE.

**STAGE I**

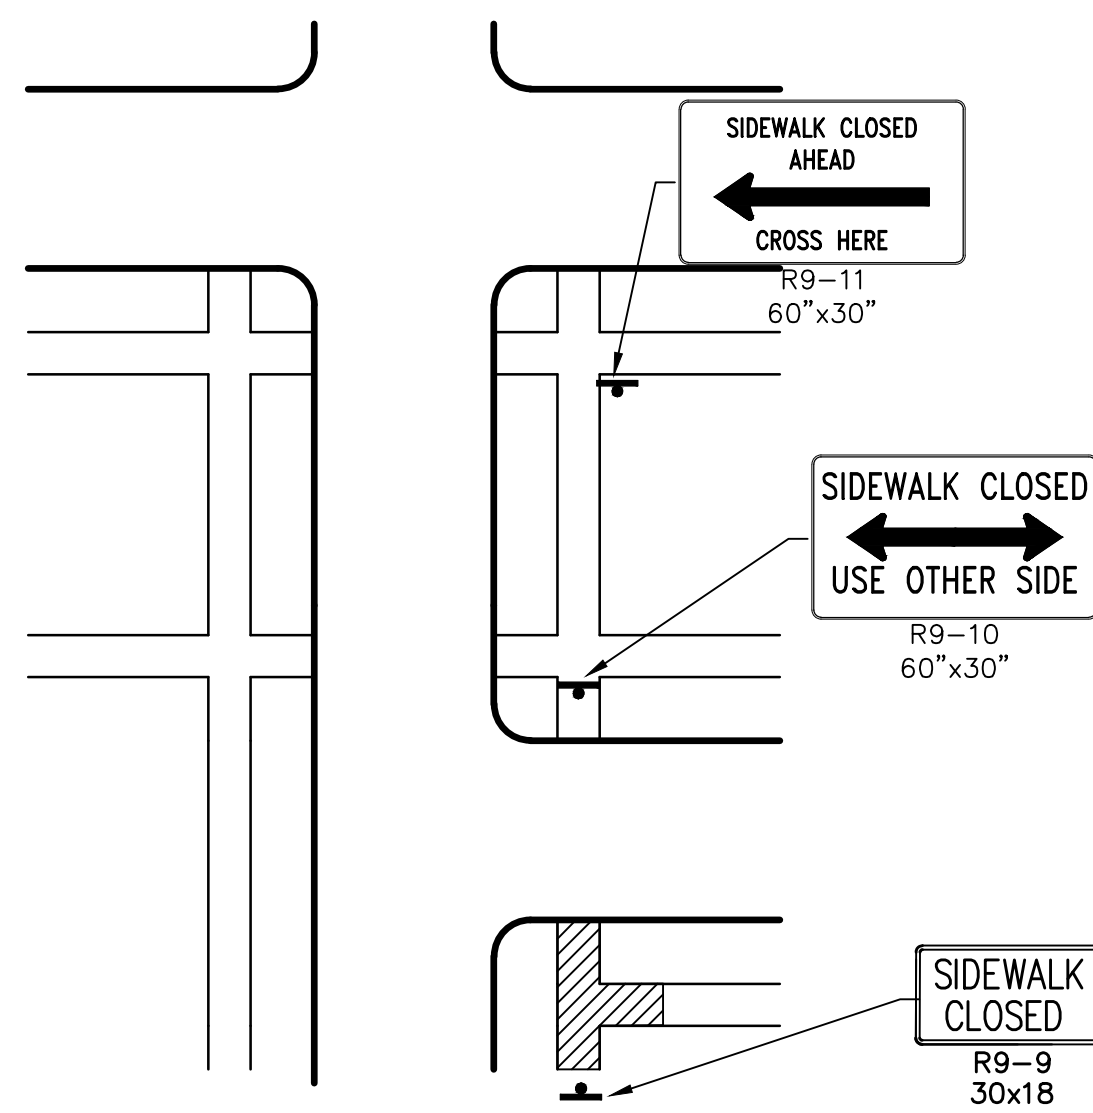
1. PLACE MESSAGE BOARDS 1 WEEK PRIOR TO START OF CONSTRUCTION. PLACE MESSAGE PER ENGINEER.
2. INSTALL TRAFFIC CONTROL DEVICES FOR DETOUR AND MAINTENANCE OF TRAFFIC PER STAGE I.
3. PLACE NO PARKING SIGNS.
4. PLACE SOIL EROSION CONTROL ITEMS AND TREE PROTECTION.
5. CONSTRUCT STORM SEWER INLETS ON COLONY AND MANCHESTER COURT.
6. REMOVE AND REPLACE CONCRETE PAVEMENT AND SIDEWALK.
7. FINISH RESTORATION, CLEAN STREET, AND COMPLETE PRELIMINARY PUNCH LIST FOR STAGE I.
8. REMOVE SOIL EROSION CONTROL MEASURES AND TREE PROTECTION.
9. REMOVE NO PARKING SIGNS, DETOUR AND CONSTRUCTION SIGNAGE.

**STAGE II**

1. ADJUST MESSAGE ON MESSAGE BOARDS, PLACE MESSAGE PER ENGINEER.
2. INSTALL TRAFFIC CONTROL DEVICES FOR DETOUR AND MAINTENANCE OF TRAFFIC PER STAGE II.
3. PLACE NO PARKING SIGNS.
4. PLACE SOIL EROSION CONTROL ITEMS AND TREE PROTECTION.
5. CONSTRUCT STORM SEWER FRONT OF 2724 AND 2731 COLONY COURT.
6. REMOVE AND REPLACE CONCRETE PAVEMENT AND SIDEWALK.
7. FINISH RESTORATION, CLEAN STREET, AND COMPLETE PRELIMINARY PUNCH LIST FOR STAGE II.
8. REMOVE SOIL EROSION CONTROL MEASURES AND TREE PROTECTION.
9. REMOVE NO PARKING SIGNS, DETOUR AND CONSTRUCTION SIGNAGE.

**STAGE III**

1. ADJUST MESSAGE ON MESSAGE BOARDS, PLACE MESSAGE PER ENGINEER.
2. INSTALL TRAFFIC CONTROL DEVICES FOR DETOUR AND MAINTENANCE OF TRAFFIC PER STAGE III.
3. PLACE NO PARKING SIGNS.
4. PLACE SOIL EROSION CONTROL ITEMS AND TREE PROTECTION.
5. CONSTRUCT STORM SEWER FRONT OF 2611, 2612, 2636, 2637, 2648, 2735 AND 2736 MANCHESTER RD.
6. REMOVE AND REPLACE CONCRETE PAVEMENT AND SIDEWALK.
7. FINISH RESTORATION, CLEAN STREET, AND COMPLETE PRELIMINARY PUNCH LIST FOR STAGE III AND OVERALL PROJECT PUNCH LIST.
8. REMOVE SOIL EROSION CONTROL MEASURES AND TREE PROTECTION.
9. REMOVE NO PARKING SIGNS, DETOUR AND CONSTRUCTION SIGNAGE.



TYPICAL SIDEWALK DETOUR  
N.T.S.

PEDESTRIAN TRAFFIC CONTROL SIGNS			
SIGN	NUMBER	QUANTITY	TOTAL SFT
	R9-10 60X30	3	38
	R9-11 60X30	3	38
	R9-9 30x18	3	14
	R9-11 48x36	3	36

**SIDEWALK DETOUR**

1. SIGNS PROVIDED AS NEEDED. PEDESTRIAN DETOUR PLACED AS DIRECTED BY ENGINEER

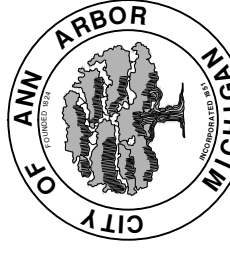
**TRAFFIC NOTES FOR STAGE 1, 2, AND 3**

1. CONTRACTOR SHALL PLACE PORTABLE, CHANGEABLE MESSAGE SIGNS A MINIMUM OF ONE (1) WEEK PRIOR TO THE START OF CONSTRUCTION IN LOCATIONS INDICATED BY ENGINEER. MESSAGE TO BE PROVIDED BY THE ENGINEER.
2. SIGN SPACING PER MMUTCD 6C-4 OR AS DIRECTED BY ENGINEER.
3. ONE SIDE OF SIDEWALK TO BE OPEN FOR USE AT ALL TIMES.
4. ALL TRAFFIC CONTROL DEVICES TO MEET CURRENT MMUTCD PART 6 STANDARDS.
5. MAINTAIN ACCESS TO PROPERTIES AND EMERGENCY VEHICLES AT ALL TIMES.
6. CONTRACTOR TO PROVIDE TRAFFIC REGULATORS AS NEEDED AND AS DIRECTED BY ENGINEER.
7. COVER CONFLICTING SIGNS AS NEEDED OR AS DIRECTED BY ENGINEER, PAID AS PART OF MINOR TRAFFIC CONTROL.



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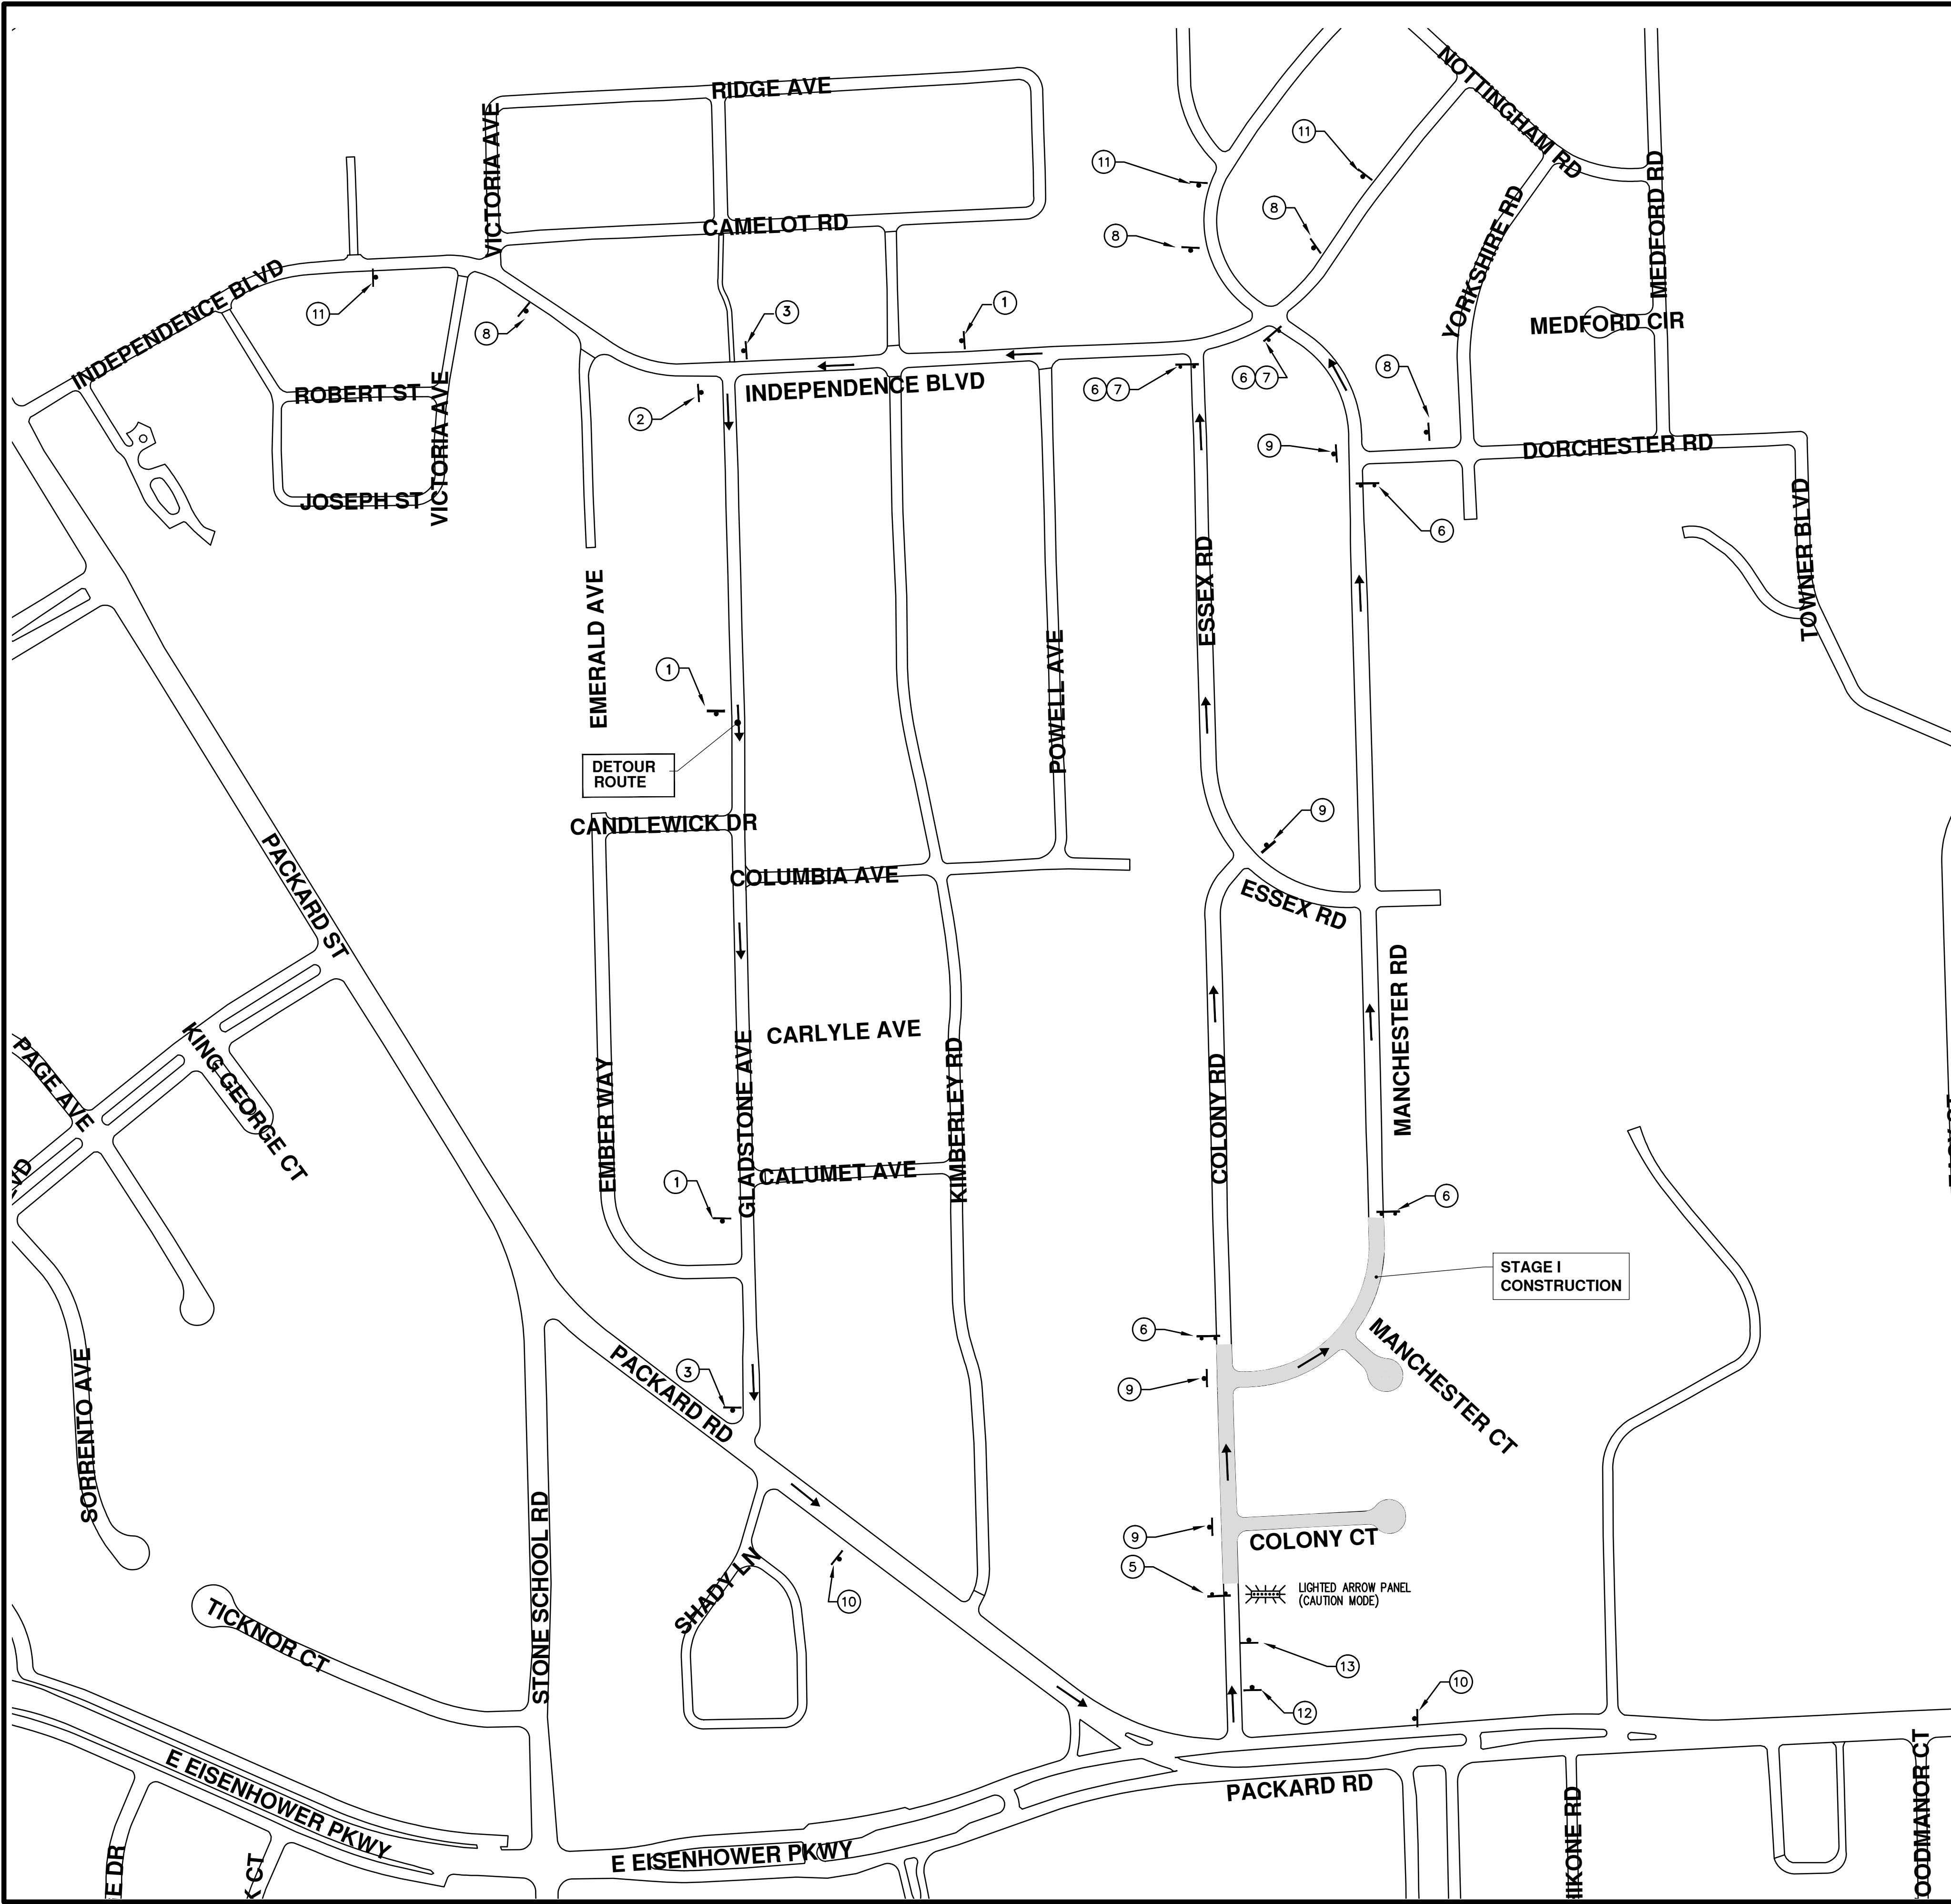
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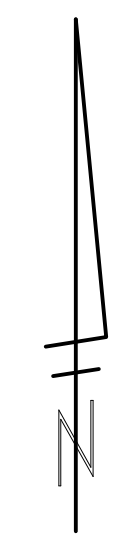
PROJECT MANAGEMENT - PUBLIC SERVICES - CITY OF ANN ARBOR  
COLONY ESSEX MANCHESTER  
CONCRETE PAVEMENT REPAIR  
PROJECT LAYOUT

SCALE PLAN: 1" = 100'  
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TRAFFIC CONTROL SIGN				
	SIGN	NUMBER	QUANTITY	TOTAL AREA (SFT)
①	ESSEX/COLONY DETOUR ↑	D3-1 M4-9S 30x30	3	6 19
②	ESSEX/COLONY DETOUR →	D3-1 M4-9R 30x24	1	2 5
③	ESSEX/COLONY DETOUR ←	D3-1 M4-9L 30x24	2	4 10
⑤	TYPE III BARRICADE WITH ROAD CLOSED LOCAL TRAFFIC ONLY	R11-3 60x30	1	13
⑥	TYPE III BARRICADE WITH ROAD CLOSED	R11-2 48x30	5	50
⑦	DETOUR →	M4-10R 30"x24"	2	10
⑧	SOUTH BOUND ESSEX AND MANCHESTER ROADS CLOSED FOLLOW DETOUR	SPECIAL 48x60	4	80
⑨	ONE WAY →	R6-1R 36x12	4	12
⑩	ROAD WORK AHEAD COLONY RD.	W20-1 48 X 48 D3-1	2	32 4
⑪	ROAD WORK AHEAD ESSEX RD	W20-1 48 X 48 D3-1	3	48 6
⑫	ONE LANE ROAD AHEAD	W20-4 48 X 48	1	16
⑬	WORK ZONE BEGINS	R5-18c 36 x 30	1	8



**PROJECT MANAGEMENT - PUBLIC SERVICES - CITY OF ANN ARBOR**

**COLONY ESSEX MANCHESTER**

**CONCRETE PAVEMENT REPAIR**

TRAFFIC AND DETOUR STAGE I

SCALE PLAN: 1" = 200'

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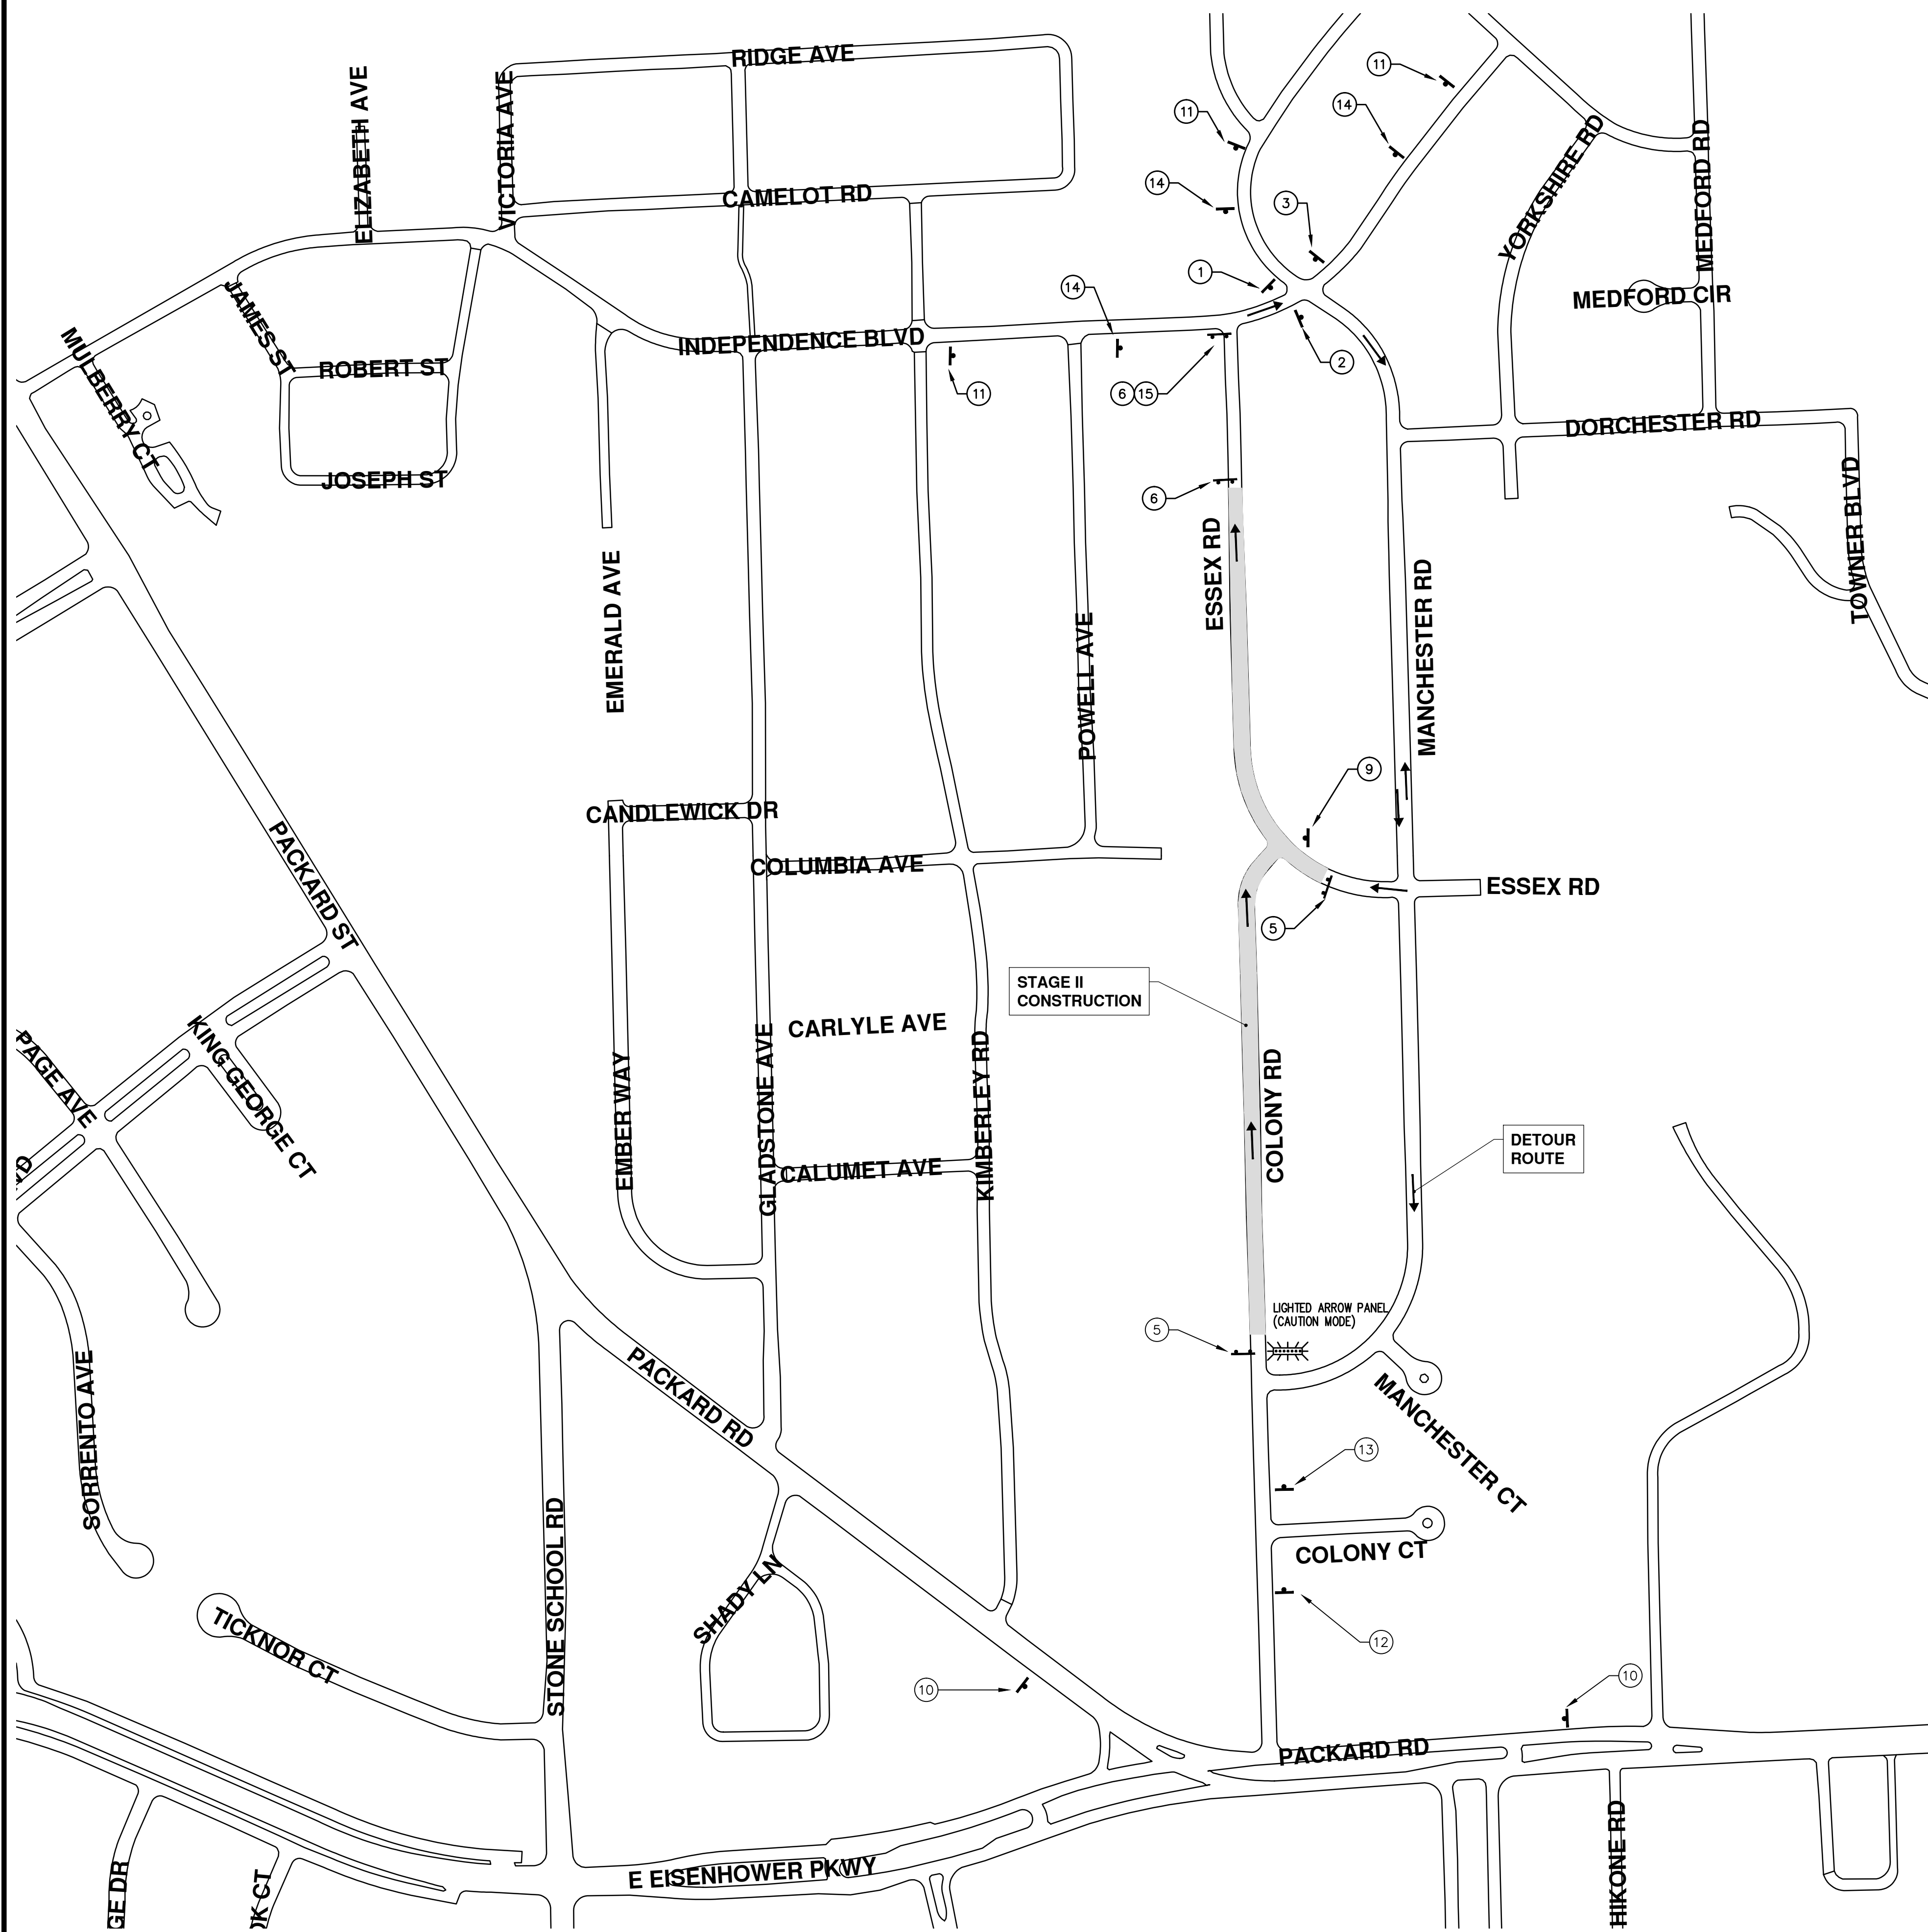
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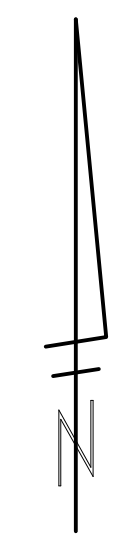
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TRAFFIC CONTROL SIGN				
	SIGN	NUMBER	QUANTITY	TOTAL AREA (SFT)
①		D3-1	1	2
		M4-9S 30x30	1	7
②		D3-1	1	2
		M4-9R 30x24	1	5
③		D3-1	1	2
		M4-9L 30x24	1	5
⑤	TYPE III BARRICADE WITH	R11-3 60x30	2	13
⑥	TYPE III BARRICADE WITH	R11-2 48x30	2	20
⑨		R6-1R 36x12	1	3
⑩		W20-1 48 X 48	2	32
		D3-1	2	4
⑪		W20-1 48 X 48	3	16
		D3-1	3	6
⑫		W20-4 48 X 48	1	16
⑬		R5-18c 36 x 30	1	8
⑭		SPECIAL 48x60	3	60
⑮		M4-10L 30"x24"	1	5



**PROJECT MANAGEMENT - PUBLIC SERVICES - CITY OF ANN ARBOR**

**COLONY ESSEX MANCHESTER**

**CONCRETE PAVEMENT REPAIR**

TRAFFIC AND DETOUR STAGE II

SCALE PLAN: 1" = 200'

DRAWING No. 2015024-8

**811**  
Know what's below.  
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REV.	DESCRIPTION	DATE	DRAWN	CHECKED

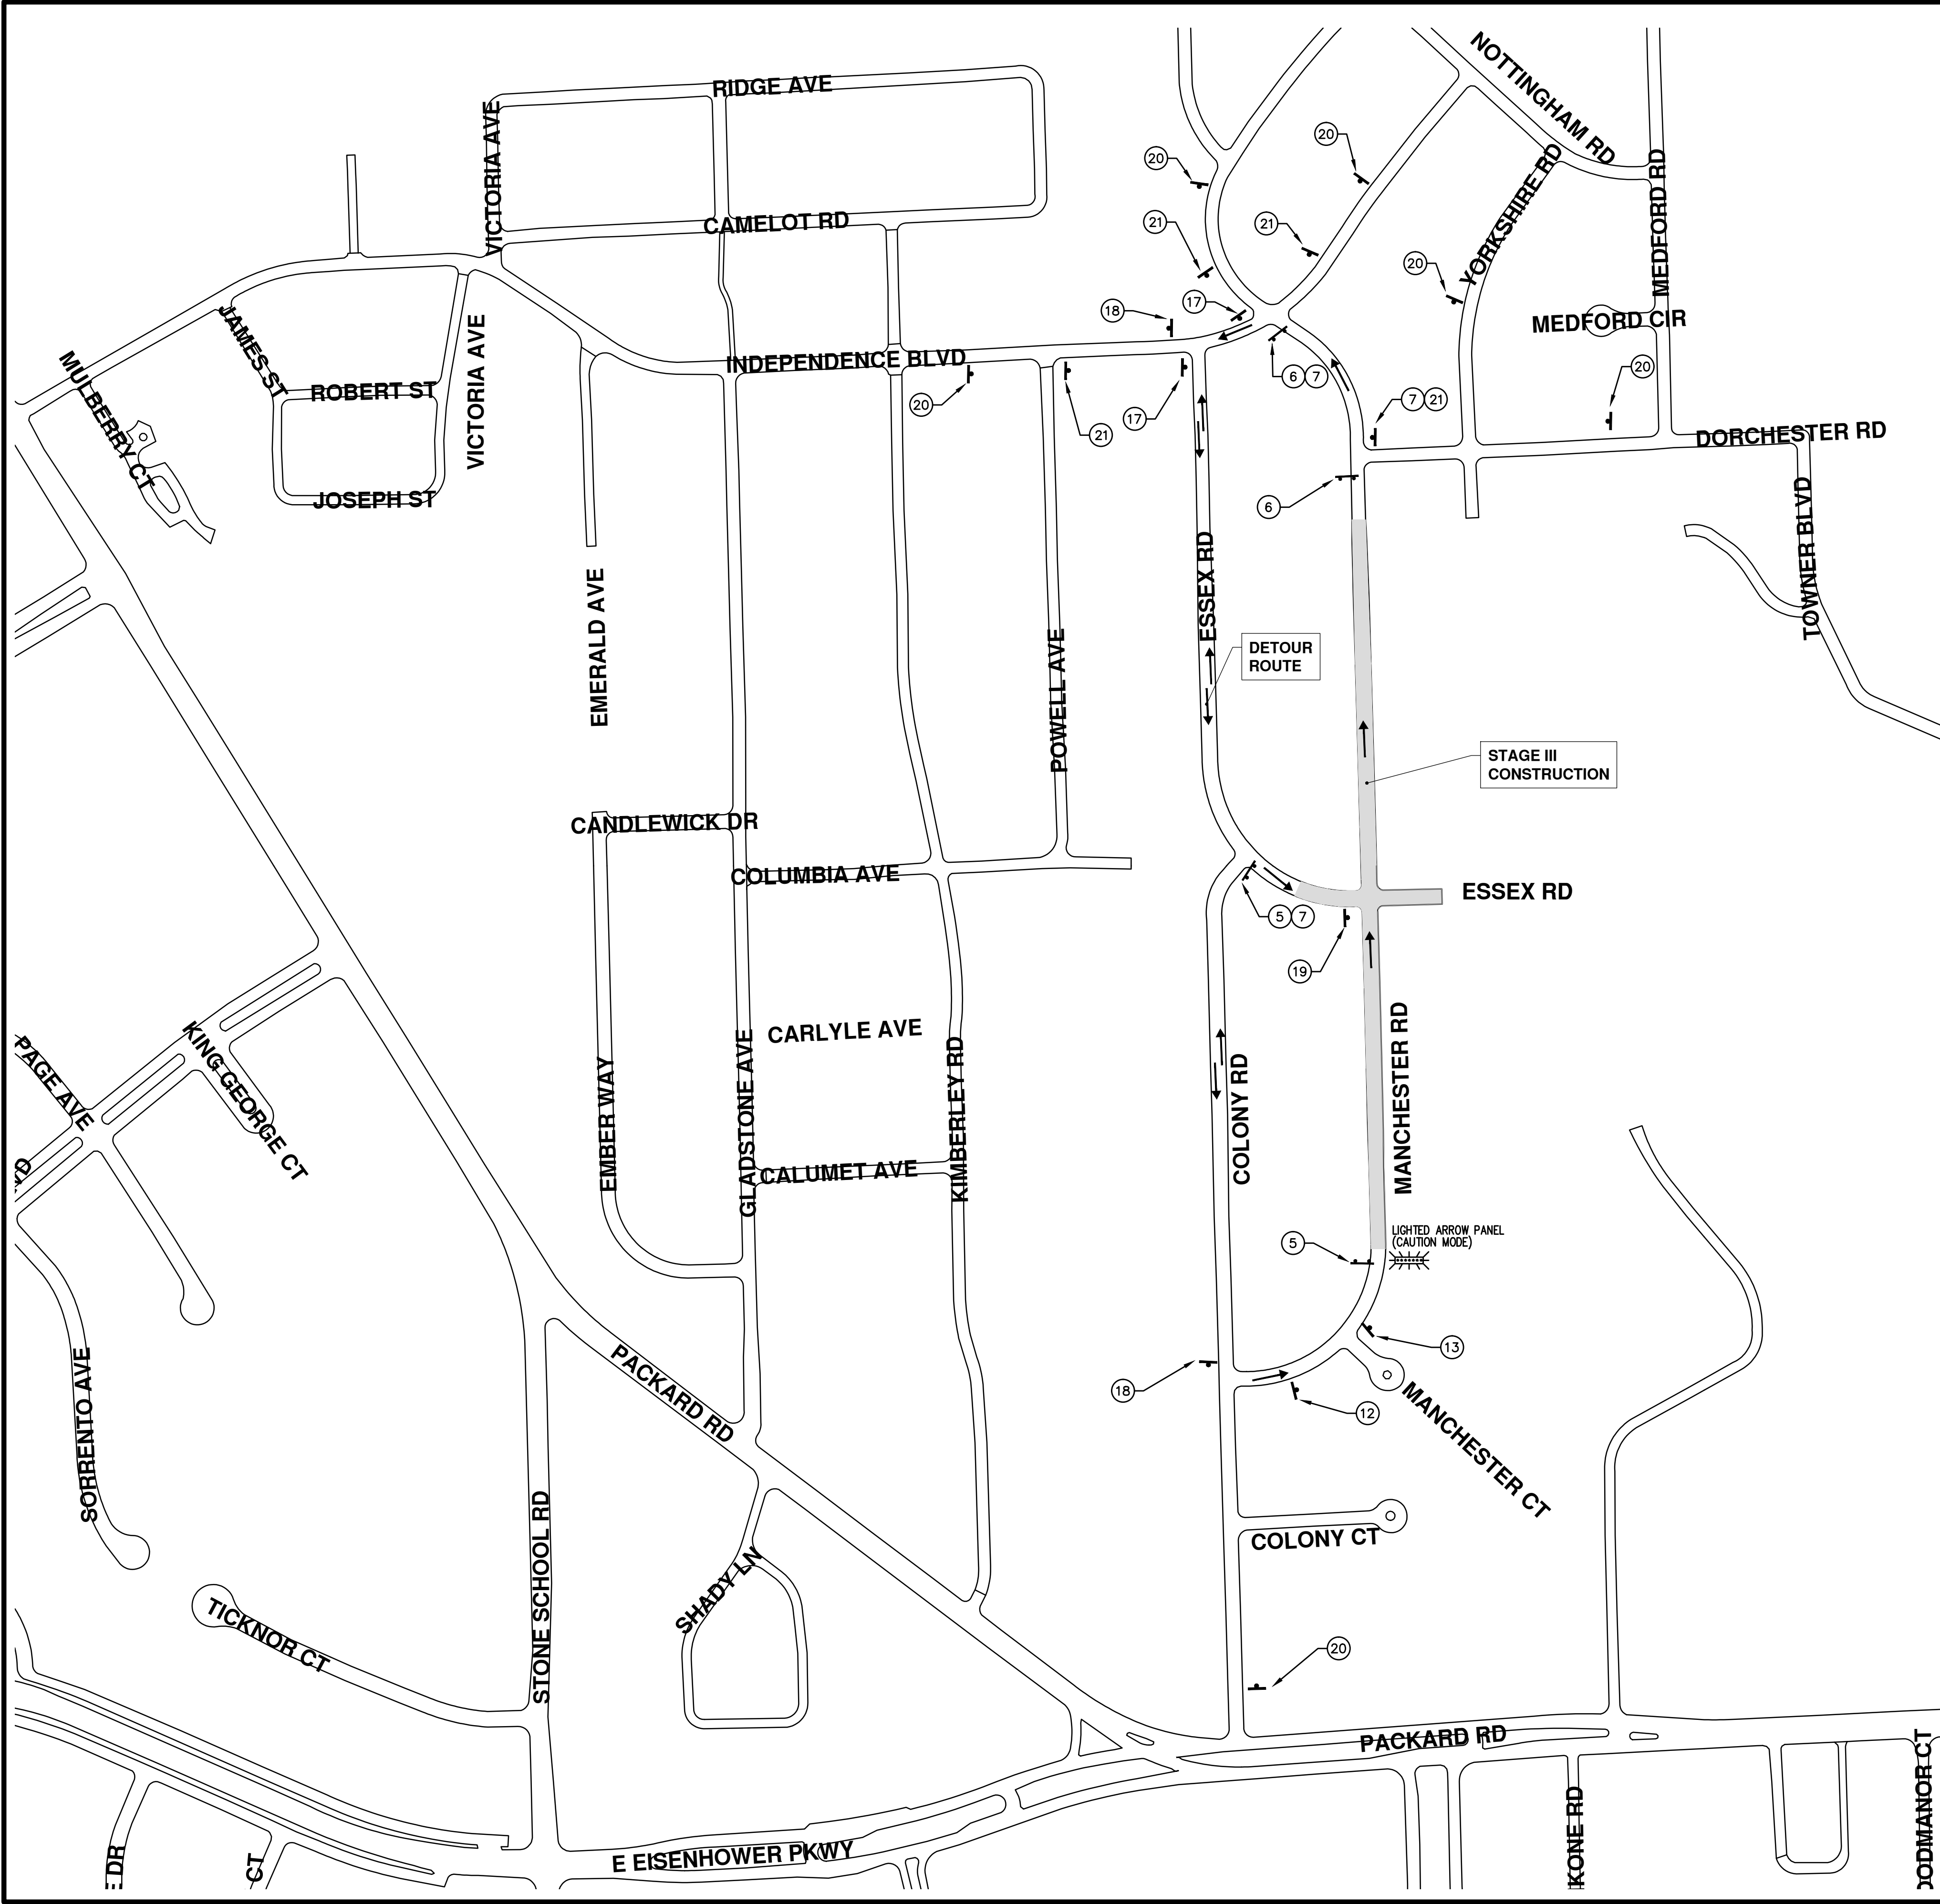
CITY OF ANN ARBOR  
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301 EAST HURON STREET  
ANN ARBOR, MI 48106-0647  
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CITY OF ANN ARBOR  
MICHIGAN

SHEET No. 8 OF 27



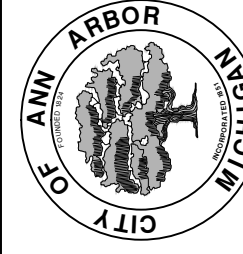
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TRAFFIC CONTROL SIGN				
	SIGN	NUMBER	QUANTITY	TOTAL AREA (SFT)
5	TYPE III BARRICADE WITH ROAD CLOSED LOCAL TRAFFIC ONLY	R11-3 60x30	2	25
6	TYPE III BARRICADE WITH ROAD CLOSED	R11-2 48"x30"	2	20
7	DETOUR	M4-10R 30"x24"	3	15
12	ONE LANE ROAD AHEAD	W20-4 48 X 48	1	16
13	WORK ZONE BEGINS	R5-18c 36 x 30	1	8
17	MANCHESTER RD DETOUR	D3-1 M4-9R 30x24	2	10
18	MANCHESTER RD DETOUR	D3-1 M4-9L 30x24	2	10
19	ONE WAY	R6-1L 36x12	1	3
20	ROAD WORK AHEAD MANCHESTER RD	W20-1 48 X 48 D3-1	6	96
21	SOUTH BOUND MANCHESTER ROAD CLOSED FOLLOW DETOUR	SPECIAL 48x60	4	80



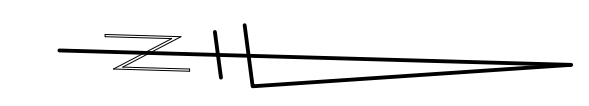
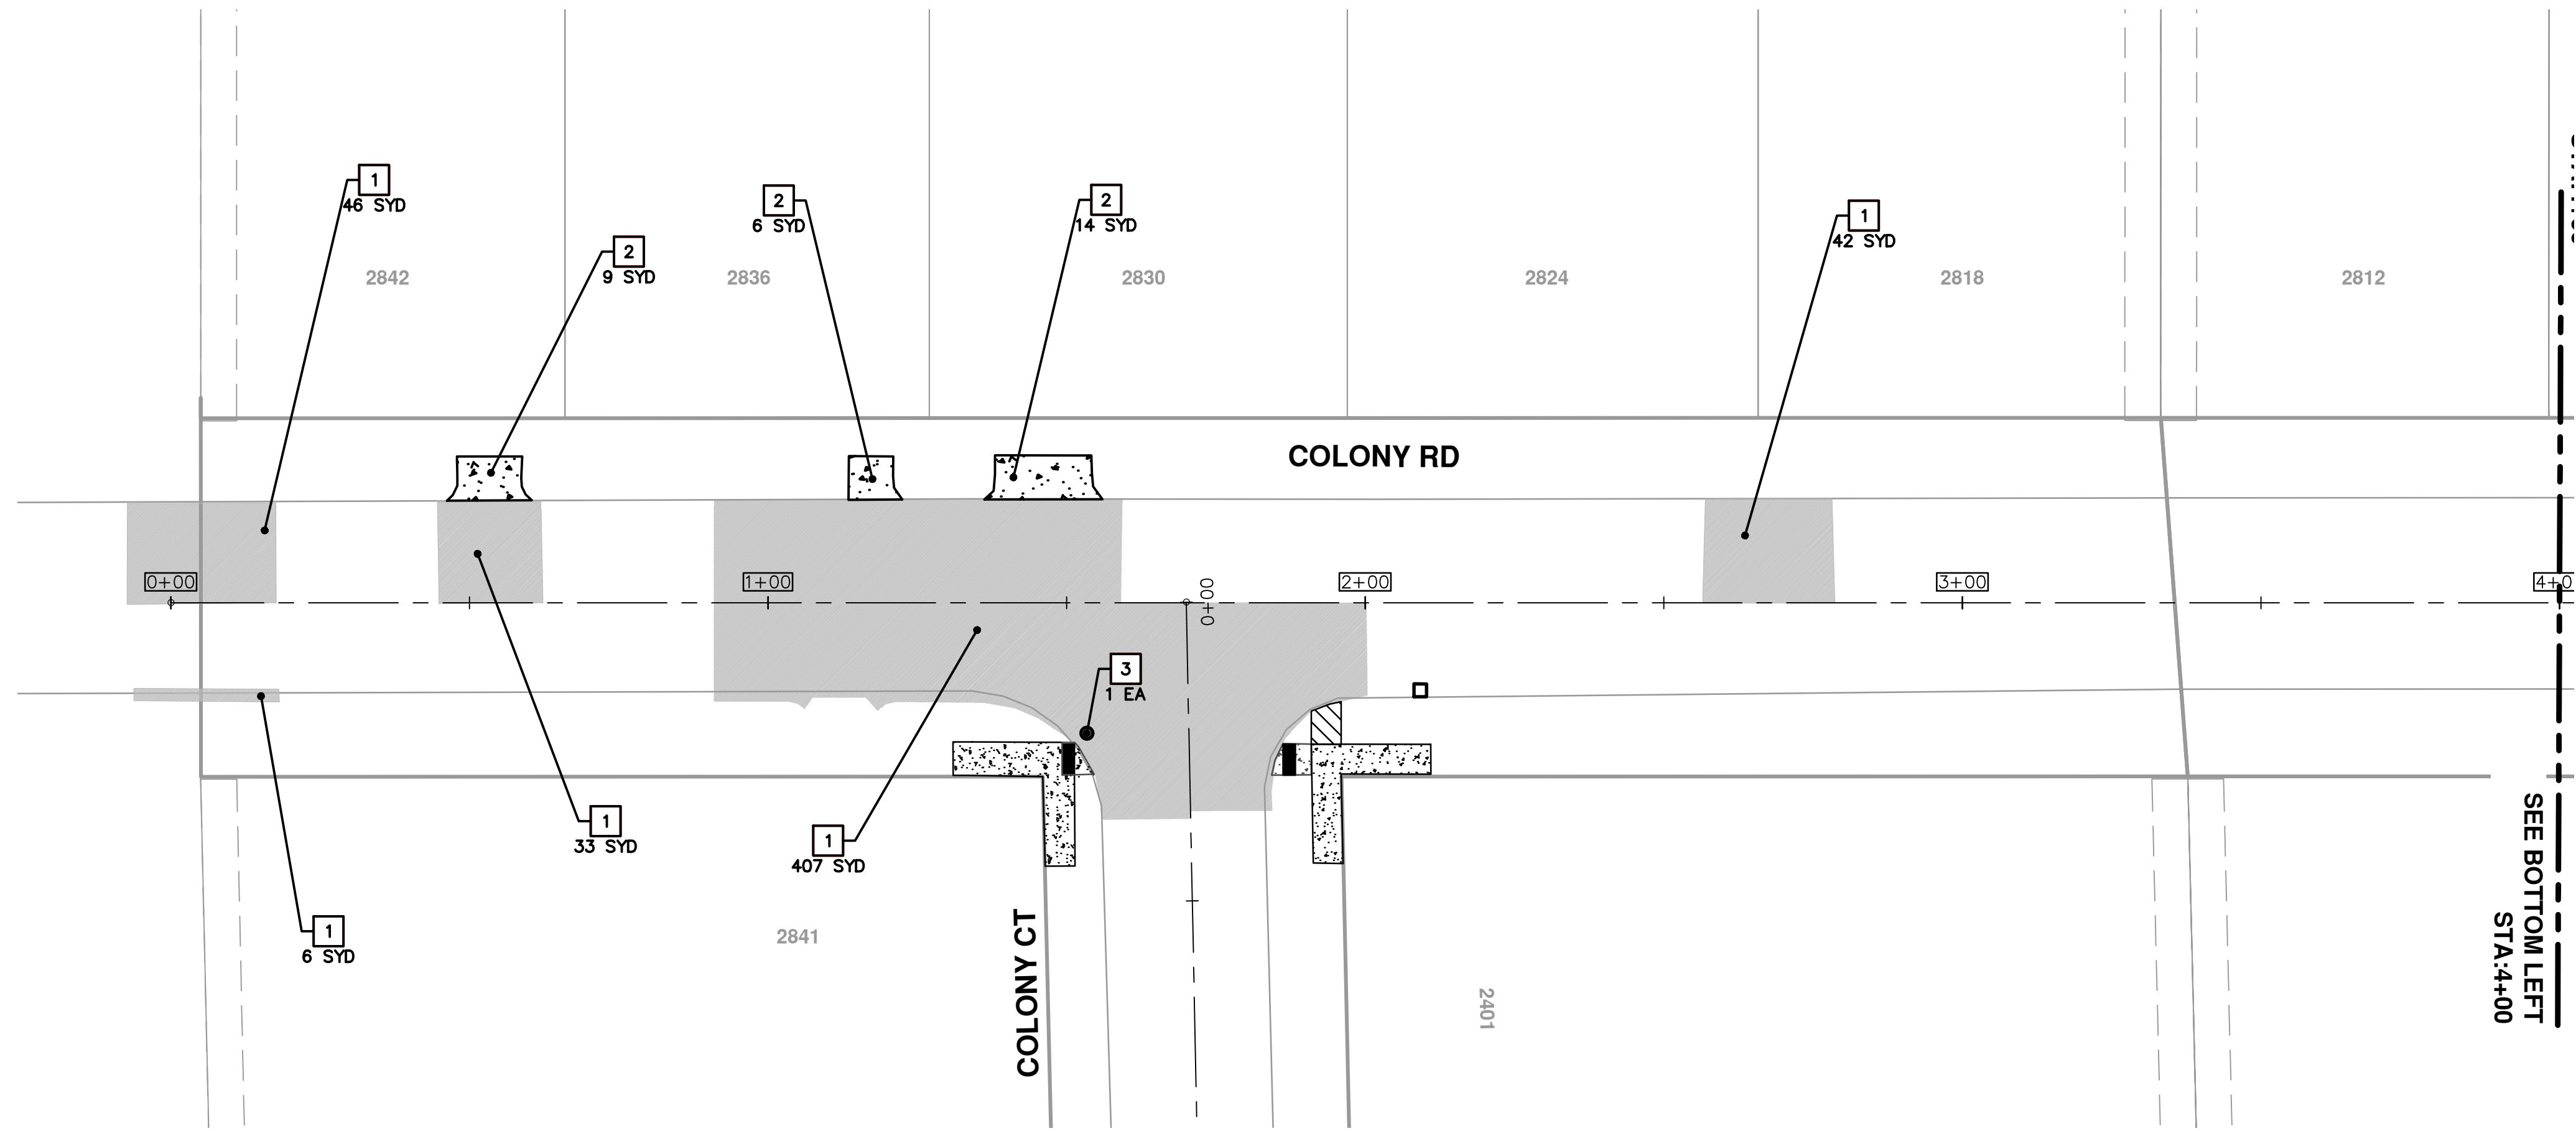
CITY OF ANN ARBOR  
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PO BOX 866  
ANN ARBOR MI 48106-0867  
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PROJECT MANAGEMENT - PUBLIC SERVICES - CITY OF ANN ARBOR  
COLONY ESSEX MANCHESTER  
CONCRETE PAVEMENT REPAIR  
TRAFFIC AND DETOUR STAGE III

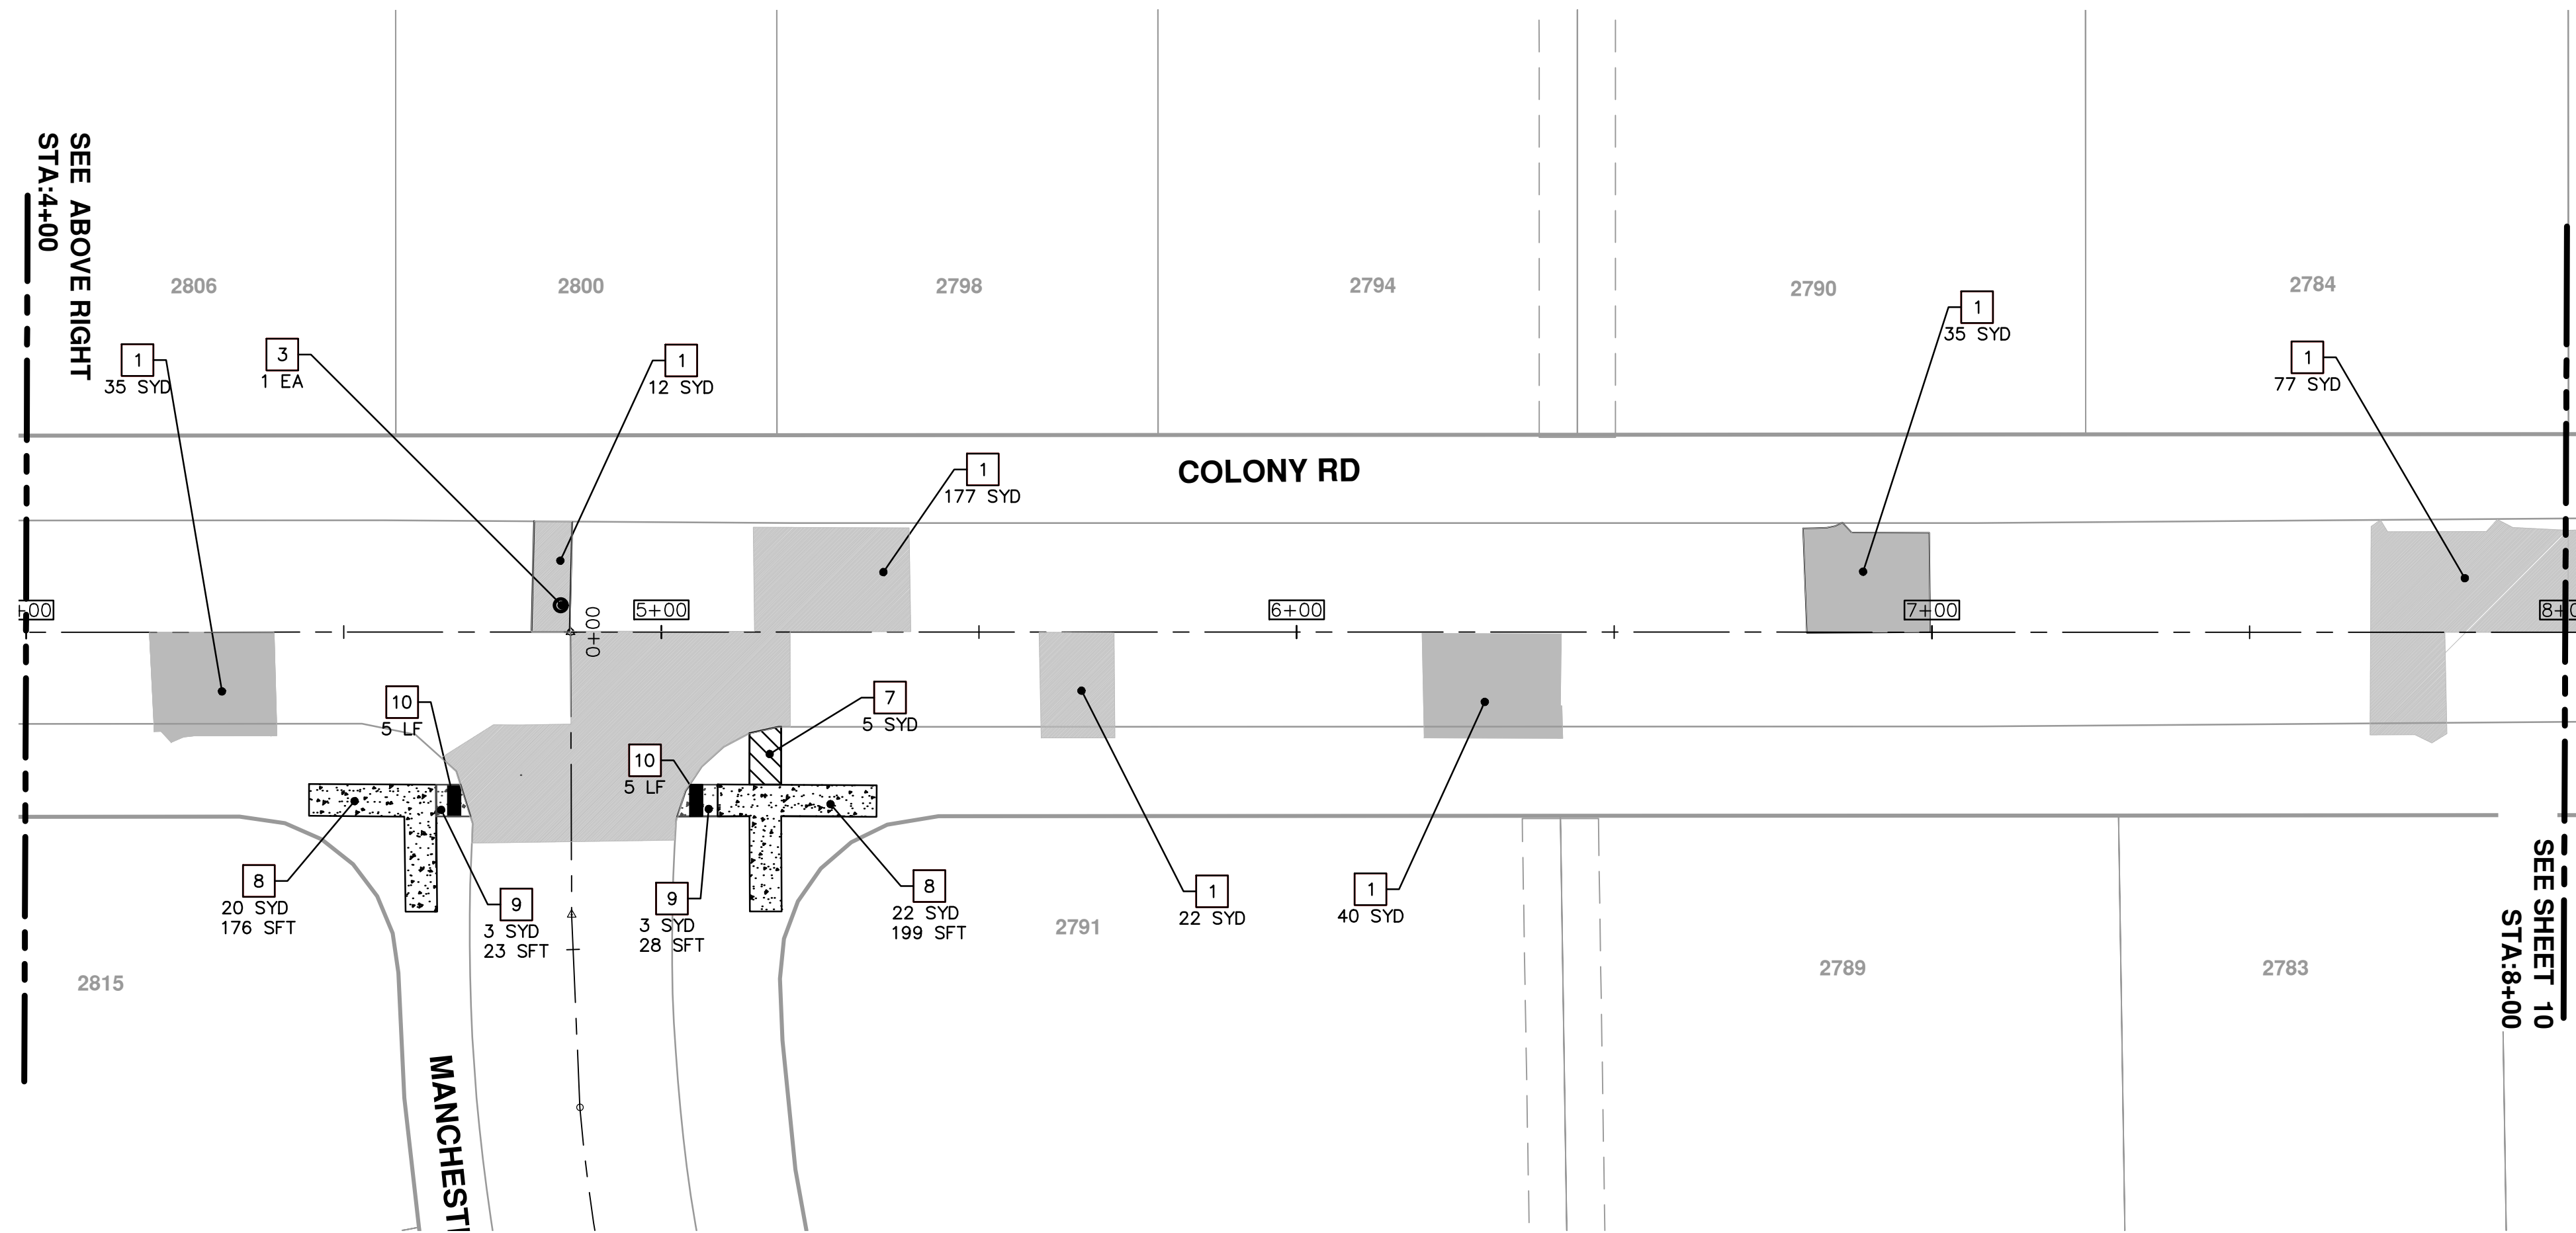
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DRAWING No. 2015024-9

REV.	DESCRIPTION	DATE	DRAWN	CHECKED




**PROJECT CONSTRUCTION INCLUDES THE REMOVAL AND REPLACEMENT OF SIDEWALK AT VARIOUS ADDRESSES WITHIN THE PROJECT LIMITS THAT IS NOT SHOWN ON THE PLANS. THE QUANTITIES FOR THIS WORK ARE REFLECTED IN THE OVERALL PROJECT QUANTITIES, AND SPECIFICALLY SHOWN BELOW.**

**SIDEWALK, REM = 795 SYD  
 GRADING, SIDEWALK = 795 SYD  
 SIDEWALK, CONC, 4 INCH, MODIFIED = 6,800 SFT  
 SIDEWALK, CONC. 6 INCH. MODIFIED = 350 SFT**




CONSTRUCTION KEY	
KEY	DESCRIPTION
1	PAVT REMOVE AND CONC. PAVT. NONREINF. 6 INCH
2	PAVT REMOVE AND DRIVEWAY NONREINF CONC 6 INCH
3	DR. STR. COVER ADJ. CASE 1 AND DR. COVER TYPE B MODIFIED
4	DR. STRUCTURE REMOVE, DR. STRUCTURE 24 INCH, AND DR. COVER TYPE K MODIFIED
5	DR. STRUCTURE REMOVE, DR. STRUCTURE DOUBLE INLET, AND DR. COVER TYPE K MODIFIED
6	GATE BOX ADJ. CASE 1, AND MONUMENT BOX, OR GAS BOX
7	SIDEWALK REMOVAL
8	SIDEWALK REMOVAL, SIDEWALK CONC. 4 INCH
9	SIDEWALK REMOVAL, SIDEWALK RAMP CONC 6 INCH
10	DETECTABLE WARNING SURFACE



Know what's below.  
Call before you dig

REV.	DESCRIPTION	DATE	DRAWN	CHECKED



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 ANN ARBOR, MI 48107-8847  
 734-794-6410  
 www.a2gov.org

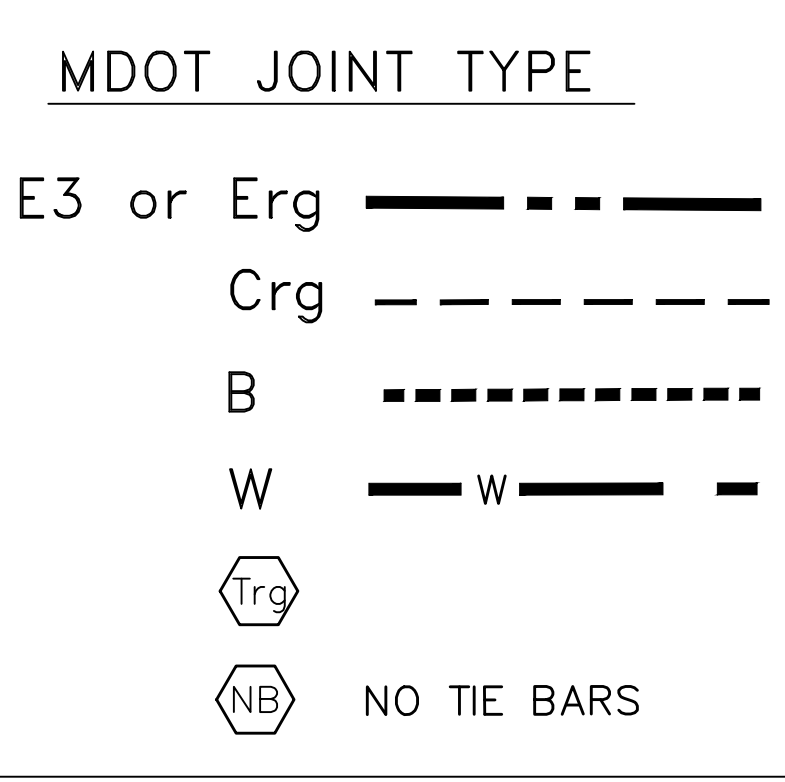
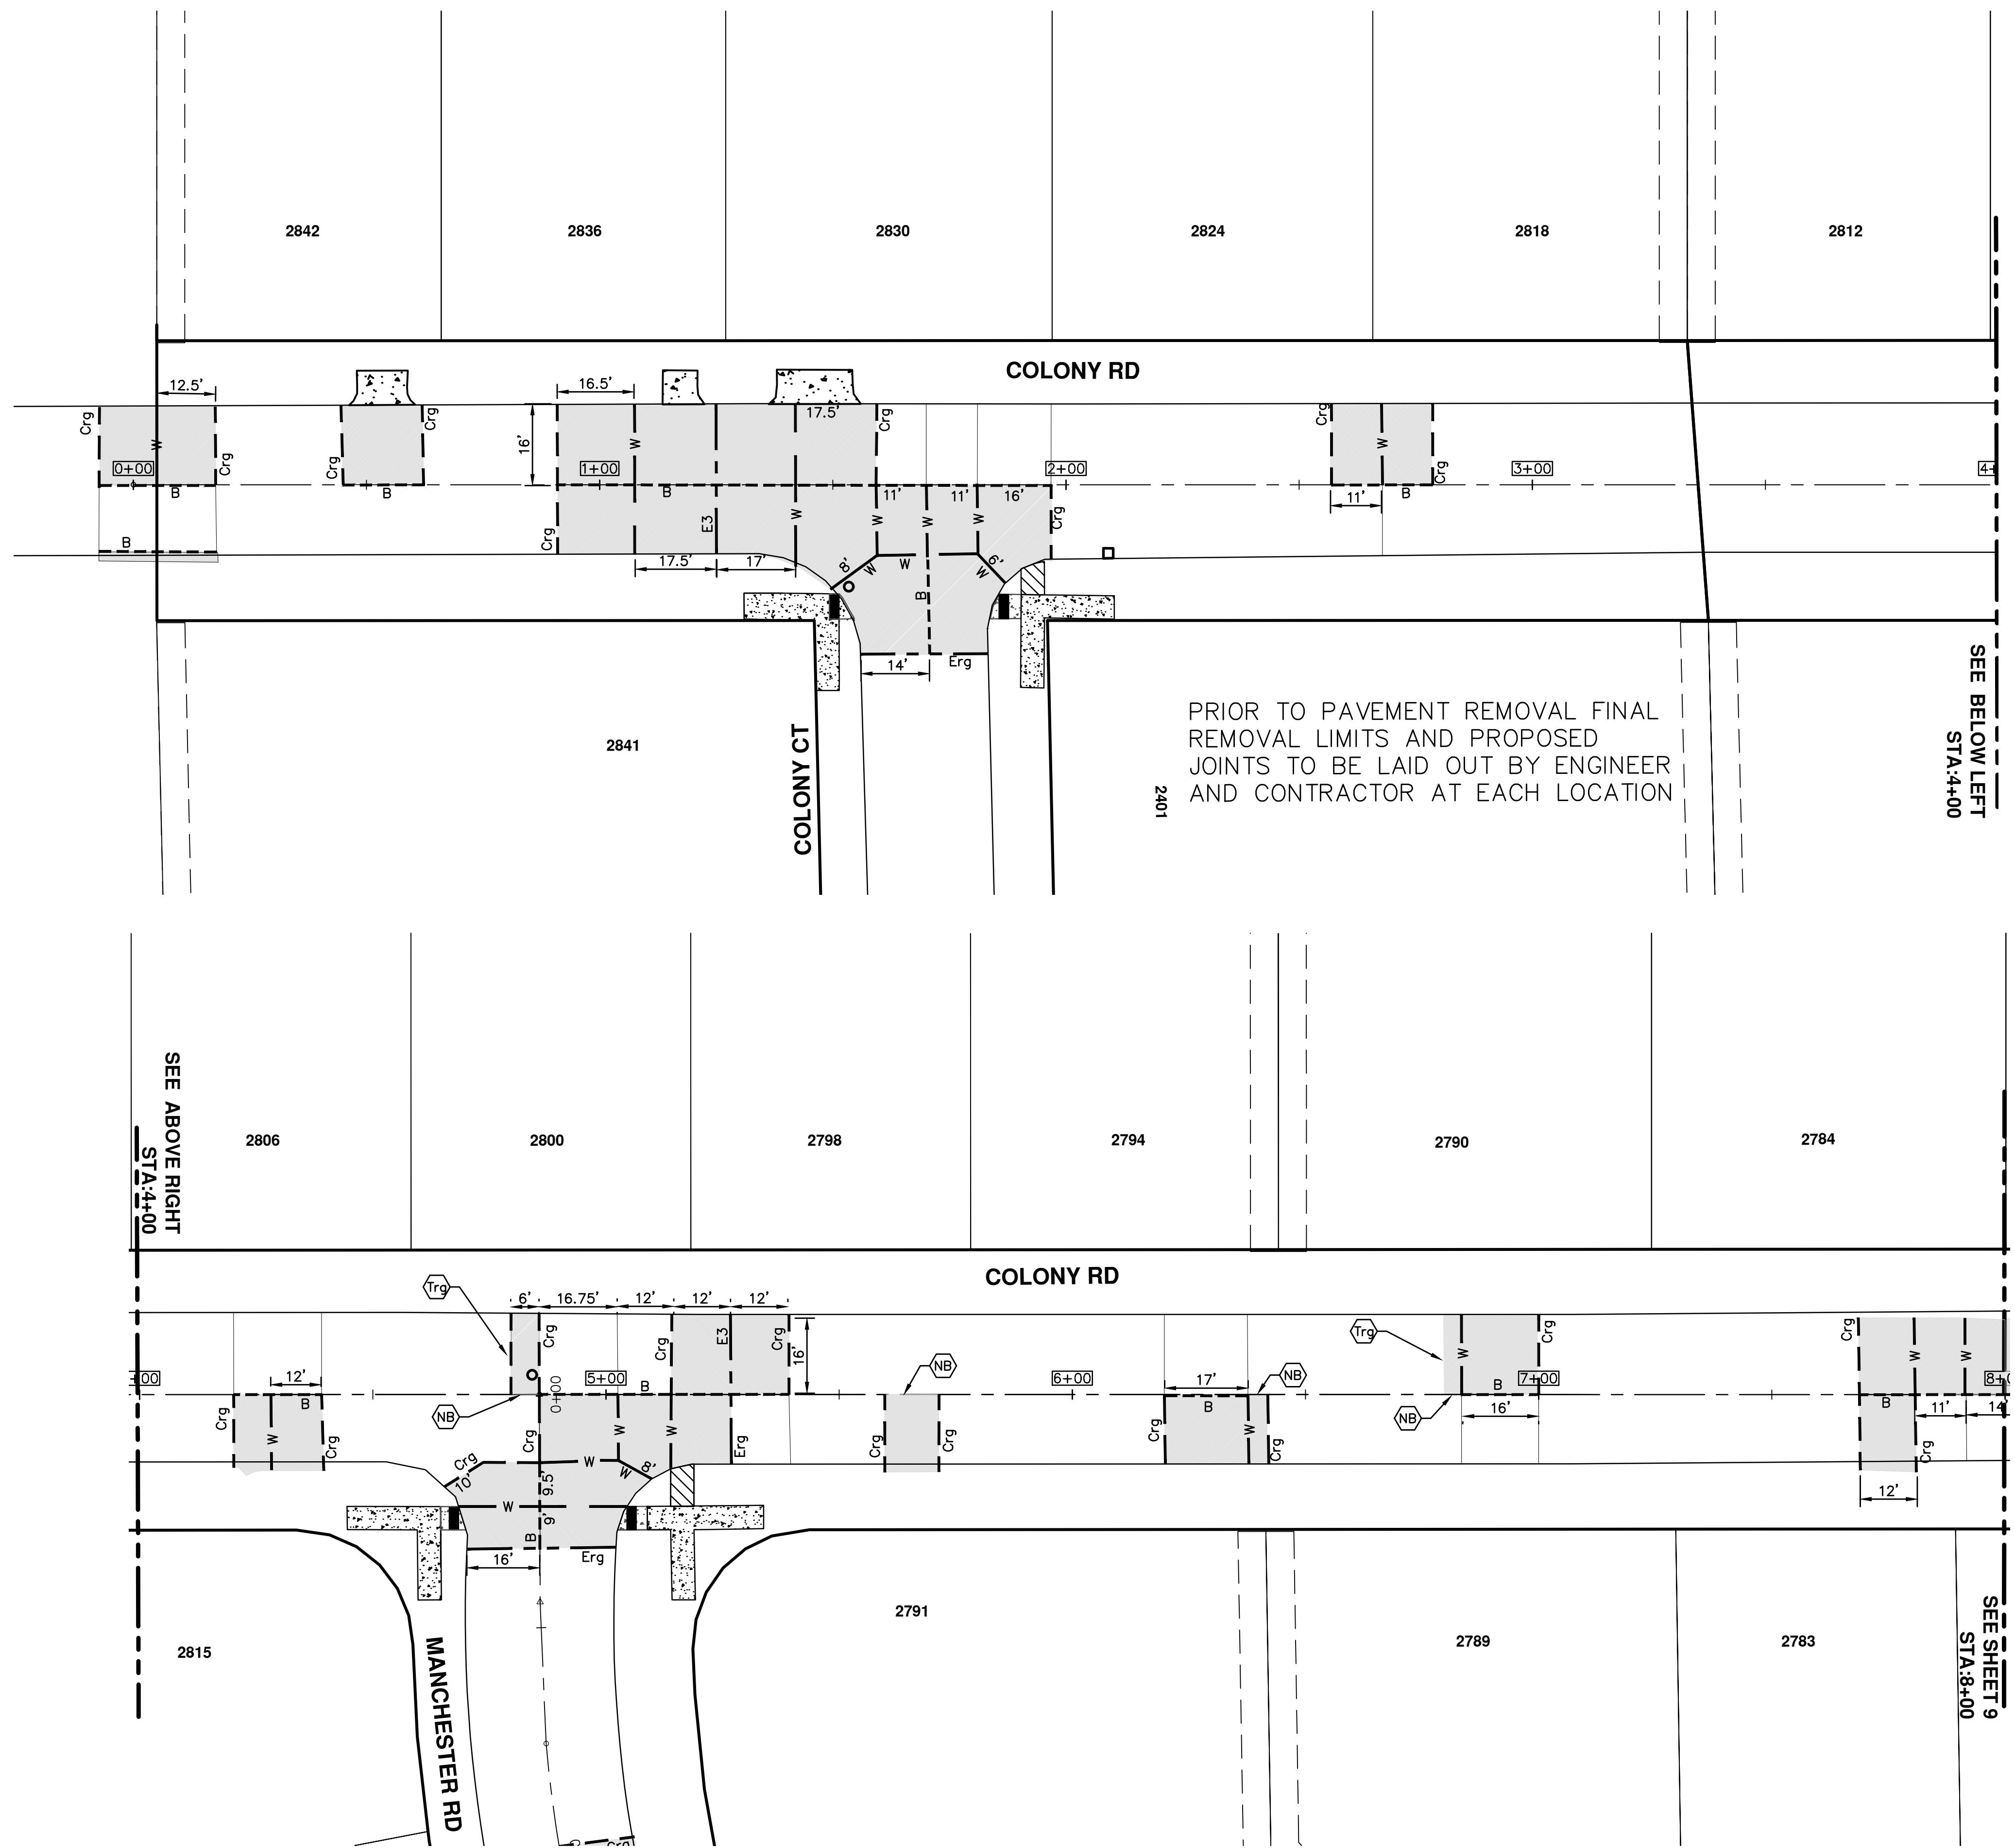
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**COLONY ESSEX MANCHESTER**  
**CONCRETE PAVEMENT REPAIR**

**COLONY RD**  
 STA 0+00 TO 8+00 REMOVAL AND CONSTRUCTION PLAN

PROJECT No. 2015024-10  
 DRAWING No. 2015024-10

SHEET No. **10 OF 27**

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**PROJECT MANAGEMENT - PUBLIC SERVICES - CITY OF ANN ARBOR**  
**COLONY ESSEX MANCHESTER**  
**CONCRETE PAVEMENT REPAIR**

SCALE PLAN: 1" = 20'  
 DRAWING No. 2015024-11

**811**  
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 301 EAST HURON STREET  
 ANN ARBOR, MI 48106-8647  
 ANN ARBOR: 734-794-4410  
 www.a2gov.org

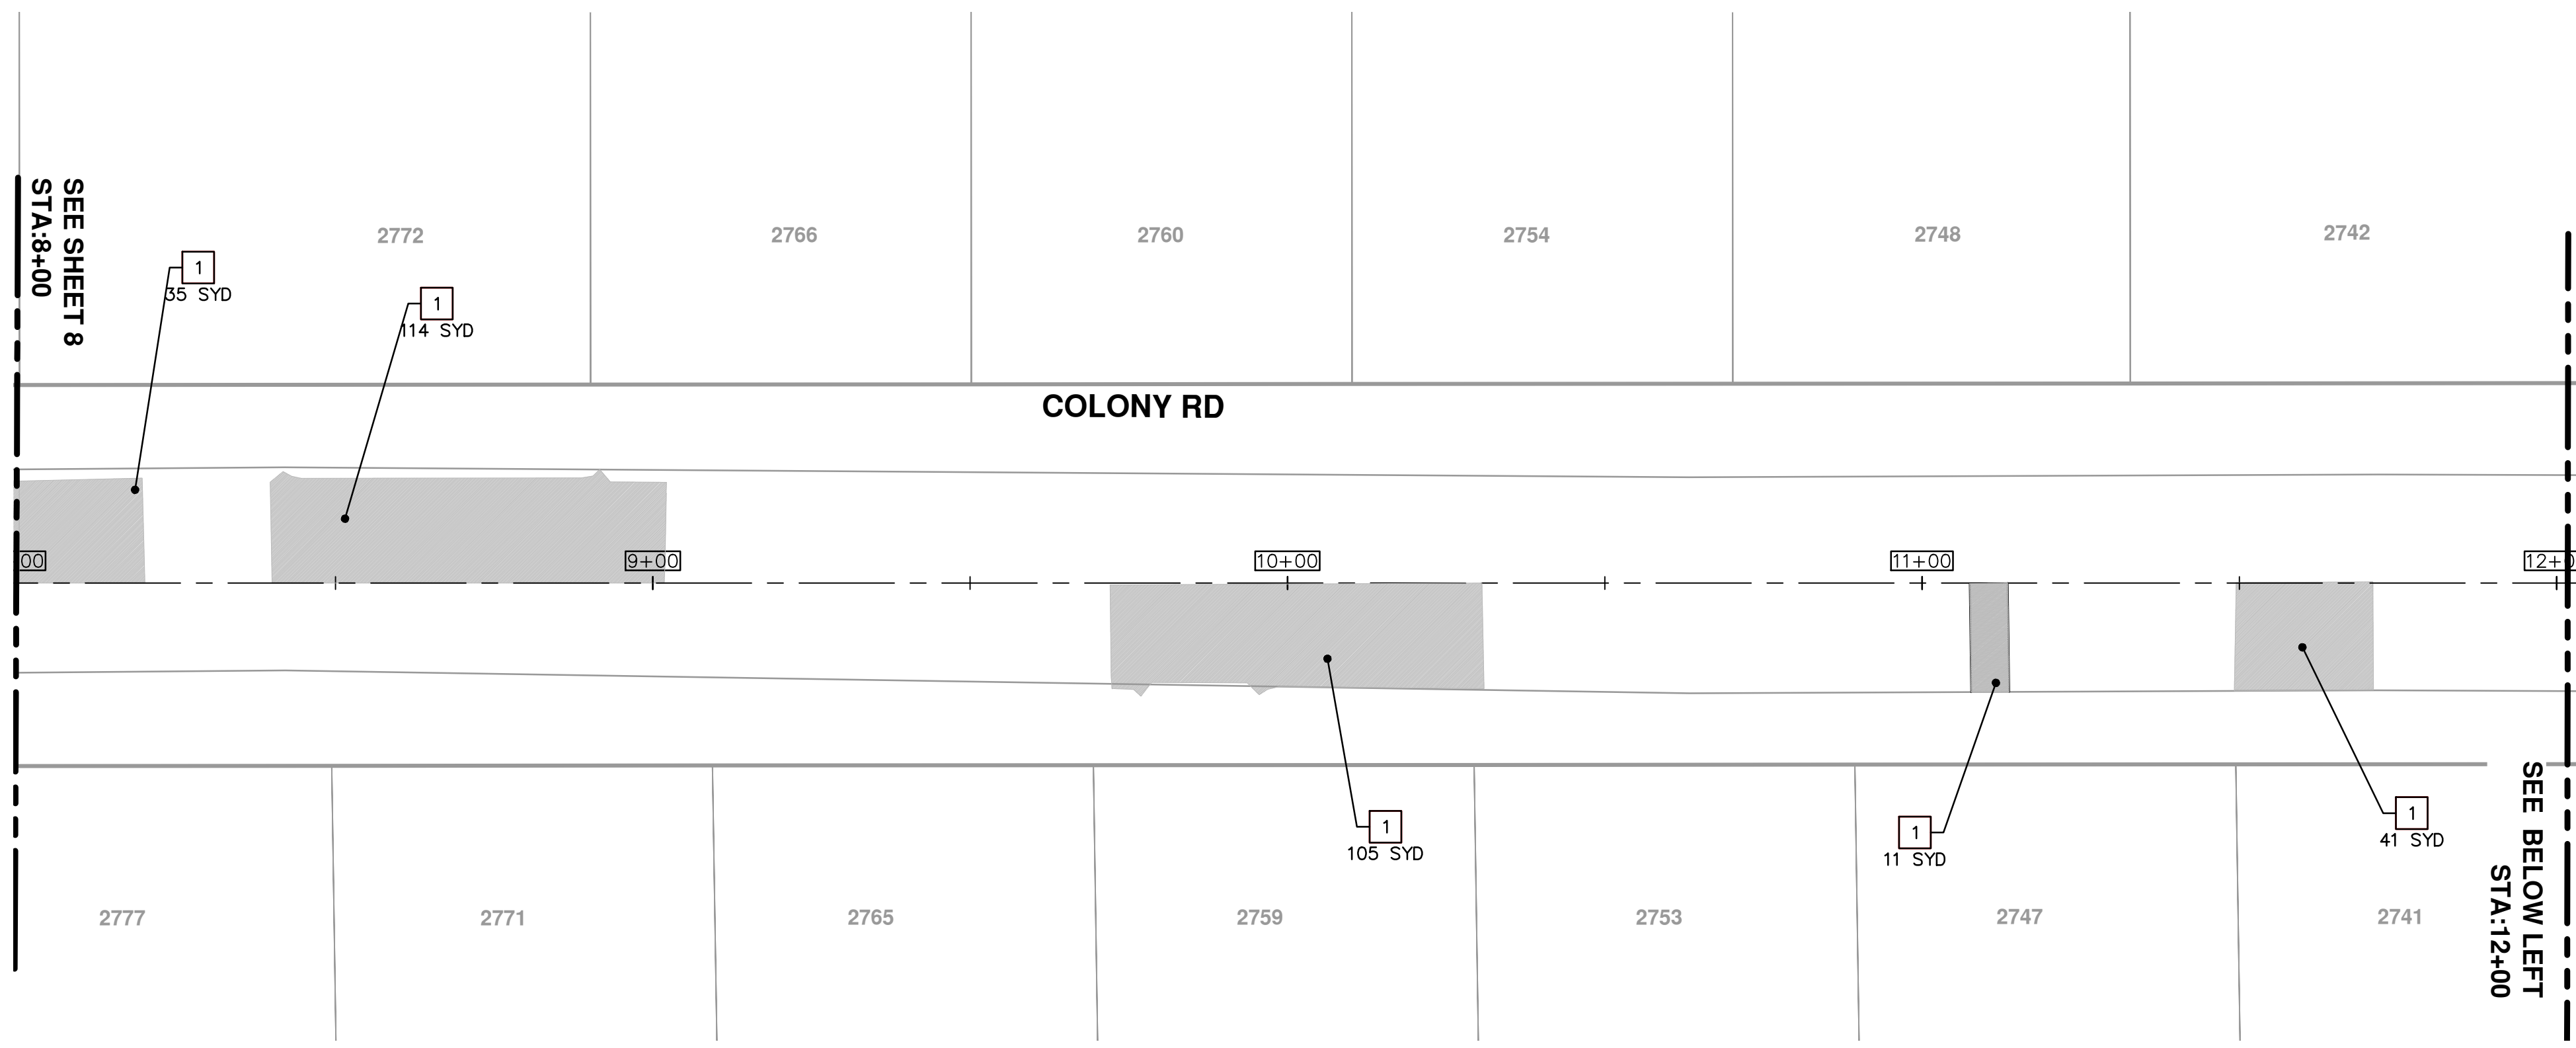
CITY OF ANN ARBOR  
 MICHIGAN

COLONY RD  
 STA 0+00 TO 8+00 JOINTING PLAN

REV.	DESCRIPTION	DATE	DRAWN	CHECKED

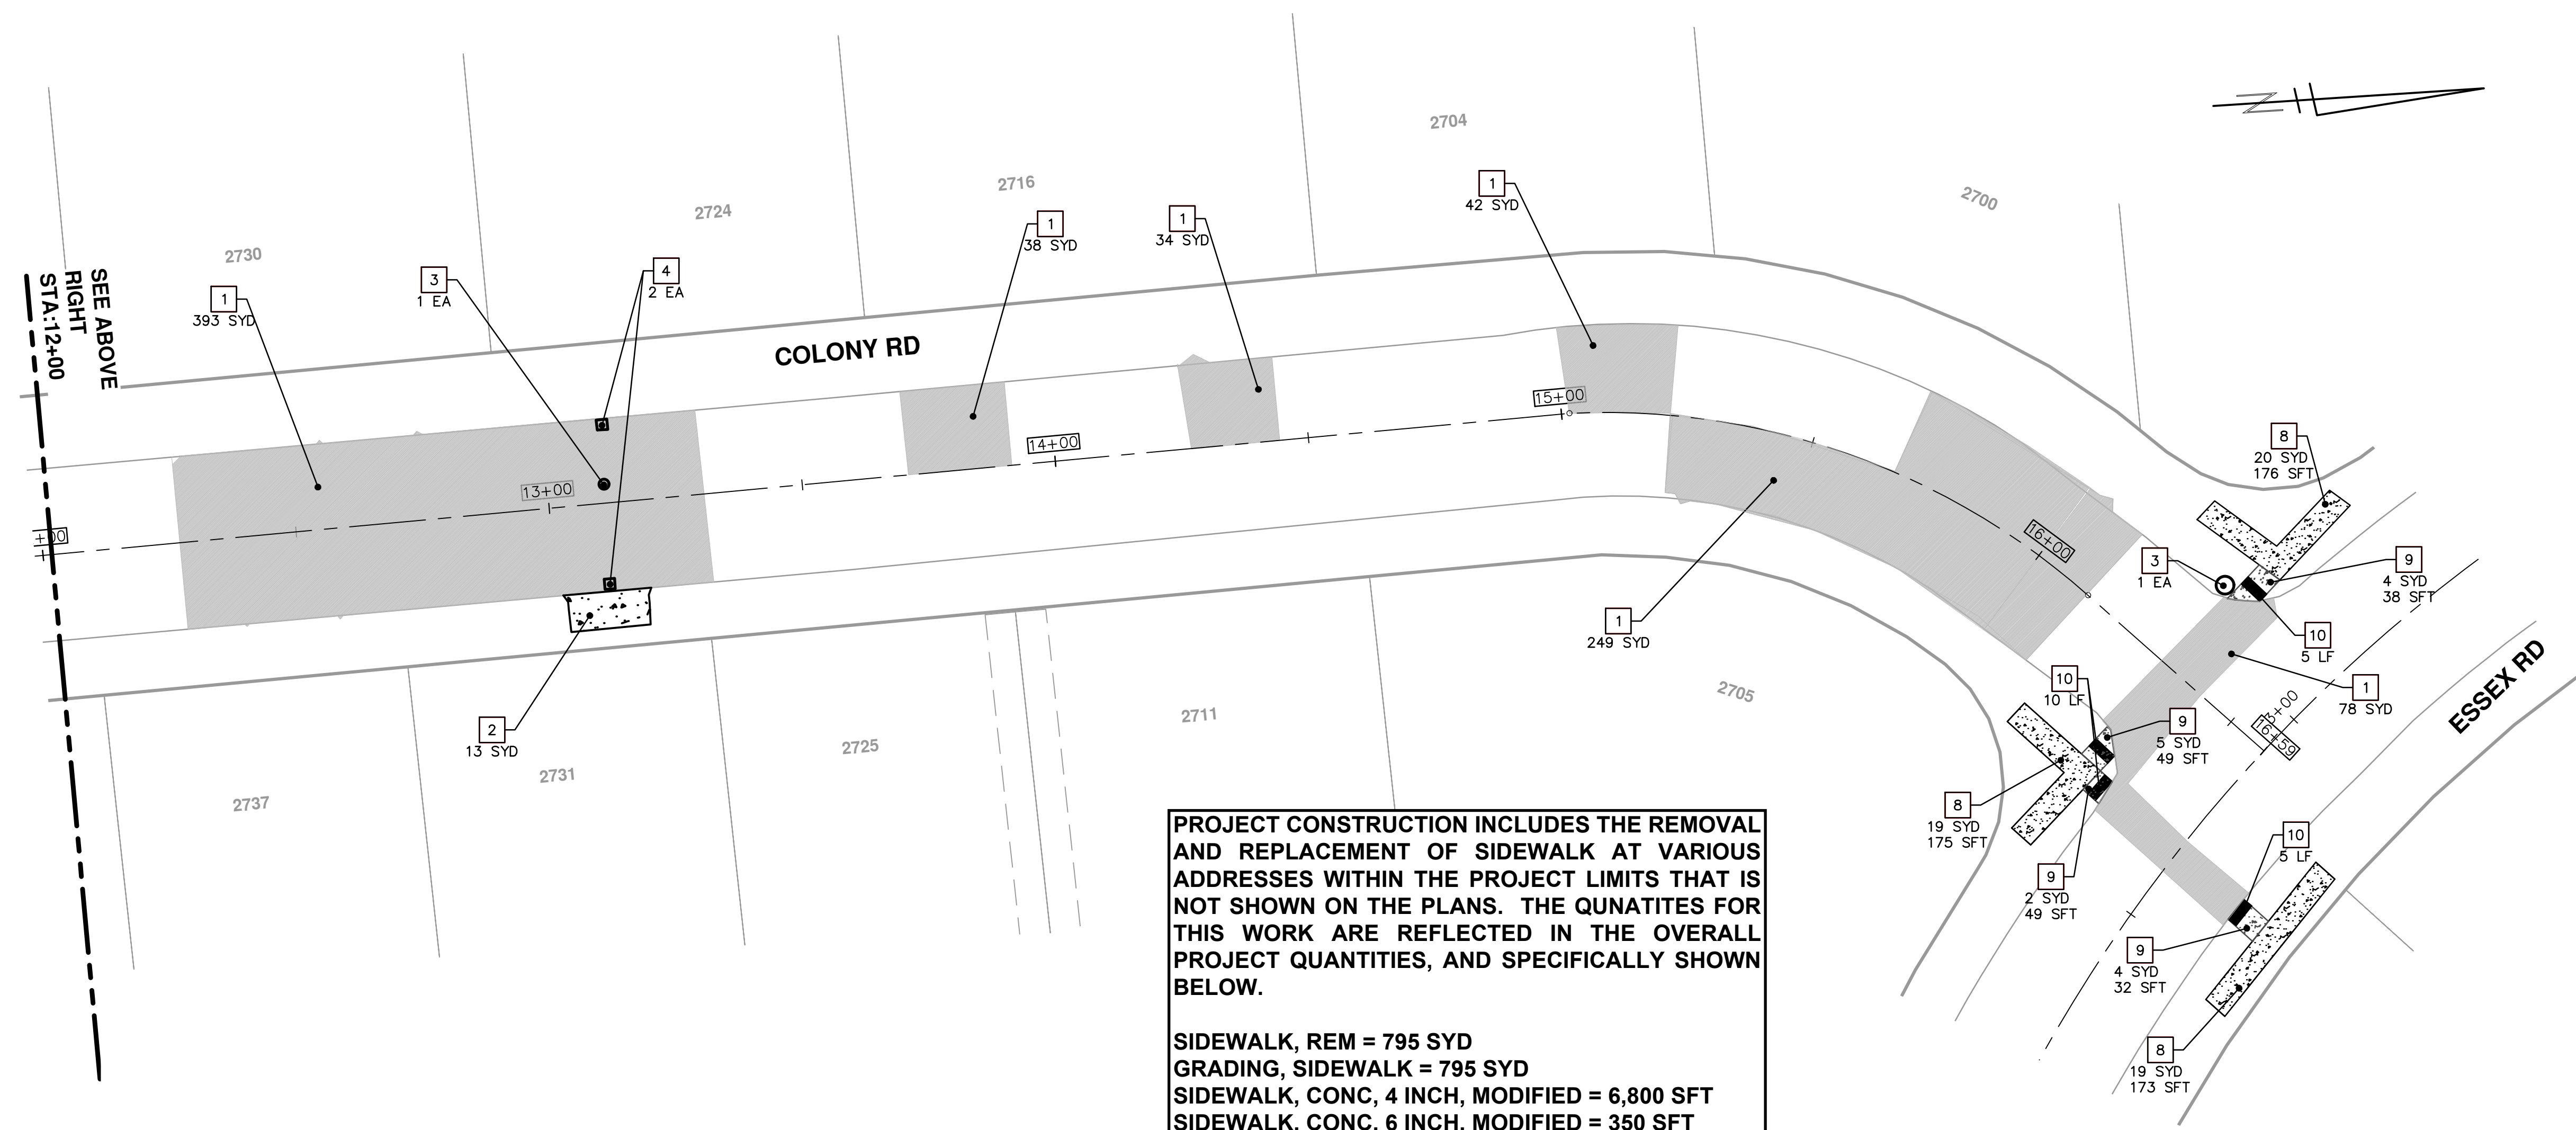
SHEET No. 11 OF 27

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CONSTRUCTION KEY	
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5	DR. STRUCTURE REMOVE, DR. STRUCTURE DOUBLE INLET, AND DR. COVER TYPE K MODIFIED
6	GATE BOX ADJ. CASE 1, AND MONUMENT BOX, OR GAS BOX
7	SIDEWALK REMOVAL
8	SIDEWALK REMOVAL, SIDEWALK CONC. 4 INCH
9	SIDEWALK REMOVAL, SIDEWALK RAMP CONC 6 INCH
10	DETECTABLE WARNING SURFACE

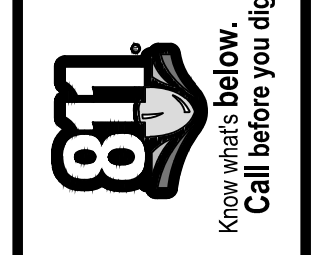
SEE BELOW LEFT  
STA:12+00



SEE ABOVE  
RIGHT  
STA:12+00

**PROJECT CONSTRUCTION INCLUDES THE REMOVAL AND REPLACEMENT OF SIDEWALK AT VARIOUS ADDRESSES WITHIN THE PROJECT LIMITS THAT IS NOT SHOWN ON THE PLANS. THE QUANTITIES FOR THIS WORK ARE REFLECTED IN THE OVERALL PROJECT QUANTITIES, AND SPECIFICALLY SHOWN BELOW.**

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**GRADING, SIDEWALK = 795 SYD**  
**SIDEWALK, CONC, 4 INCH, MODIFIED = 6,800 SFT**  
**SIDEWALK. CONC. 6 INCH. MODIFIED = 350 SFT**



REV.	DESCRIPTION	DATE	DRAWN	CHECKED

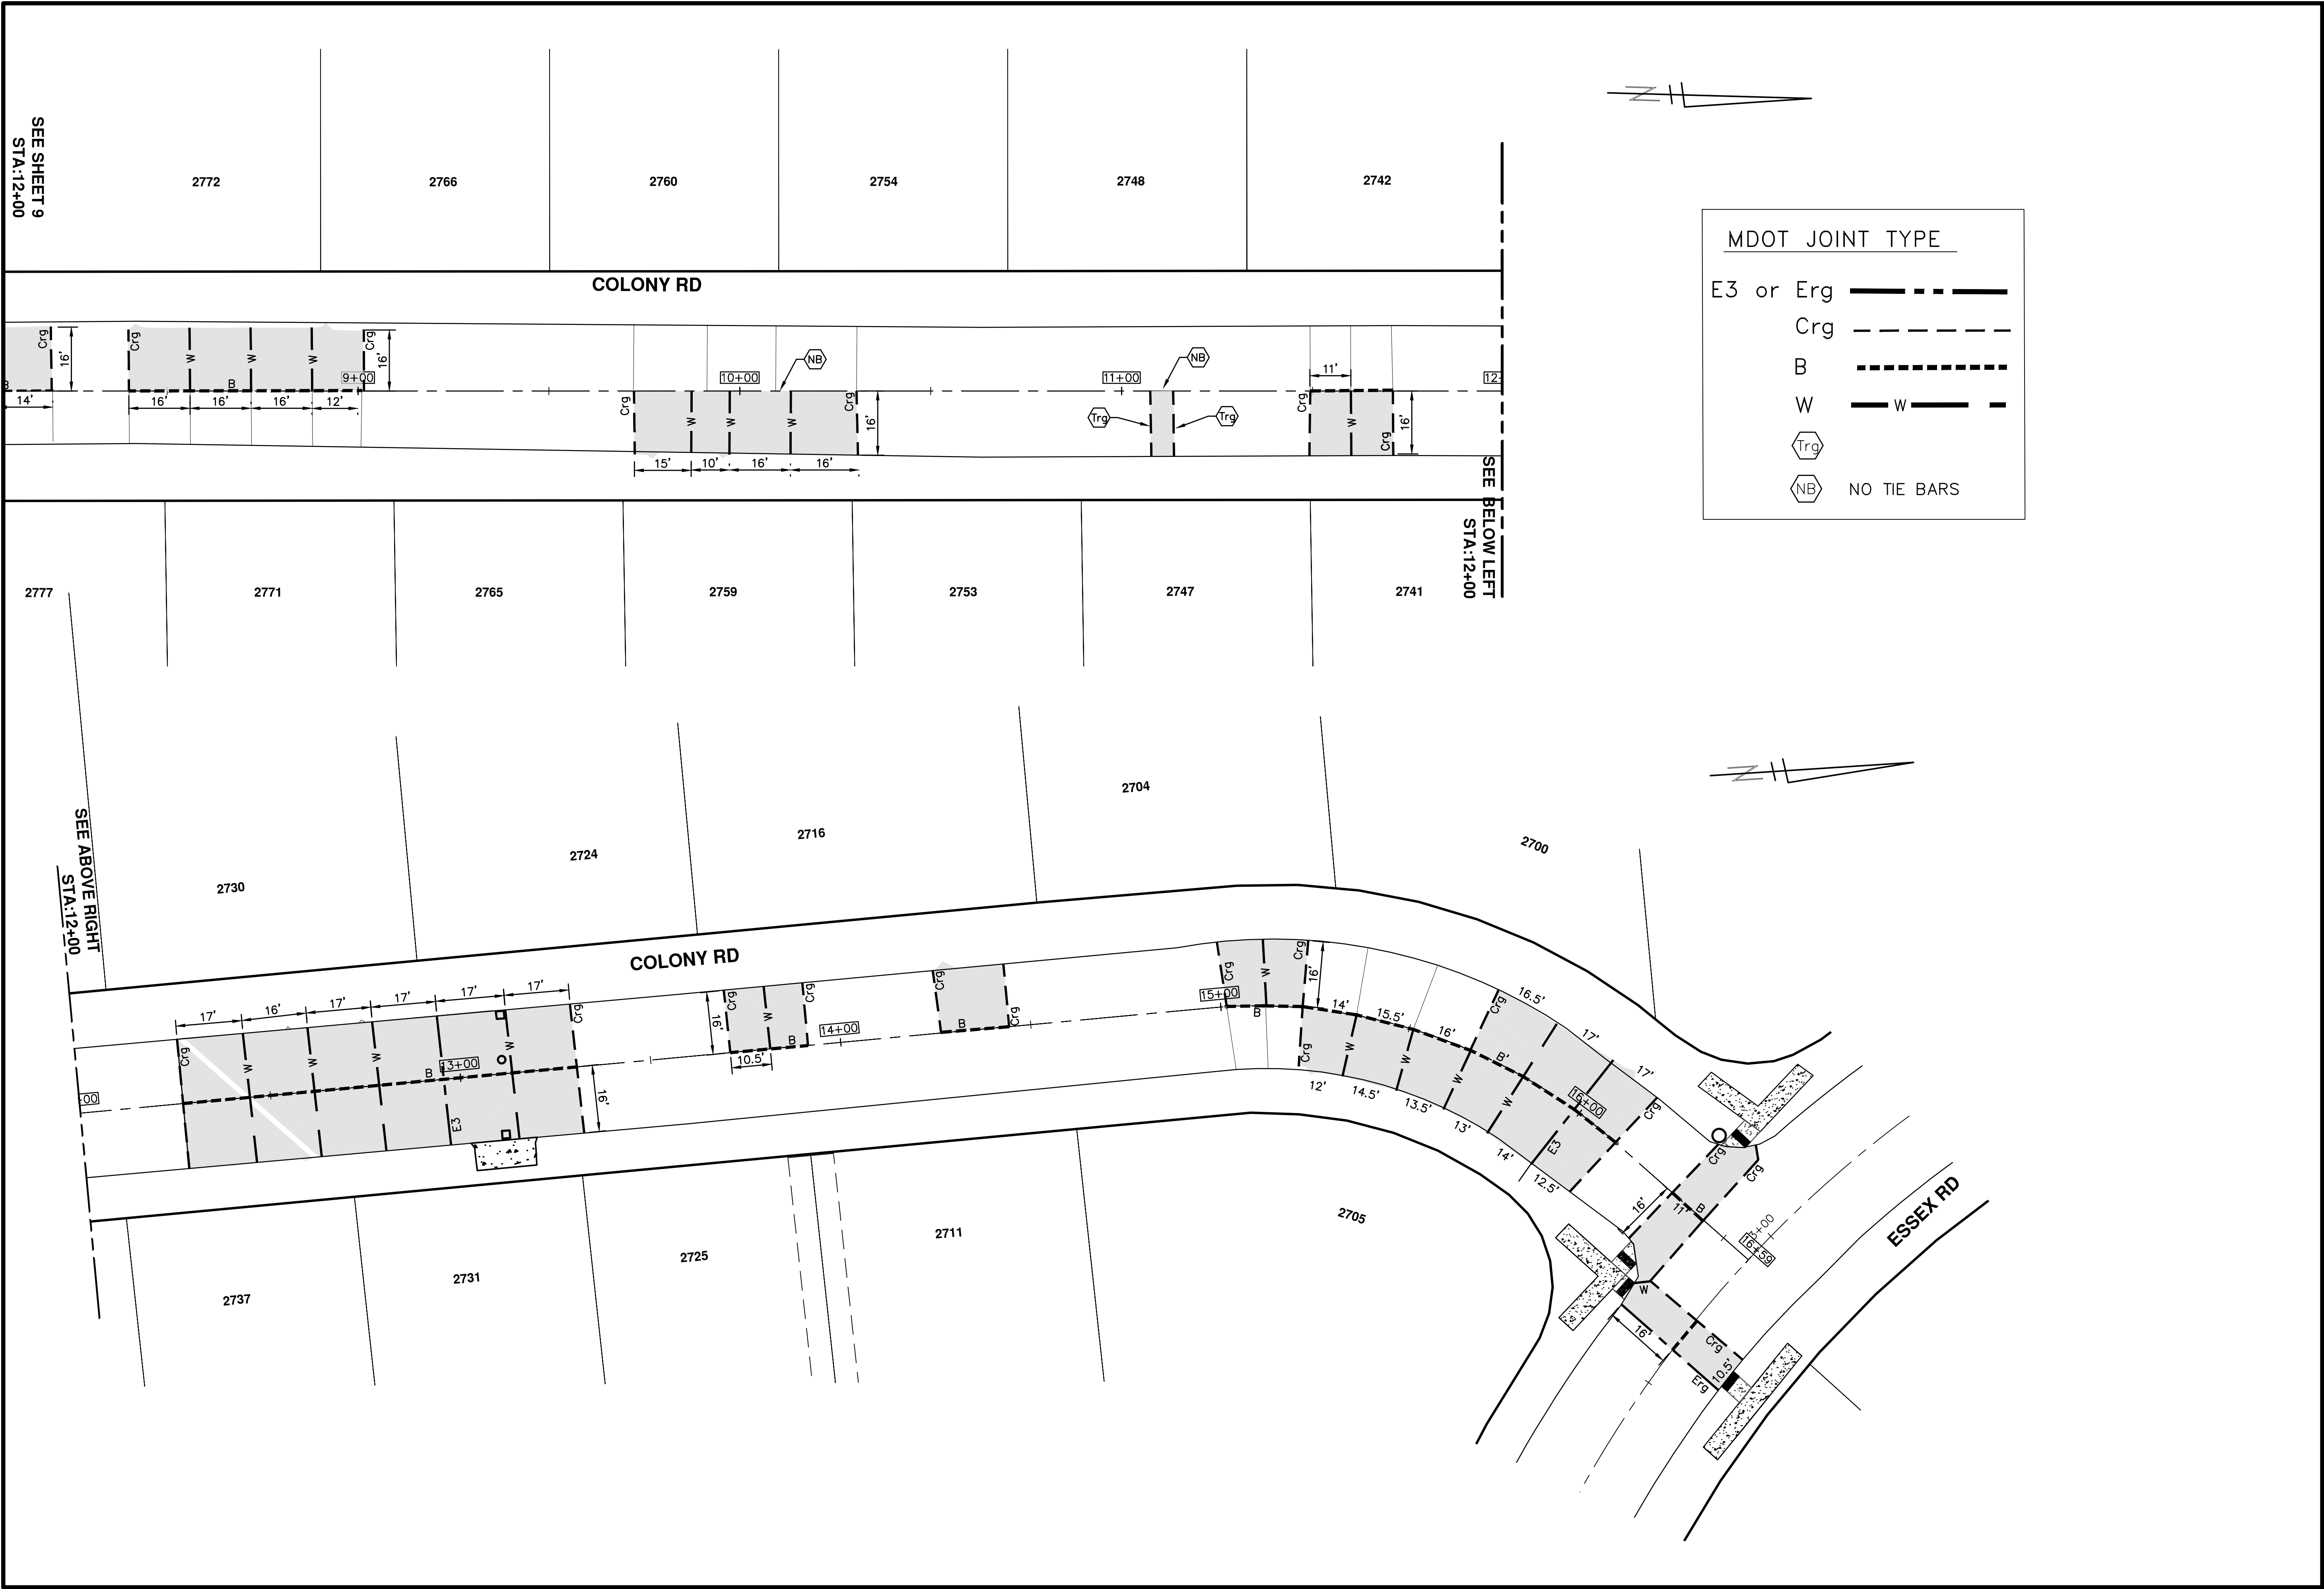
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PUBLIC SERVICES  
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ANN ARBOR MI 48106-0667  
www.a2gov.org






**PROJECT MANAGEMENT - PUBLIC SERVICES - CITY OF ANN ARBOR**  
**COLONY ESSEX MANCHESTER**  
**CONCRETE PAVEMENT REPAIR**  
 COLONY RD  
 STA 8+00 TO 16+00 REMOVAL AND CONSTRUCTION PLAN

SCALE PLAN: 1" = 20'  
 DRAWING No. 2015024-12

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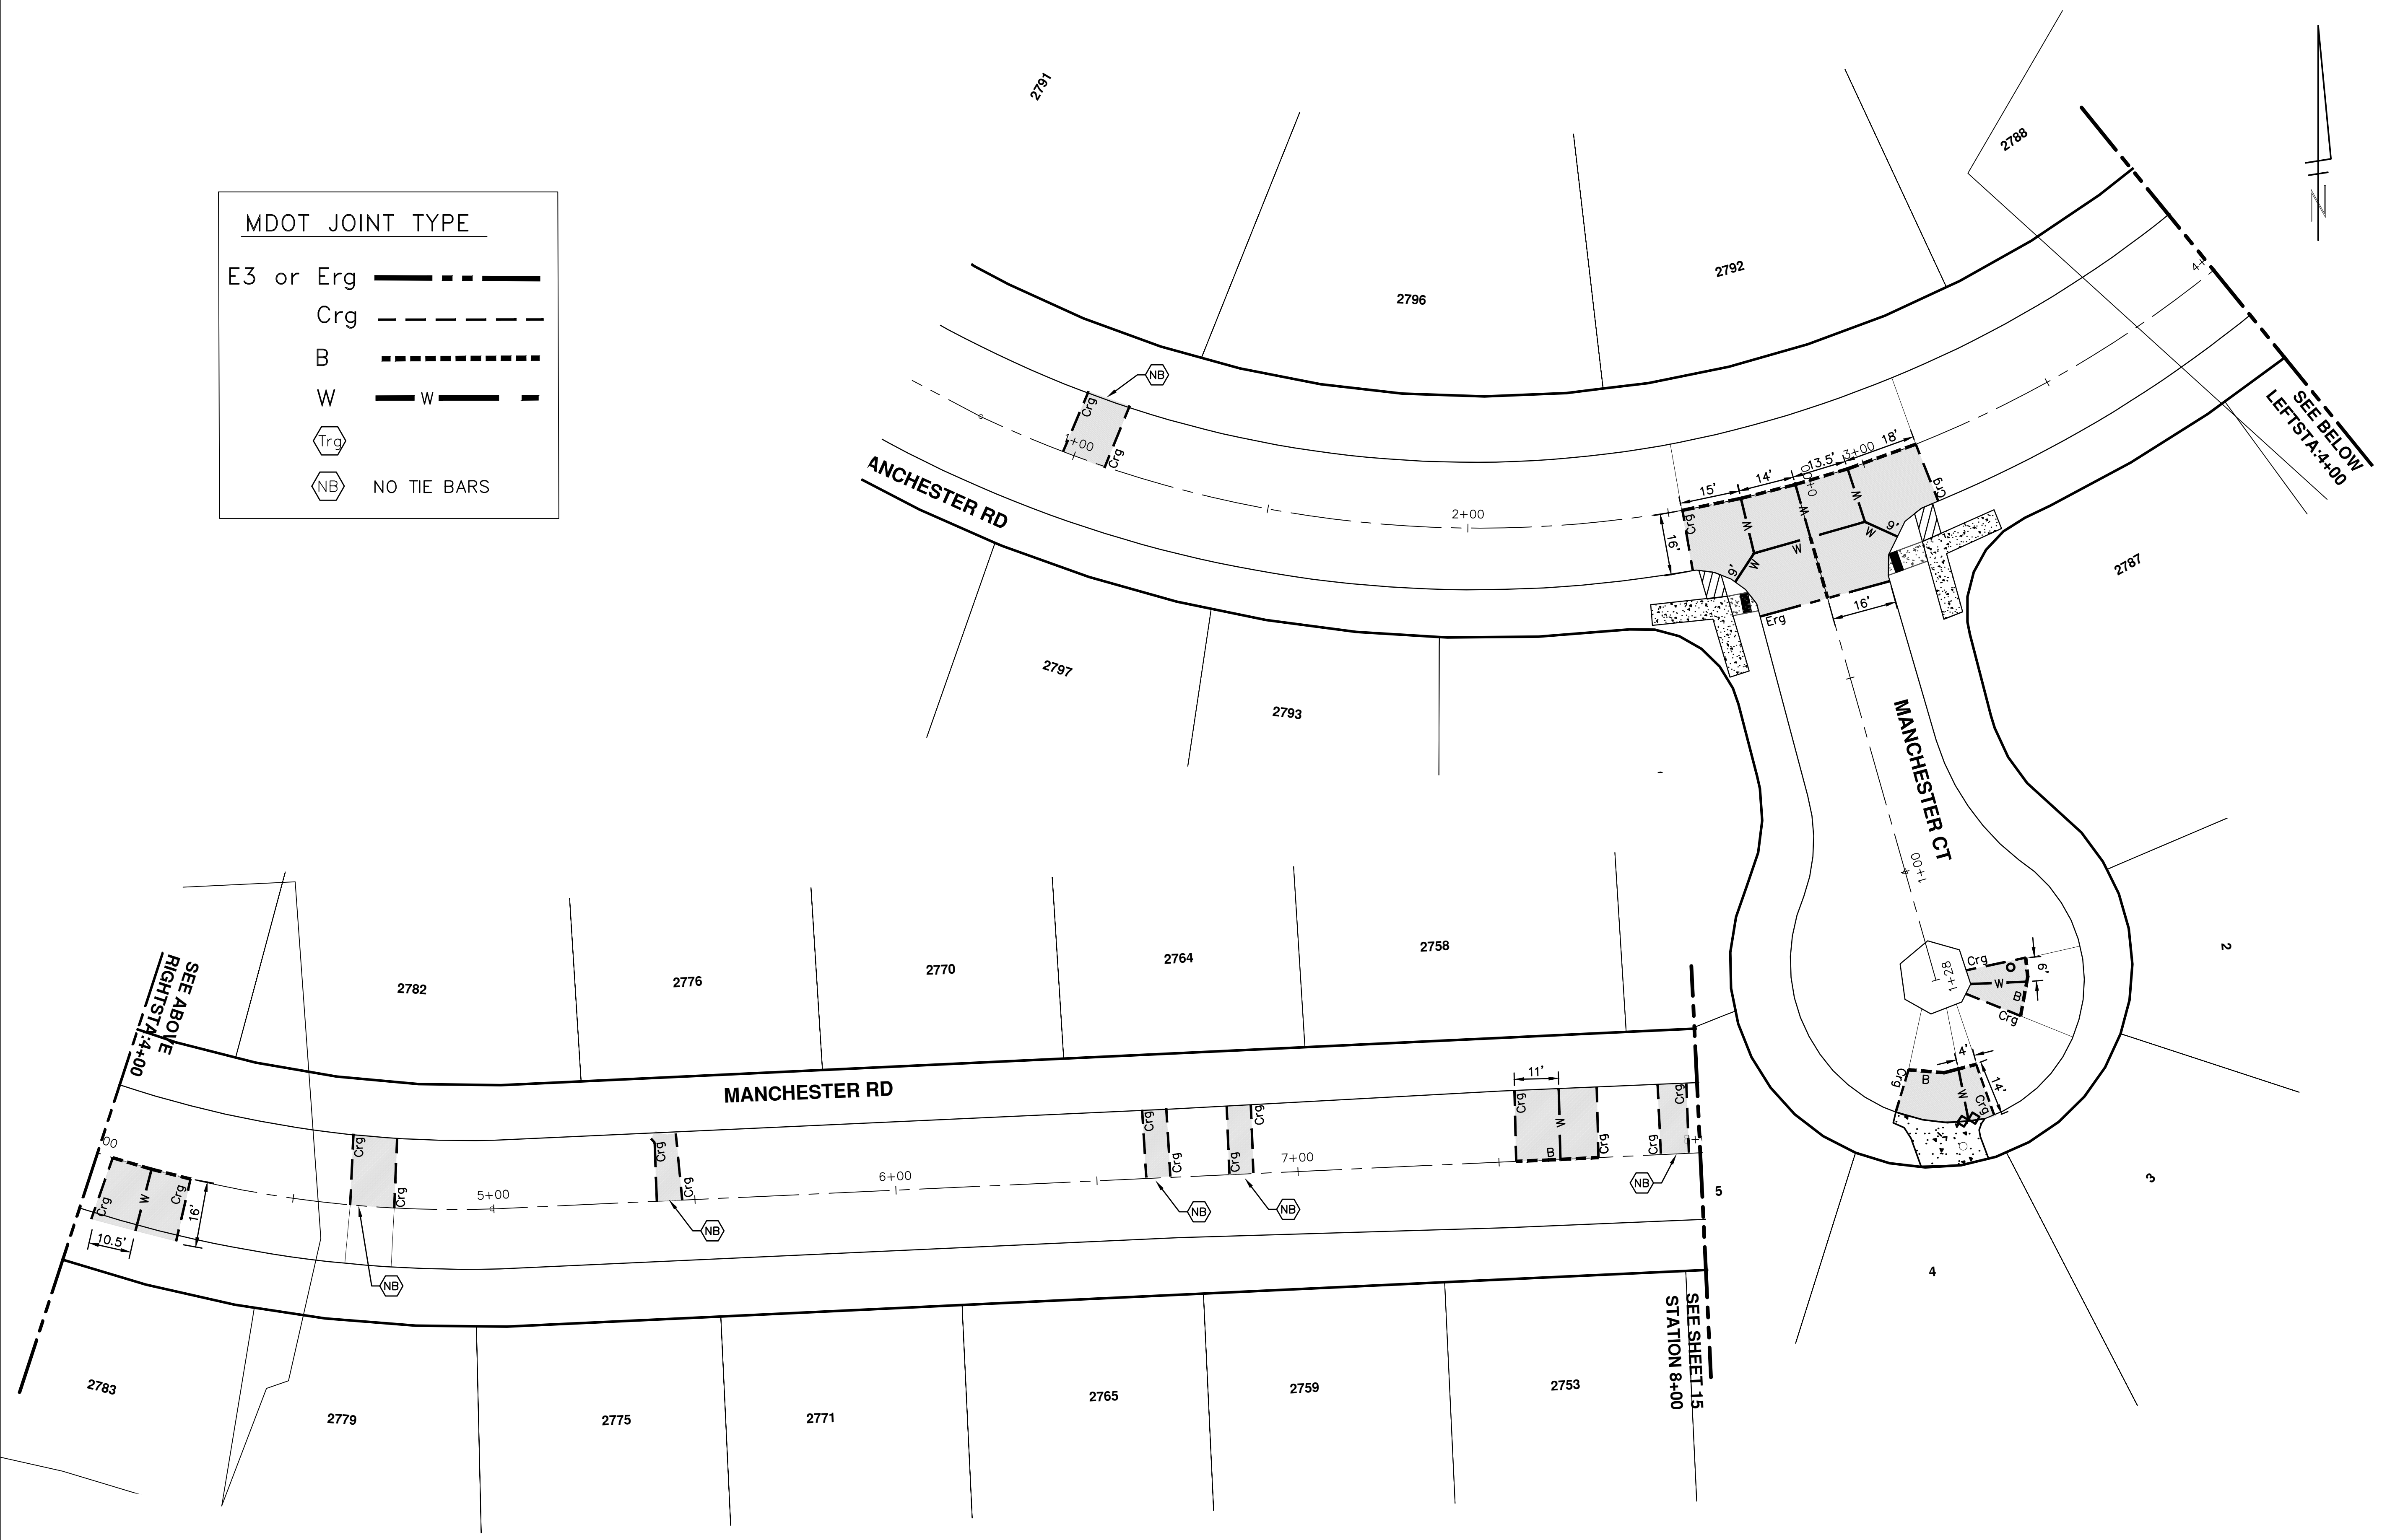


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<b>PROJECT MANAGEMENT - PUBLIC SERVICES - CITY OF ANN ARBOR</b> <b>COLONY ESSEX MANCHESTER</b> <b>CONCRETE PAVEMENT REPAIR</b>				
SCALE PLAN: 1" = 20' 			DRAWING No. <b>2015024-13</b>	
SHEET No. <b>13 OF 27</b>				



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MDOT JOINT TYPE	
E3 or Erg	
Crg	
B	
W	
	Trg
	NB NO TIE BARS



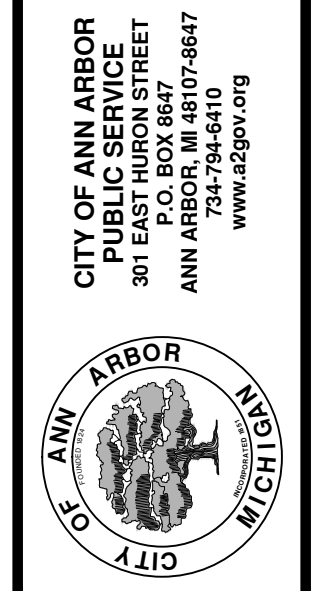
SEE ABOVE  
RIGHT STA: 4+00

SEE SHEET 15  
STATION 8+00

SEE BELOW  
LEFT STA: 4+00

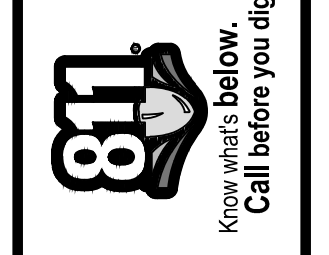
**PROJECT MANAGEMENT - PUBLIC SERVICES - CITY OF ANN ARBOR**  
**COLONY ESSEX MANCHESTER**  
**CONCRETE PAVEMENT REPAIR**  
 MANCHESTER RD  
 STA 0+00 TO 8+00 AND MANCHESTER CT JOINTING PLAN

SCALE PLAN: 1" = 20'  
 DRAWING No. 2015024-15

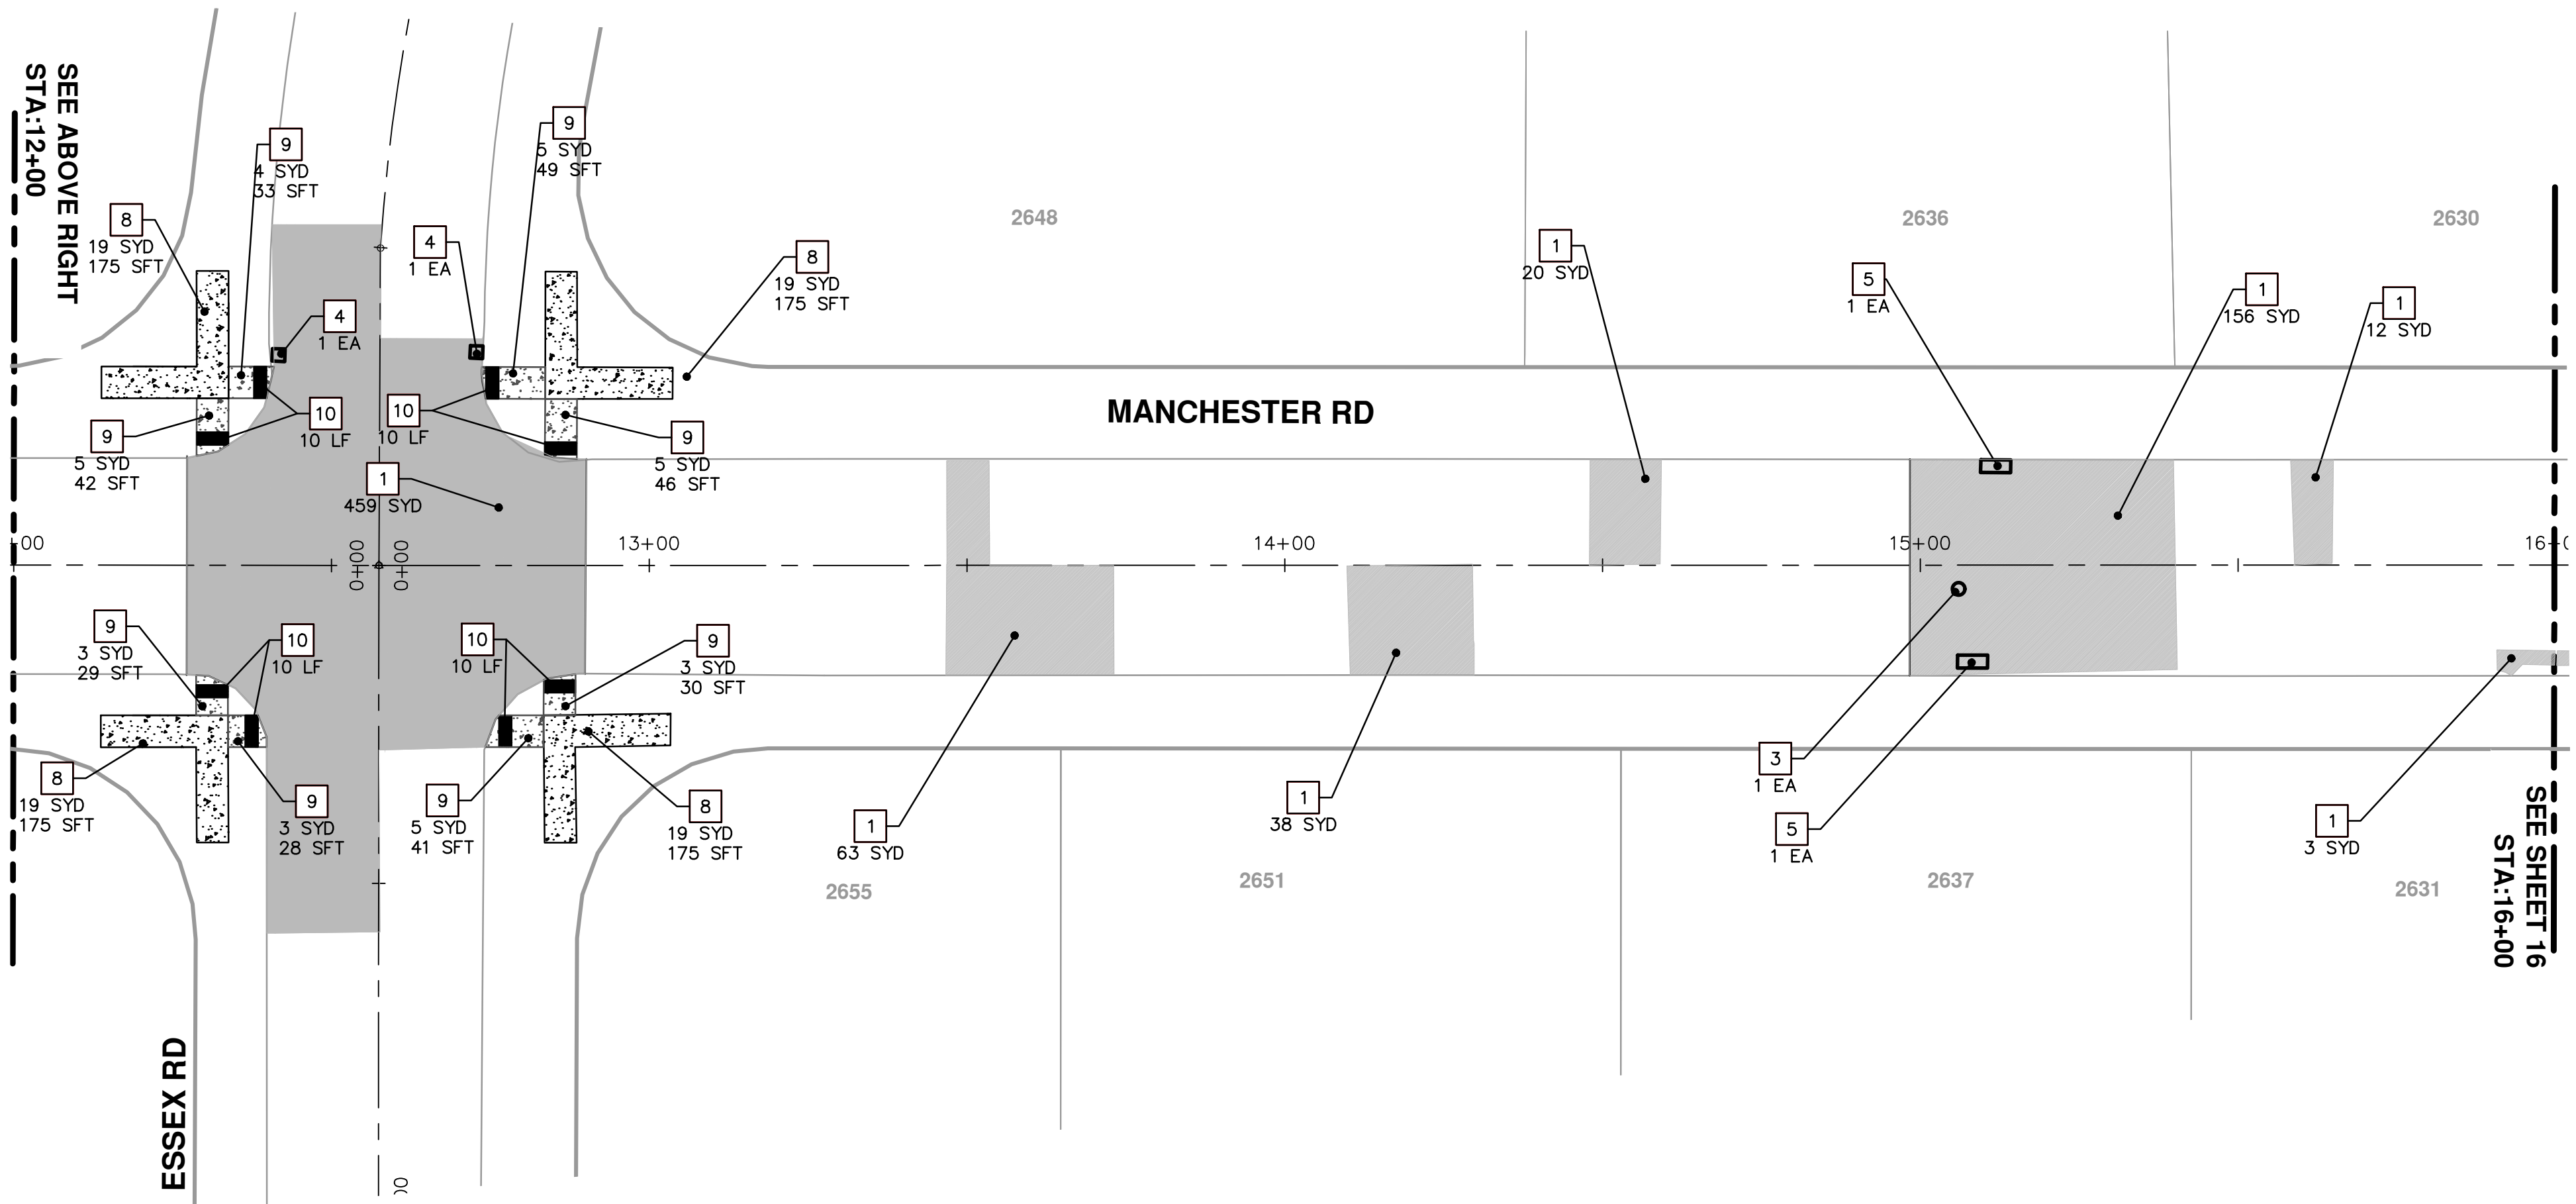
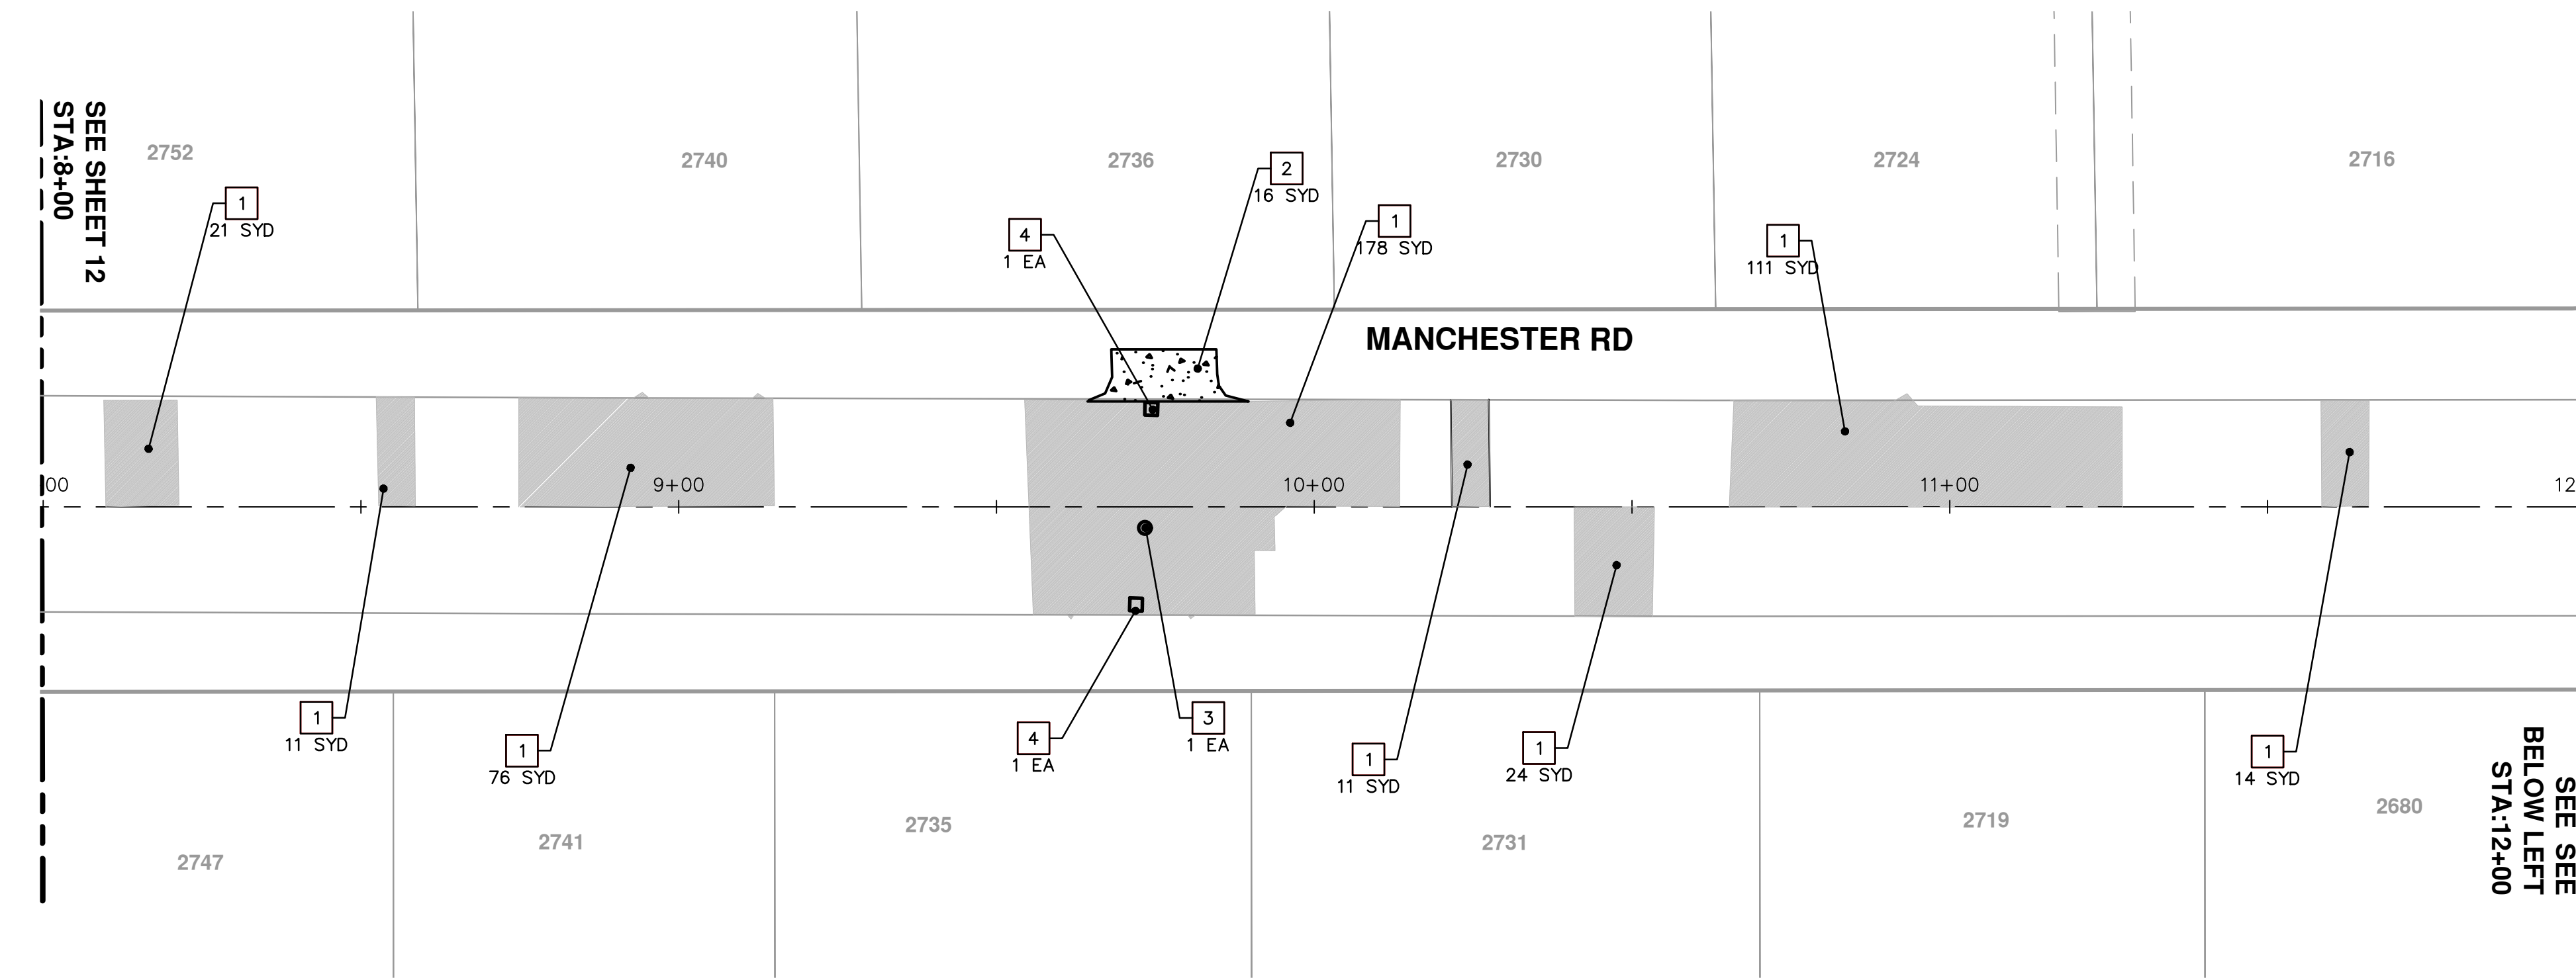


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 PUBLIC SERVICE  
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 ANN ARBOR, MI 48106-8647  
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7	SIDEWALK REMOVAL
8	SIDEWALK REMOVAL, SIDEWALK CONC. 4 INCH
9	SIDEWALK REMOVAL, SIDEWALK RAMP CONC 6 INCH
10	DETECTABLE WARNING SURFACE

**PROJECT MANAGEMENT - PUBLIC SERVICES - CITY OF ANN ARBOR**  
 COLONY ESSEX MANCHESTER  
 CONCRETE PAVEMENT REPAIR  
 MANCHESTER RD  
 STA 8+00 TO 16+00 REMOVAL AND CONSTRUCTION PLAN

SCALE PLAN: 1" = 20'  
 DRAWING No. 2015024-16

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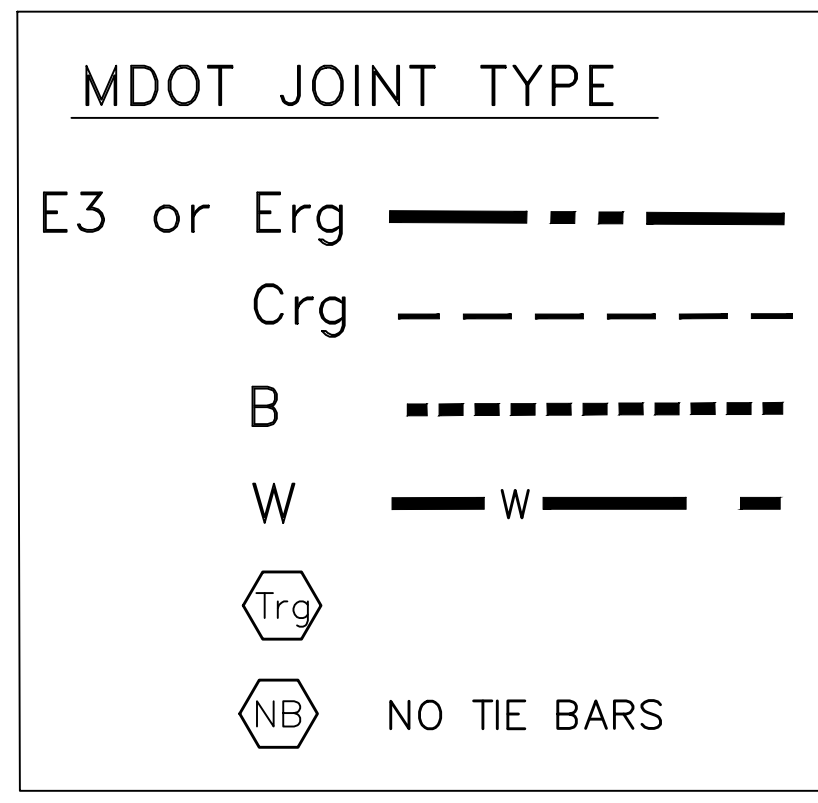
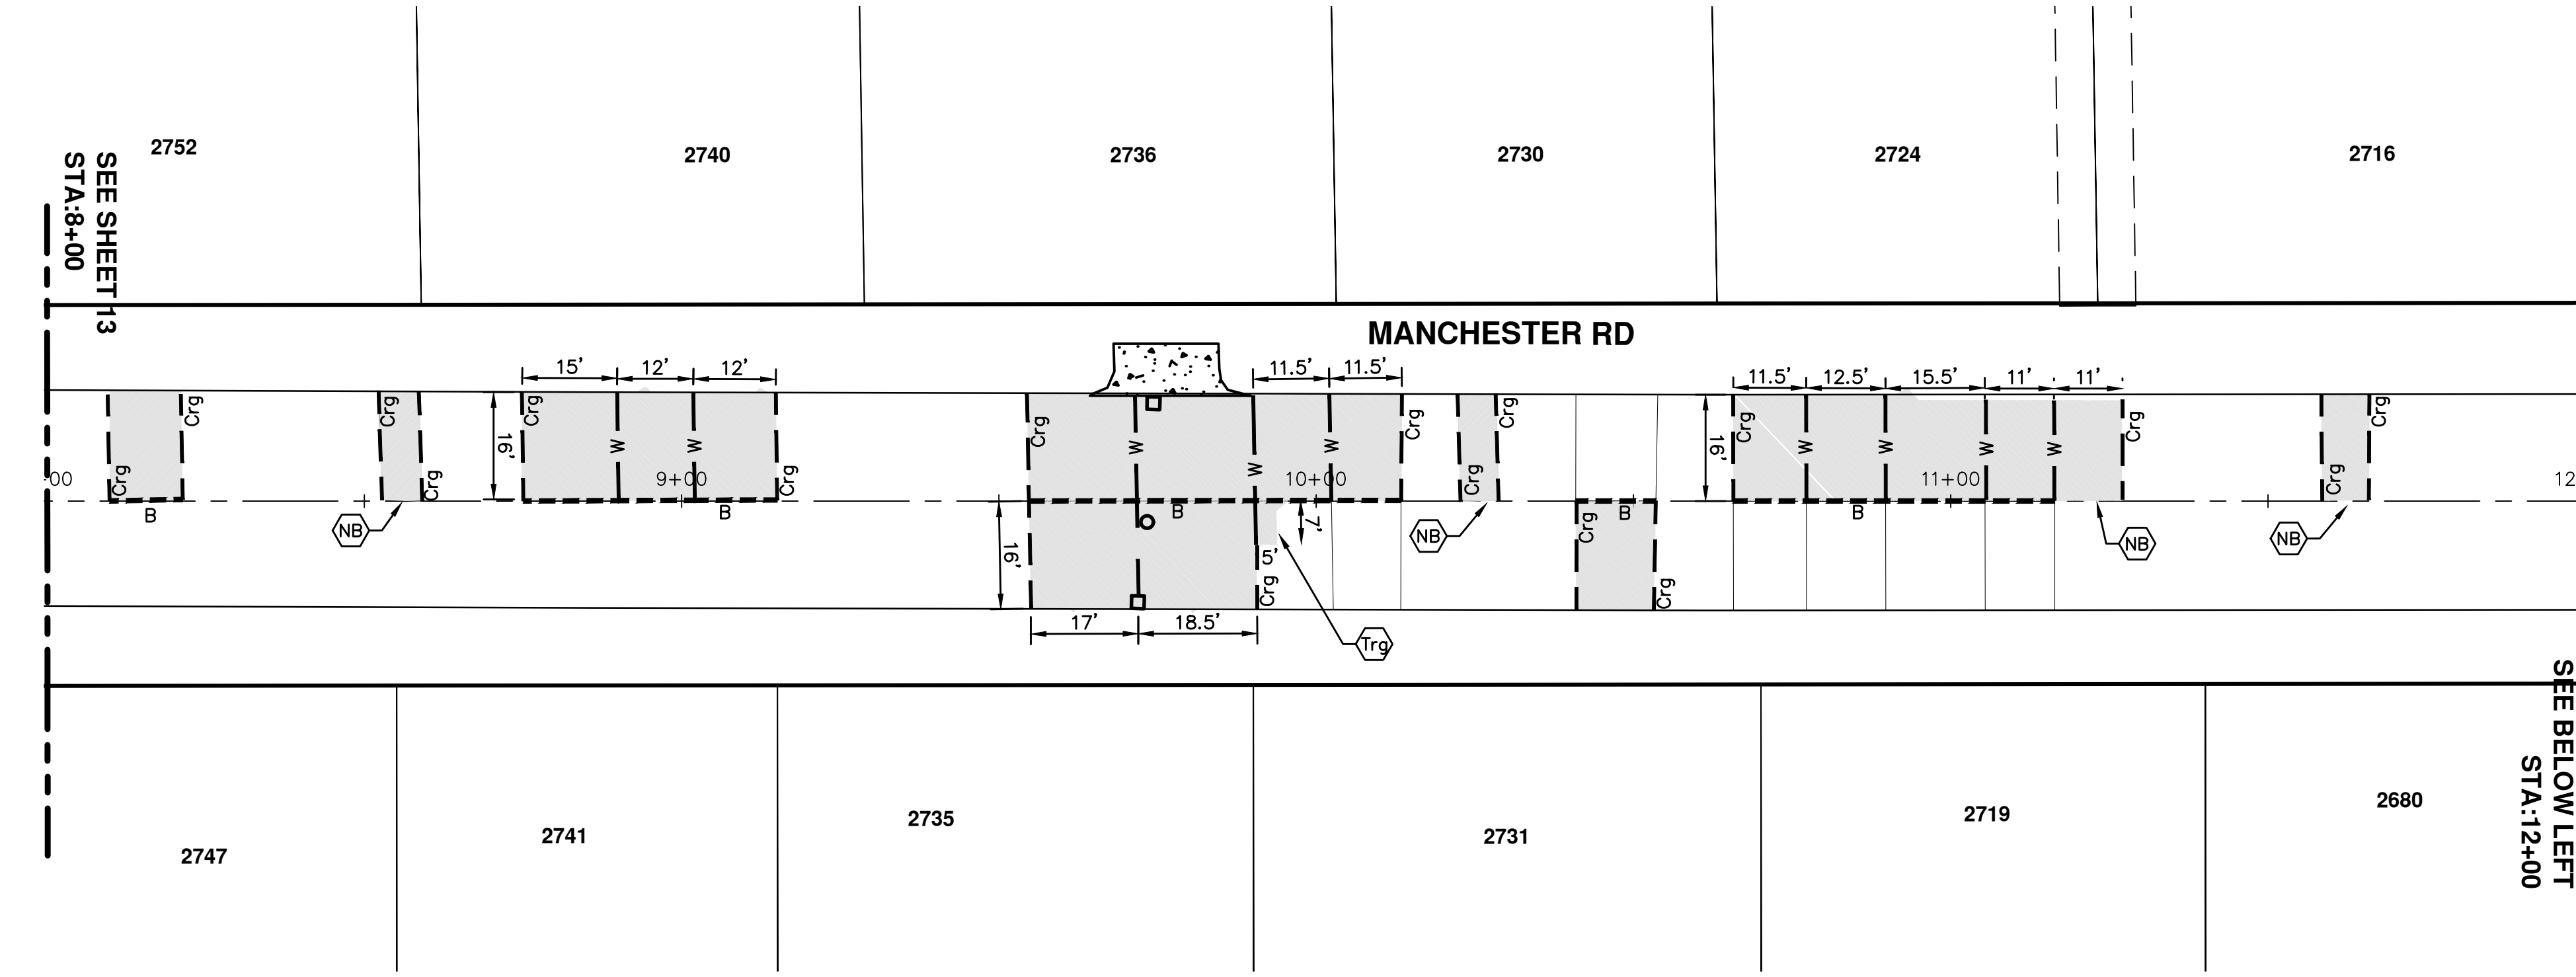
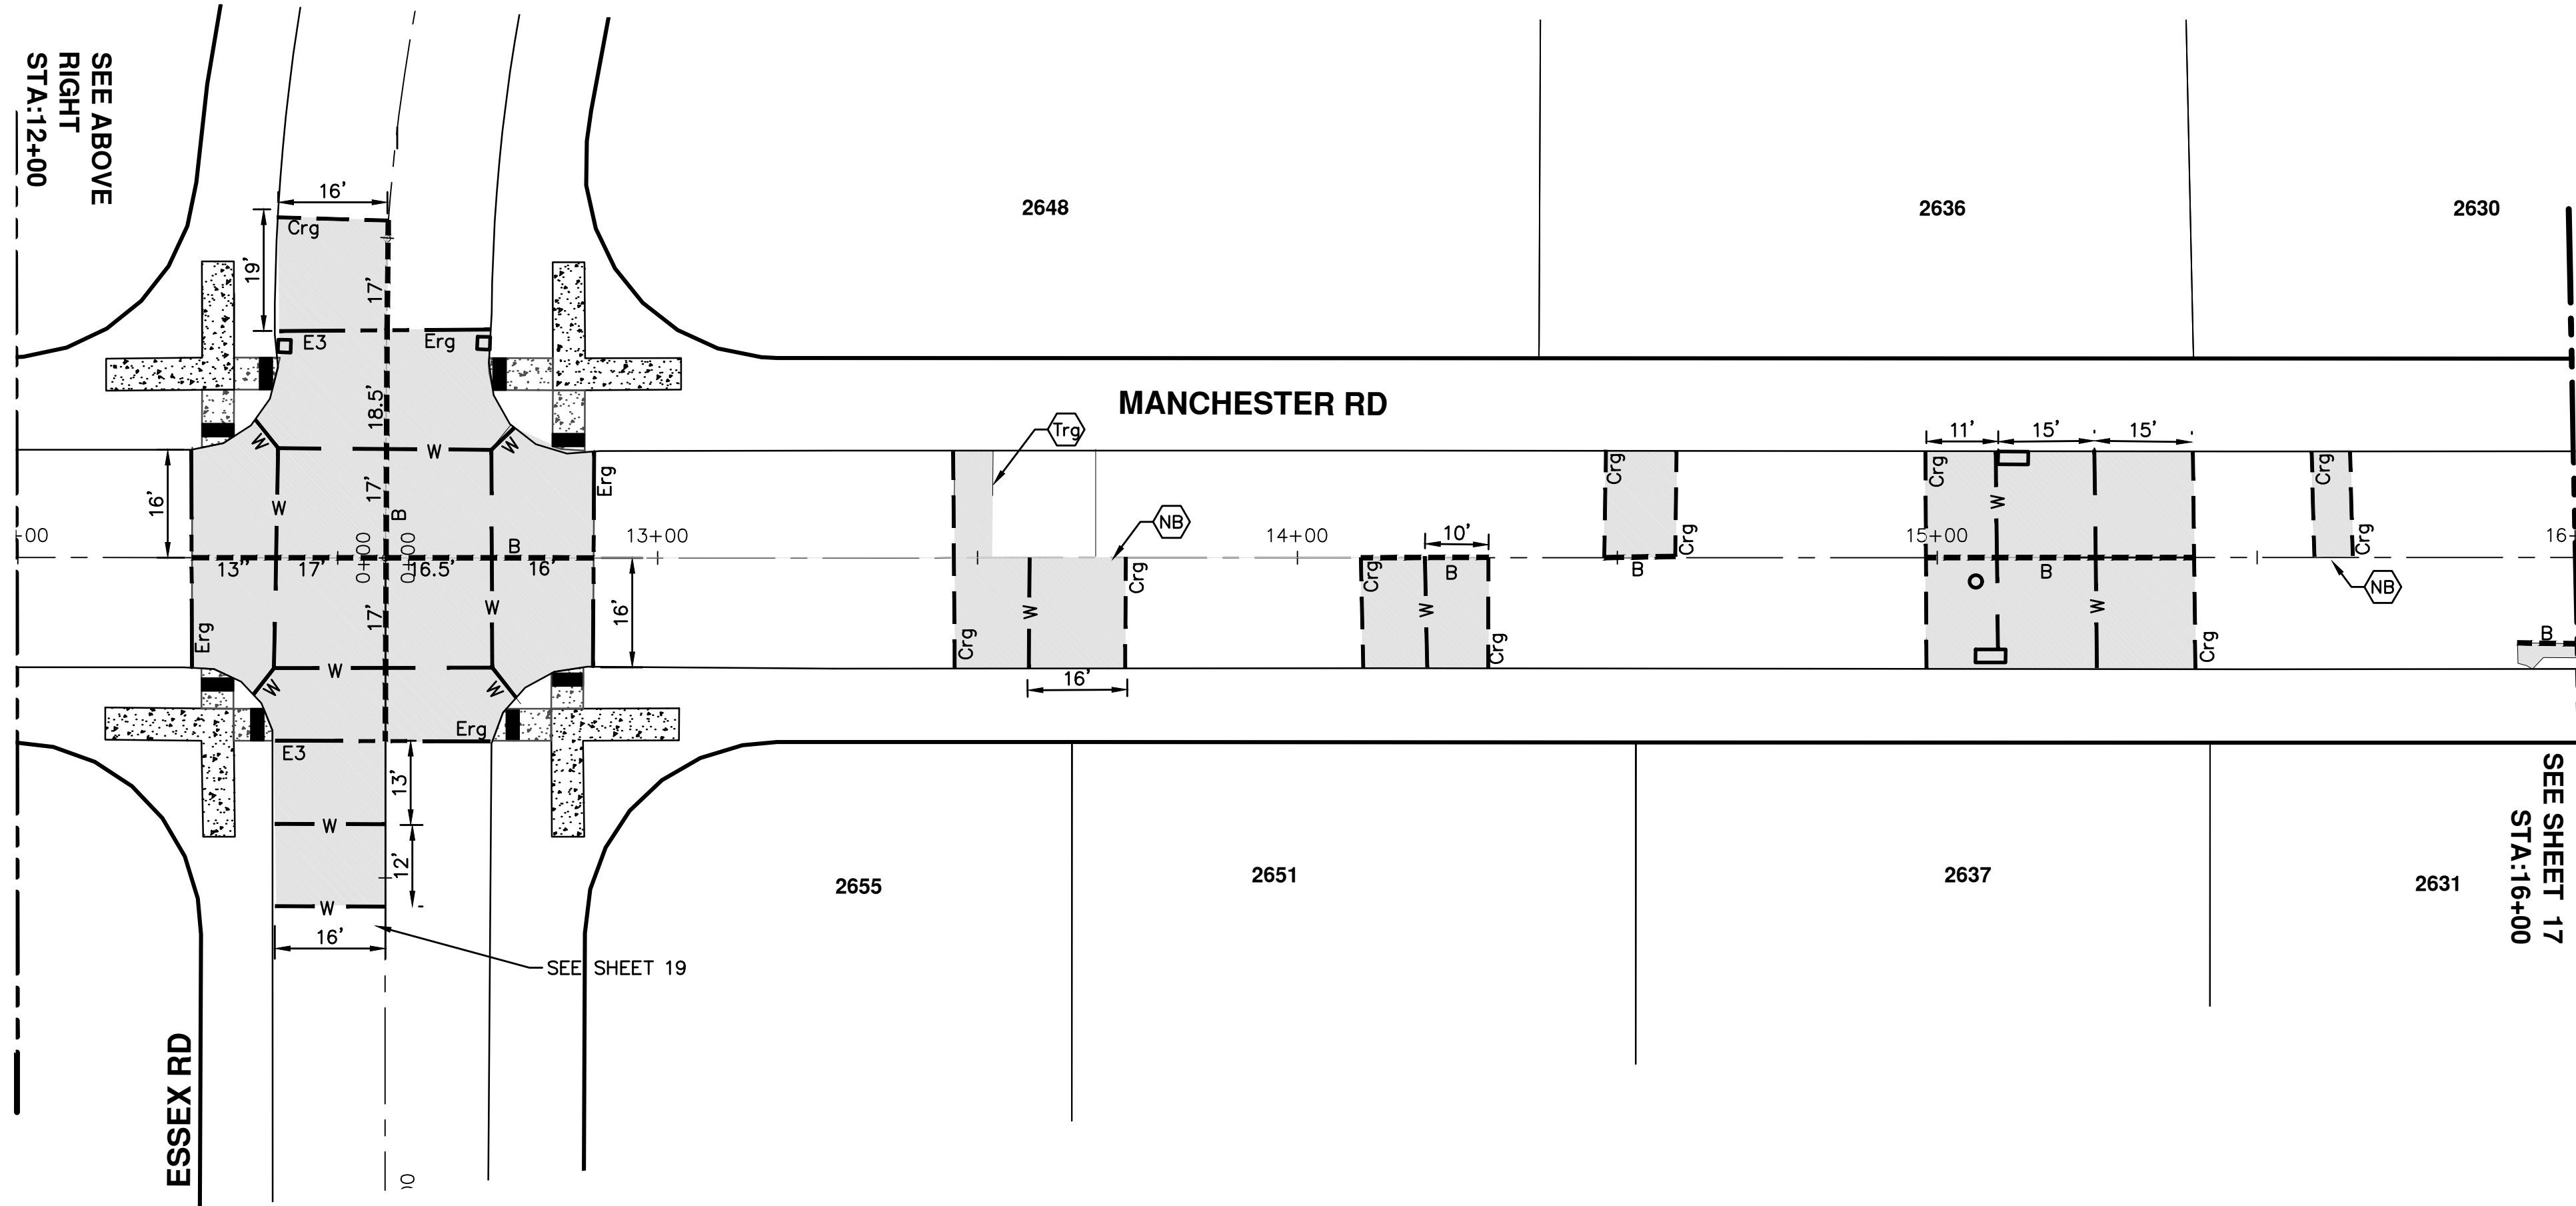
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 ANN ARBOR, MI 48106-0667  
 ANN ARBOR 734-754-4410  
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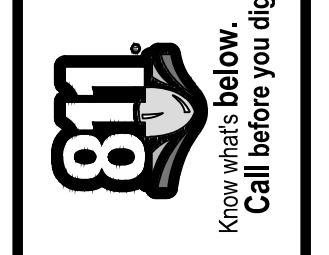
**PROJECT MANAGEMENT - PUBLIC SERVICES - CITY OF ANN ARBOR**  
**COLONY ESSEX MANCHESTER**  
**CONCRETE PAVEMENT REPAIR**

SCALE PLAN: 1" = 20'  
 DRAWING No. 2015024-17

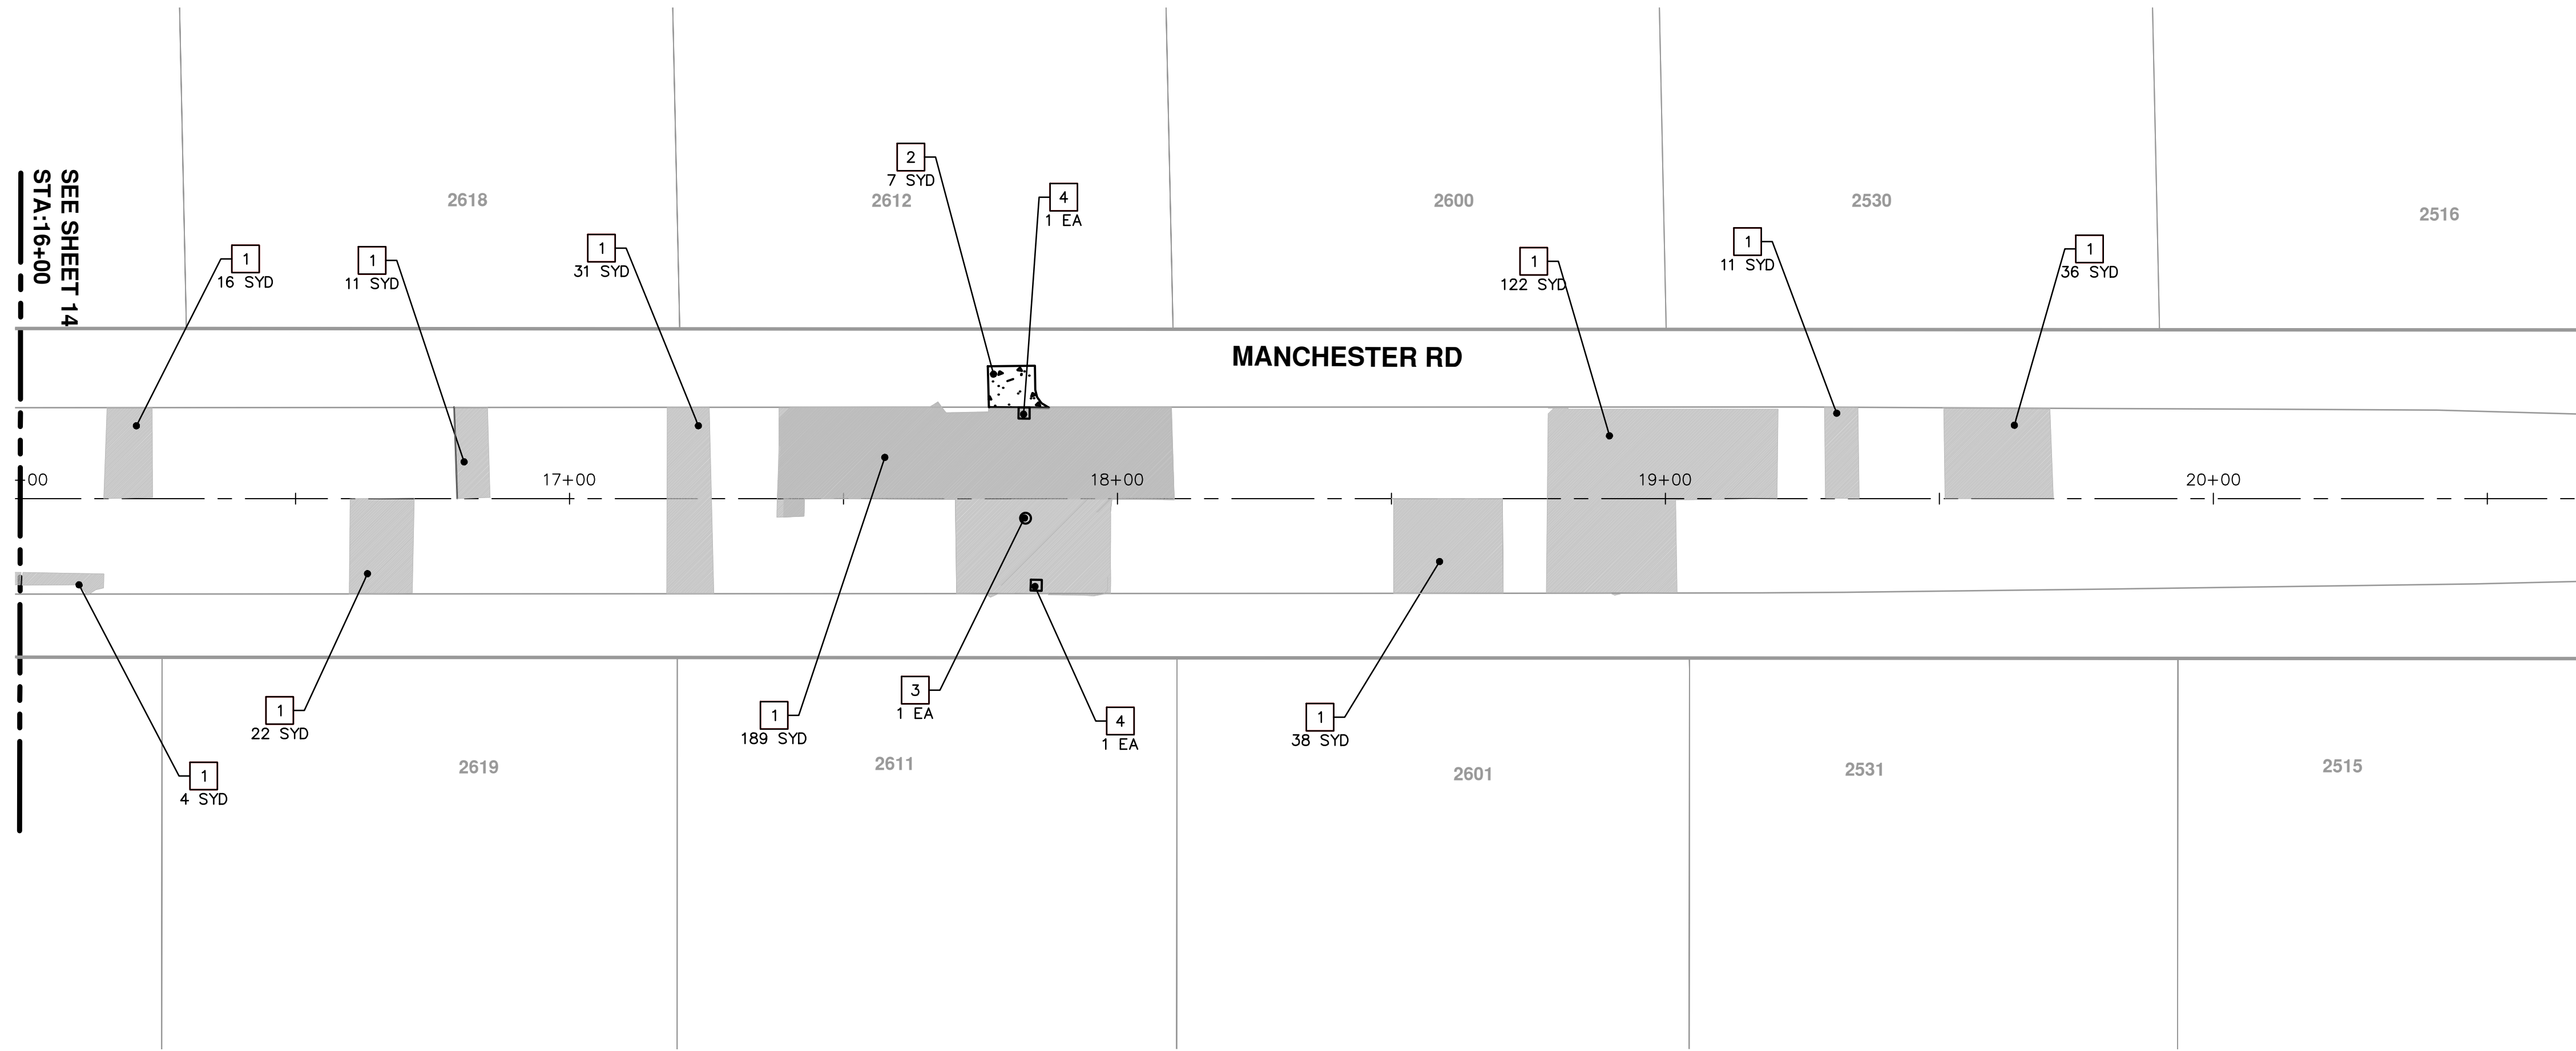
MANCHESTER RD  
 STA 8+00 TO 16+00 JOINTING PLAN

CITY OF ANN ARBOR  
 PUBLIC SERVICE  
 301 EAST HURON STREET  
 ANN ARBOR, MI 48106-0667  
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REV.	DESCRIPTION	DATE	DRAWN	CHECKED



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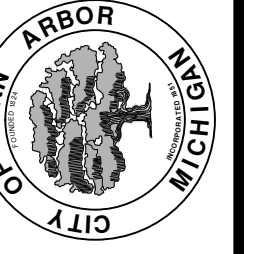
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10	DETECTABLE WARNING SURFACE



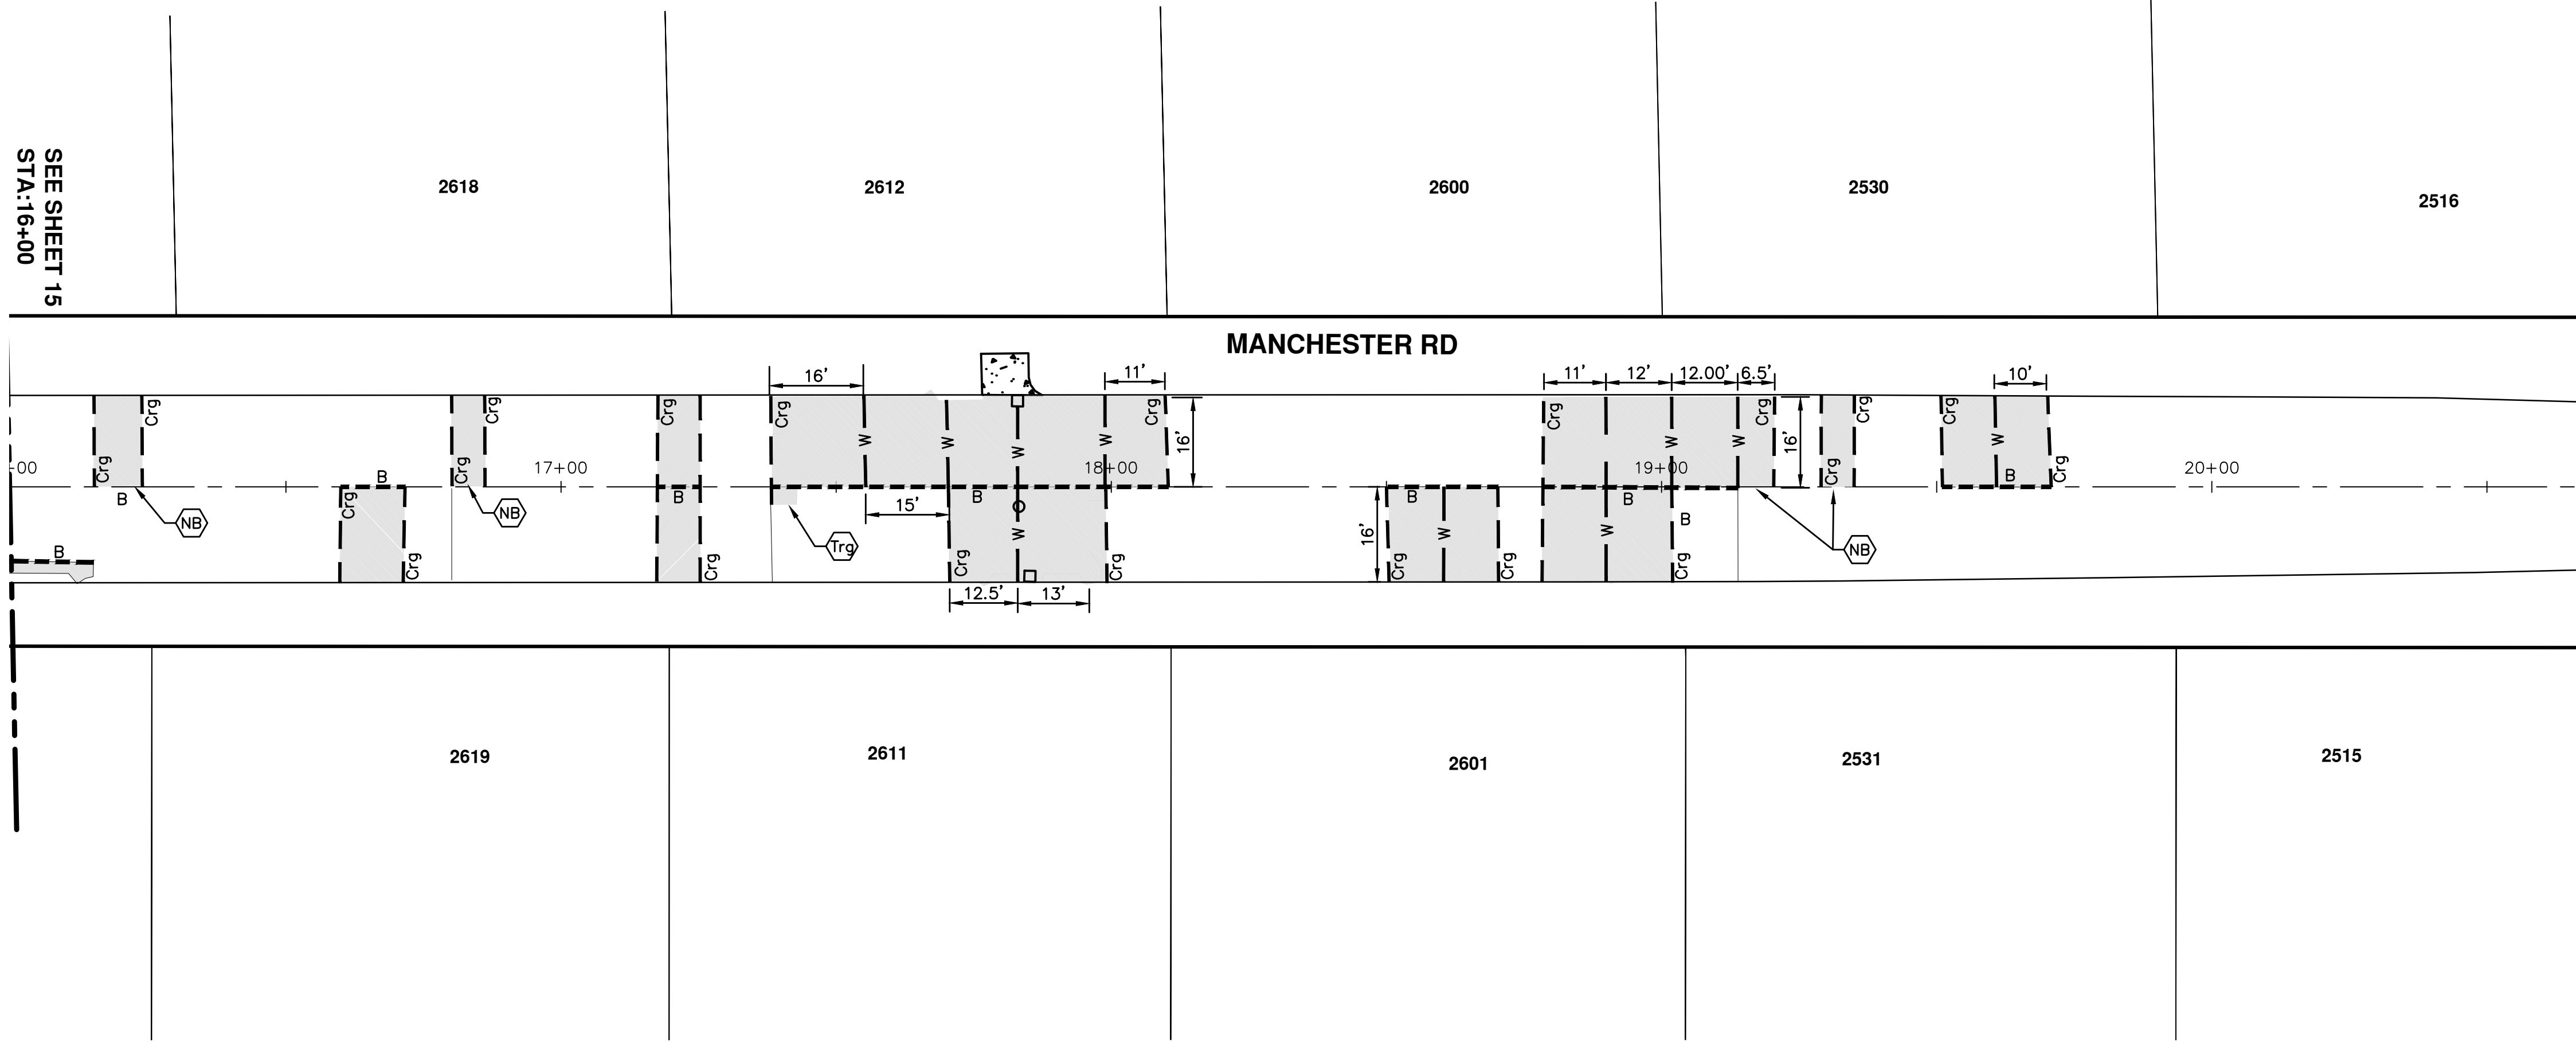
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**PROJECT MANAGEMENT - PUBLIC SERVICES - CITY OF ANN ARBOR**  
**COLONY ESSEX MANCHESTER**  
**CONCRETE PAVEMENT REPAIR**  
 MANCHESTER RD  
 STA 16+00 TO 20+00 REMOVAL AND CONSTRUCTION PLAN

SCALE PLAN: 1" = 20'  
 DRAWING No.  
**2015024-18**

REV.	DESCRIPTION	DATE	DRAWN	CHECKED



SEE SHEET 15  
STA:16+00

2618

2612

2600

2530

2516

MANCHESTER RD

2619

2611

2601

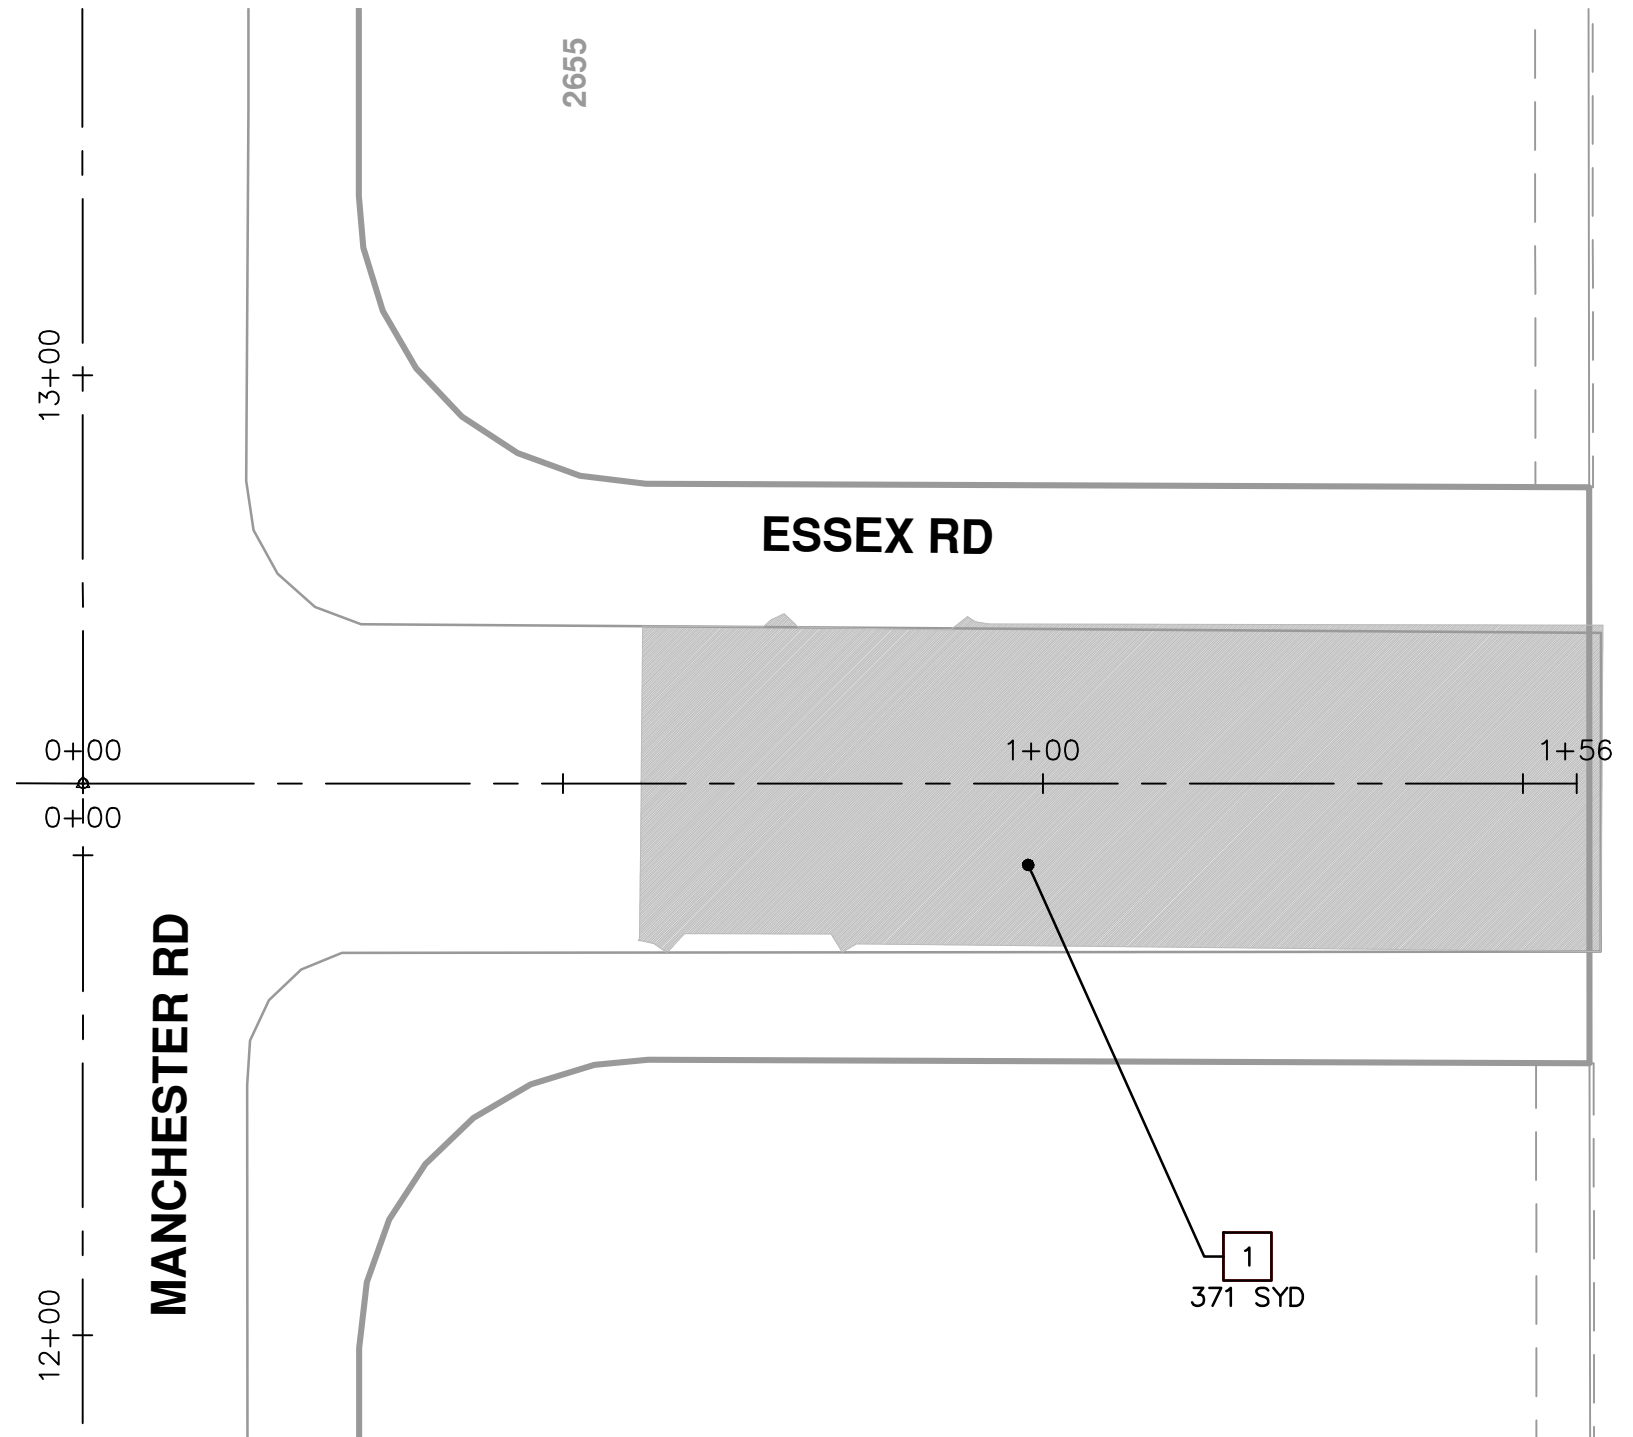
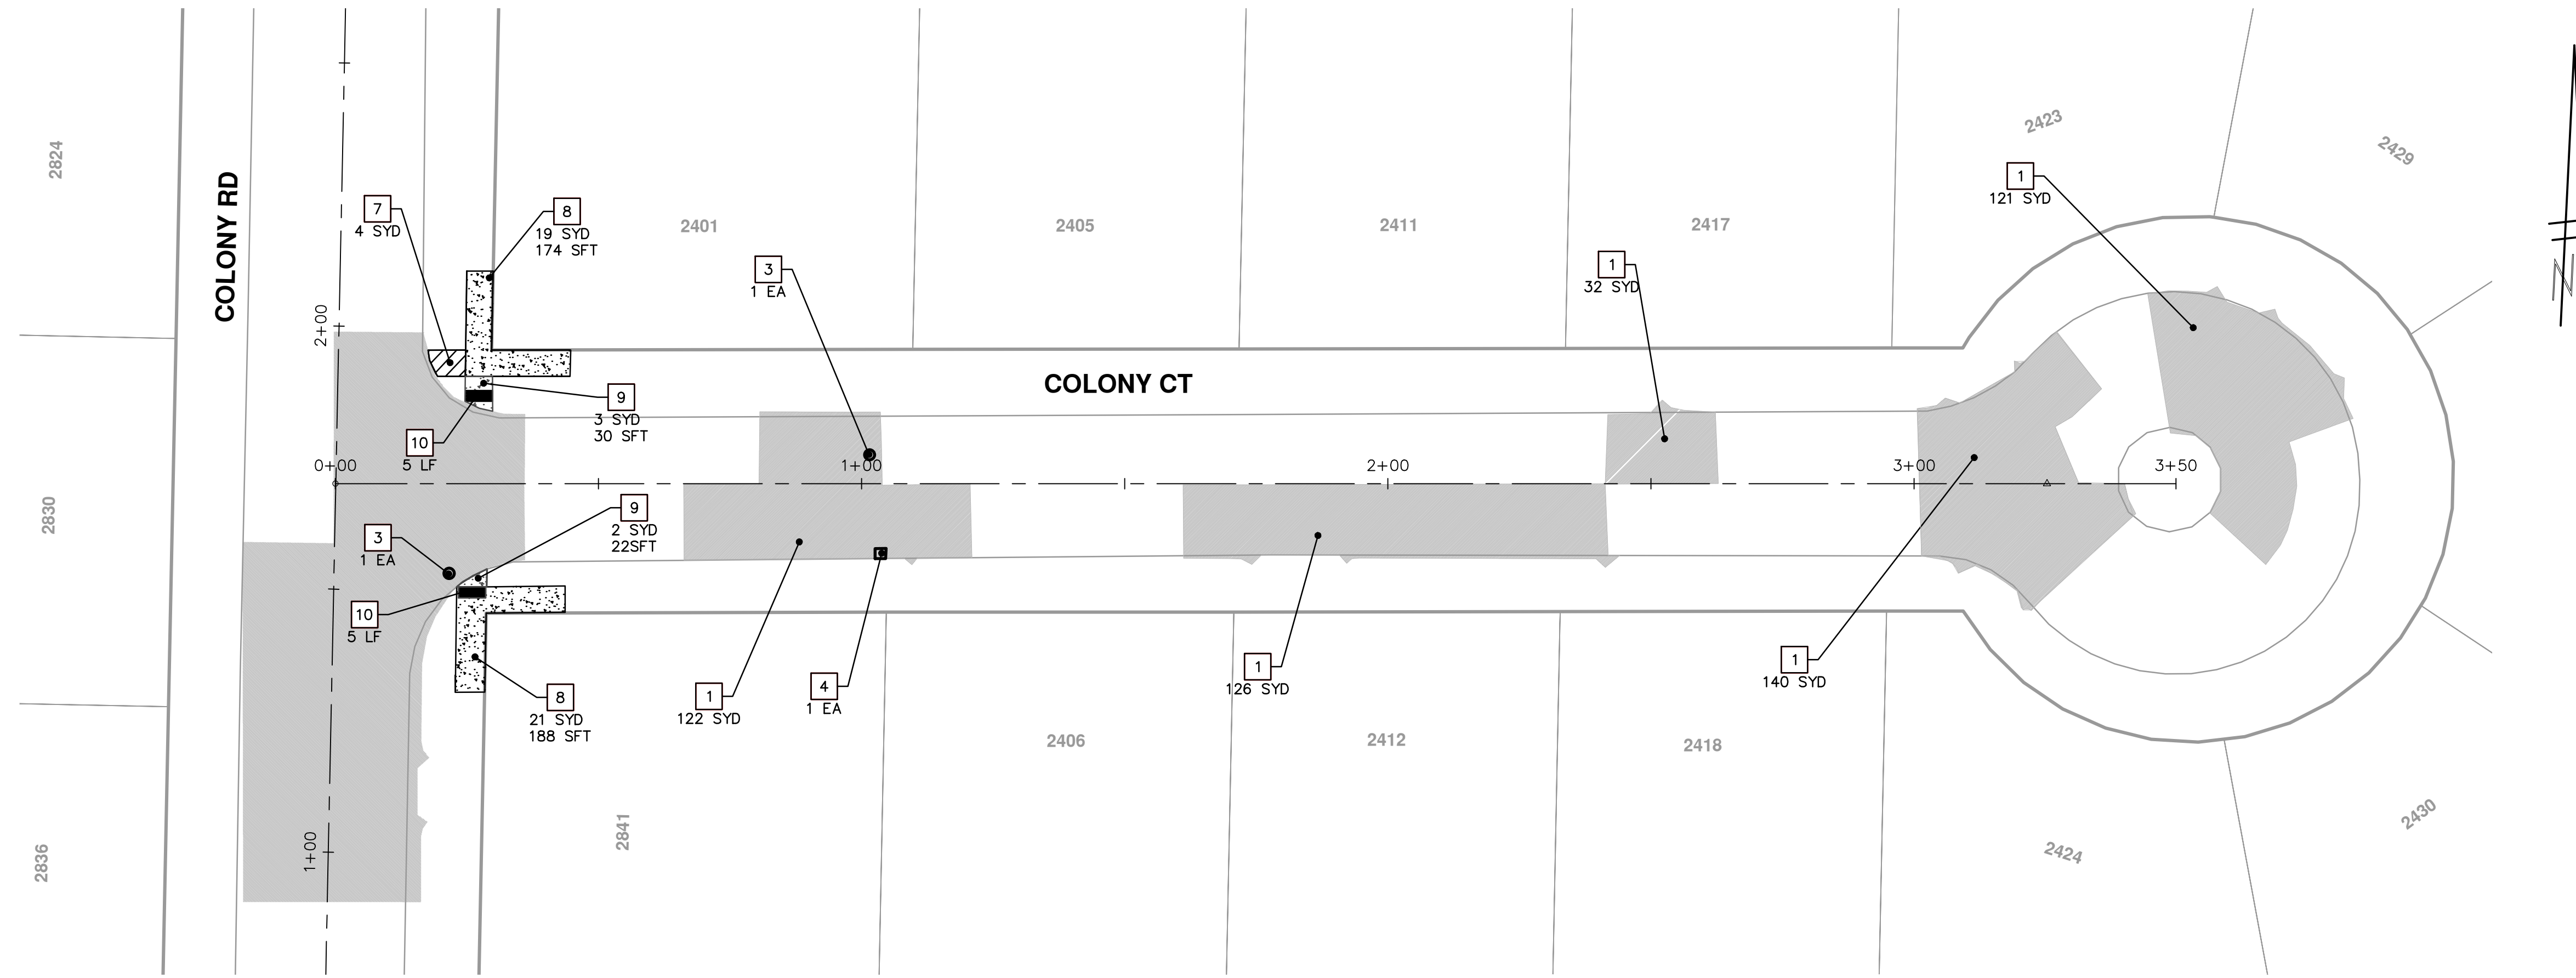
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2515

MDOT JOINT TYPE

- E3 or Erg
- Crg
- B
- W
- Trg
- NO TIE BARS

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6	GATE BOX ADJ. CASE 1, AND MONUMENT BOX, OR GAS BOX
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8	SIDEWALK REMOVAL, SIDEWALK CONC. 4 INCH
9	SIDEWALK REMOVAL, SIDEWALK RAMP CONC 6 INCH
10	DETECTABLE WARNING SURFACE

**PROJECT MANAGEMENT - PUBLIC SERVICES - CITY OF ANN ARBOR**

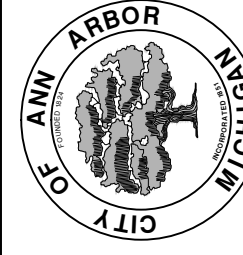
COLONY ESSEX MANCHESTER  
 CONCRETE PAVEMENT REPAIR

COLONY CT AND ESSEX EAST  
 STA 0+00 TO 1+55 REMOVAL AND CONSTRUCTION PLAN

SCALE PLAN: 1" = 20'

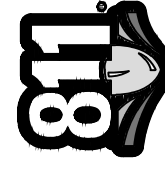
DRAWING No.  
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SHEET No.  
 20 OF 27



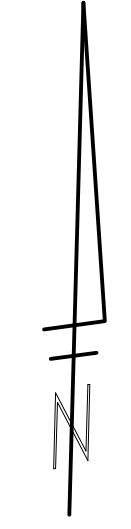
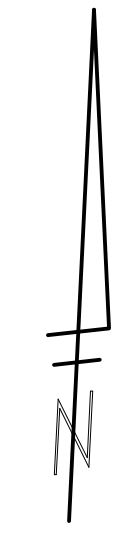
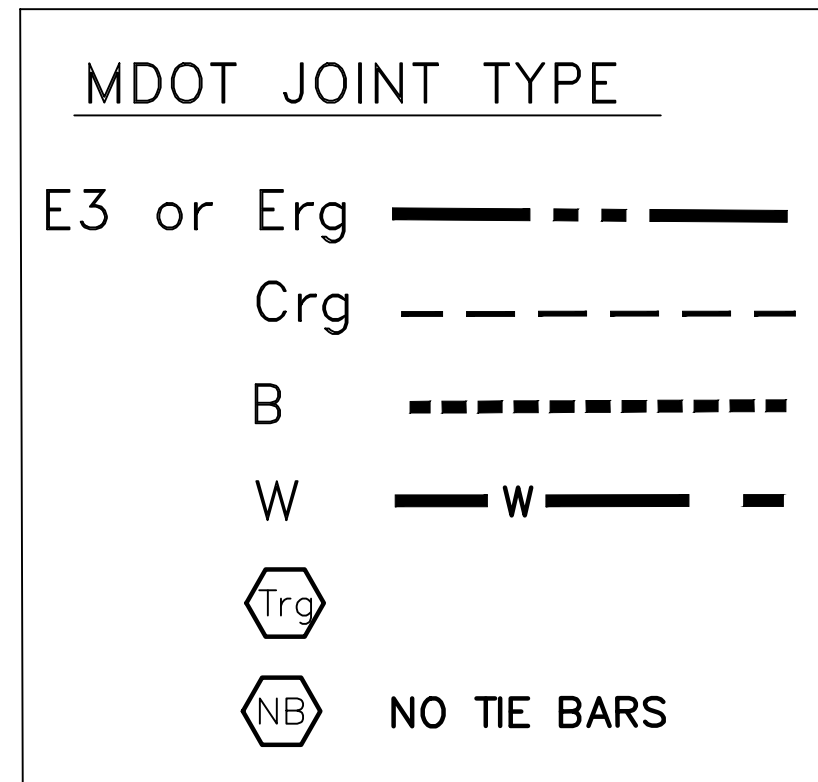
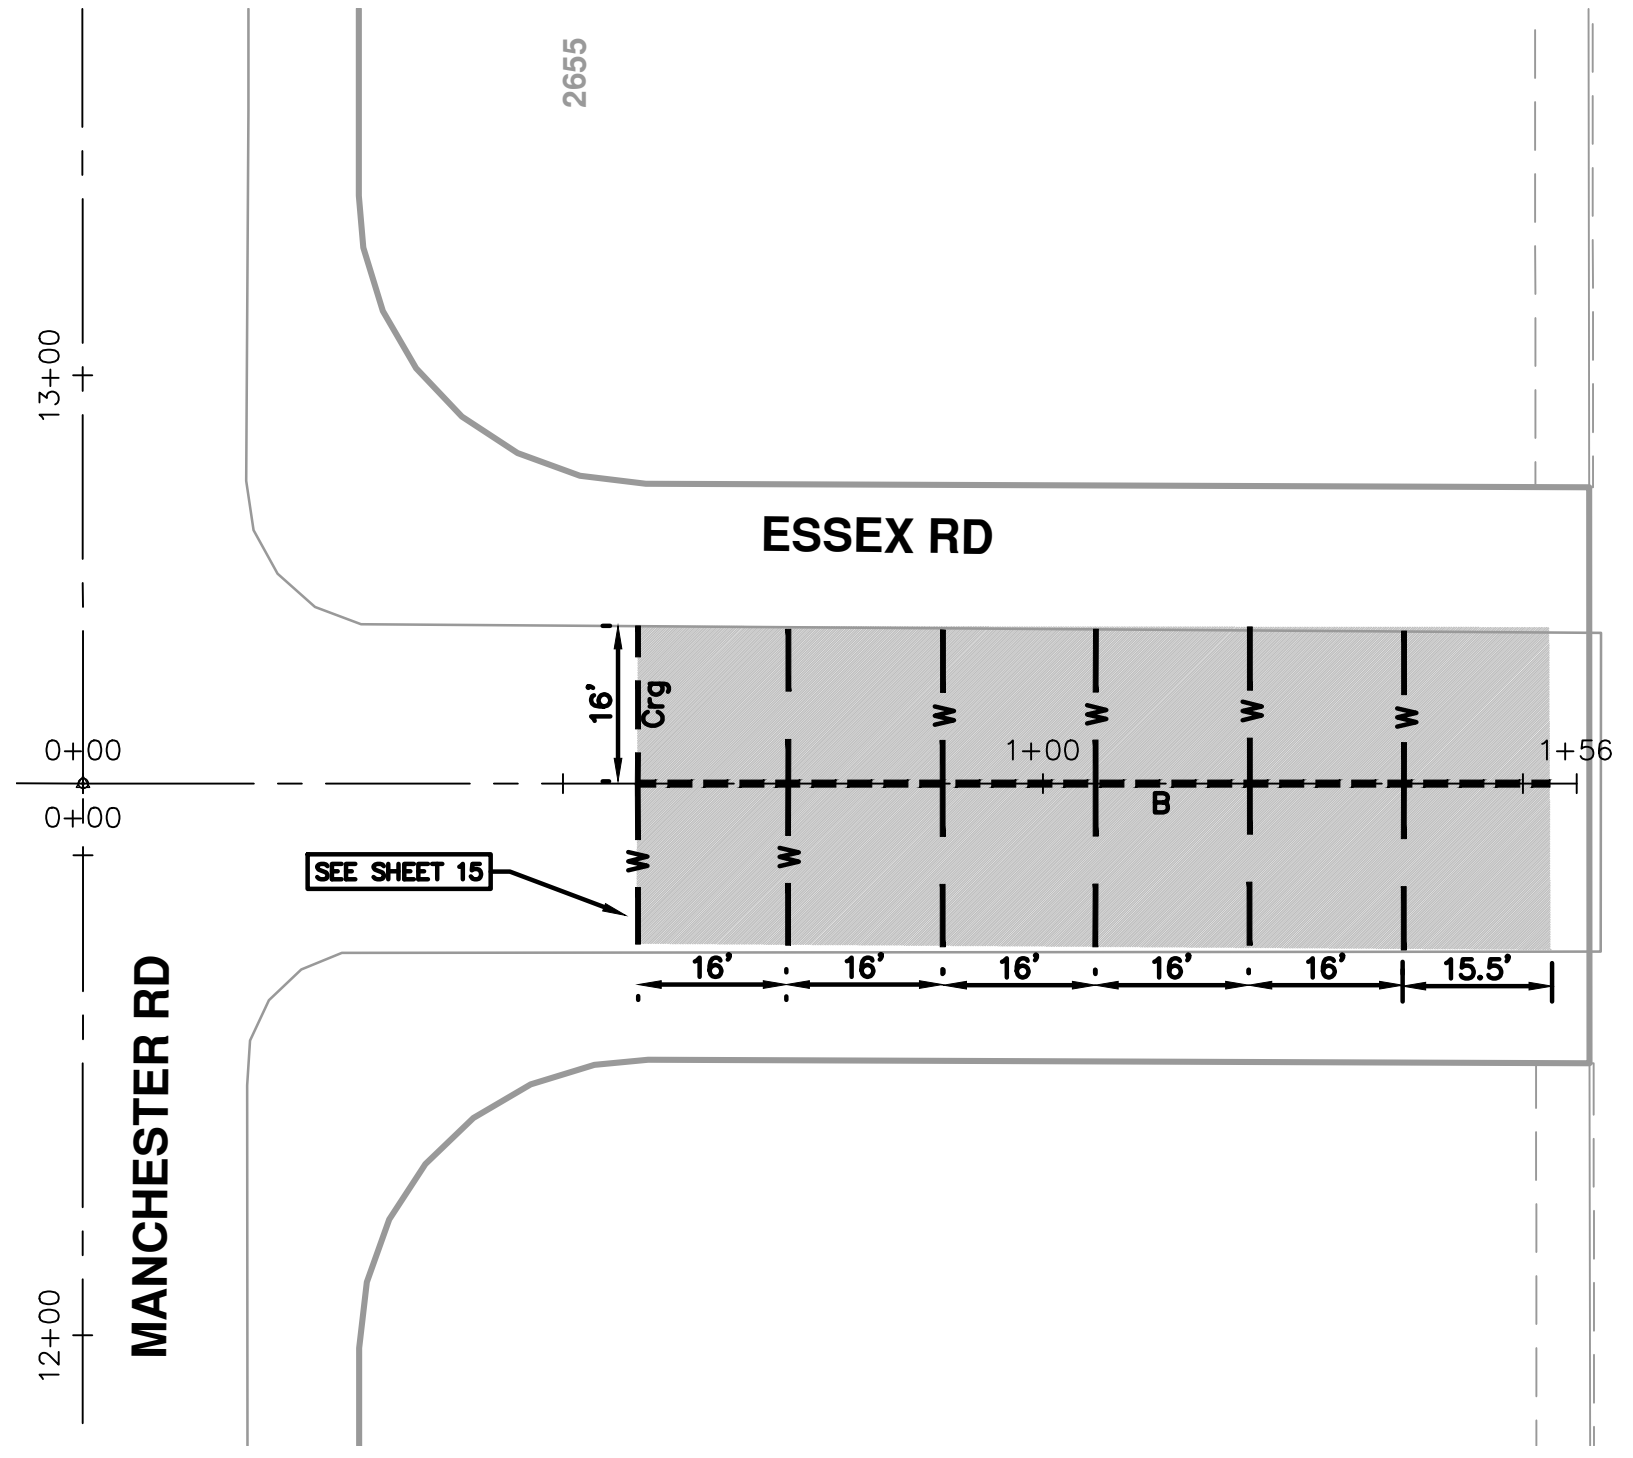
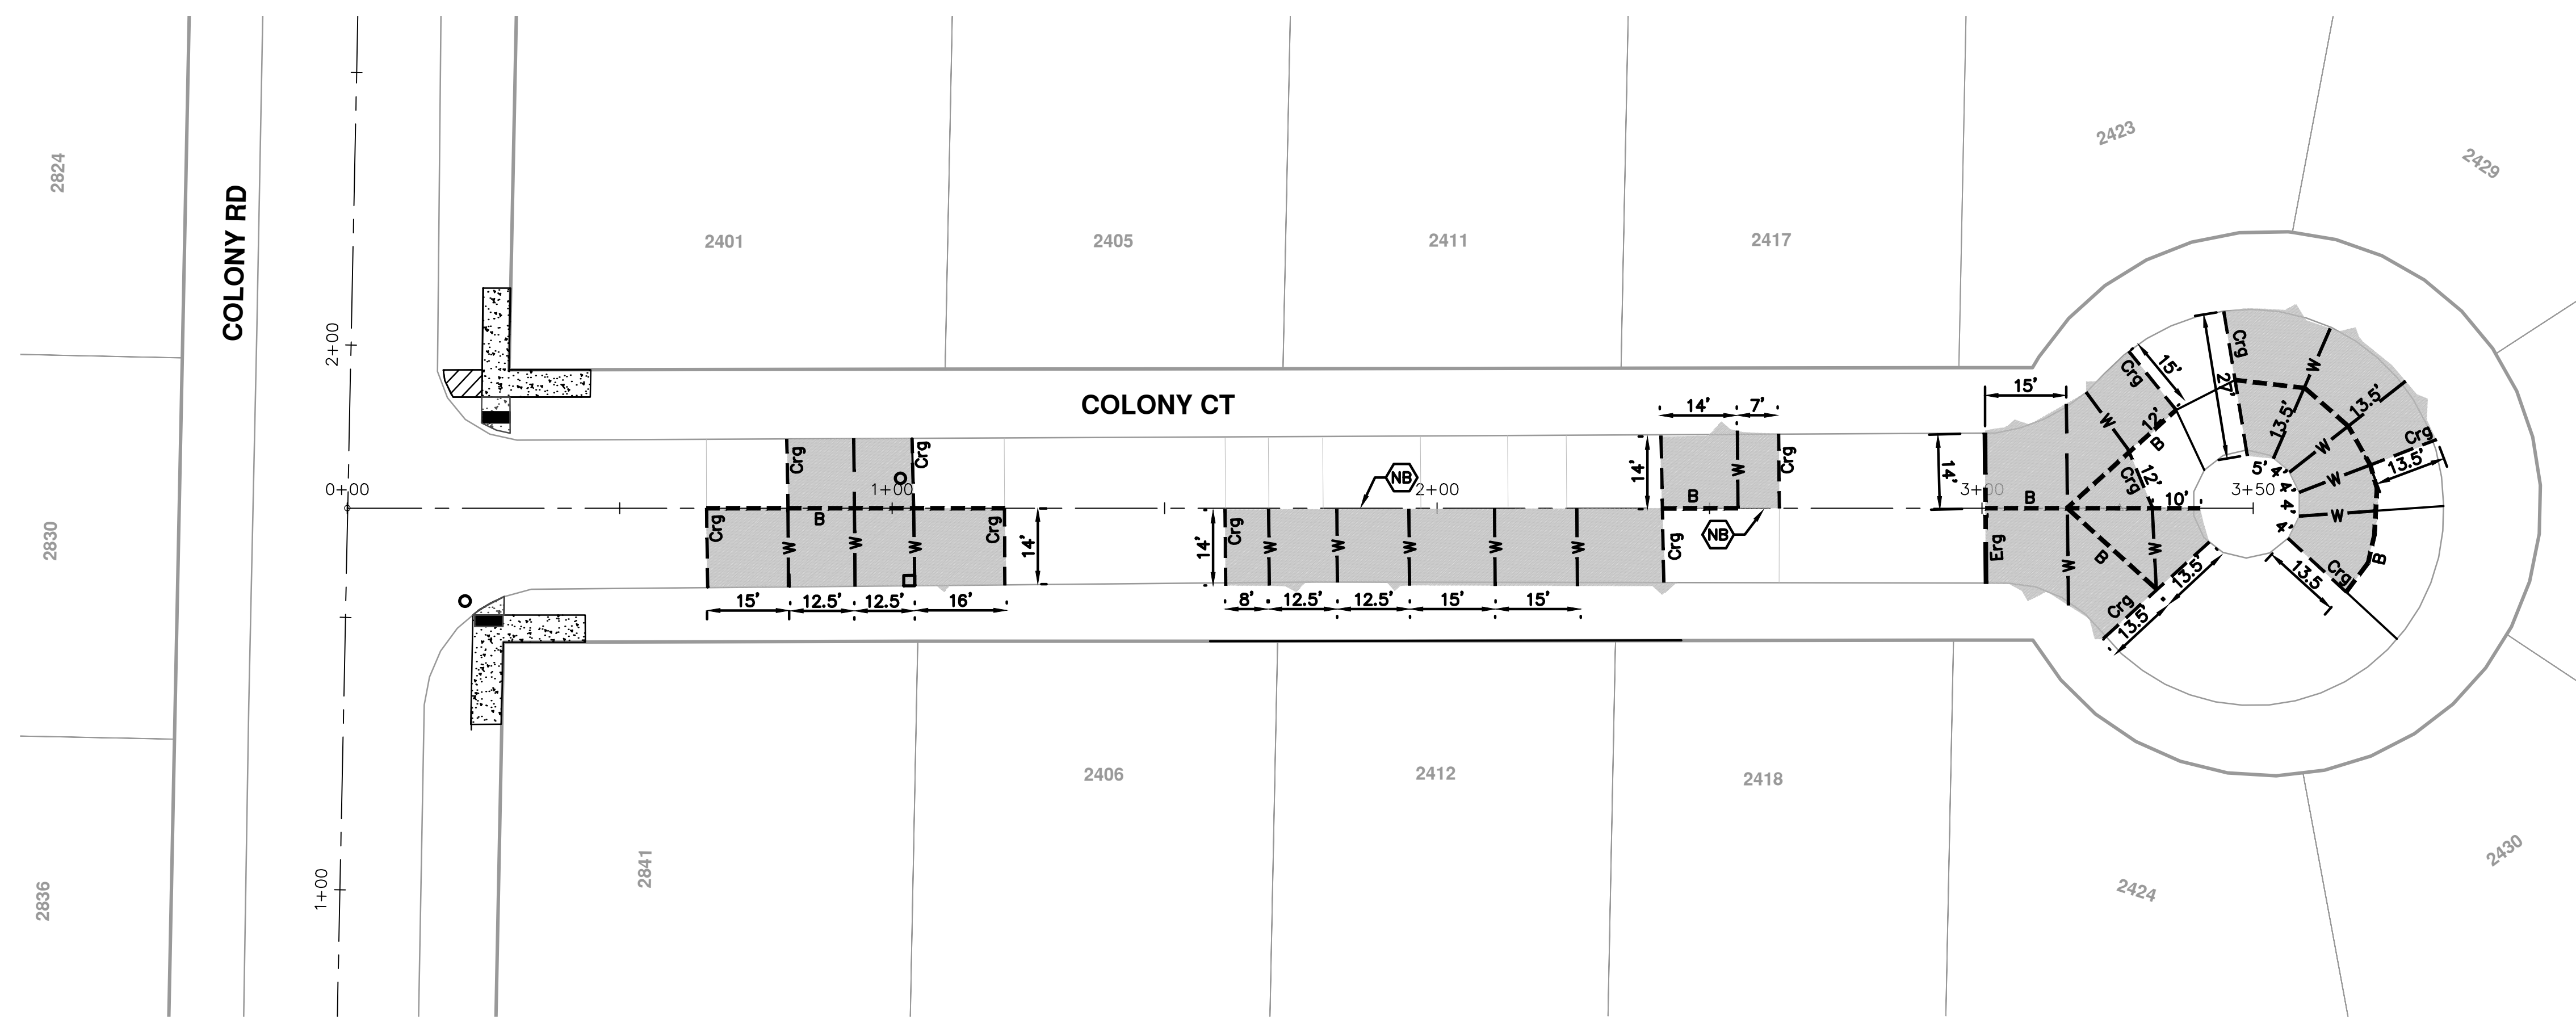
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 ANN ARBOR: 734-794-4410  
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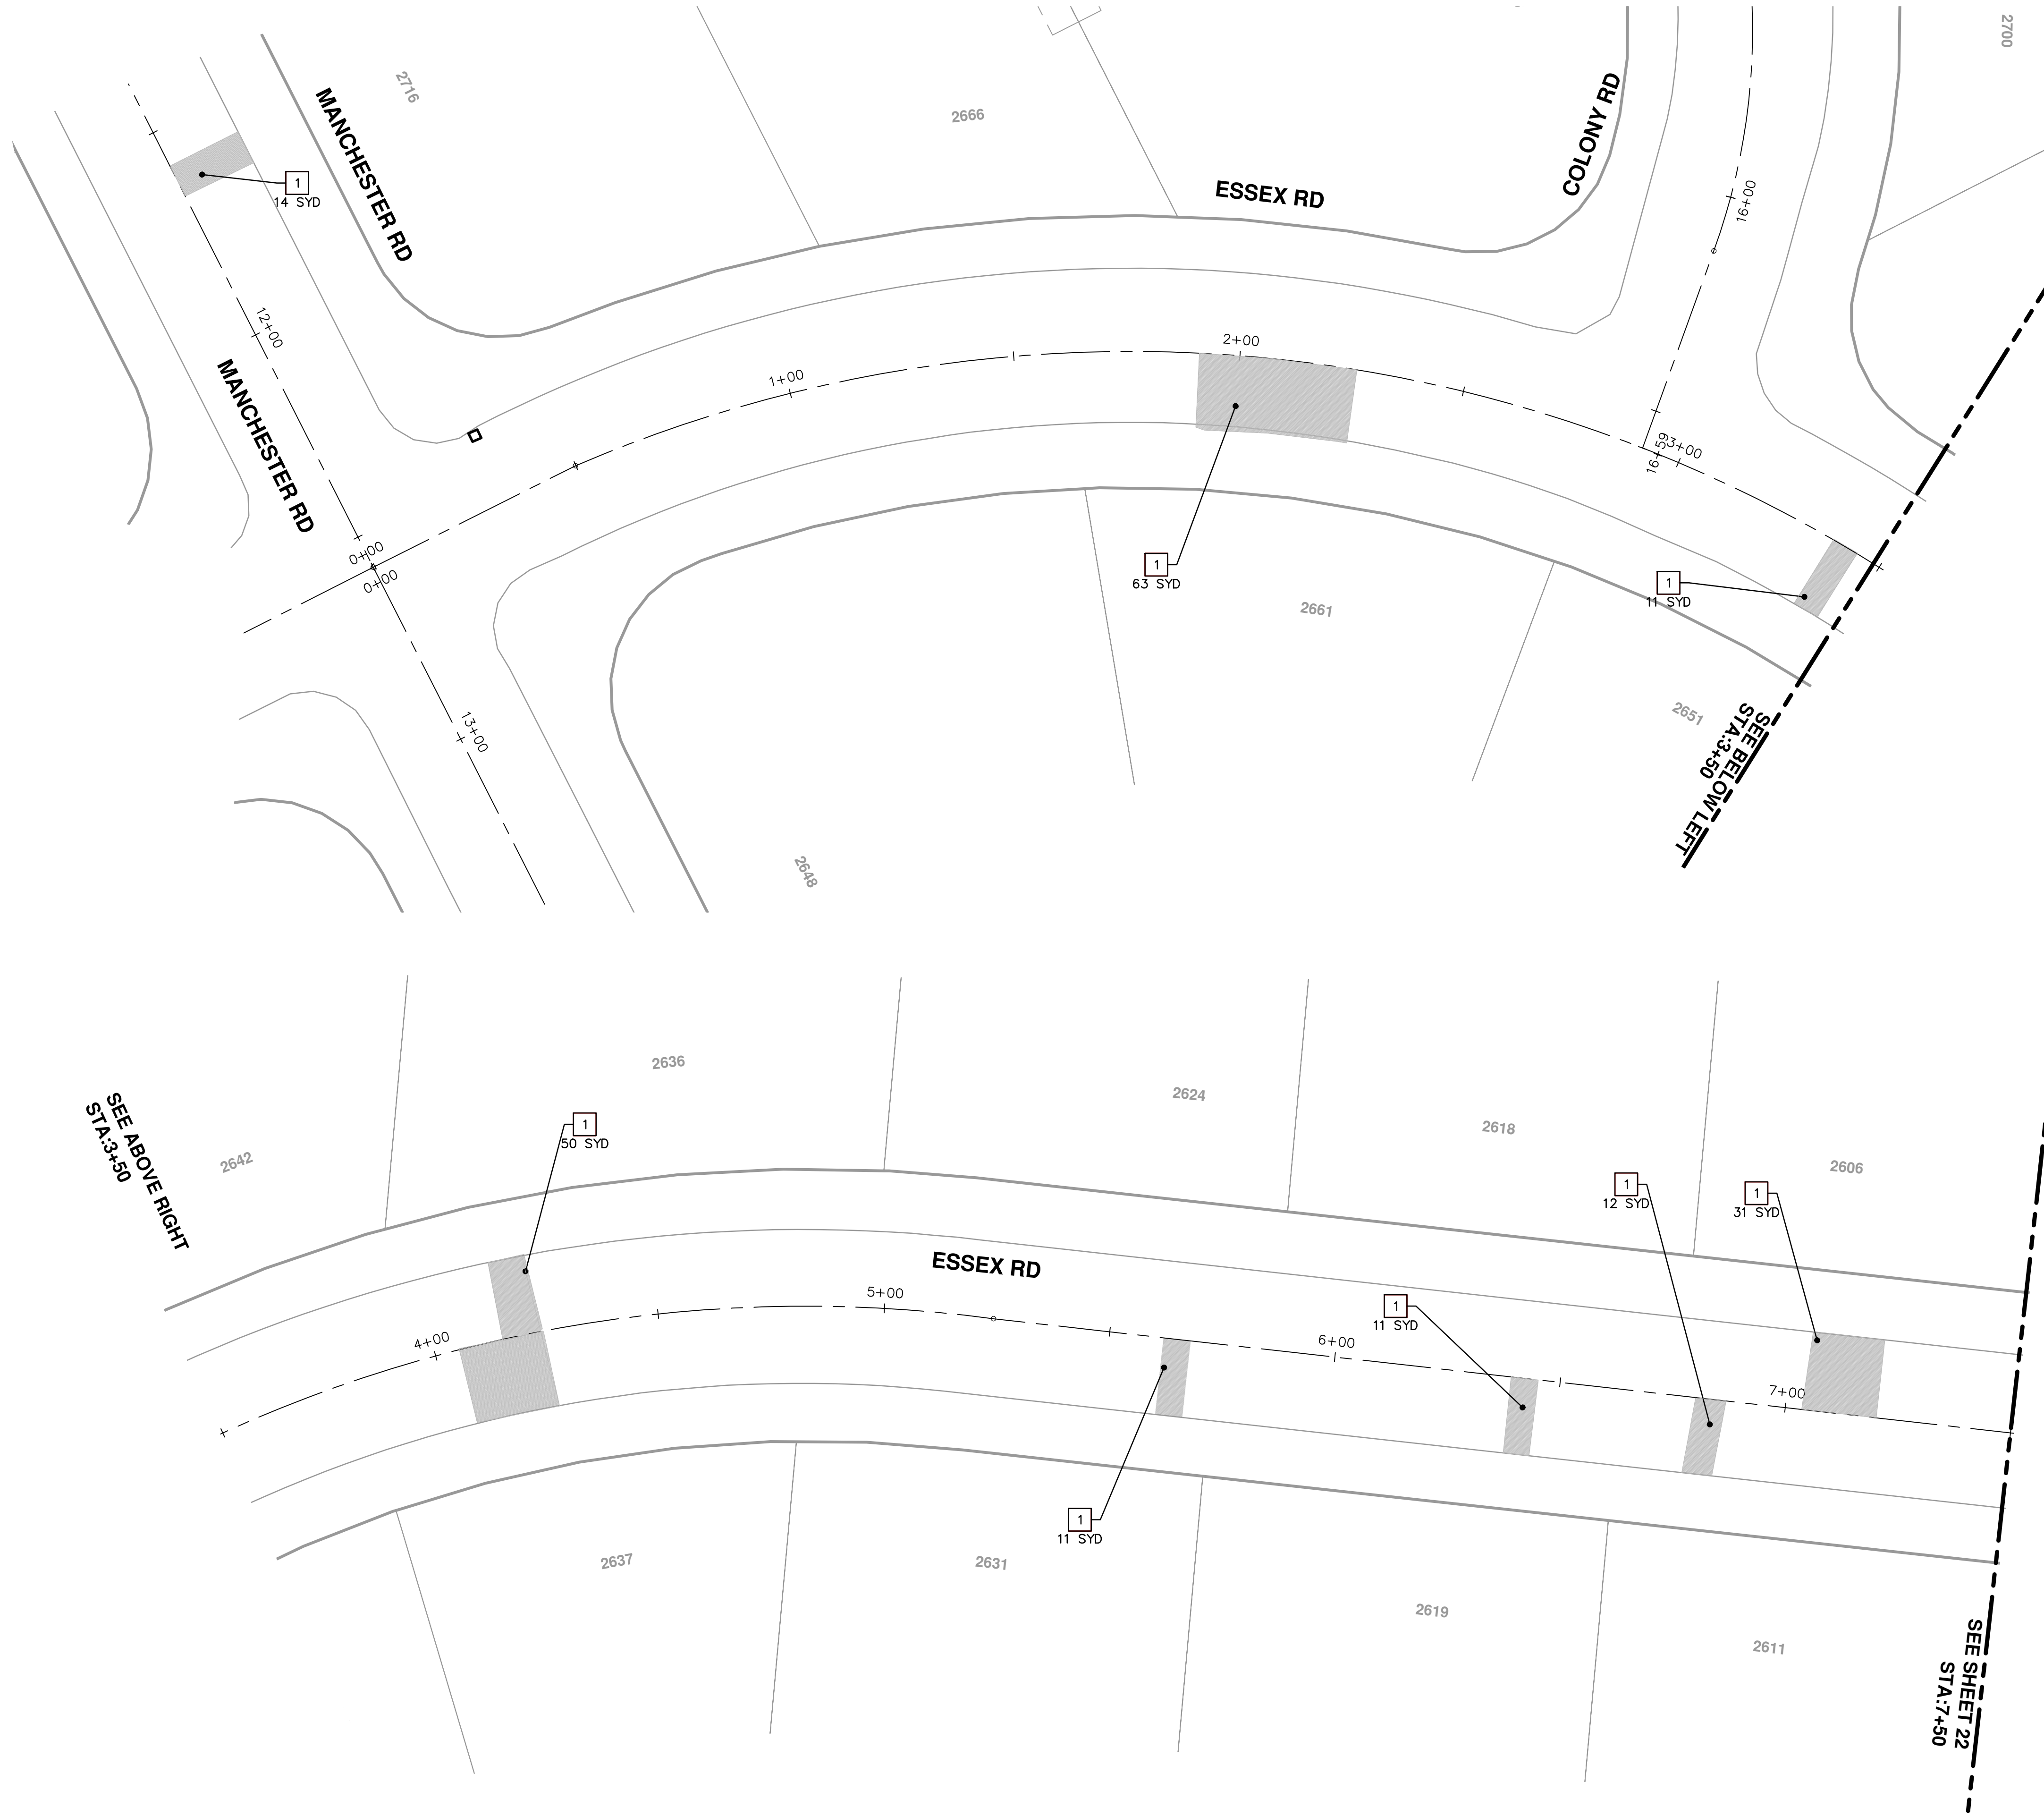
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<p><b>PROJECT MANAGEMENT - PUBLIC SERVICES - CITY OF ANN ARBOR</b></p> <p><b>COLONY ESSEX MANCHESTER</b></p> <p><b>CONCRETE PAVEMENT REPAIR</b></p> <p>COLONY CT AND ESSEX EAST STA 0+00 1+55 JOINTING PLAN</p>					
<p>SHEET No. <b>21 OF 27</b></p>		<p>SCALE PLAN: 1" = 20'</p>		<p>DRAWING No. <b>2015024-21</b></p>	

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**PROJECT CONSTRUCTION INCLUDES THE REMOVAL AND REPLACEMENT OF SIDEWALK AT VARIOUS ADDRESSES WITHIN THE PROJECT LIMITS THAT IS NOT SHOWN ON THE PLANS. THE QUANTITIES FOR THIS WORK ARE REFLECTED IN THE OVERALL PROJECT QUANTITIES, AND SPECIFICALLY SHOWN BELOW.**

**SIDEWALK, REM = 795 SYD**  
**GRADING, SIDEWALK = 795 SYD**  
**SIDEWALK, CONC, 4 INCH, MODIFIED = 6,800 SFT**  
**SIDEWALK, CONC. 6 INCH, MODIFIED = 350 SFT**

CONSTRUCTION KEY	
KEY	DESCRIPTION
1	PAVT REMOVE AND CONC. PAVT. NONREINF. 6 INCH
2	PAVT REMOVE AND DRIVEWAY NONREINF CONC 6 INCH
3	DR. STR. COVER ADJ. CASE 1 AND DR. COVER TYPE B MODIFIED
4	DR. STRUCTURE REMOVE, DR. STRUCTURE 24 INCH, AND DR. COVER TYPE K MODIFIED
5	DR. STRUCTURE REMOVE, DR. STRUCTURE DOUBLE INLET, AND DR. COVER TYPE K MODIFIED
6	GATE BOX ADJ. CASE 1, AND MONUMENT BOX, OR GAS BOX
7	SIDEWALK REMOVAL
8	SIDEWALK REMOVAL, SIDEWALK CONC. 4 INCH
9	SIDEWALK REMOVAL, SIDEWALK RAMP CONC 6 INCH
10	DETECTABLE WARNING SURFACE

**PROJECT MANAGEMENT - PUBLIC SERVICES - CITY OF ANN ARBOR**  
**COLONY ESSEX MANCHESTER**  
**CONCRETE PAVEMENT REPAIR**

SCALE PLAN: 1" = 20'  
 DRAWING No. 2015024-22

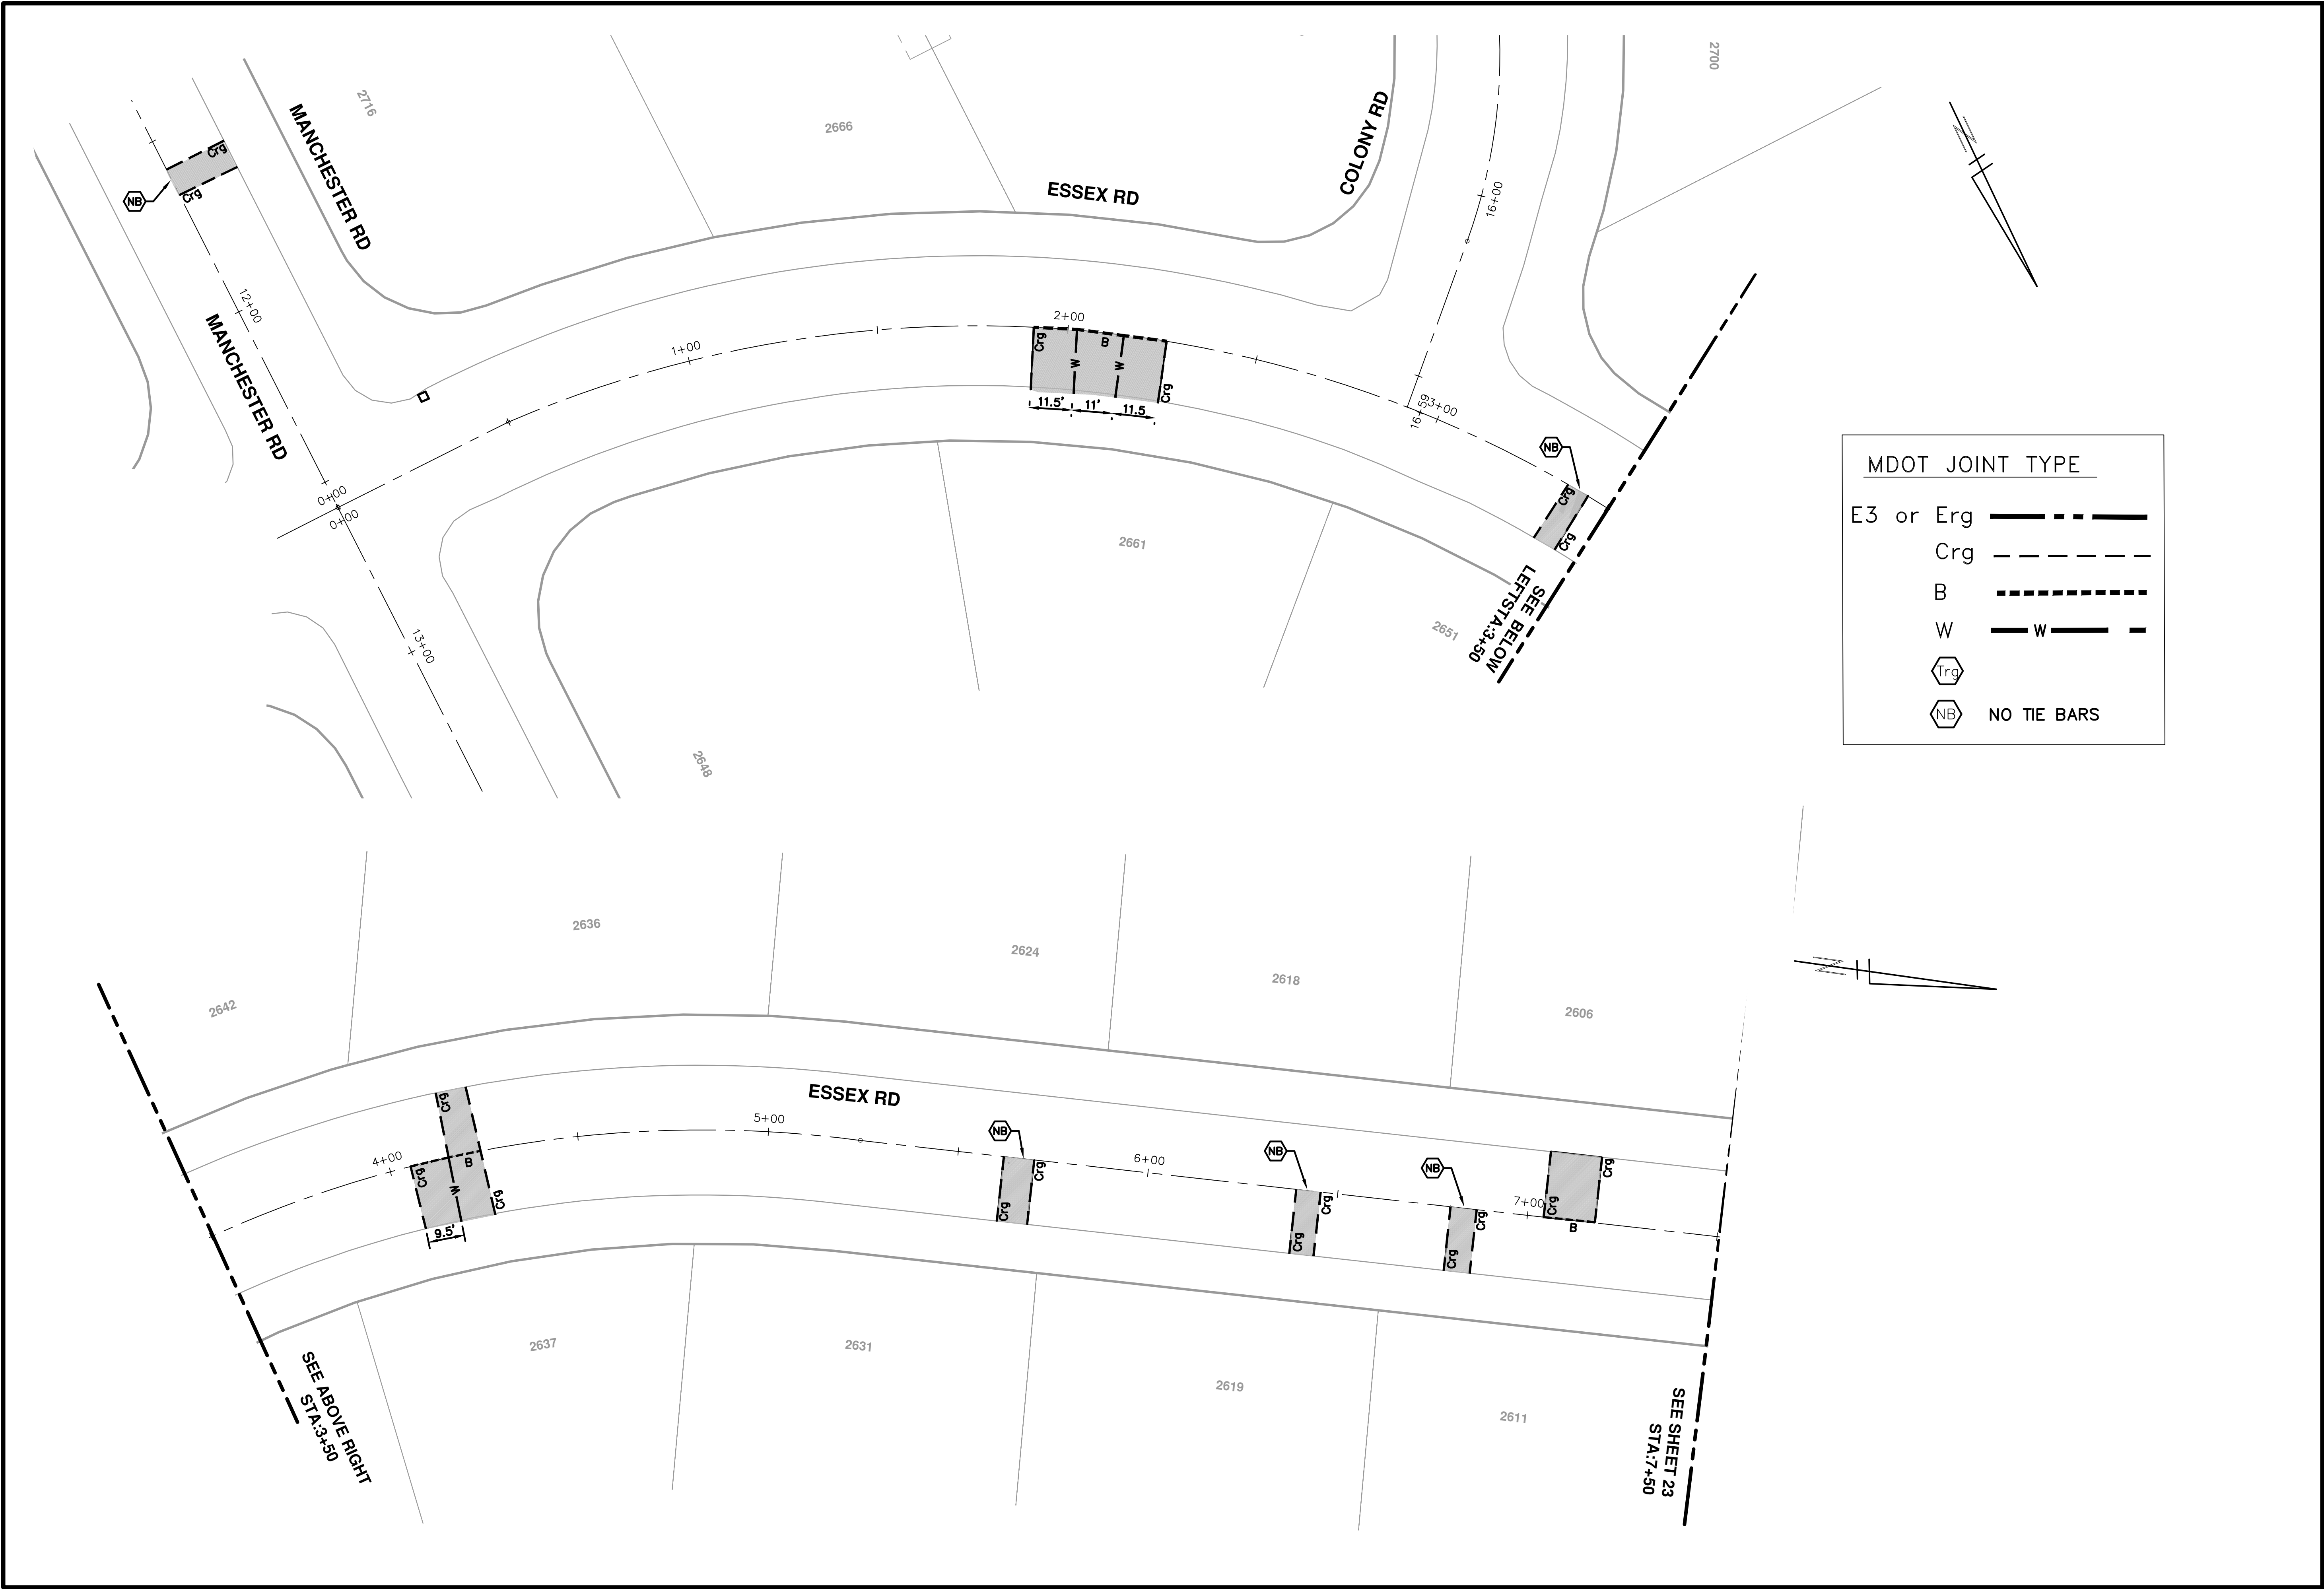
ESSEX RD  
 STA 0+00 TO 7+50 REMOVAL AND CONSTRUCTION PLAN


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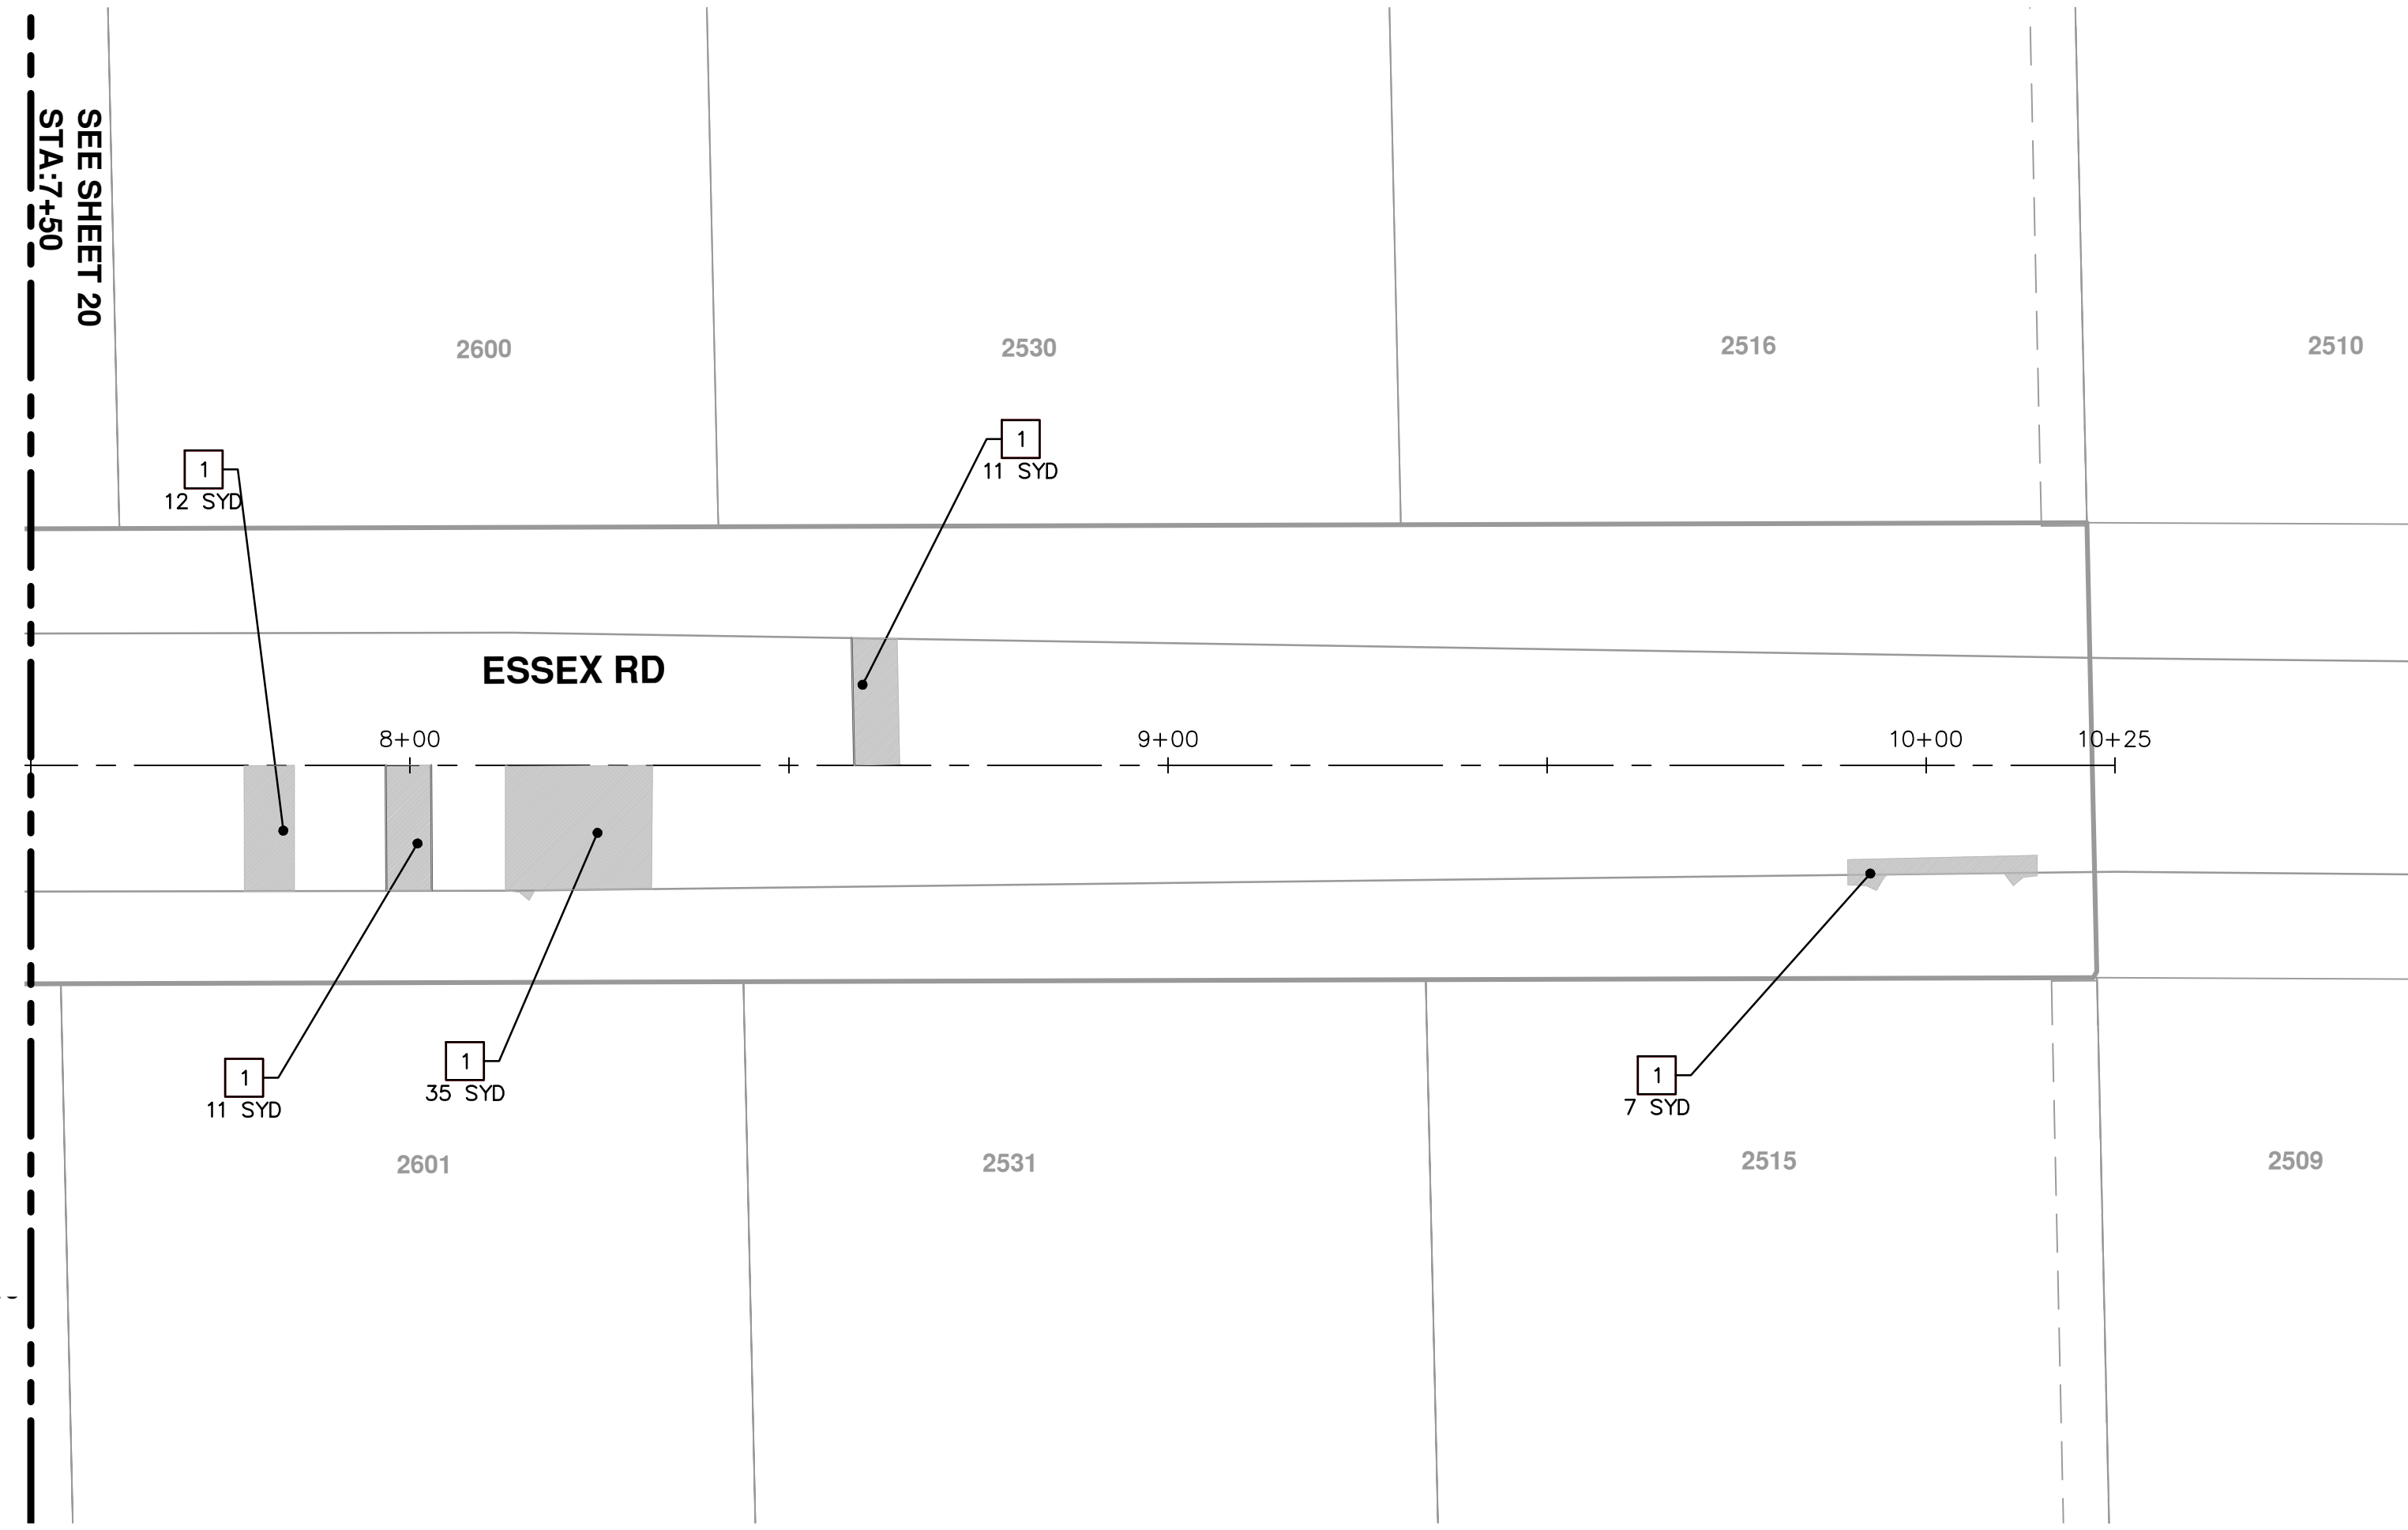
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<b>PROJECT MANAGEMENT - PUBLIC SERVICES - CITY OF ANN ARBOR</b> <b>COLONY ESSEX MANCHESTER</b> <b>CONCRETE PAVEMENT REPAIR</b>		STA 0+00 TO 7+50 JOINTING PLAN
SCALE PLAN: 1" = 20' DRAWING No. <b>2015024-23</b>	SHEET No. <b>23 OF 27</b>	



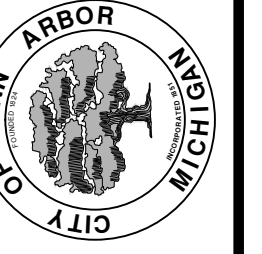
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 GRADING, SIDEWALK = 795 SYD  
 SIDEWALK, CONC. 4 INCH, MODIFIED = 6,800 SFT  
 SIDEWALK, CONC. 6 INCH, MODIFIED = 350 SFT**

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9	SIDEWALK REMOVAL, SIDEWALK RAMP CONC 6 INCH
10	DETECTABLE WARNING SURFACE



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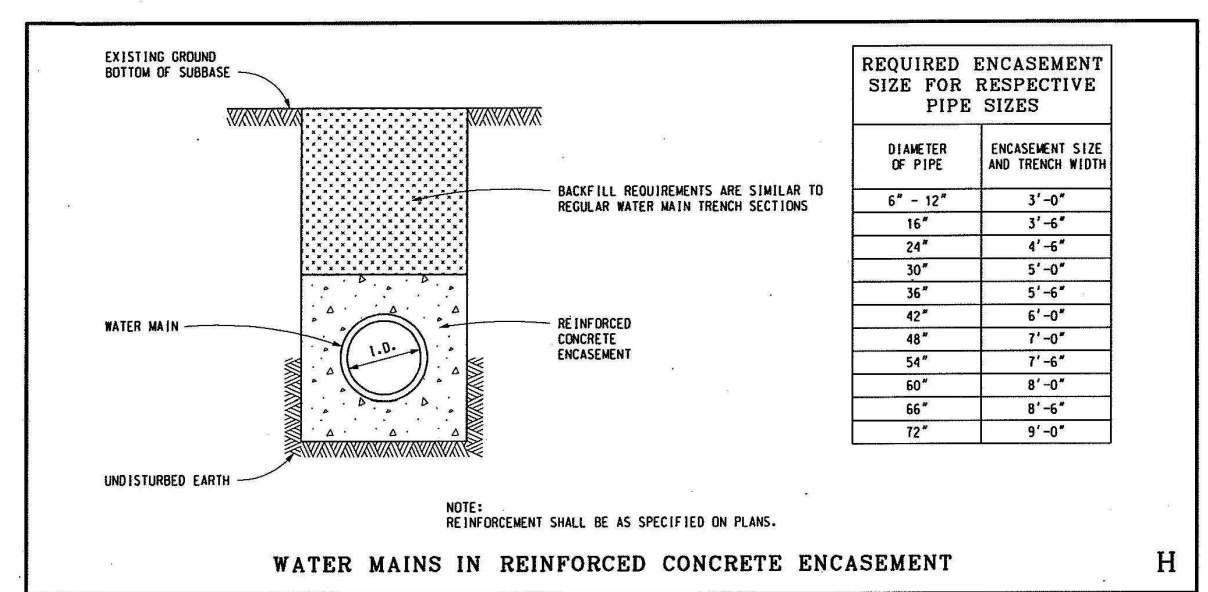
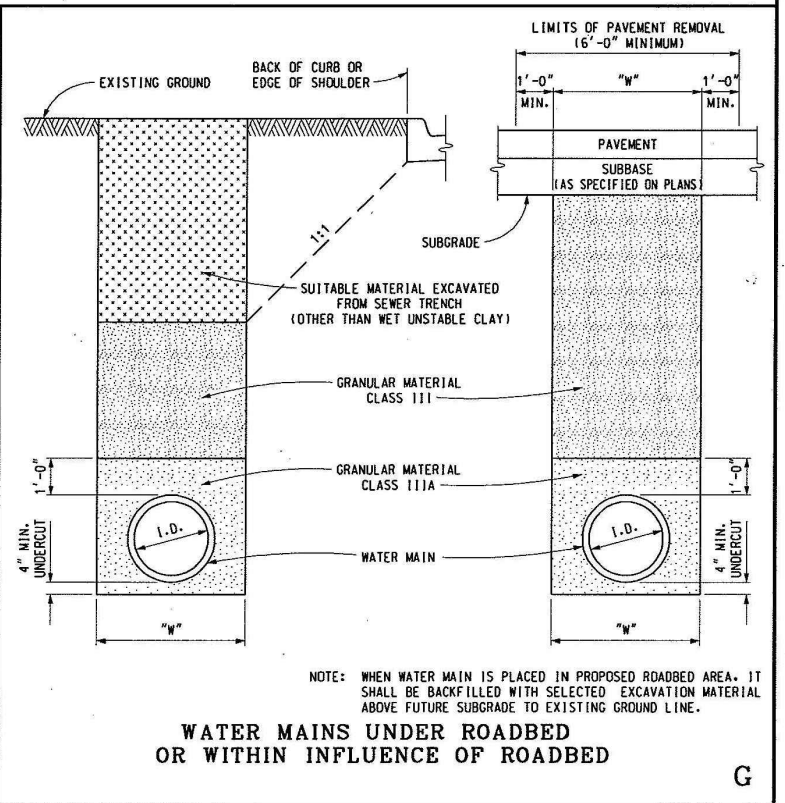
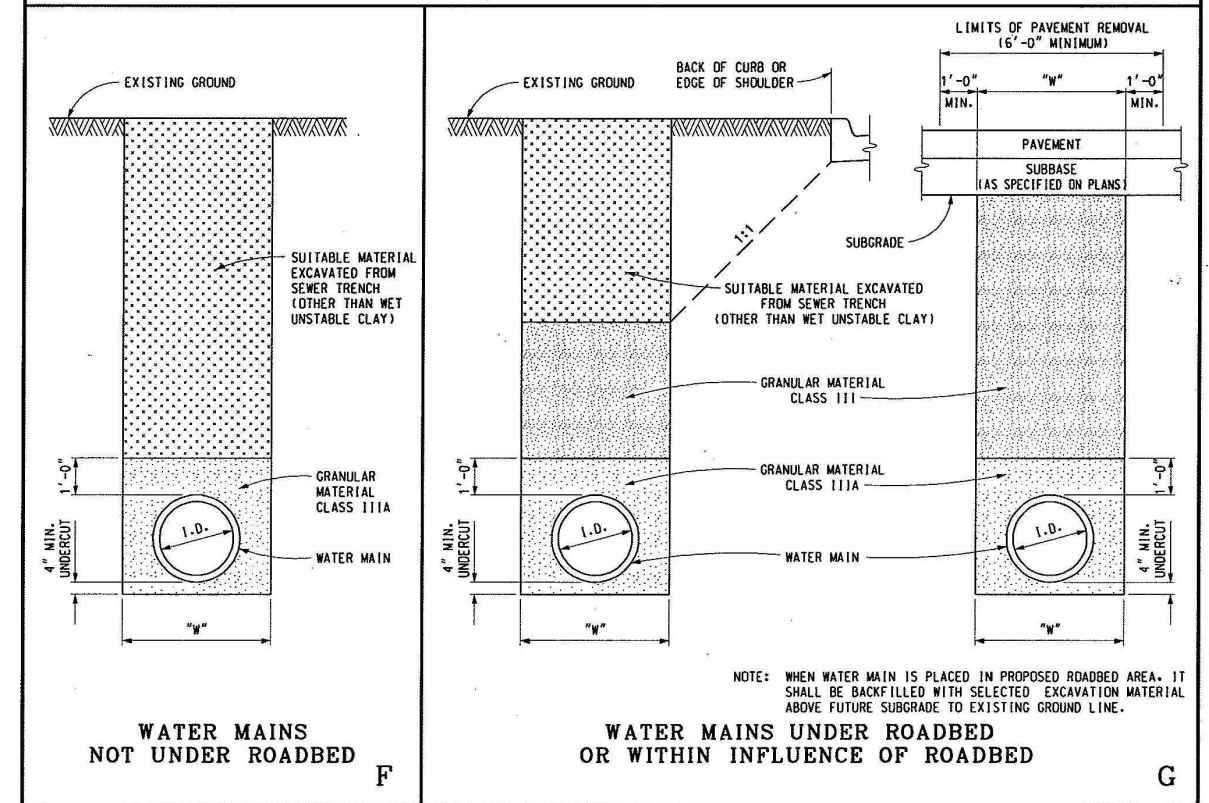
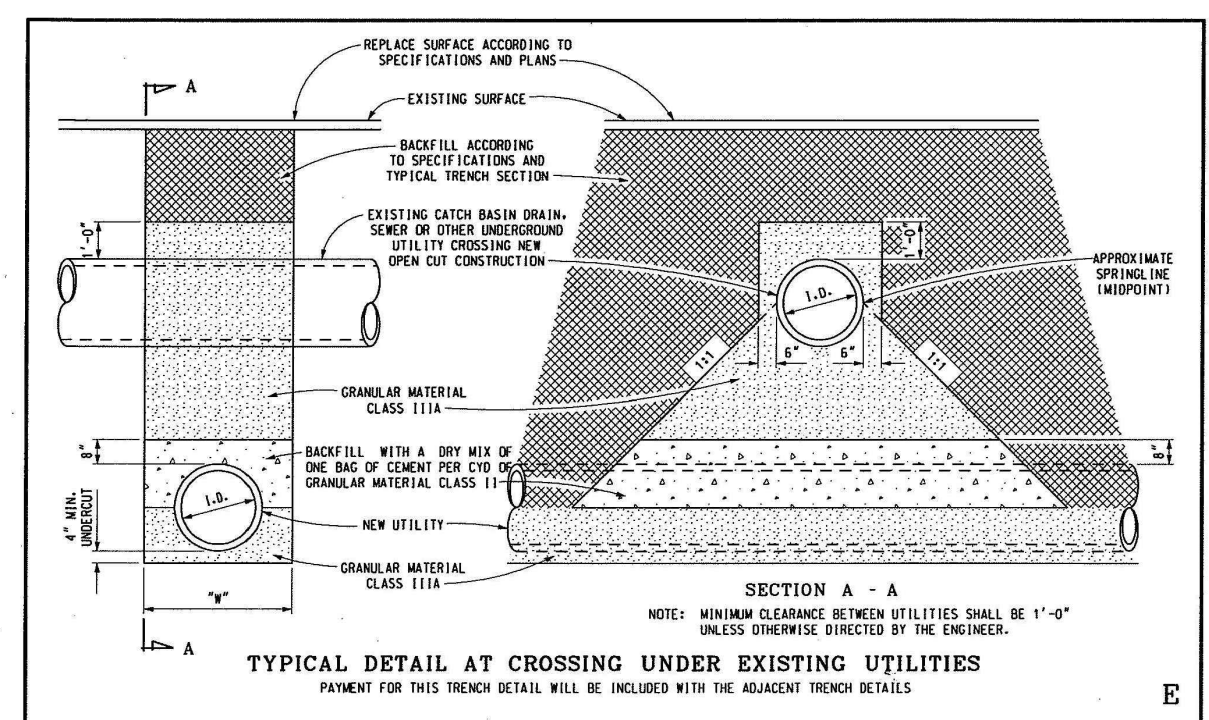
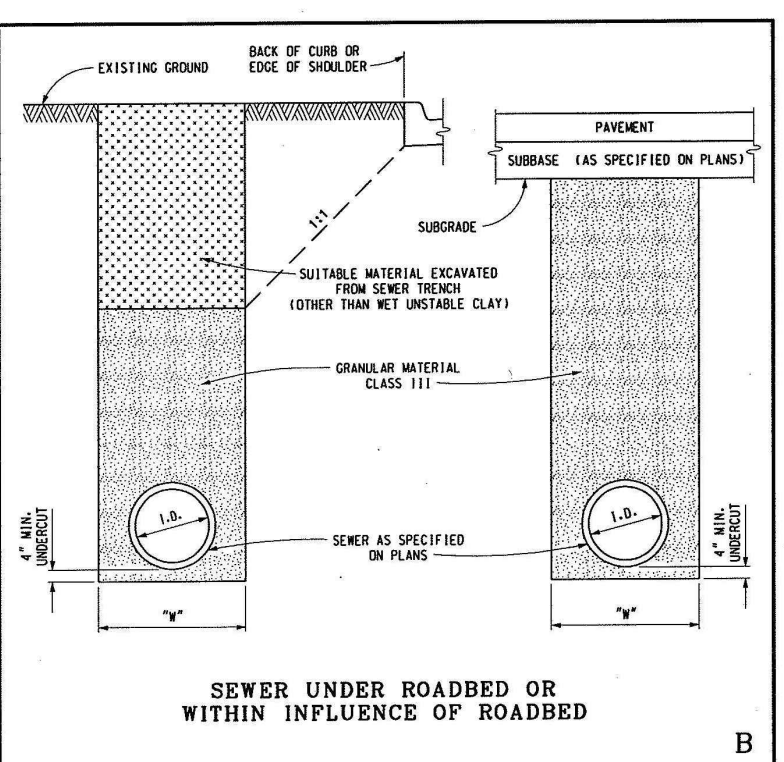
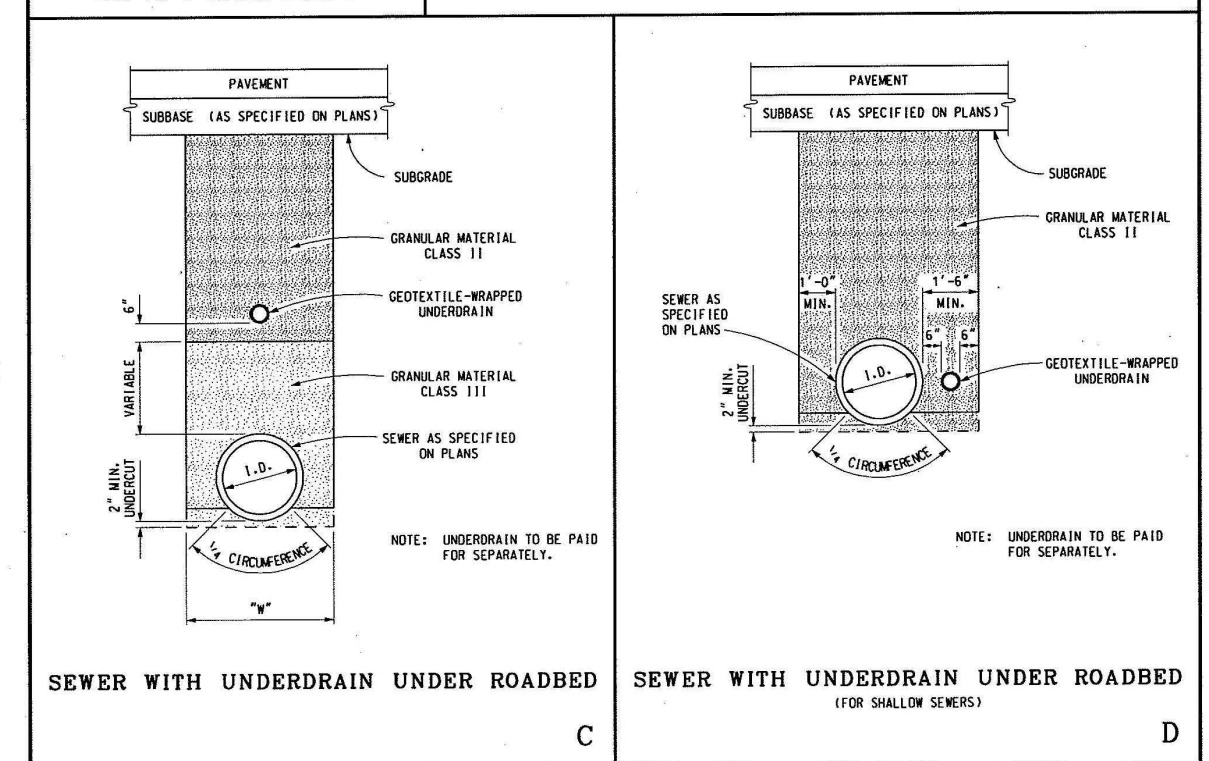
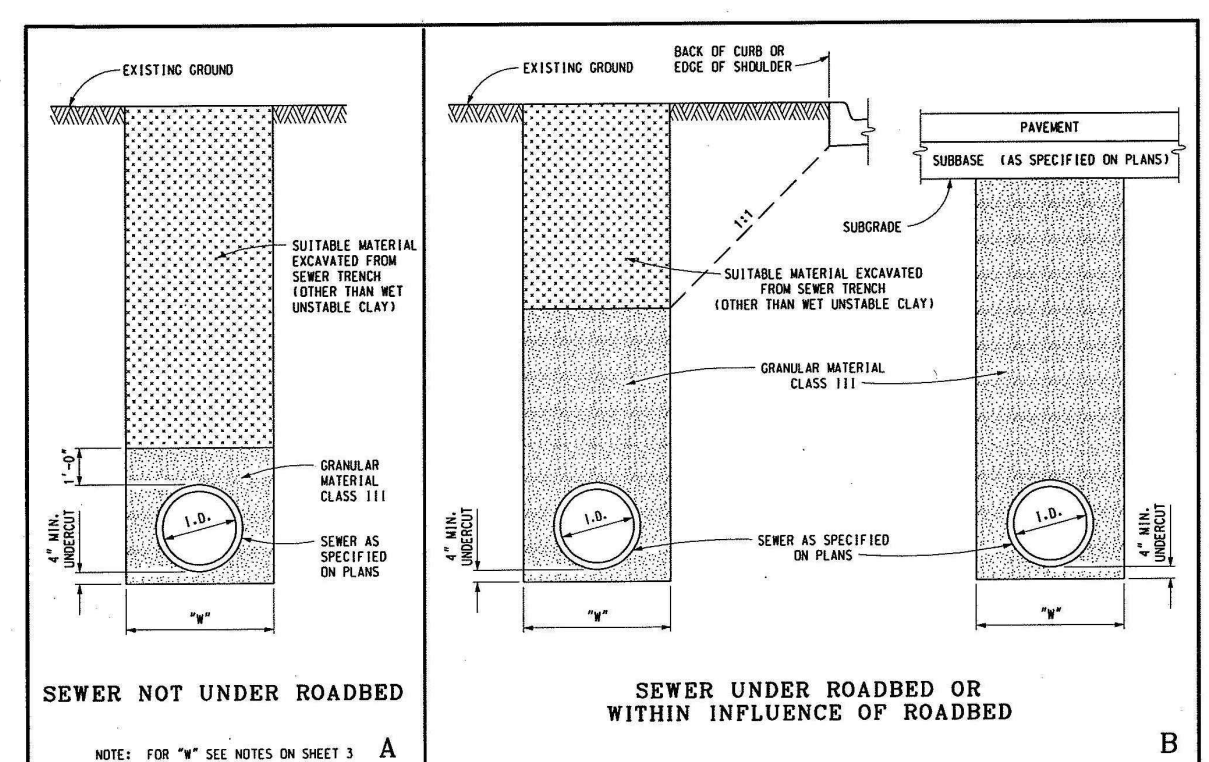
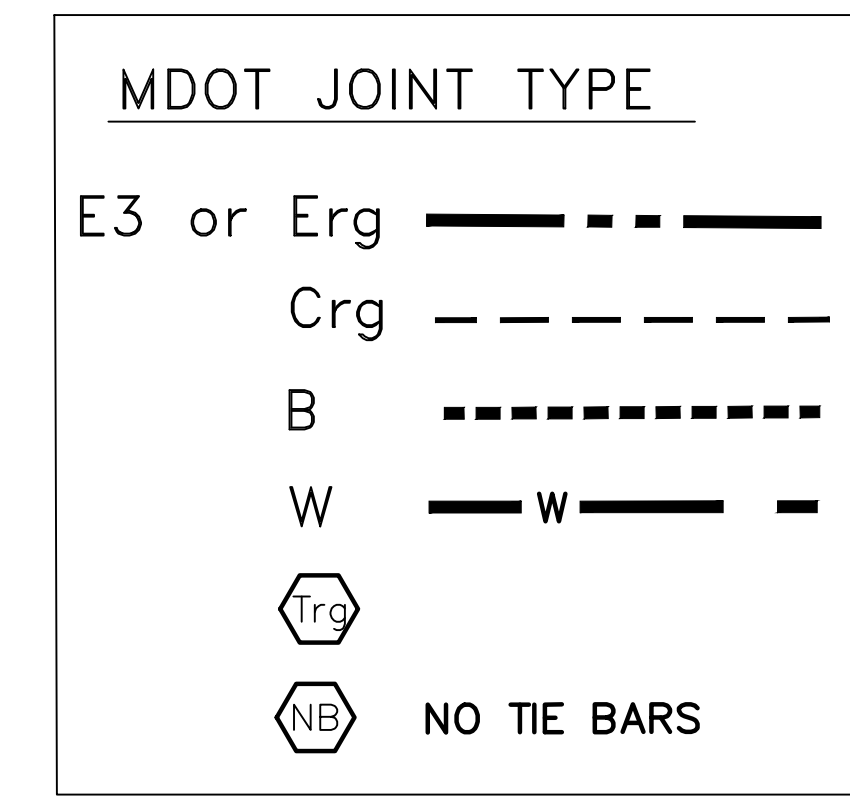
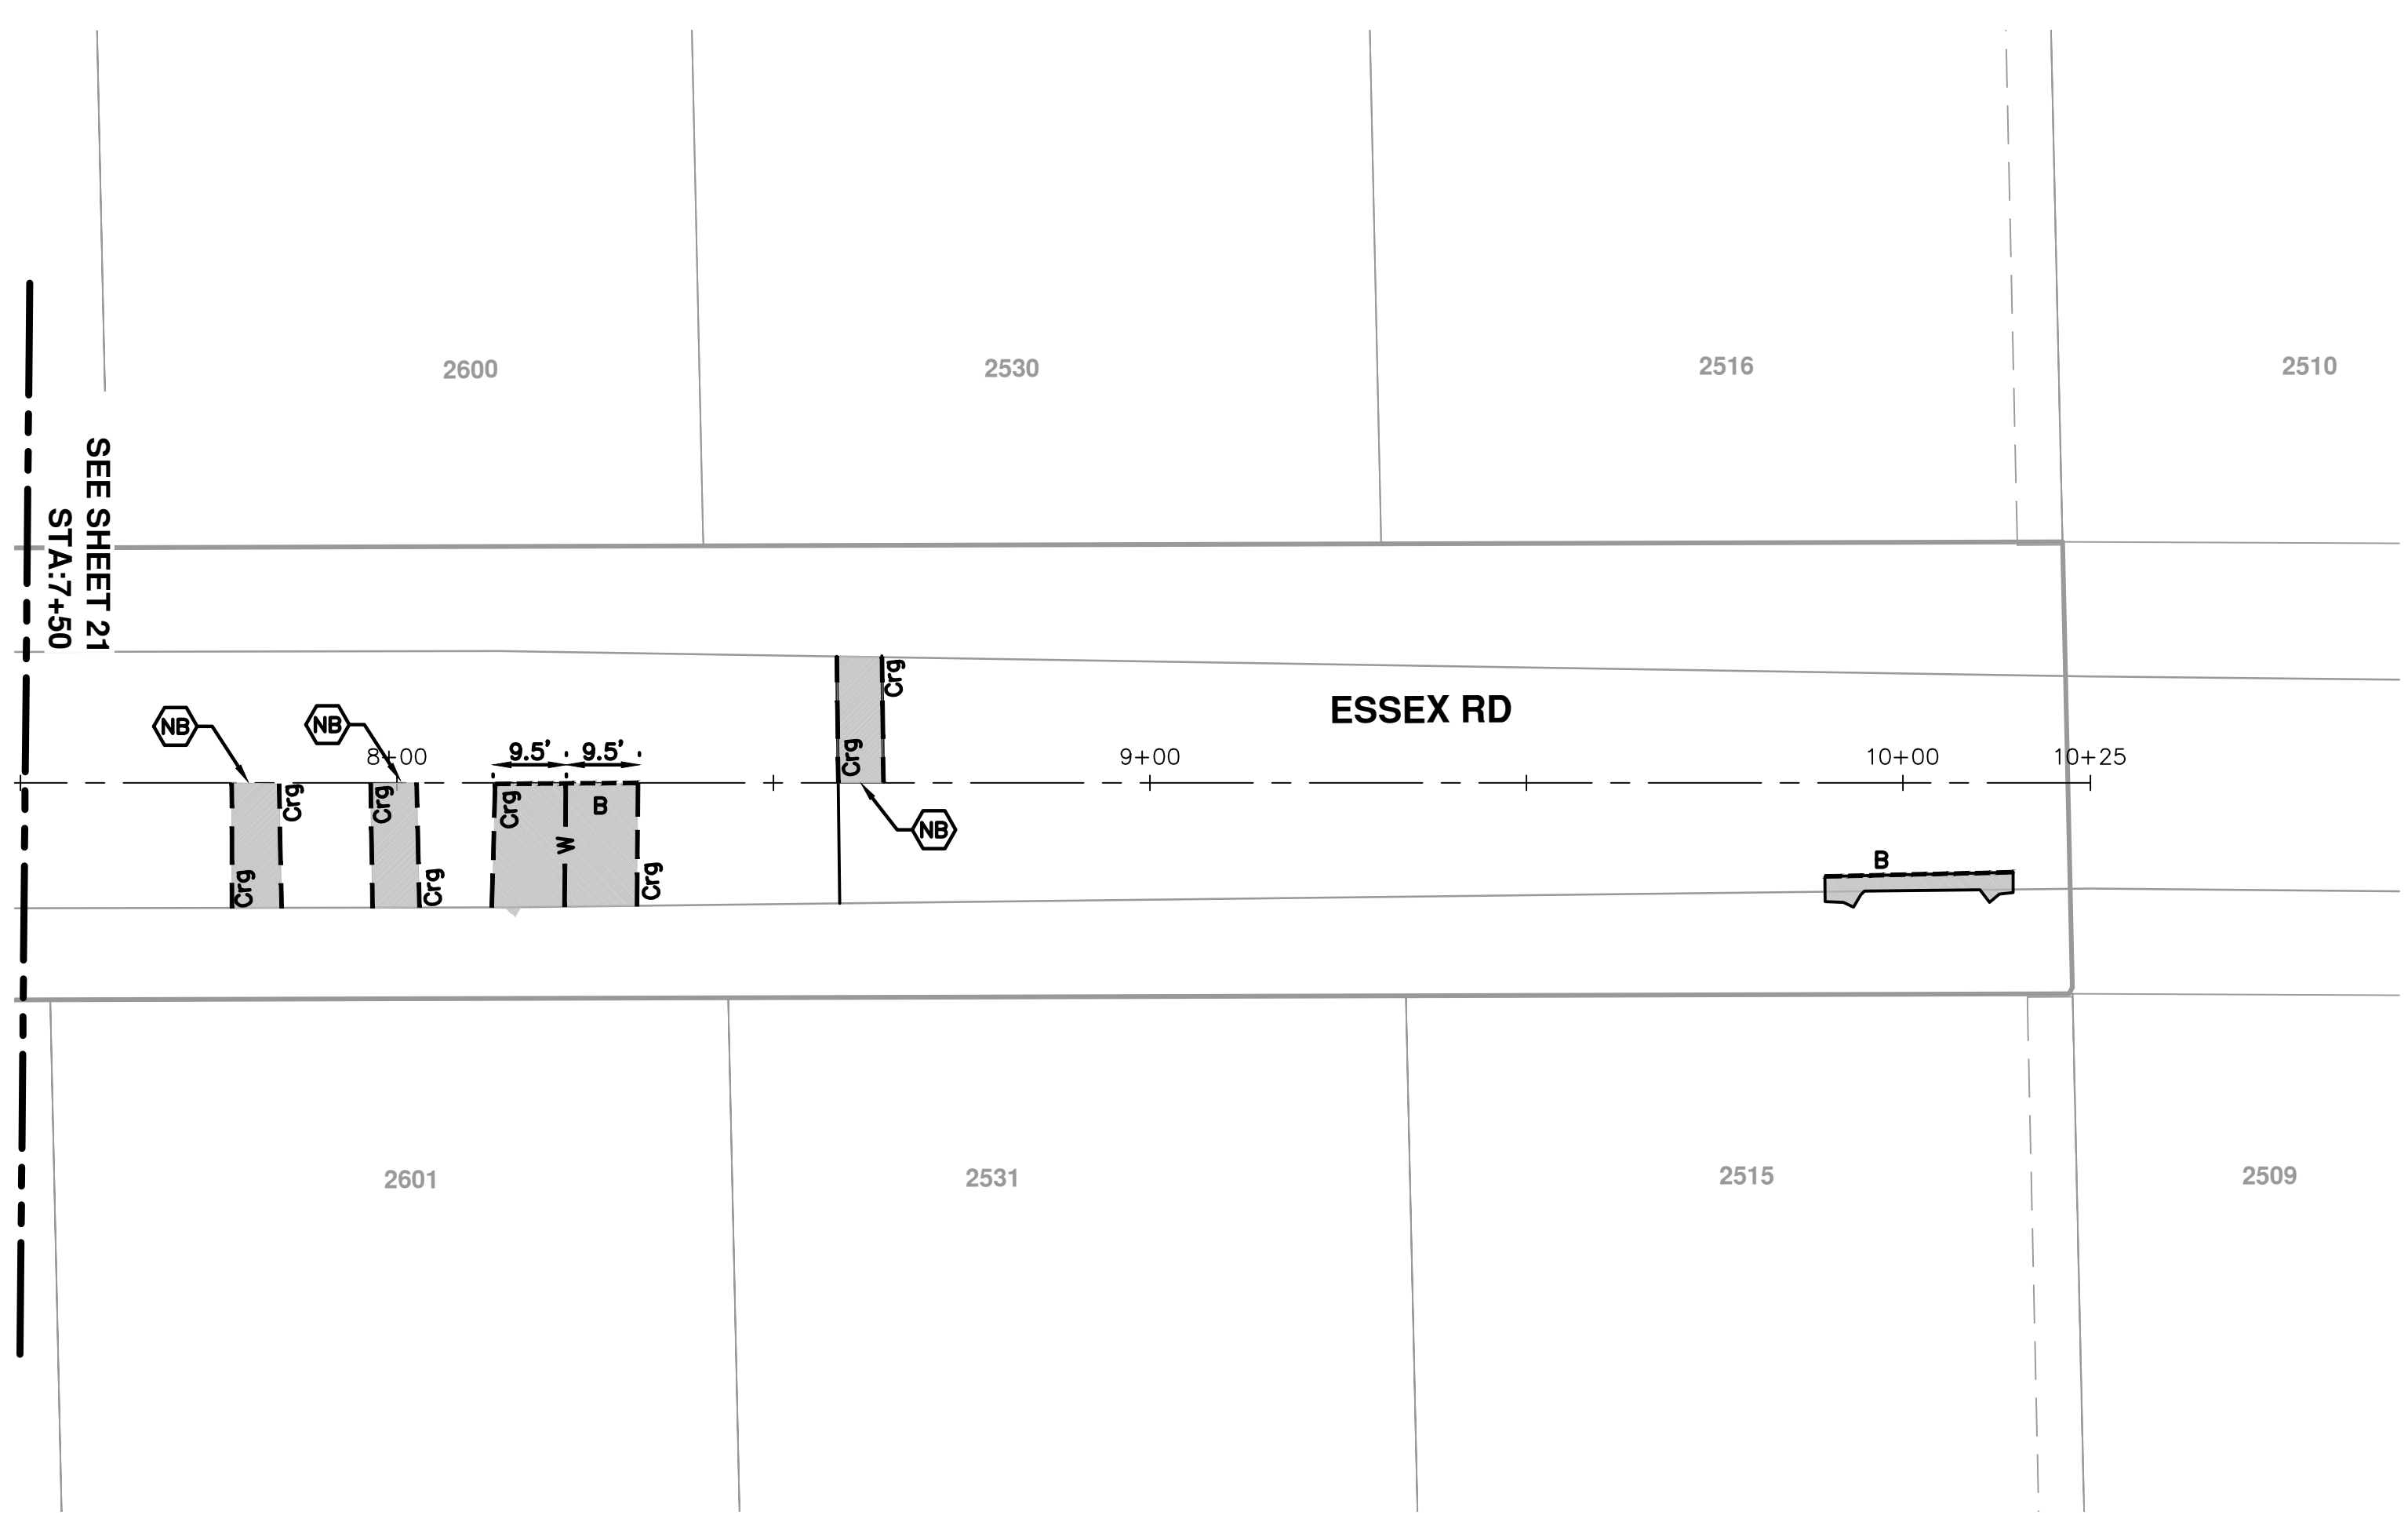


**PROJECT MANAGEMENT - PUBLIC SERVICES - CITY OF ANN ARBOR**  
**COLONY ESSEX MANCHESTER**  
**CONCRETE PAVEMENT REPAIR**  
 ESSEX RD  
 STA 7+50 TO 10+25 REMOVAL AND CONSTRUCTION PLAN

SCALE PLAN: 1" = 20'  
 DRAWING No.  
 2015024-24

REV.	DESCRIPTION	DATE	DRAWN	CHECKED





**REQUIRED ENCASEMENT SIZE FOR RESPECTIVE PIPE SIZES**

DIAMETER OF PIPE	ENCASEMENT SIZE AND TRENCH WIDTH
6"	3'-4"
8"	3'-6"
10"	4'-0"
12"	4'-4"
14"	4'-8"
16"	5'-0"
18"	5'-4"
20"	5'-8"
24"	6'-0"
30"	7'-0"
36"	7'-4"
42"	7'-8"
48"	8'-0"
54"	8'-4"
60"	8'-8"
66"	9'-0"

**NOTES:**

BEFORE UNDER THE UTILITY SHALL BE AS SPECIFIED AND THE UNDERCUT MATERIAL REPLACED WITH GRANULAR MATERIAL, CLASS 111A. BACKFILLING SHALL BE ACCORDING TO THE CURRENT STANDARD SPECIFICATION.

BACKFILL FOR UTILITY TRENCHES ABOVE GRANULAR MATERIAL CLASS 111A SHALL BE PLACED AS FOLLOWS:

- GRANULAR MATERIAL, OF THE CLASS SPECIFIED ON DETAILS, SHALL BE USED TO BACKFILL TRENCHES UNDER THE ROADBED AND SHALL BE COMPACTED TO NOT LESS THAN 95% OF ITS MAXIMUM UNIT WEIGHT.
- GRANULAR MATERIAL, OF THE CLASS SPECIFIED ON DETAILS, SHALL BE USED TO BACKFILL UTILITY TRENCHES OUTSIDE THE ROADBED BUT WITHIN THE 1:1 ZONE OF INFLUENCE SHOWN. IT WILL ALSO BE USED AS BACKFILL UNDER SIDEWALKS, SURFACES, AND MISCELLANEOUS STRUCTURES, AND COMPACTED TO NOT LESS THAN 95% OF ITS MAXIMUM UNIT WEIGHT.
- WHEN ACCEPTABLE, MATERIAL EXCAVATED FROM THE UTILITY TRENCHES SHALL BE USED TO BACKFILL UTILITY TRENCHES OUTSIDE THE LIMITS OF THE 1:1 ZONE OF INFLUENCE AND SHALL BE COMPACTED TO NOT LESS THAN 95% OF ITS MAXIMUM UNIT WEIGHT.

GRANULAR MATERIAL CLASS 111, 11A, OR 111A MAY BE USED WHERE GRANULAR MATERIAL CLASS 111 IS SPECIFIED ON THE PLANS.

SUFFICIENT TRENCH WIDTH SHALL BE PROVIDED TO ALLOW FREE WORKING SPACE AND TO PERMIT COMPACTING THE BACKFILL AROUND THE PIPE.

THE FOLLOWING ARE MINIMUM TRENCH WIDTHS:

PIPE SIZE (INCHES)	LESS THAN 18'	21'	24'	30'	36'
4"	3.0	3.5	4.0	5.0	6.0
6"	4.2	4.8	5.4	6.0	7.2
8"	5.4	6.0	6.6	7.2	8.4
10"	6.6	7.2	7.8	8.4	10.0
12"	7.8	8.4	9.0	9.6	10.8
14"	9.0	9.6	10.2	10.8	12.6
16"	10.2	10.8	11.4	12.0	14.4

ESTIMATED PAVEMENT REMOVAL WIDTH IS TO BE TRENCH WIDTH "W" PLUS 1'-0" EACH SIDE OF THE TRENCH (6'-0" MINIMUM).

**MDOT** MICHIGAN DEPARTMENT OF TRANSPORTATION  
BUREAU OF HIGHWAY TECHNICAL SERVICES STANDARD PLAN FOR

**UTILITY TRENCHES**

ENGINEER: ROAD DESIGN: *Robert Roberts*  
ENGINEER OF DESIGN: *Robert Roberts*  
ENGINEER OF MAINTENANCE: *Robert Roberts*

DATE: 3-14-2001 2-28-2001  
F.A.S.L. APPROVE: TUM DATE

R-83-B SHEET 1 OF 3

**MDOT** MICHIGAN DEPARTMENT OF TRANSPORTATION  
BUREAU OF HIGHWAY TECHNICAL SERVICES STANDARD PLAN FOR

**UTILITY TRENCHES**

ENGINEER: ROAD DESIGN: *Robert Roberts*  
ENGINEER OF DESIGN: *Robert Roberts*  
ENGINEER OF MAINTENANCE: *Robert Roberts*

DATE: 3-14-2001 2-28-2001  
F.A.S.L. APPROVE: TUM DATE

R-83-B SHEET 2 OF 3

**MDOT** MICHIGAN DEPARTMENT OF TRANSPORTATION  
BUREAU OF HIGHWAY TECHNICAL SERVICES STANDARD PLAN FOR

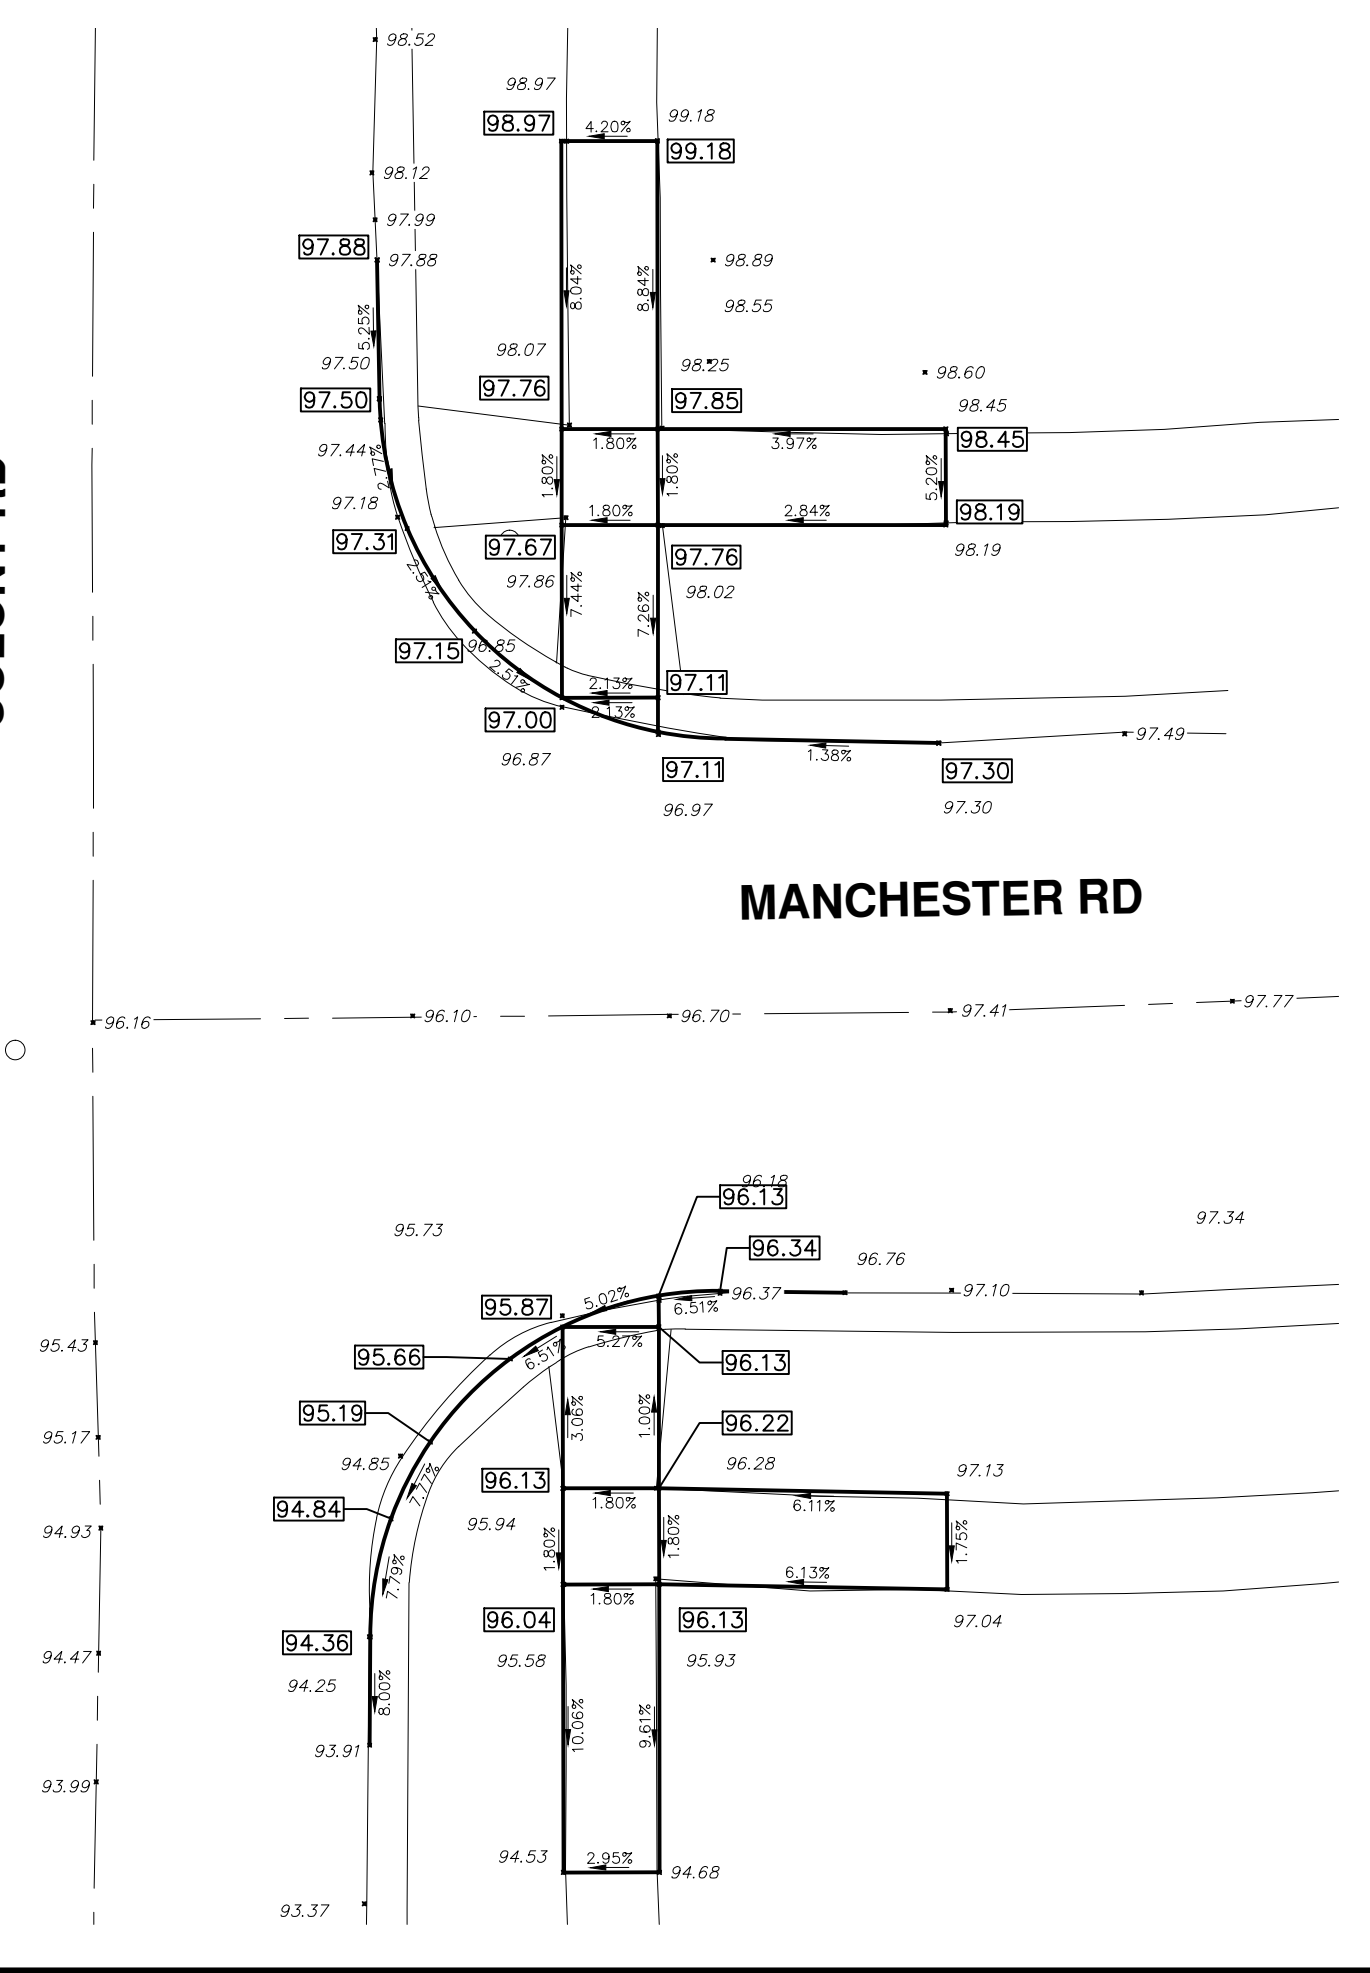
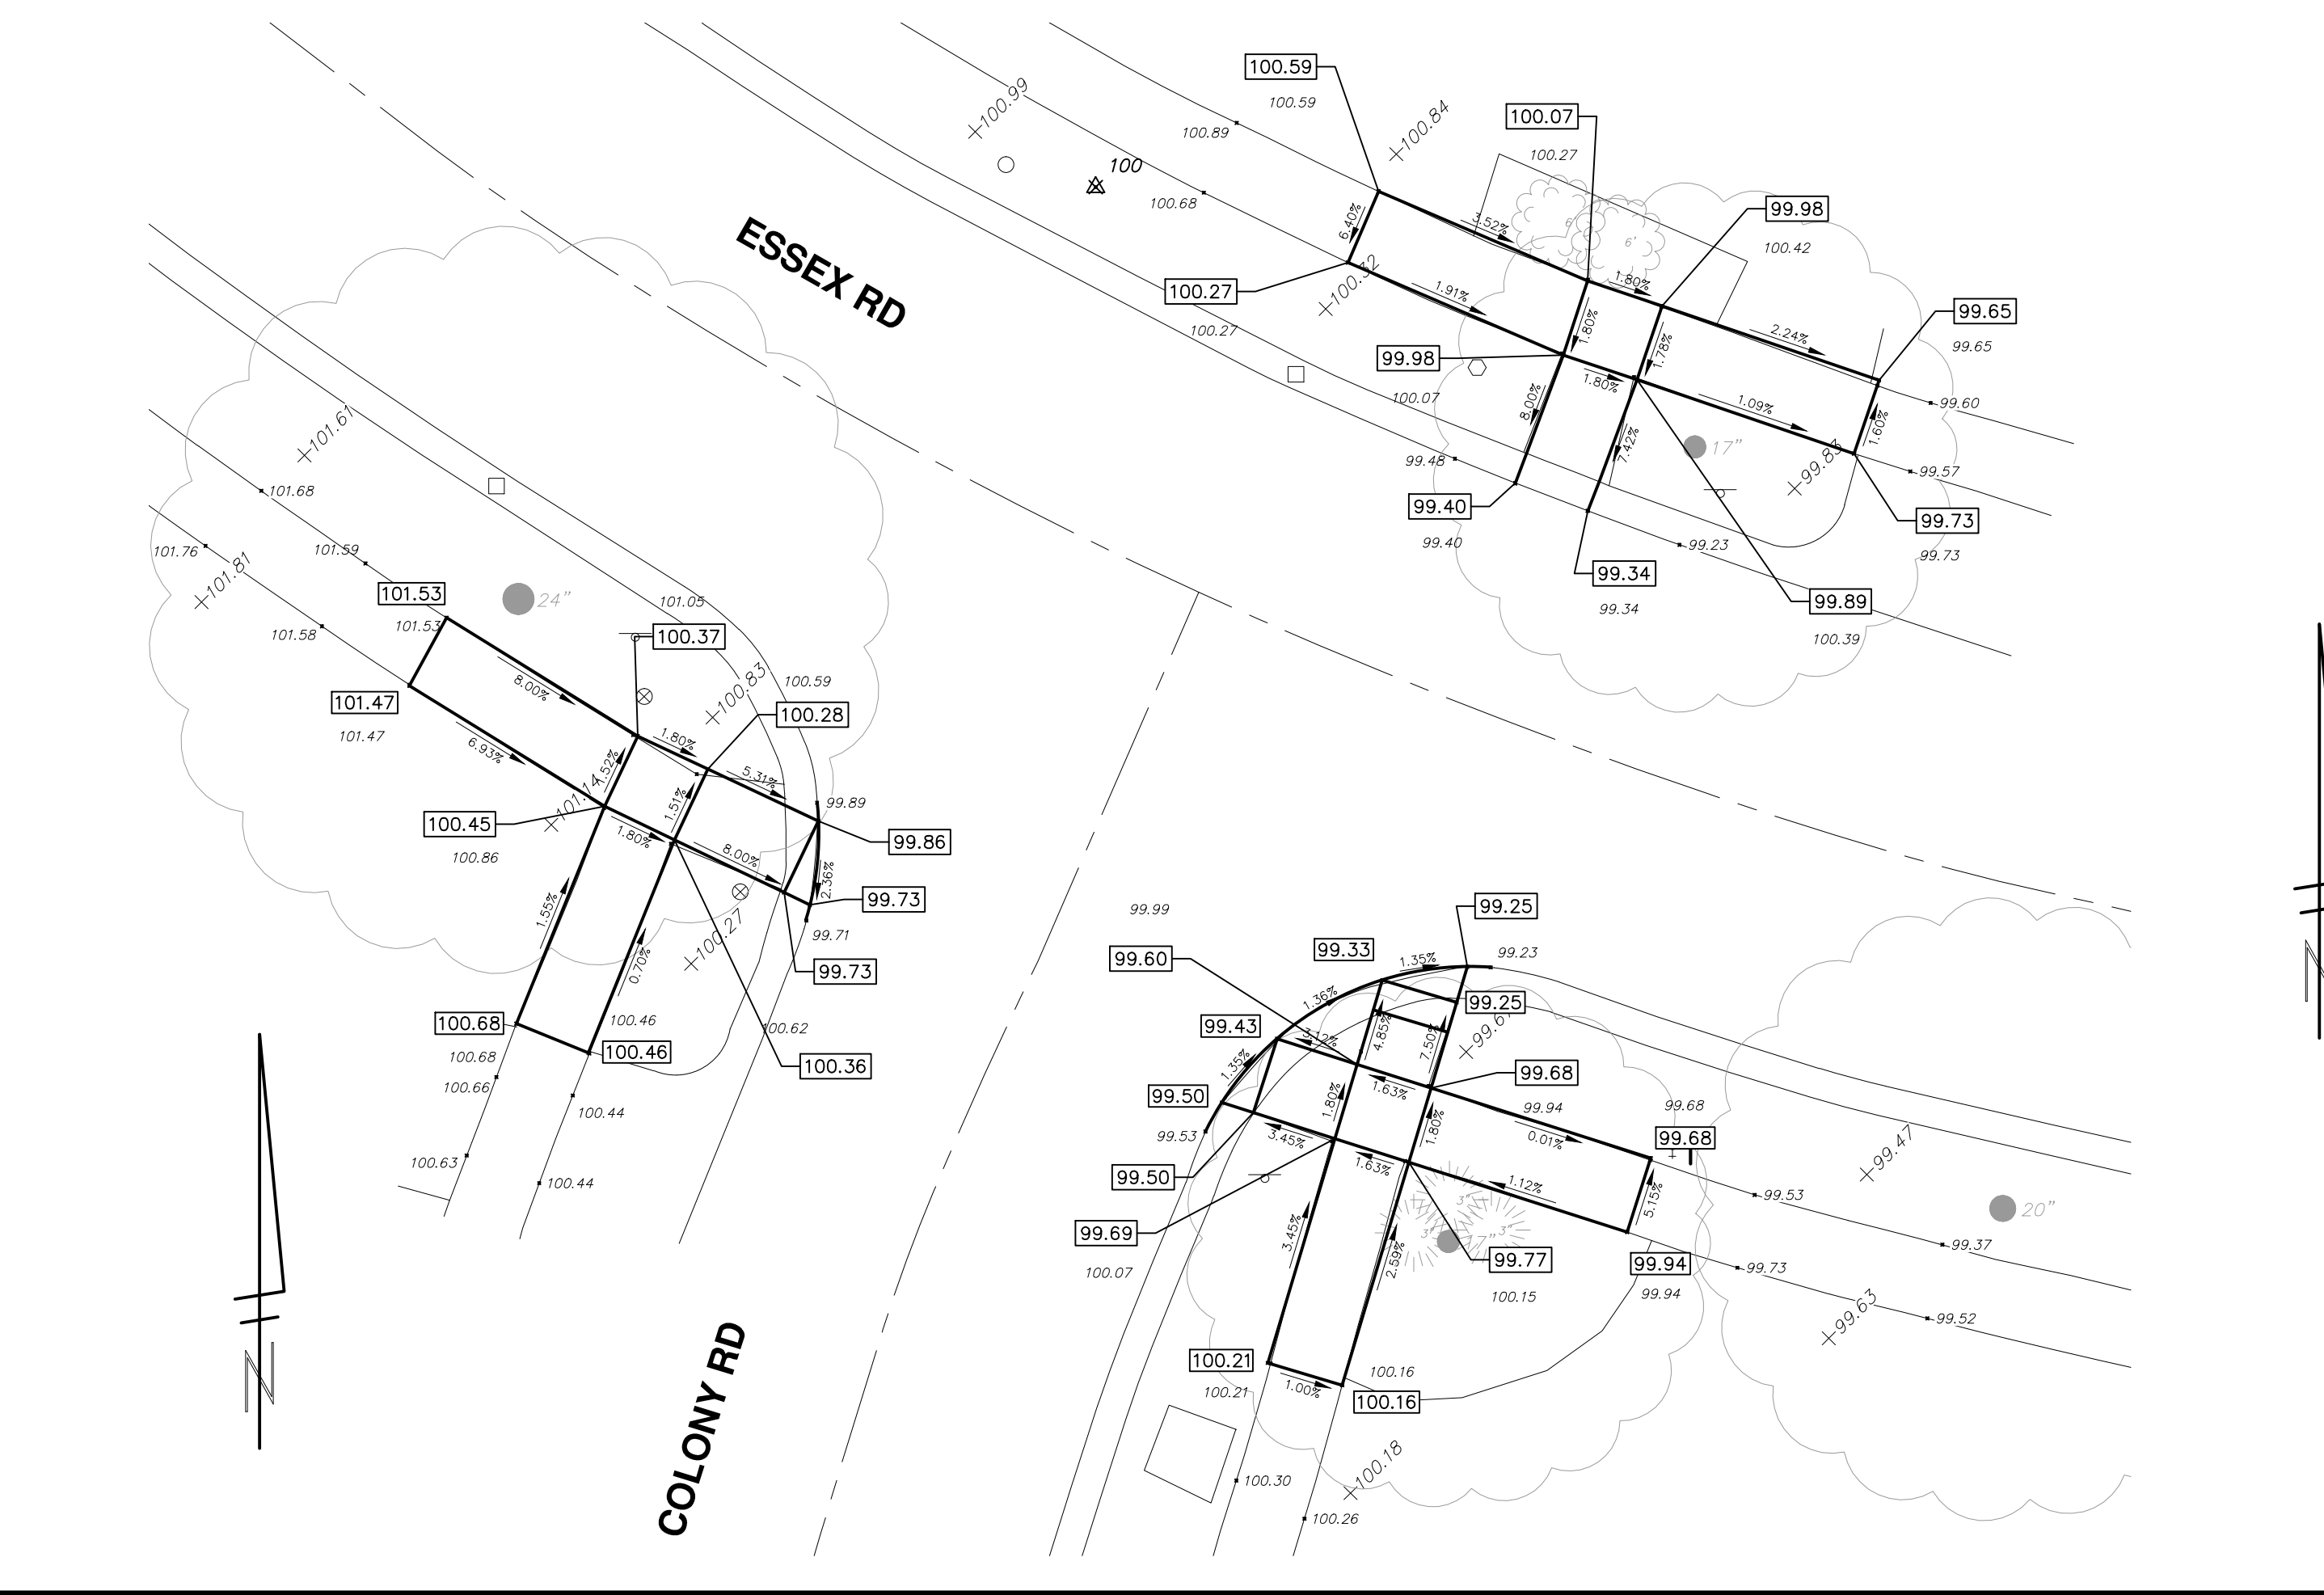
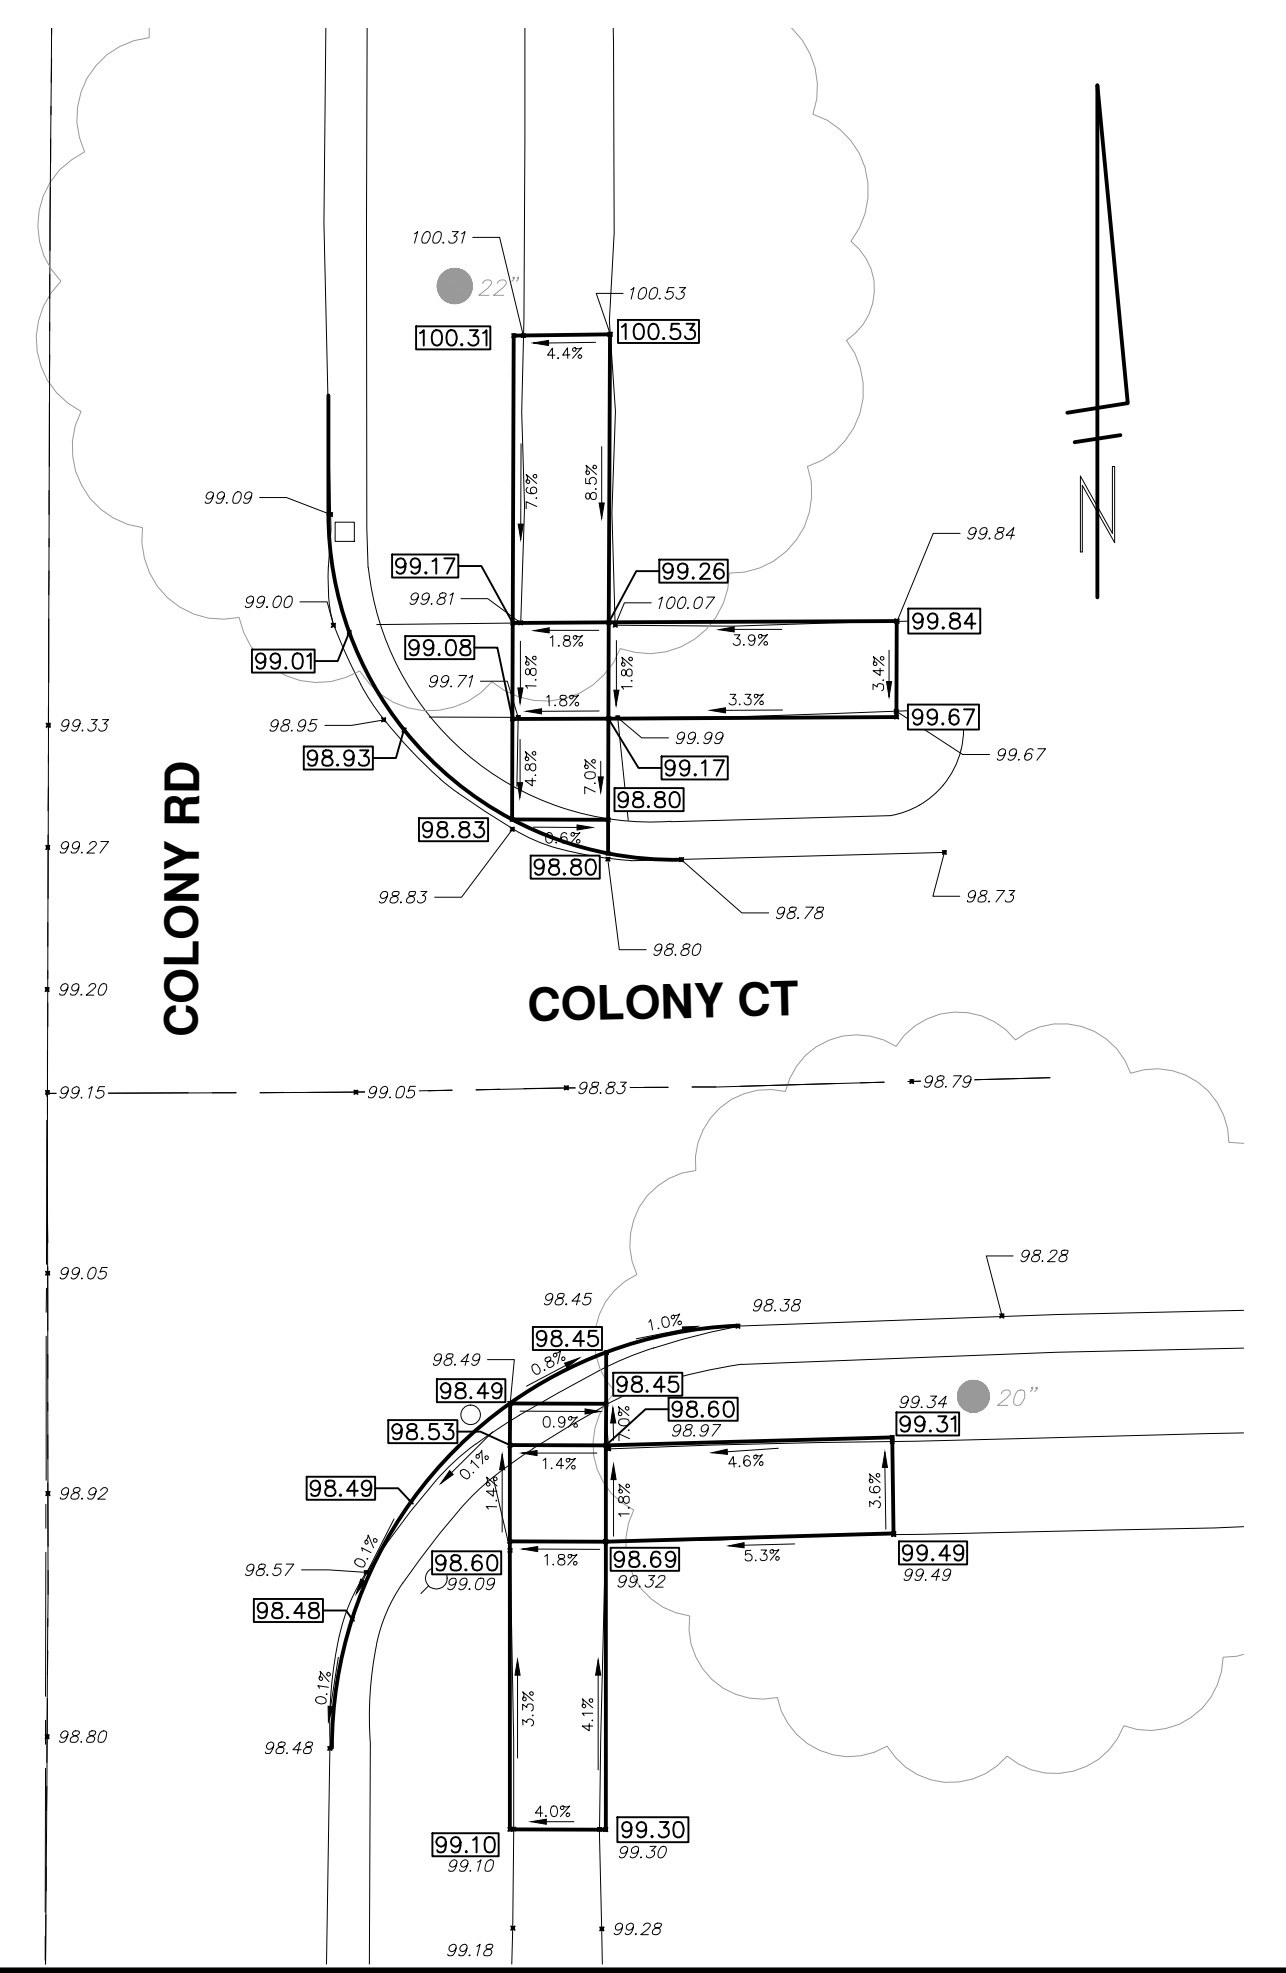
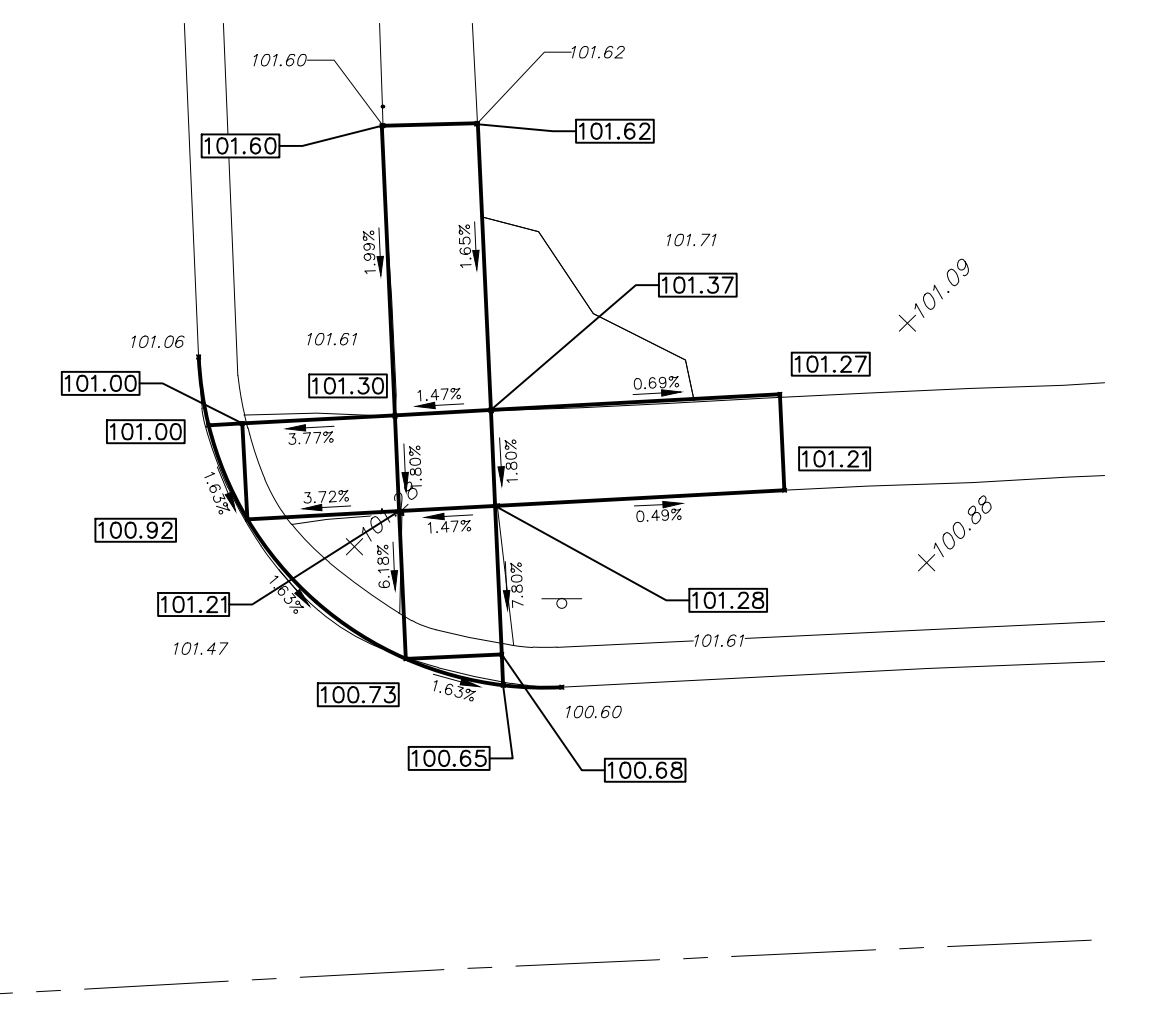
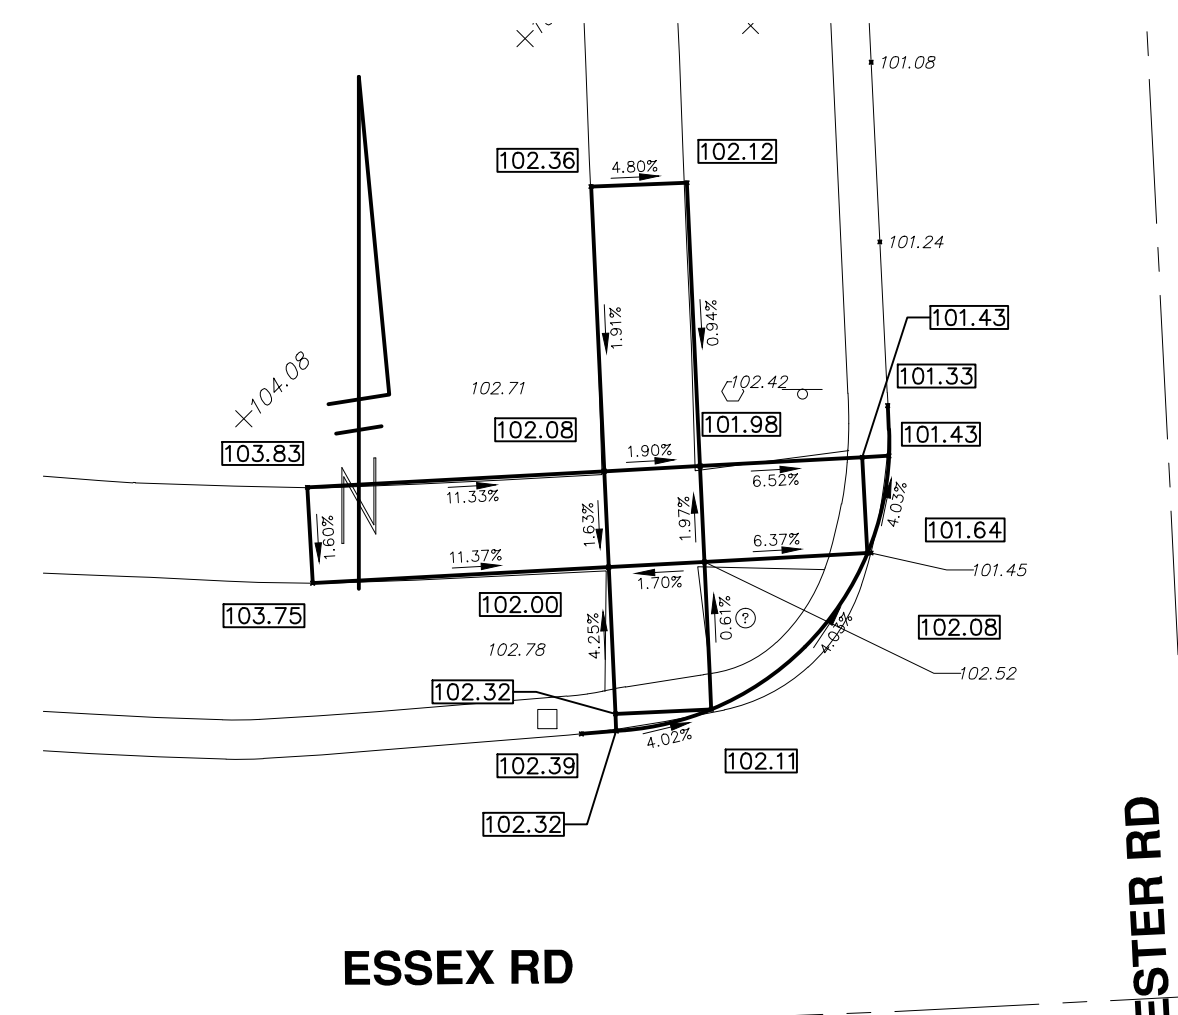
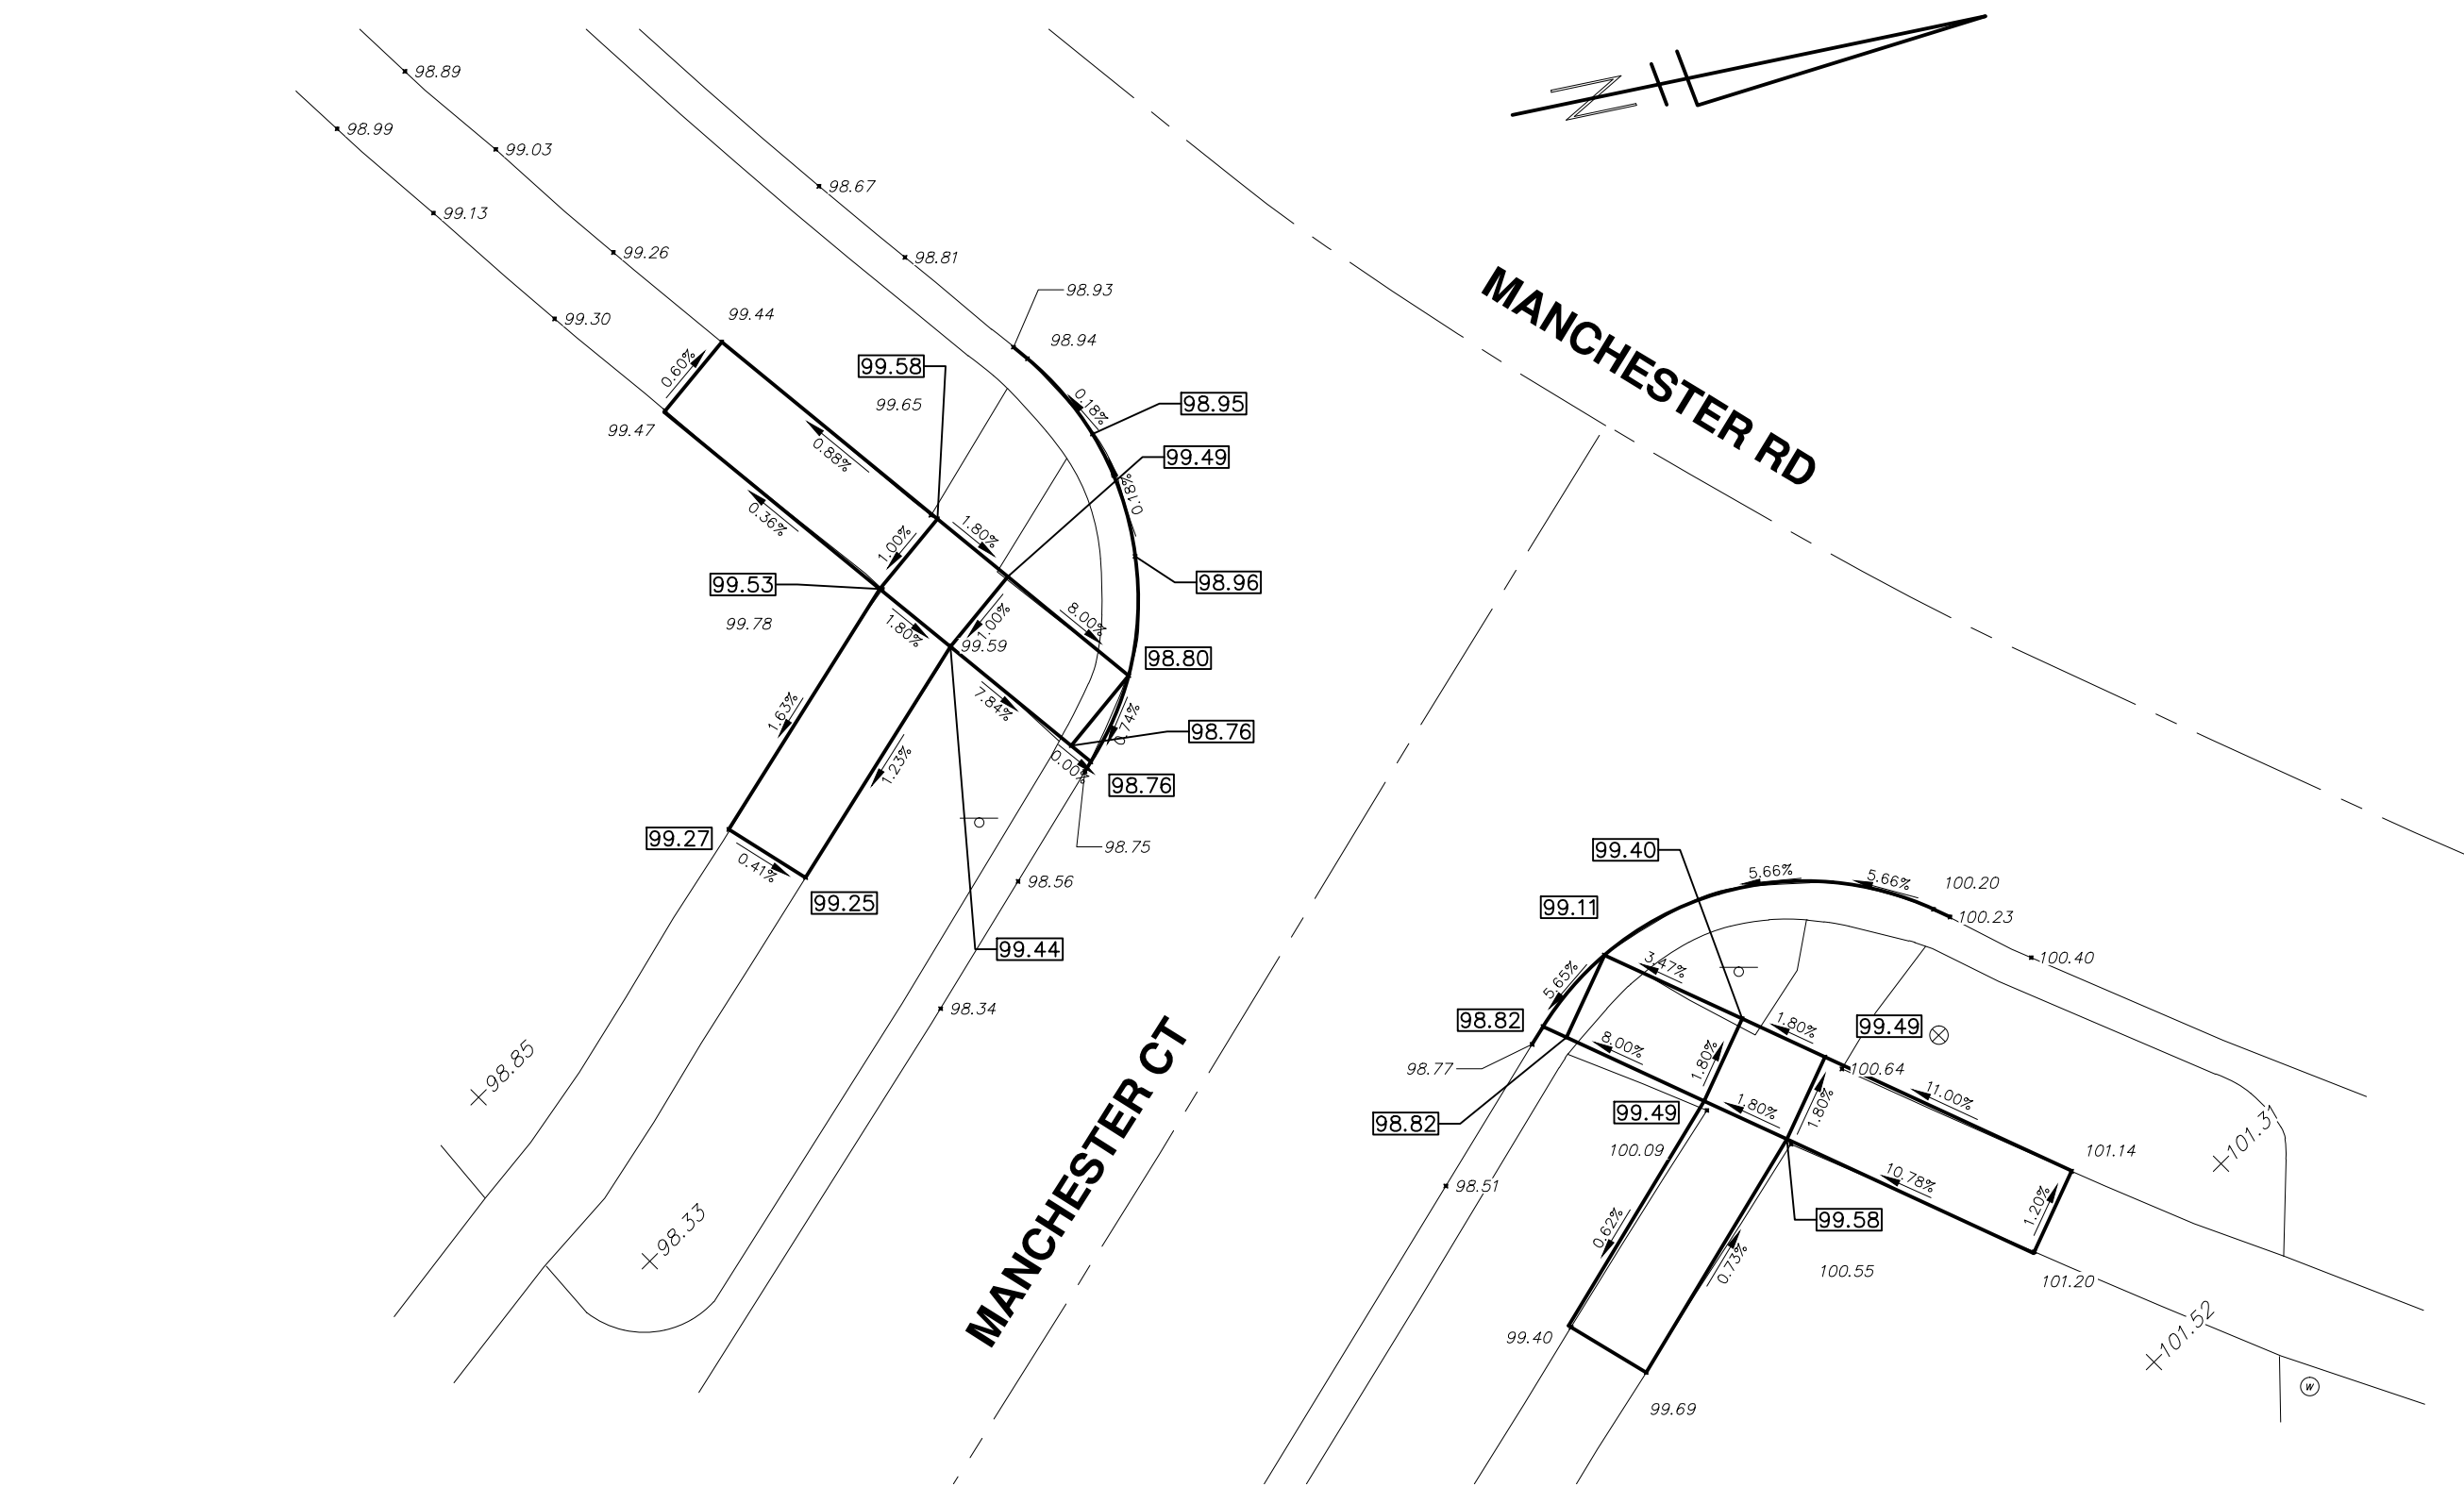
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ENGINEER OF DESIGN: *Robert Roberts*  
ENGINEER OF MAINTENANCE: *Robert Roberts*

DATE: 3-14-2001 2-28-2001  
F.A.S.L. APPROVE: TUM DATE

R-83-B SHEET 3 OF 3

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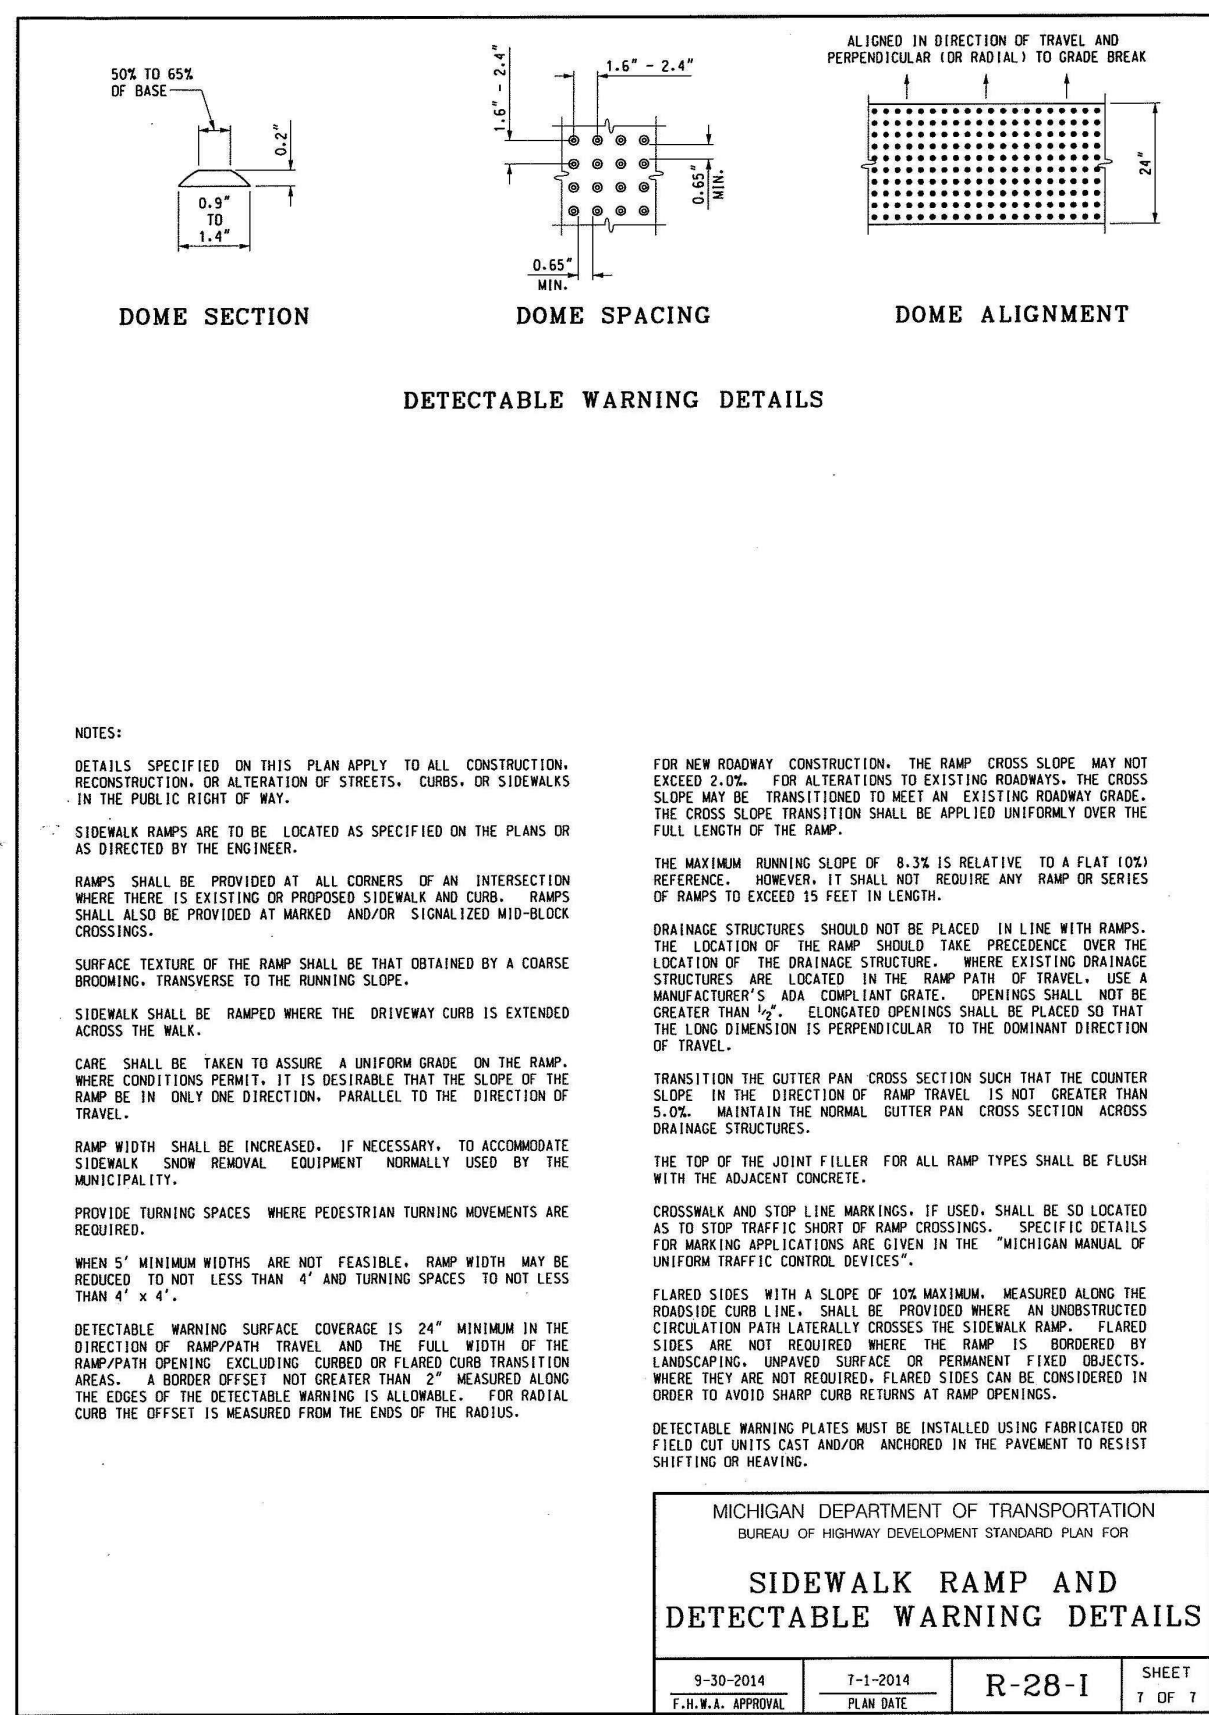
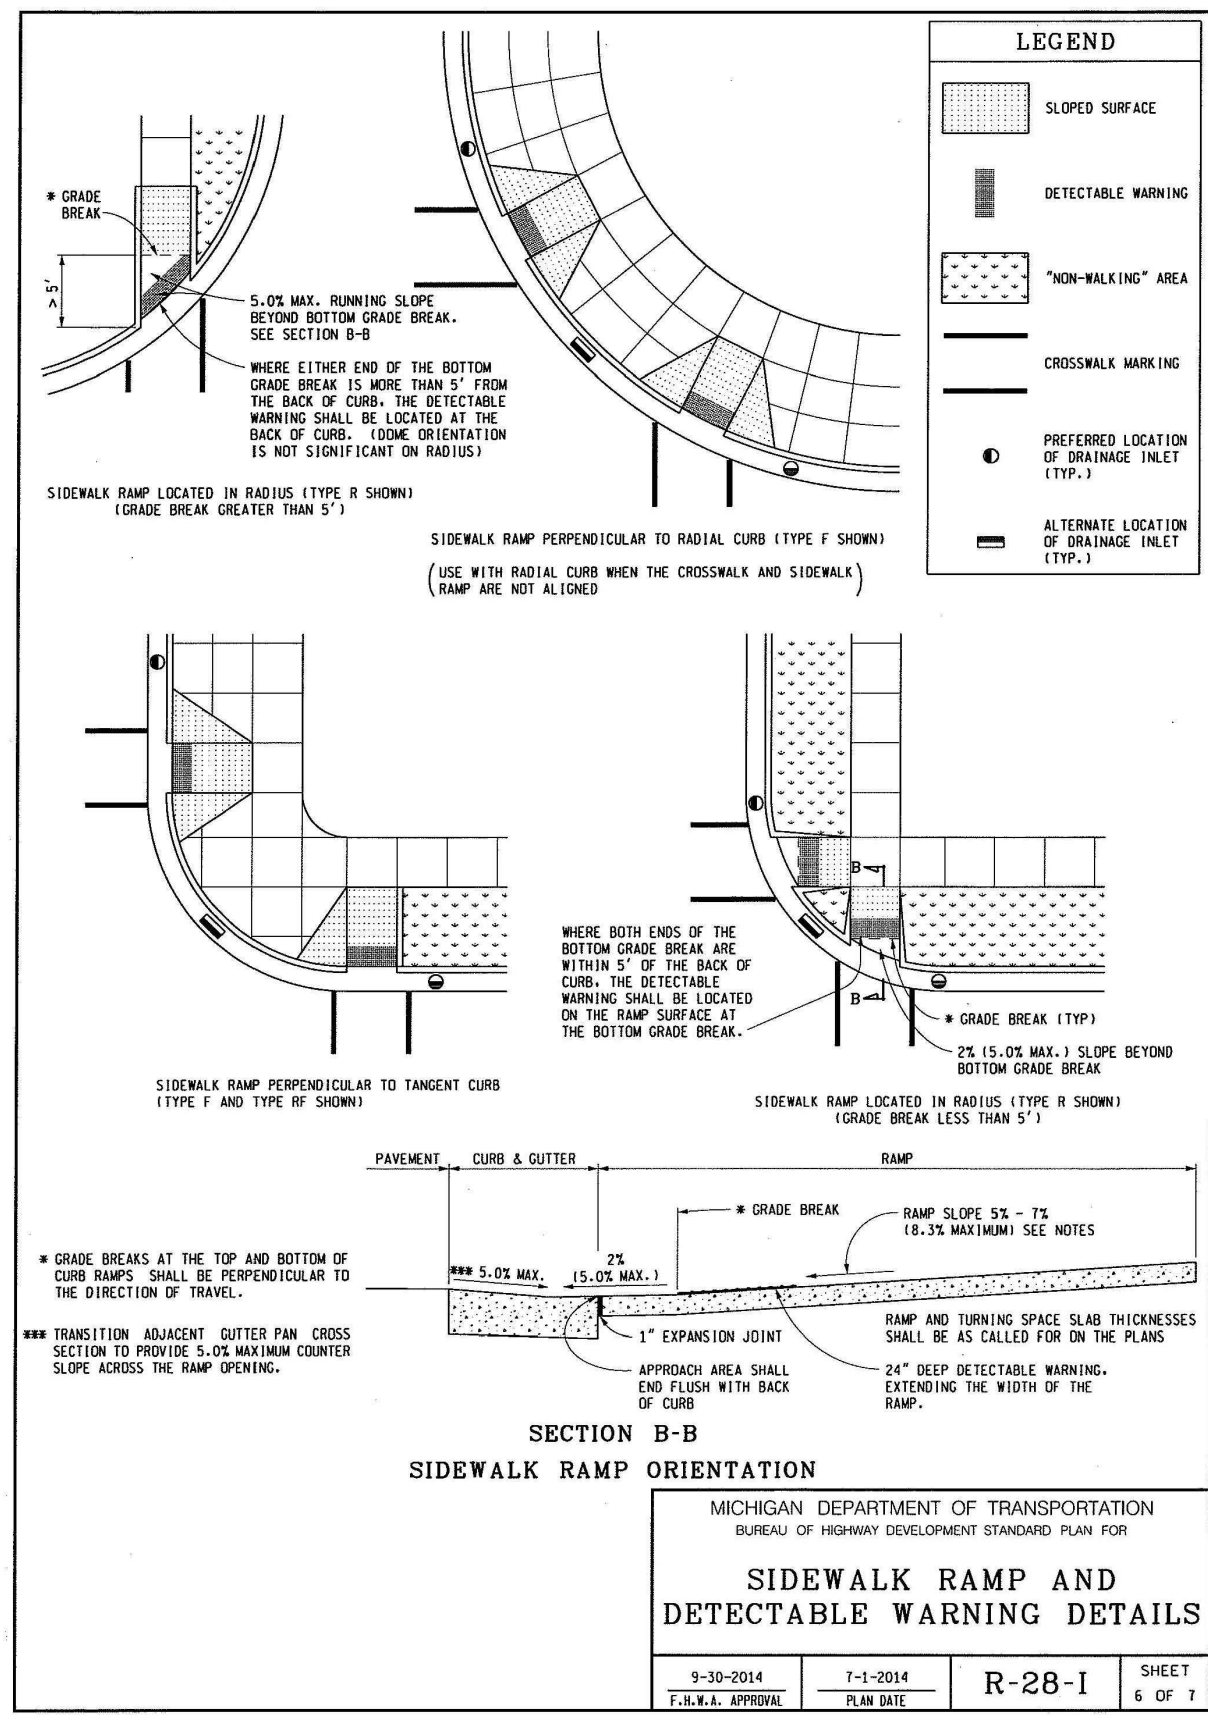
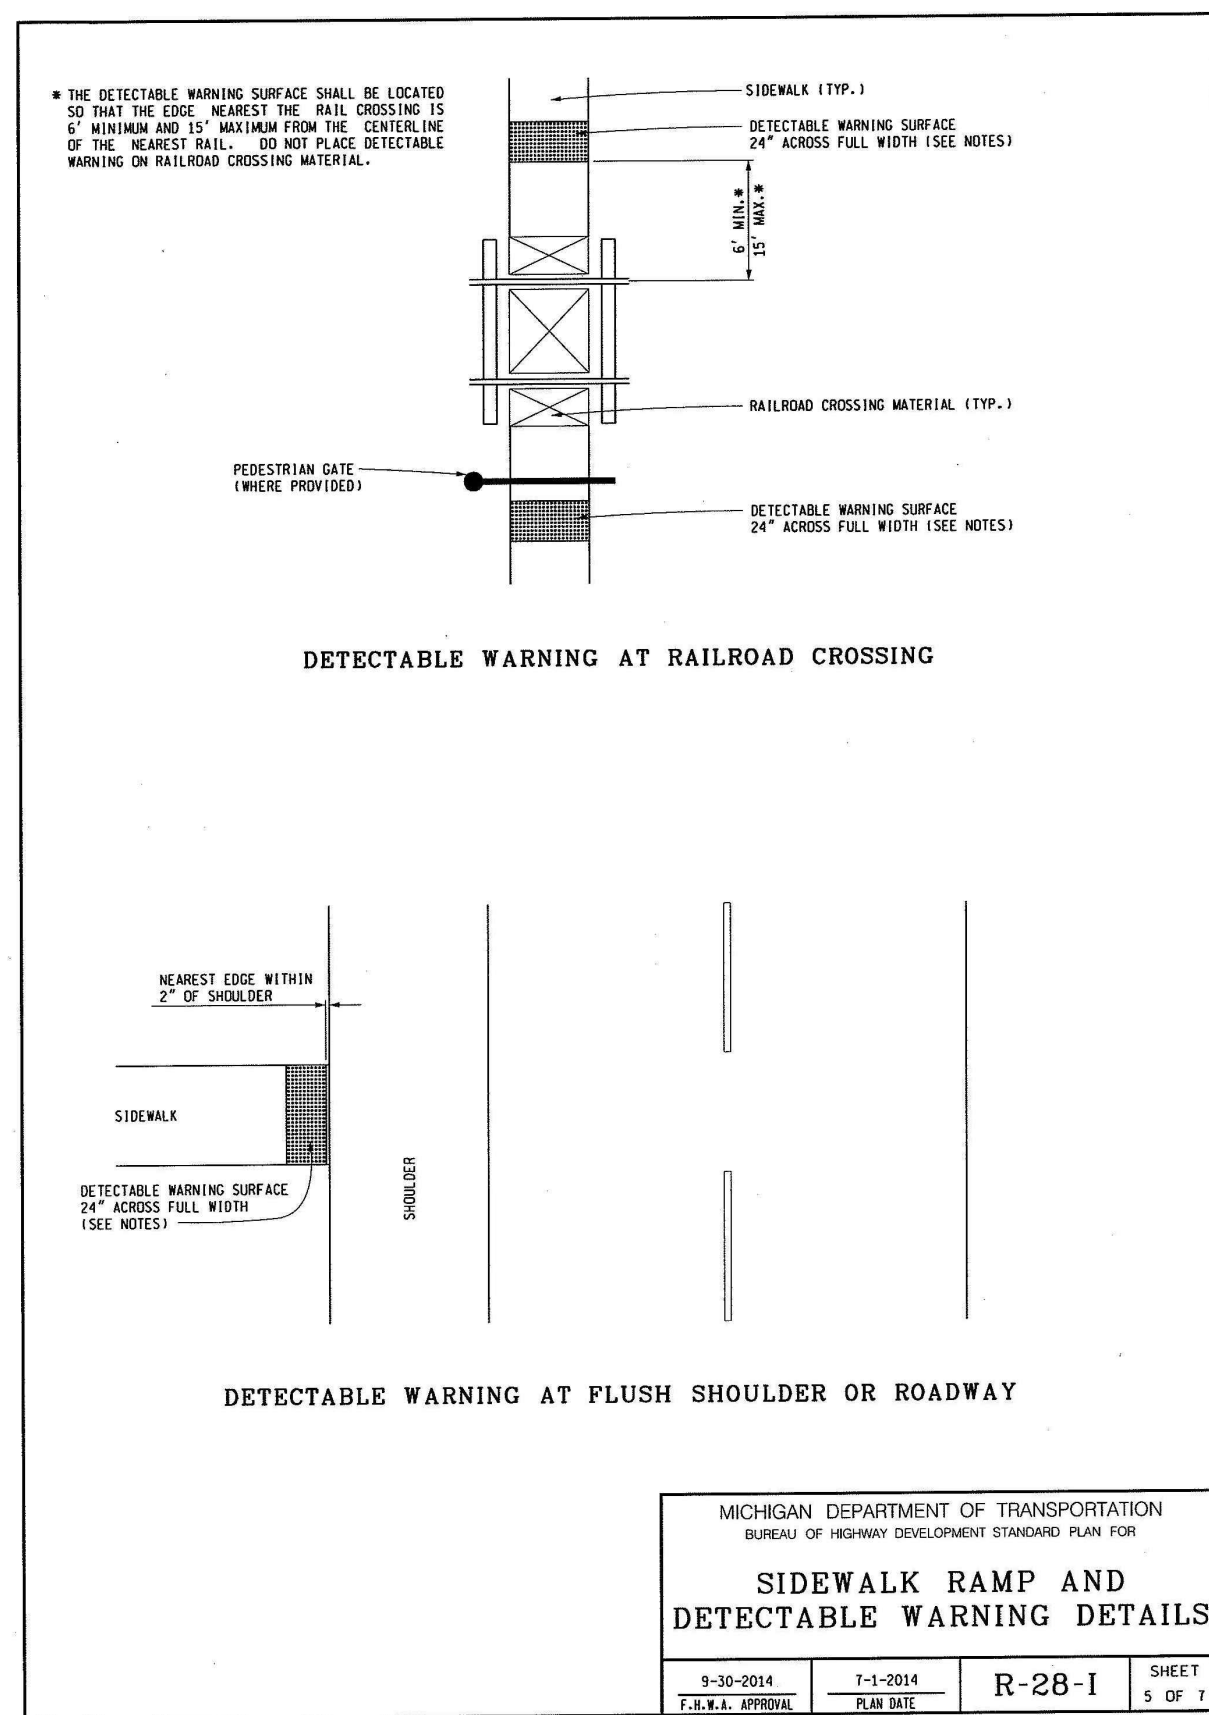
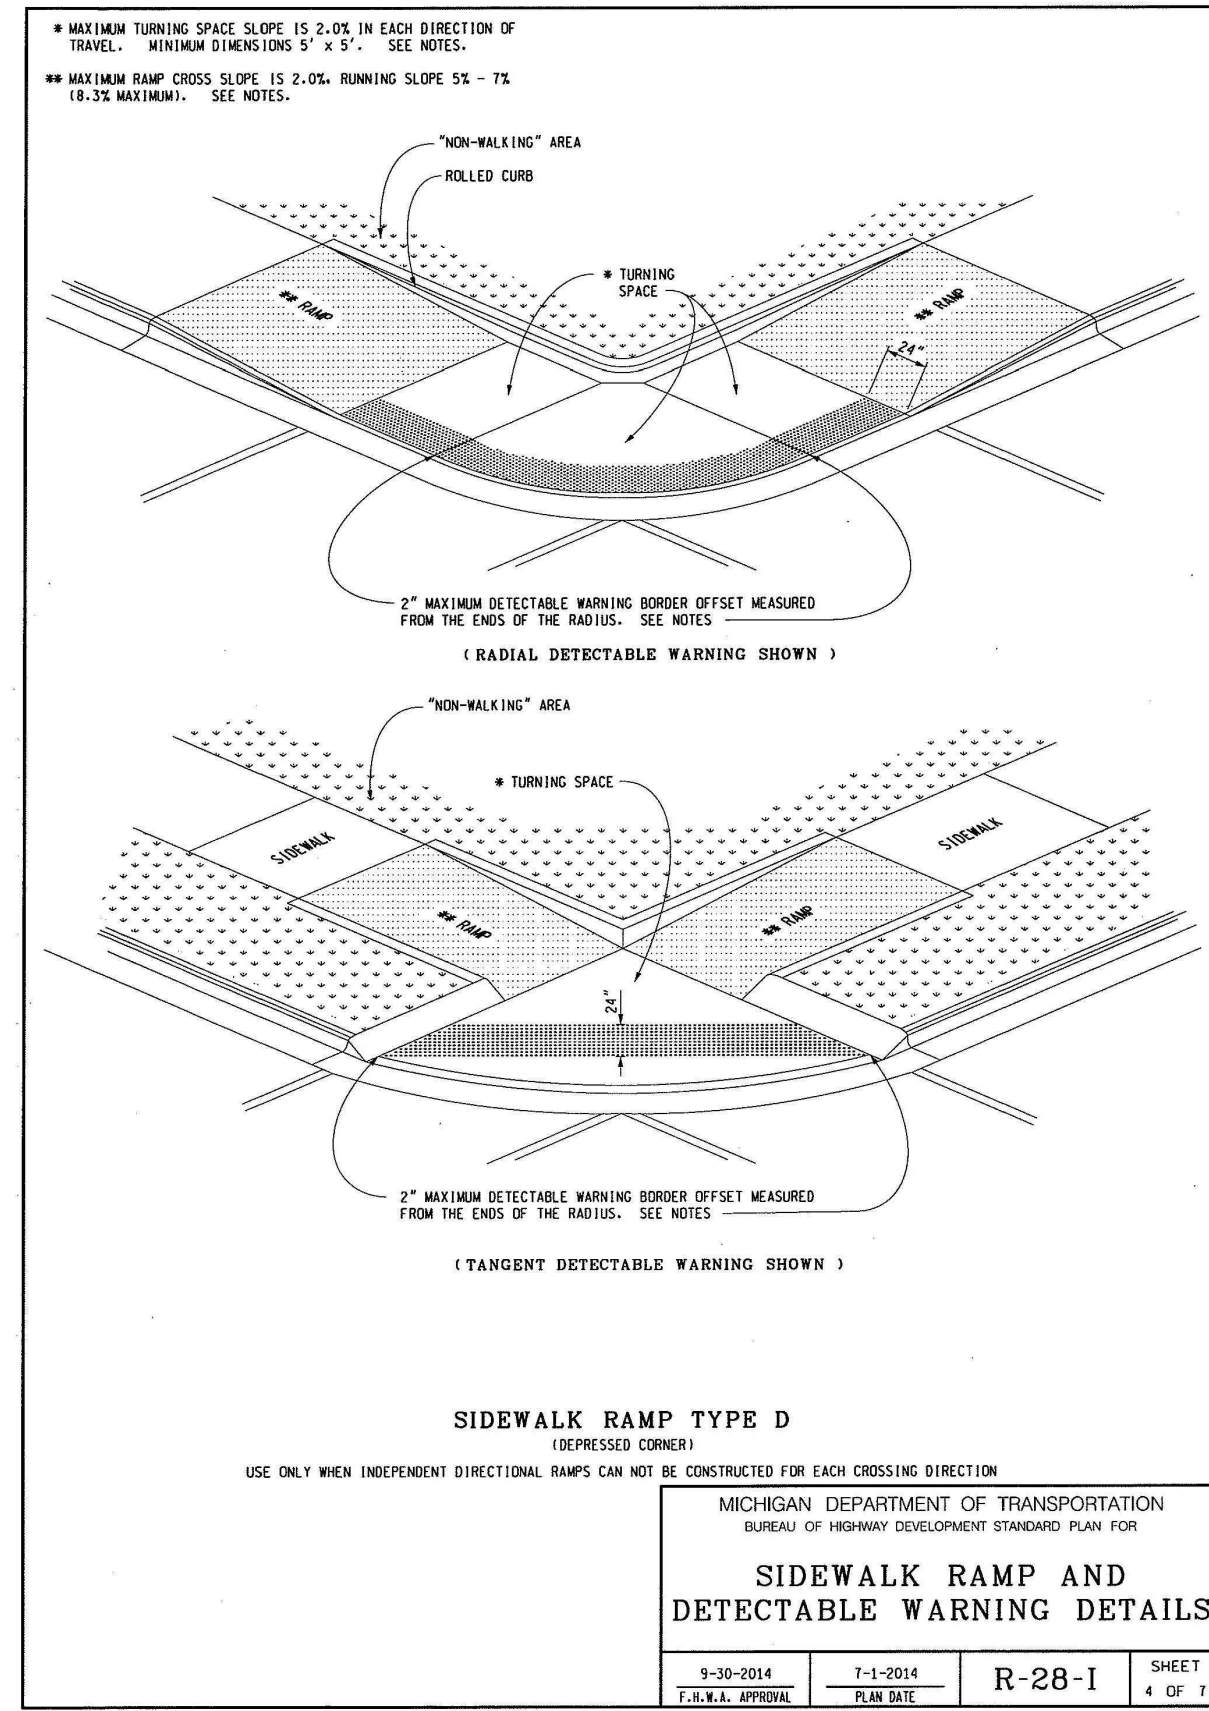
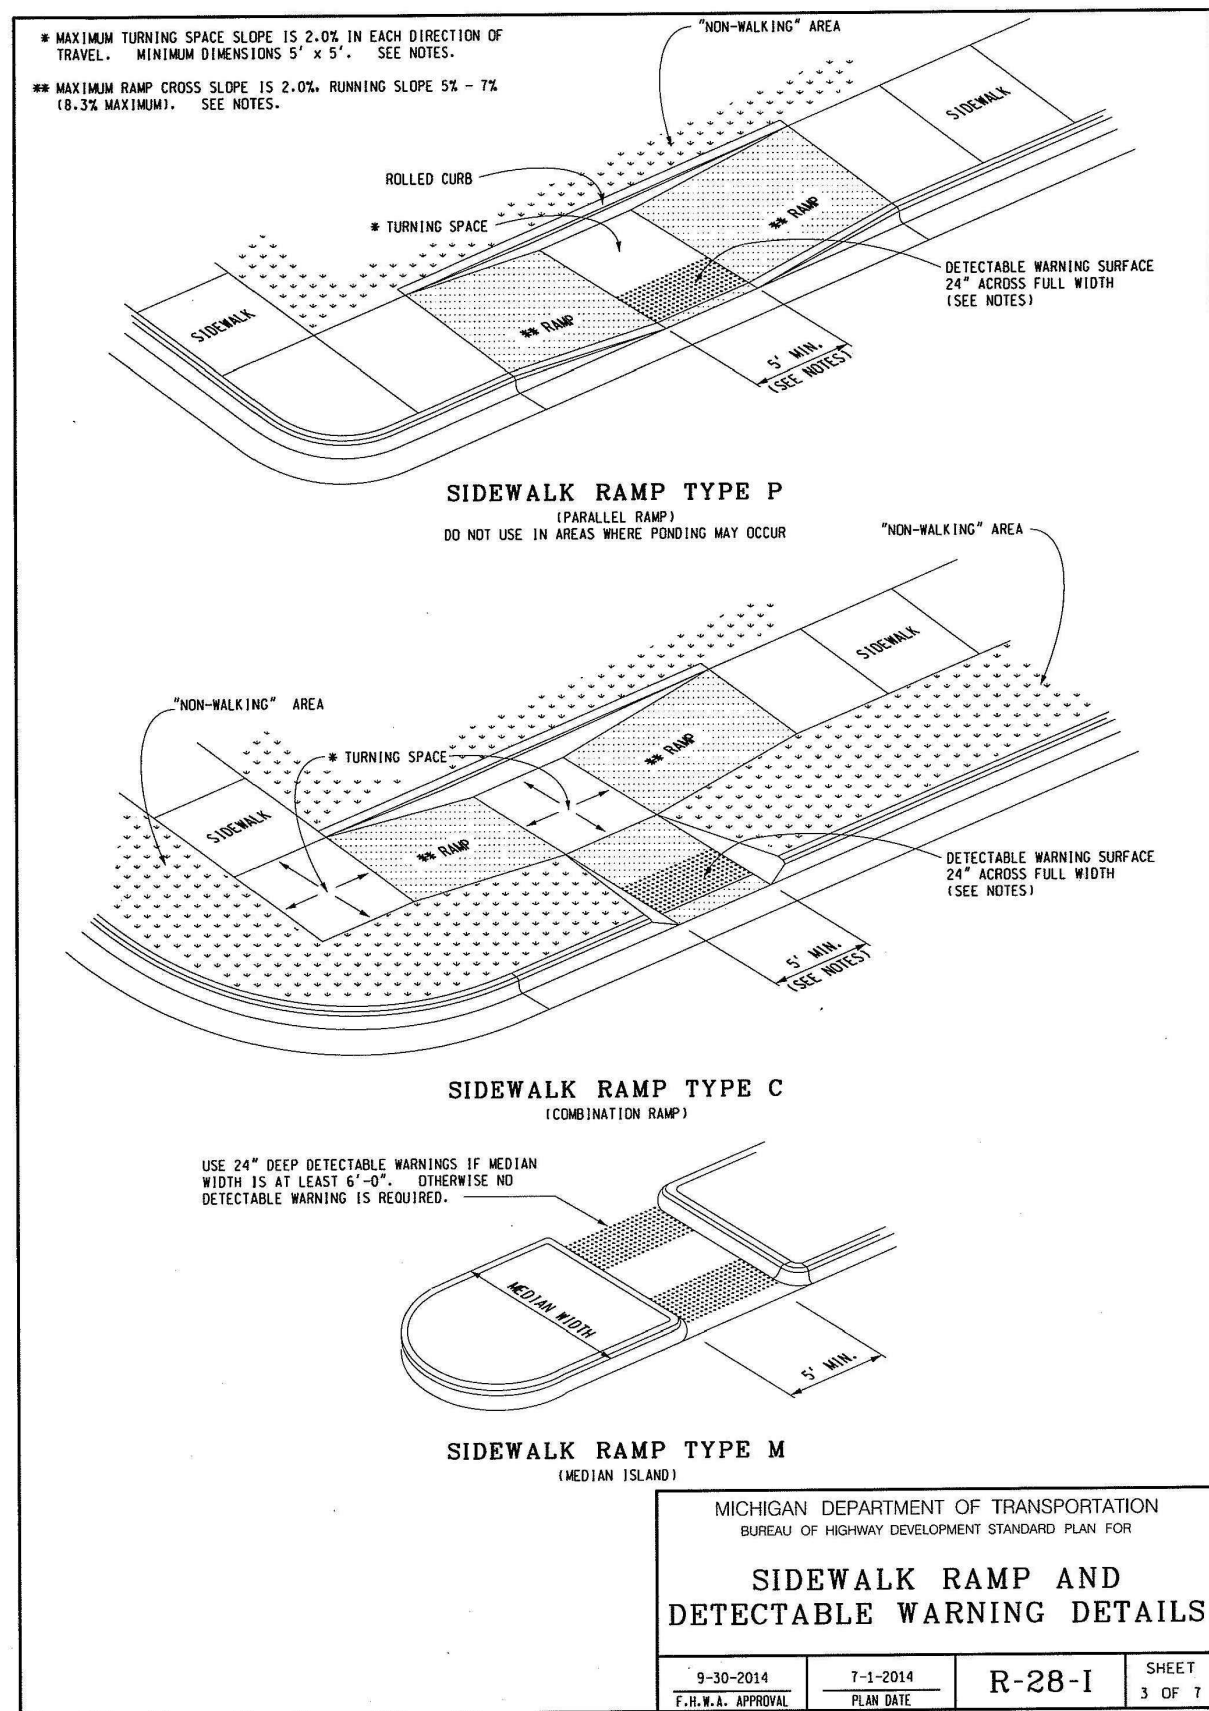
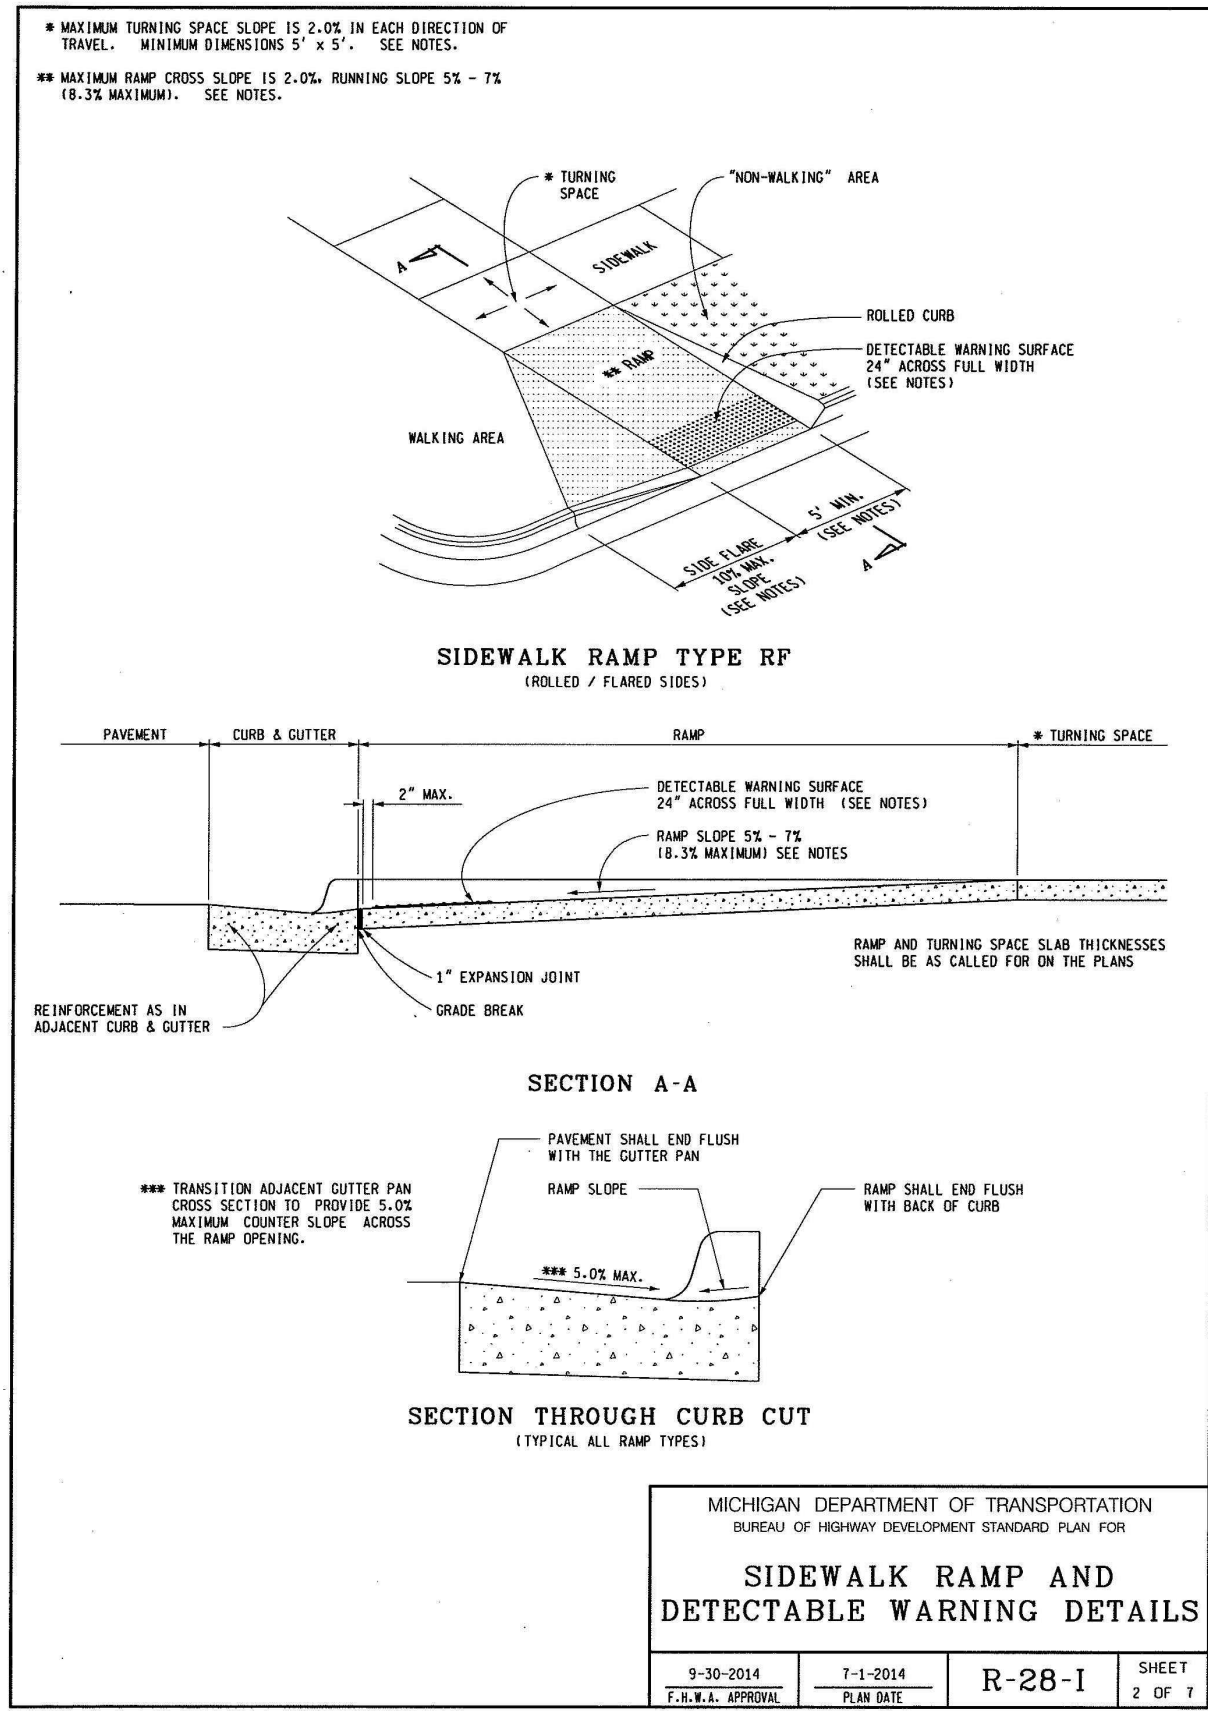
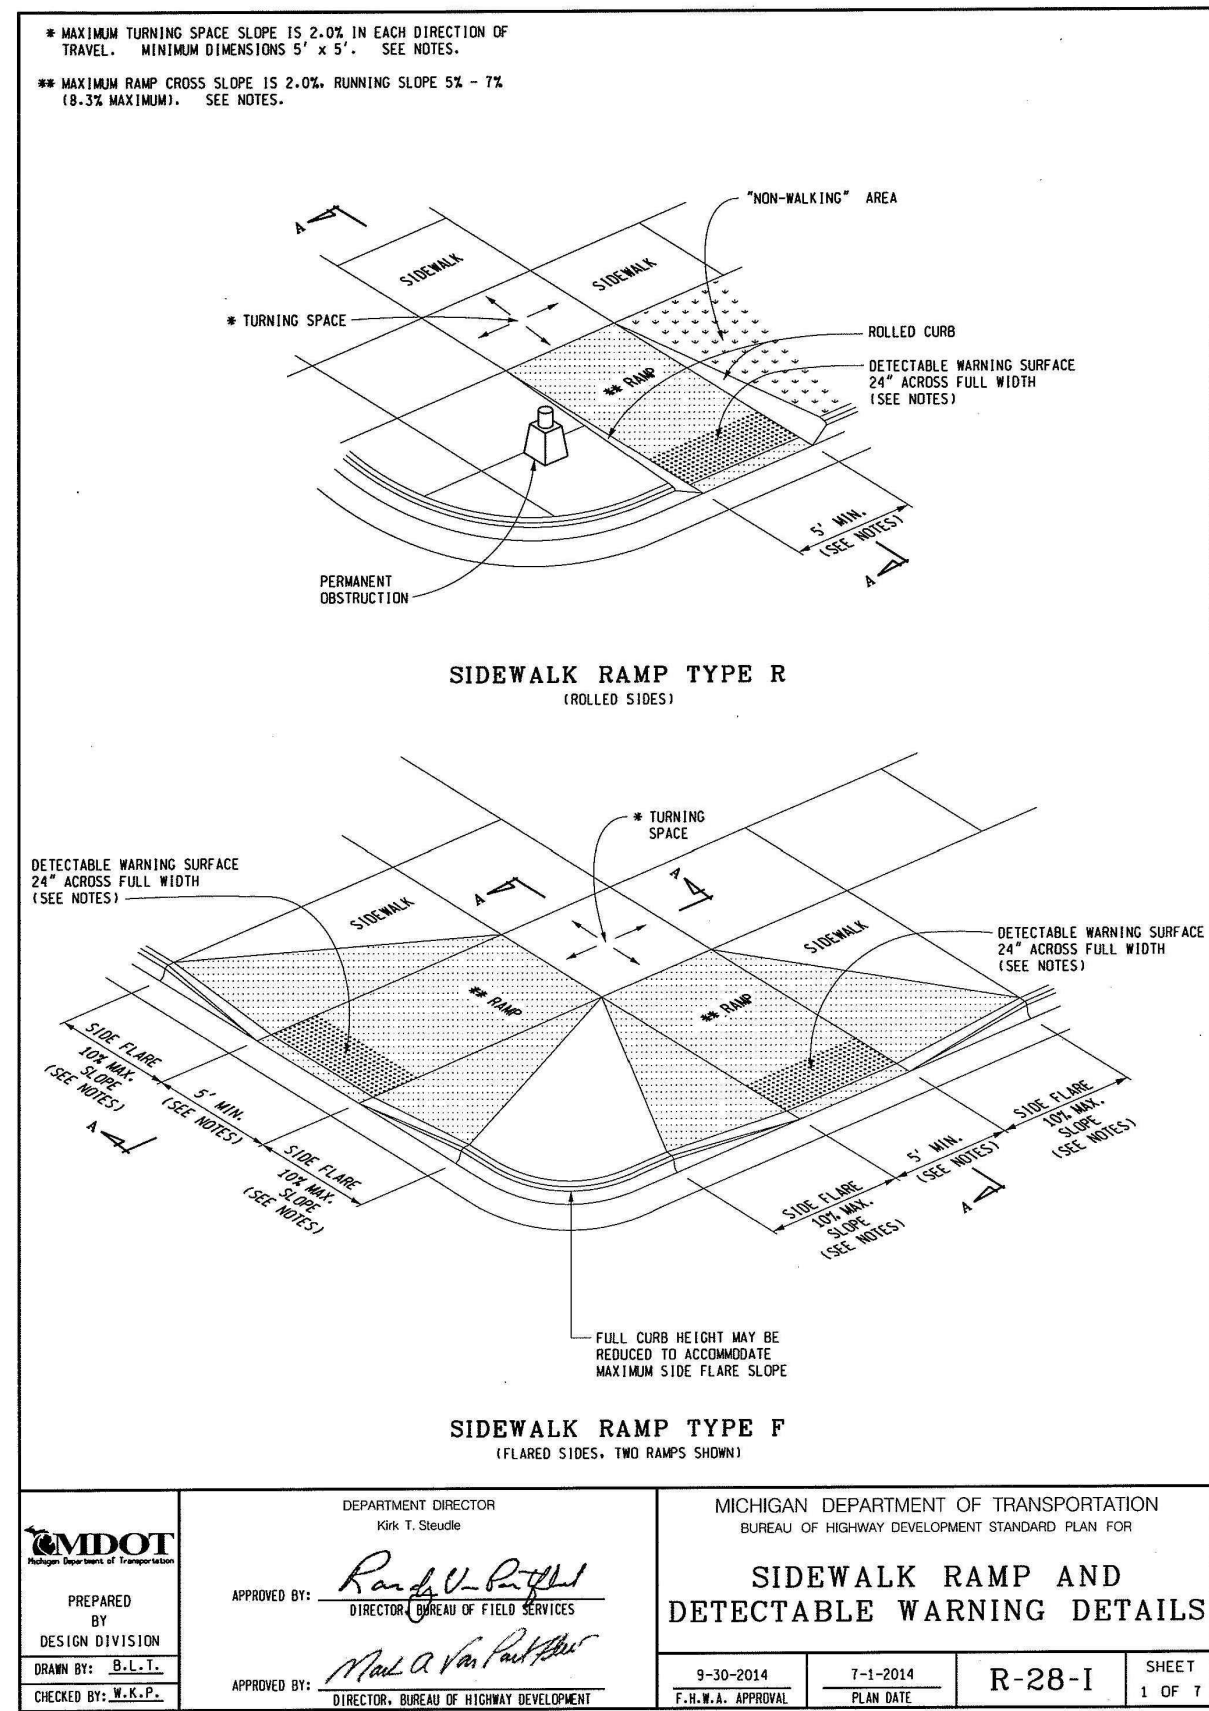


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**COLONY ESSEX MANCHESTER**  
**CONCRETE PAVEMENT REPAIR**  
SIDEWALK GRADES

REV.	DESCRIPTION	DATE	DRAWN	CHECKED

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PROJECT MANAGEMENT - PUBLIC SERVICES - CITY OF ANN ARBOR  
COLONY ESSEX MANCHESTER  
CONCRETE PAVEMENT REPAIR  
SIDEWALK STANDARD PLAN DETAILS

SCALE PLAN: #####  
DRAWING NO.: 2015024-27  
SHEET NO. 27 OF 27