WTP Lime Residual Removal Contract No. 1 - Site Modifications

Ann Arbor, Michigan

Issued for Bids & Construction Project Number 241760 RFP 25-15



2001 Commonwealth Blvd. Ann Arbor, Michigan

GENERAL

CIVIL

LIME RESIDUAL LAGOON SITE PLAN

C102 WATER TREATMENT PLANT SITE PLAN

WATER TREATMENT PLANT TEMPORARY DRIVEWAY & FORCE MAIN PLAN & PROFILE


LAGOON FORCE MAIN PLAN & PROFILE


SESC & STANDARD DETAILS

C502 STANDARD DETAILS MISC. DETAILS

REFERENCE

8 IN 2009 AS BUILT DRAWING SHEET 31 8 IN 2009 AS BUILT DRAWING SHEET 32

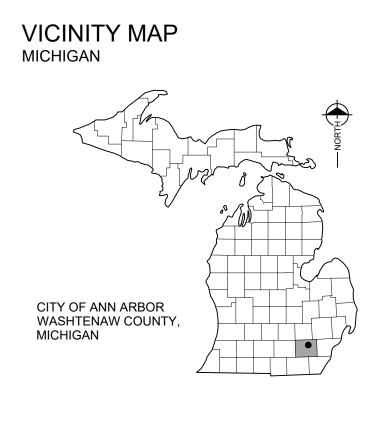

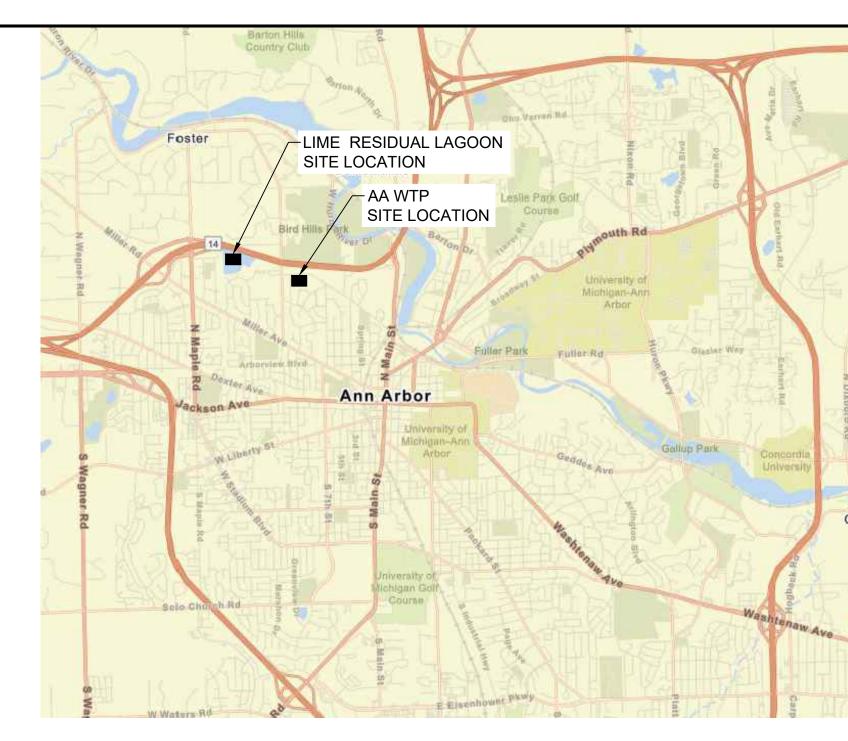



GRAPHIC SYMBOLS

ELEVATION, SECTION, AND DETAIL DESIGNATION


PLAN DESIGNATION

INTERIOR ELEVATION TAG/PHOTO TAG





EXTERIOR ELEVATION TAG NORTH ARROW DESIGNATION

ROOM NAME AND NUMBER

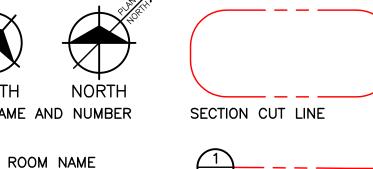


ENLARGED DETAIL FRAME

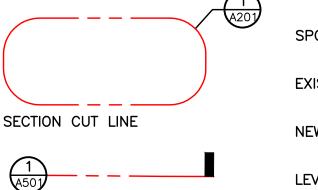

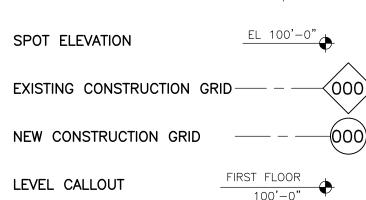

ELEVATION TARGET

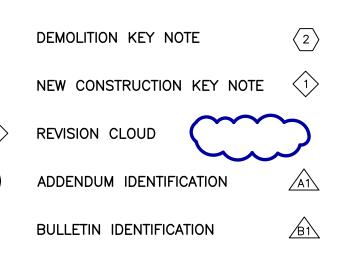

BUILDING CODE INFORMATION

SEAL

REVISIONS

3/4/2025 BIDS & CONSTRUCTION

Manager

Hard copy is intended to be 22"x34" when plotted. Scale(s) indicated and graphic quality may not be accurate for any other size

> PROJECT NO. 241760

SHEET NO.

©Copyright 2025

PROJECT SIGN DETAIL

1. CONSTRUCTION SIGN SHALL BE BAKED ENAMEL ALUMINUM SHEET LAMINATED ONTO 2 SIDES OF A TRUSS TYPE CORRUGATED

SHEET OF POLYMER CORE. 2. CONSTRUCTION SIGN SHALL BE STANDARD WHITE.


3. LETTERING SHALL BE DIE CUT VINYL (BLACK) LAMINATED ONTO THE PANEL. VINYL SHALL BE SUITABLE FOR EXTERIOR

4. PROVIDE (3) SIGNS, LOCATIONS TO BE DETERMINED IN FIELD.

5. SECURE WITH TWO (2) 4X4 SET INTO CONCRETE.
6. FINAL ARTWORK TO BE DETERMINED BY CITY.

SITE SYMBOL LEGEND

———— SILT FENCE

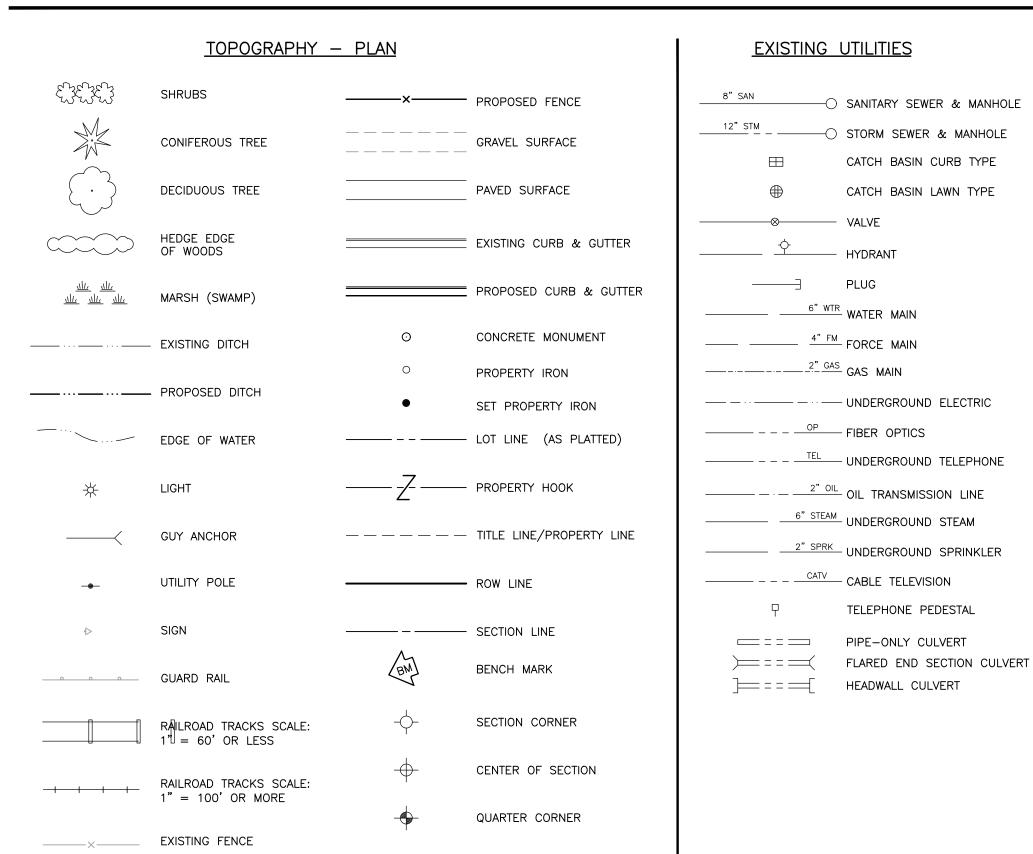


PROPOSED I	<u>UTILITIES</u>
	- SANITARY SEWER & MANHOLE
	- WYE & LEAD
	RISER & LEAD
o——	STANDARD SEWER CLEANOUT
832.56	MAX. ELEVATION OF LOT LEAD AT PROPERTY LINE
	STORM SEWER & MANHOLE
⊕ •	CATCH BASIN
	- UNDERDRAIN
8"_WTR	- WATER MAIN
_∞	- VALVE & BOX
	- VALVE & CHAMBER
М	METER
	PLUG
<u></u>	STANDARD FIRE HYDRANT ASSEMBLY
↓	- CURB STOP & BOX
6" FORCE MAIN (FM	I) FORCE MAIN
	- AIR RELEASE STRUCTURE
12" CSP 	PIPE-ONLY CULVERT
)=====================================	FLARED END SECTION CULVERT
도 <u>12" CSP</u>	HEADWALL CULVERT
1	

SEE SHEET C10

MH FOR 8" FM SEE SHEET R1-

MIDDLE

OVERALL SITE PLAN

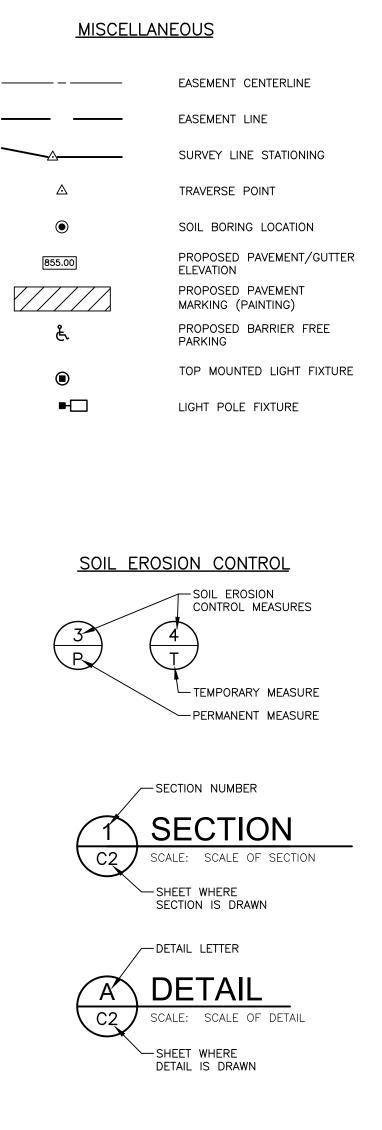

GENERAL NOTES

- THREE FULL WORKING DAYS PRIOR TO ANY EXCAVATION; THE CONTRACTOR SHALL CONTACT MISS DIG (1-800-482-7171) FOR LOCATION OF UNDERGROUND UTILITIES LOCATED IN THE VICINITY OF THE WORK. THE CONTRACTOR SHALL MAKE ANY NECESSARY ARRANGEMENTS WITH UTILITY COMPANIES FOR RELOCATION OF EXISTING UTILITIES, IF REQUIRED.
- UNDERGROUND UTILITIES AS SHOWN HEREON WERE TAKEN FROM EXISTING PLANS AND ARE APPROXIMATE LOCATIONS ONLY. UNDERGROUND UTILITY LOCATIONS HAVE NOT BEEN FIELD VERIFIED.
 UNLESS SPECIFICALLY NOTED FOR REMOVAL ON THE CONSTRUCTION PLANS, ALL SIDEWALK, DRIVES,
- CULVERTS, GUARDRAILS AND ABOVE GROUND UTILITIES DAMAGED OR DESTROYED DURING CONSTRUCTION SHALL BE REMOVED AND REPLACED, INCIDENTAL TO THE COST OF CONSTRUCTION, AT NO EXPENSE TO
- 4. EXISTING WATER MAINS, STORM SEWERS, SANITARY SEWERS, GAS MAINS AND UNDERGROUND TELEPHONE, ELECTRIC AND CABLE TELEVISION CONDUITS AND/OR LINES ARE SHOWN ONLY IN THE PLAN VIEW OF THE CONSTRUCTION DRAWINGS. THE EXACT DEPTH OF THESE UTILITIES IS NOT KNOWN AND THEREFORE, NO ATTEMPT HAS BEEN MADE TO SHOW SUCH UTILITIES IN THE PROFILE OF THE CONSTRUCTION DRAWINGS. THE CONTRACTOR SHALL BE RESPONSIBLE FOR PROTECTING THESE UTILITIES WHICH ARE NOT WITHIN THE SPACE OCCUPIED BY COMPLETED PIPES OR STRUCTURES THAT ARE A PART OF THIS CONTRACT. DURING CONSTRUCTION, IF DAMAGED OR DESTROYED DURING CONSTRUCTION, THE CONTRACTOR SHALL BE RESPONSIBLE FOR THE COSTS TO REPAIR OR REPLACE THEM AT NO ADDITIONAL EXPENSE TO THE OWNER.
- THE CONTRACTOR SHALL PROTECT EXISTING UTILITIES IN A MANNER ACCEPTABLE TO THE ENGINEER DURING THE PROPOSED CONSTRUCTION. ANY UTILITY, WHICH IS TO REMAIN IN SERVICE, THAT IS DAMAGED OR DESTROYED DURING CONSTRUCTION SHALL BE REPLACED BY THE CONTRACTOR AT NO
- ADDITIONAL EXPENSE TO THE OWNER.

 PRIOR TO CONSTRUCTION, THE CONTRACTOR SHALL EXPOSE EXISTING UTILITIES AT POINTS OF POSSIBLE CONFLICT SO THAT THESE CONFLICTS CAN BE RESOLVED.

 PROTECT TREES IN ACCORDANCE WITH ANN ARBOR PUBLIC SERVICES DEPARTMENT STANDARD SPECIFICATIONS, DIVISION I GENERAL SPECIFICATIONS "PROTECTION OF TREES" AND STANDARD DETAIL
- 8. ACCESS TO THE FORCE MAIN AIR RELEASE VALVE LOCATED WITHIN THE SCHOOL PARKING AREA SHALL
- ONLY BE ACCESSED WITH ADVANCE APPROVAL. REQUESTS SHALL BE MADE A MINIMUM OF 3 DAYS IN ADVANCE. ALL OTHER CONTRACTOR ACCESS TO THE ANN ARBOR PUBLIC SCHOOL PROPERTY IS
- 9. CONTRACTOR SHALL BE RESPONSIBLE FOR COORDINATING THEIR WORK WITH ALL OTHER UTILITIES THAT MAY HAVE EQUIPMENT OR INSTALLATIONS ON SITE.

SESC NOTES

- CONTRACTOR IS RESPONSIBLE FOR APPLYING AND PAYING FOR THE SESC PERMIT. CONTRACTOR MAY USE THE EXISTING SITE PLAN AS A BASE AND IS RESPONSIBLE FOR ADDING OR MODIFYING TO SUIT THE NEEDS OF THEIR OPERATION.
- CONTRACTOR SHALL INSTALL SILT FENCING ALONG THE DOWN SLOPE SIDE OF ALL EXCAVATIONS. CONTRACTOR RESPONSIBLE FOR INSTALLATION AND MAINTENANCE OF ALL TEMPORARY AND PERMANENT SOIL EROSION AND SEDIMENTATION CONTROL (SESC) MEASURES DURING CONSTRUCTION. CONTRACTOR SHALL MAINTAIN AND KEEP IN PLACE SESC MEASURES UP TO PROJECT COMPLETION FOR USE UNDER CONTRACT NO. 2. CONTRACTOR RESPONSIBLE FOR OBTAINING, EXERCISING AND PERFORMING ALL WORK IN ACCORDANCE WITH THE CONDITIONS PROVIDED BY THE ISSUER OF THE SOIL EROSION AND SEDIMENTATION CONTROL PERMIT.
- 4. ALL TEMPORARY SEDIMENT CONTROL MEASURES ARE TO BE INSTALLED AND VERIFIED BY ENGINEER PRIOR TO EARTH DISTURBANCE ACTIVITY AND CHECKED DAILY FOR EFFECTIVENESS AND REPAIRED AS

TRAFFIC NOTES

CONTRACTOR RESPONSIBLE FOR ANY TRAFFIC CONTROL REQUIRED TO COMPLETE THE WORK IN A SAFE AND EFFICIENT MANNER. WORK INCLUDES IDENTIFYING, APPLYING FOR AND OBTAINING ROW PERMITS AND APPROVAL FOR ALL TEMPORARY LANE CLOSURES OR PARKING SPACE RESTRICTIONS THROUGH THE CITY

MEANING

2. CONSTRUCTION TRAFFIC TO THE WATER TREATMENT PLANT IS EXPECTED TO UTILIZE MILLER AVE TO NEWPORT RD TO SUNSET RD. CONTRACTOR MUST SUBMIT FOR APPROVAL ANY ALTERNATIVE ACCESS

SITE PLAN ABBREVIATIONS

MEANING

ABBREV.

ADANI	ADANDON	FO! F	MICHICAN DEPARTMENT OF MATURAL RECOUR
ABAN.	ABANDON ADJACENT	EGLE MDOT	MICHIGAN DEPARTMENT OF NATURAL RESOUR
ADJ.	ADJACENT		
AGG.	AGGREGATE	MDPH	MICHIGAN DEPARTMENT OF PUBLIC HEALTH
ALT.	ALTERNATE	MFGR	MANUFACTURER
APPD.	APPROVED	MGD	MILLION GALLONS PER DAY
ADDDOV	APPROXIMATE	MH.	
		MH.	MANHOLE
B/B	BACK TO BACK	MIN.	
BIT.	BITUMINOUS	MISC.	MISCELLANEOUS
BLDG. BLVD.	PLIII DINC	MJ	
DLDG.	BUILDING	MIJ	MECHANICAL JOINT MONUMENT
BLVD.	BOULEVARD	MON.	
ВМ	BENCH MARK	NA	NOT APPLICABLE
BNDY.	BOLINDARY	NIC	NOT IN CONTRACT
DINDI.	DOTTOM	NDOD	NON-REINFORCED CONCRETE PIPE
BOT.	BOTTOM	NRCP	NON-REINFORCED CONCRETE PIPE
BSMT.	BASEMENT	NTS	NOT TO SCALE
C & G	CURB AND GUTTER	OC	ON CENTER
C/C	CENTER TO CENTER	OD	OUTSIDE DIAMETER
0,0	CARLE TELEVISION	00	
CATV	BITUMINOUS BUILDING BOULEVARD BENCH MARK BOUNDARY BOTTOM BASEMENT CURB AND GUTTER CENTER TO CENTER CABLE TELEVISION CATCH BASIN CUBIC FEET	OE OP	OVERHEAD ELECTRIC
CB	CATCH BASIN	OP	FIBER OPTICS
CF	CUBIC FEFT	ORIG.	ORIGINAL
CFS	CUBIC FEET DED SECOND	OT.	OVERHEAD TELEPHONE
013	CODIC FEET PER SECOND	01	OVERHEAD TELEPHONE
CL	CENTERLINE	PC	POINT OF CURVE
CMP	CUBIC FEET PER SECOND CENTERLINE CORRUGATED METAL PIPE	PC PCC	POINT OF CURVE POINT OF COMPOUND CURVATURE
CO	CLEAN OUT	PF	POLYETHYLENE
CONC.	CONCRETE	PE PERF.	POLYETHYLENE PIPE PERFORATED
CONST.	CONSTRUCTION	PERF.	PERFORATED
COORD.	COORDINATE	PI	PERFORATED POINT OF INTERSECTION
CP	COPPER PIPE	PI\/	POST INDICATOR VALVE
CSP	CORRUGATED STEEL PIPE		PROPERTY LINE
CSPA	CORRUGATED STEEL PIPE ARCH	POB POE	POINT OF BEGINNING POINT OF ENDING
CULV.	CULVERT	POF	POINT OF ENDING
CY	CUBIC YARD	DDC	POINT OF REVERSE CURVE
	CODIC TAND		
DEG (*)	DEGREE		PROPOSED
DEMO.	DEMOLISH	PSF	POUNDS PER SQUARE FOOT POUNDS PER SQUARE INCH
DIP	DUCTILE IRON	PSI	POLINDS PER SOLIARE INCH
		PT	
DIA.	DIAMETER		POINT OF TANGENCY
DIM.	DIMENSION	PVC	POLYVINYL CHLORIDE
DIST.	DISTANCE	PVC PVI	POINT OF VERTICAL CURVE
EL.	ELEVATION	D\/I	POINT OF VERTICAL INTERSECTION
ENGR.			
	ENGINEER	PVMT.	PAVEMENT
EOM	EDGE OF METAL	PVT	POINT OF VERTICAL TANGENCY
EQUIP.	EQUIPMENT	QTY.	QUANTITY
ESMT.	EASEMENT	R.	RADIUS
EXIST. EX.	EXISTING	RCP	REINFORCED CONCRETE PIPE
EXT.	EXTERIOR	RED.	REDUCER
F/F	FACE TO FACE	REF.	REFERENCE
FDN.	FOUNDATION	REQD.	REQUIRED
FIG.	FIGURE	REV.	REVISION
FF	FINISH FLOOR	RJ	RESTRAINED JOINT
FIN. GR.	FINISH GRADE	ROW	RIGHT OF WAY
FM	FORCE MAIN	SAN	SANITARY SEWER
FTG.	FOOTING	SF	SQUARE FOOT
GEN.	GENERATOR	SPEC.	SPECIFICATION
GND.	GROUND	SS	SIDE SLOPE
GPD	GALLONS PER DAY	STA.	STATION
GPM	GALLONS PER MINUTE	STD.	STANDARD
HDPE	HIGH DENSITY POLYETHYLENE	STL.	STEEL
HDWL.	HEADWALL	STM	STORM SEWER
Н.	HEIGHT	SYD	SQUARE YARD
HORIZ.	HORIZONTAL	TC	TOP OF CURB
HP	HIGH POINT	TAN.	TANGENT
HWL	HIGH WATER LEVEL	TEMP.	TEMPORARY
HWY.	HIGHWAY	TOC	TOP OF CASTING
HYD.	HYDRANT	T/W	TOP OF WALL
ID	INSIDE DIAMETER	TRPT	TRAVERSE POINT
		TYP.	
INV	INVERT ELEVATION		TYPICAL
INCL.	INCLUDE	UD	UNDER DRAIN
LA	LANDING AREA (SIDEWALK)	UTIL.	UTILITY
LAT.	LATERAL	VB	VALVE BOX
LF	LINEAL FEET	VCP	VITRIFIED CLAY PIPE
L.	LENGTH	VERT.	VERTICAL
LP	LOW POINT	W/	WITH
LS	LUMP SUM	W/O	WITHOUT
LWL	LOW WATER LEVEL	WL	WATER LEVEL
	MORE OR LESS	WTR	WATER MAIN
M /I			777 N 1 1 N 1 N 1 N 1 N
M/L MAINT.	MAINTENANCE		

Removal sidual

REVISIONS

Drawn By jreyes Designer jsiwek


3/4/2025 BIDS & CONSTRUCTION


Reviewer krostrowski Manager jsiwek

Hard copy is intended to be 22"x34" when plotted. Scale(s) indicated and graphic quality may not be accurate for any other size.

> PROJECT NO. 241760

SHEET NO.

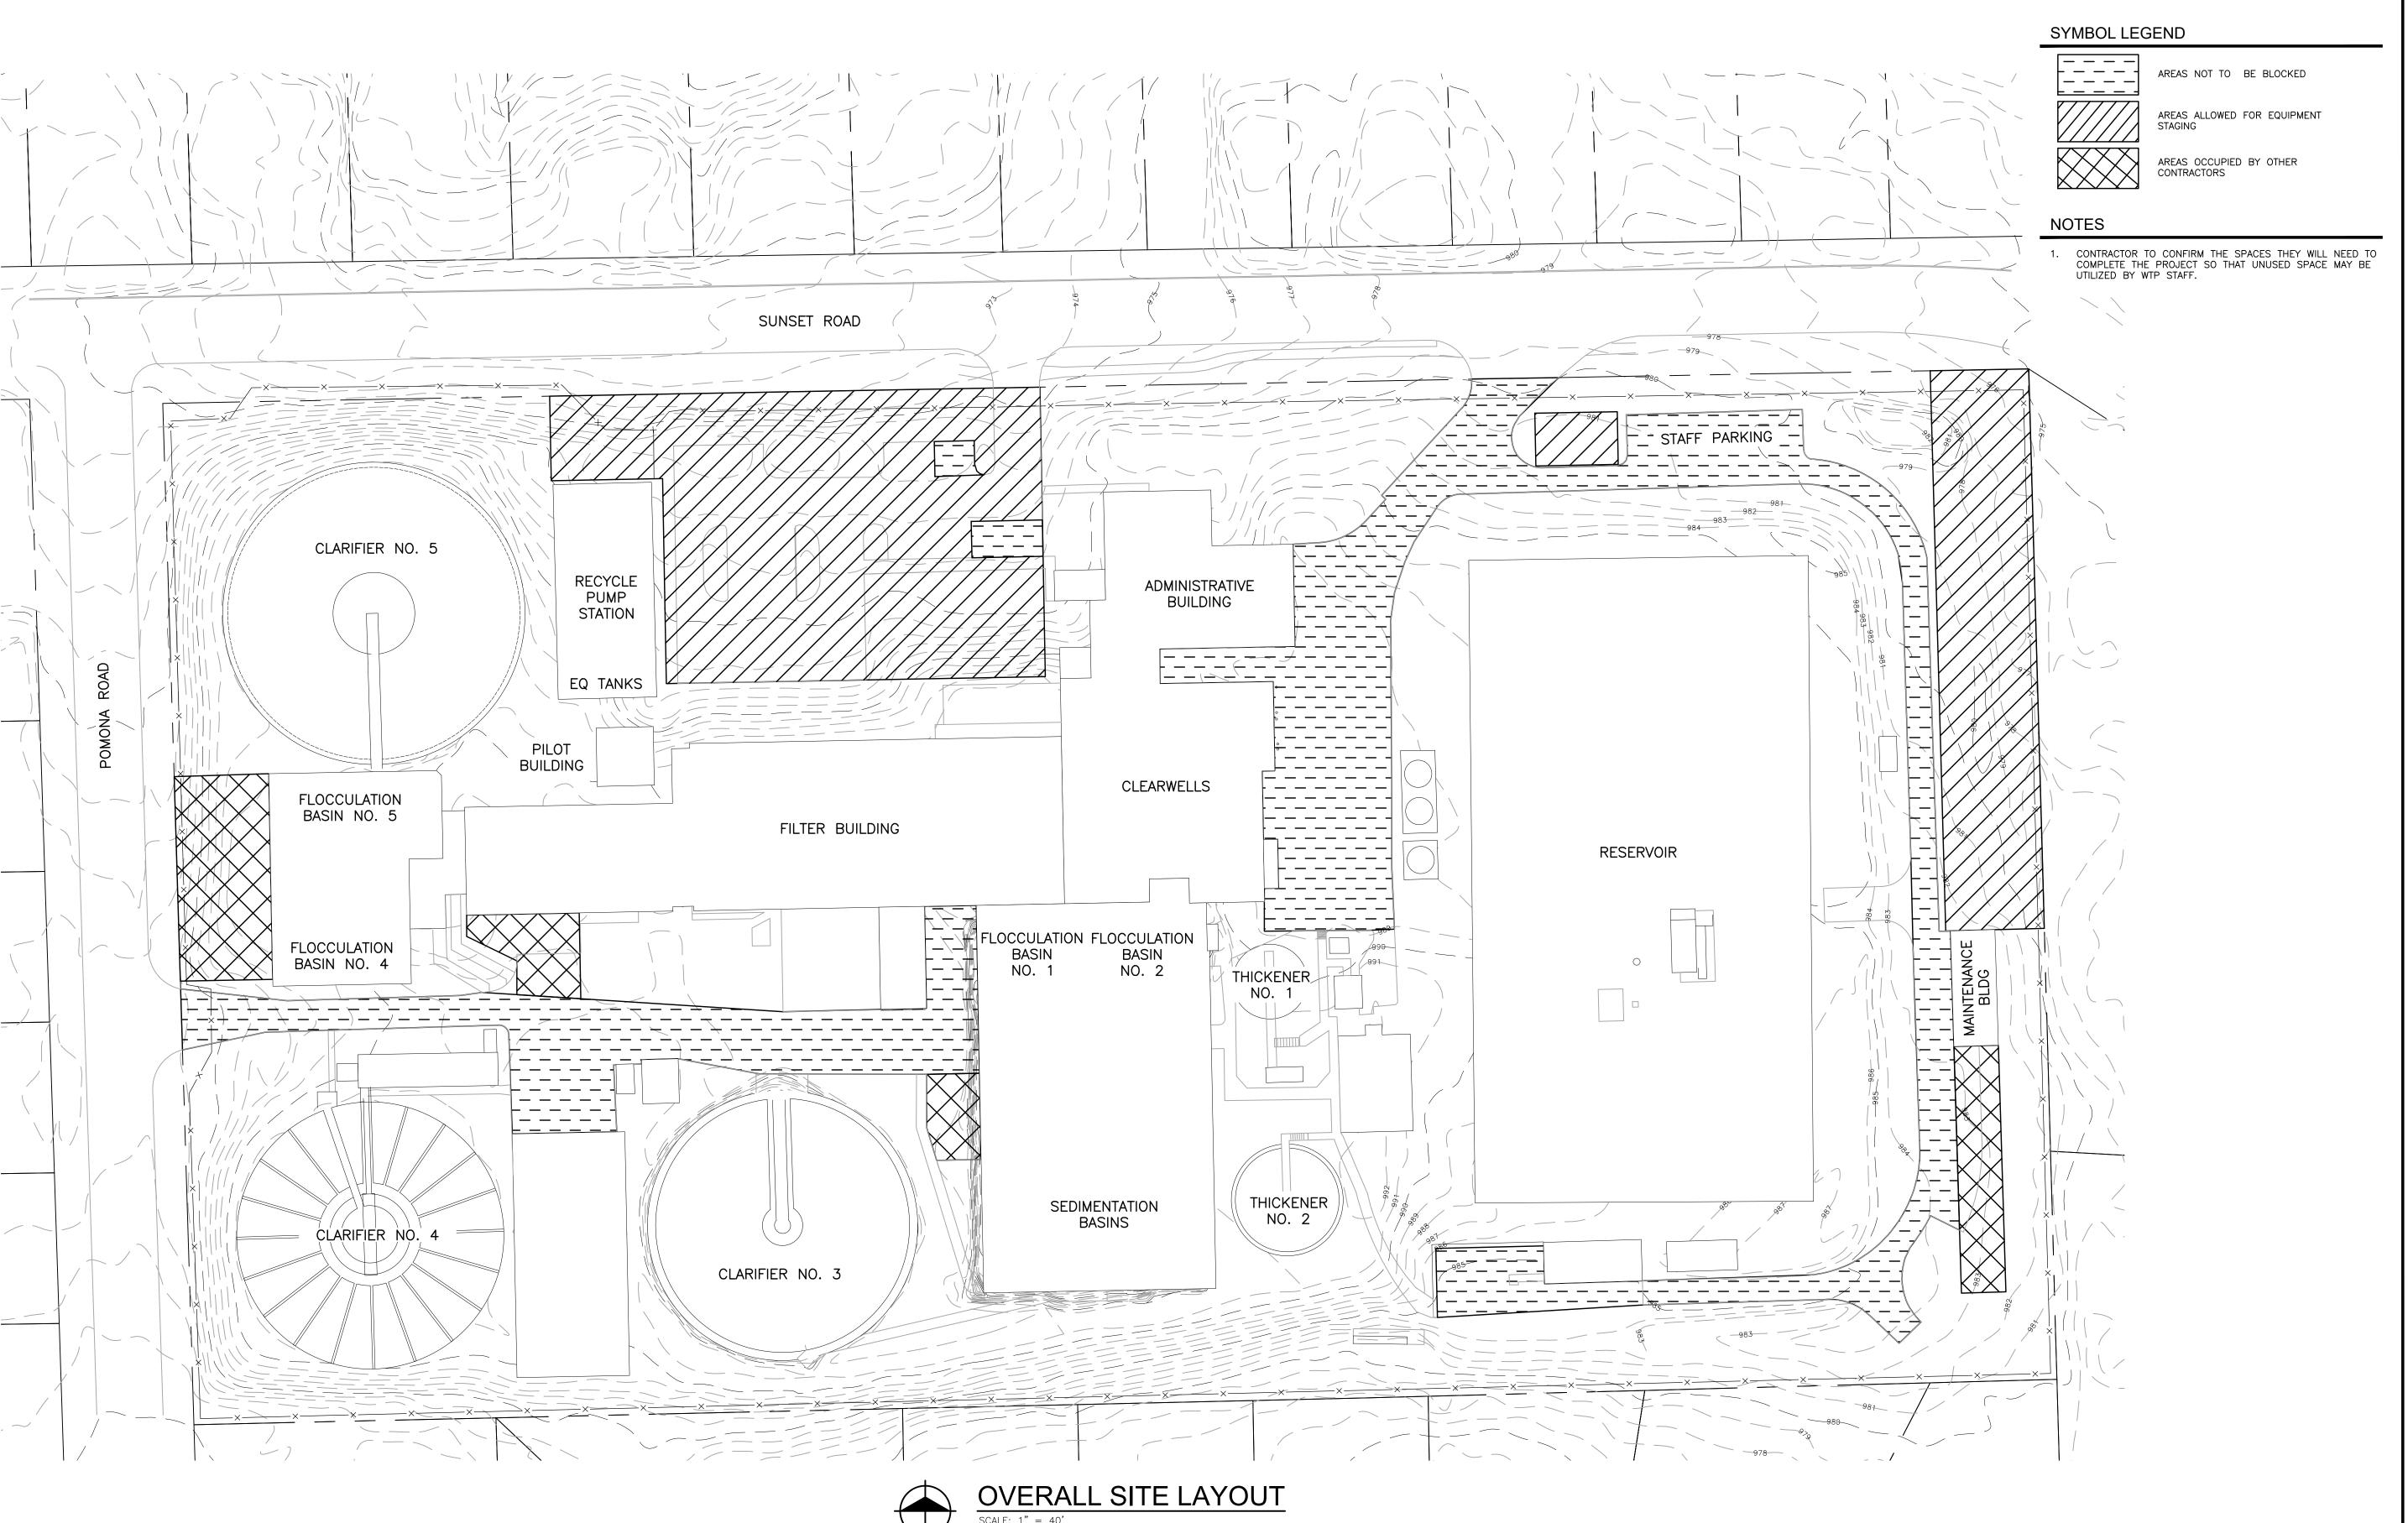

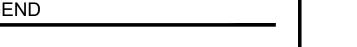

of City Residual Removal - Site Modifications

WTP Lime Contract 1 -

REVISIONS

3/4/2025 BIDS & CONSTRUCTION Drawn By

Manager

Hard copy is intended to be 22"x34" when plotted. Scale(s) indicated and graphic quality may not be accurate for any other size.

> PROJECT NO. 241760

> > SHEET NO.

G102

NOTES

- 1. ALL LOCATIONS AND DIMENSIONS OF EXISTING FEATURES SHOWN ON THE DRAWINGS ARE APPROXIMATE. FIELD VERIFY SITE CONDITIONS AND EXISTING FEATURES PRIOR TO COMMENCING WORK
- 2. PROTECT TREES AND UTILITY POLES NOT NOTED OR APPROVED FOR REMOVAL IN ACCORDANCE WITH ANN ARBOR PUBLIC SERVICES DEPARTMENT STANDARD SPECIFICATIONS, DIVISION 1 GENERAL SPECIFICATIONS "PROTECTION OF TREES" AND STANDARD. SEE SHEET C501. CONTRACTOR TO COORDINATE WITH OWNER AND ENGINEER IF ANY TREES NEED TO BE REMOVED.
- 3. CONTRACTOR TO PRESSURE TEST THE EXISTING FORCE MAIN AFTER COMPLETION OF PIPE MODIFICATIONS IN ACCORDANCE WITH THE SPECIFICATIONS.
- 4. CONTRACTOR TO FLUSH AND PIG THE EXISTING FORCE MAIN AFTER COMPLETION OF PIPE PRESSURE TESTING. CONTRACTOR SHALL UTILIZE THE EXISTING STORMWATER BASIN FOR COLLECTING WATER FROM FLUSHING. THE PIG AND ALL DEBRIS FLUSHED FROM THE LINE SHALL BE CLEANED FROM THE BASIN UPON COMPLETION. CONTRACTOR SHALL INSERT A TEMPORARY PLUG IN THE DOWNSTREAM STORM SEWER UPSTREAM OF THE METERING MANHOLE TO ENSURE THAT NO WATER FROM CONSTRUCTION OPERATIONS LEAVE THE SITE. THE PLUG MUST BE REMOVED AFTER FLUSHING IS COMPLETE.
- 5. CONTRACTOR RESPONSIBLE FOR ALL SITE SECURITY AT THE LAGOON SITE DURING CONSTRUCTION. THE ACCESS GATE SHOULD REMAIN LOCKED AT ALL TIMES WHEN NOT BEING ACTIVELY UTILIZED. CONTRACTOR TO COORDINATE WITH CITY AND "DAISY CHAIN" THEIR LOCK WITH CITY'S LOCK FOR ACCESS DURING CONSTRUCTION.
- 6. CONTRACTOR SHALL PERFORM STREET SWEEPING IN HATCHER CRESCENT AND SAUNDERS CRESCENT AS NEEDED DURING THE PROJECT.
- 7. CONTRACTOR SHALL RESTORE THE SITE ONCE ALL PIPE MODIFICATIONS AND TESTING / FLUSHING IS COMPLETE.
- 8. PROVIDE 8 CU YD. MDOT PLAIN RIP RAP TO BE FIELD LOCATED TO PROTECT BASIN SLOPE FROM EROSION DURING PIGGING AND FLUSHING OPERATIONS.

SYMBOL LEGEND

EXISTING MAJOR CONTOUR

724

EXISTING MINOR CONTOUR

SILT FENCE

TURBIDITY CURTAIN

GRAVEL PAVEMENT

TEMPORARY EASEMENT

EGLE SOIL EROSION AND SEDIMENTATION CONTROL MEASURES

KEY	DETAIL	CHARACTERISTICS								
1	Turbidity Curtain	Within a stream or drain parallel to flow when a slack water area is necessary to isolate earth change activities from a lake or channel.								
7	Riprap, Rubble, Gabions	Used where vegetation is not easily established. Effective for high velocities or high concentrations. Permits runoff to infiltrate soil. Dissipates energy flow at system outlets.								
14	Gravel Access Approach	Used at every point where construction traffic enters or leaves a construction site.								
26	Geotextile Silt Fence	Use geotextile and posts or poles. May be constructed or prepackaged. Easy to construct and locate as necessary.								
29	Catch Basin, Drain Inlet	Collects high velocity concentrated runoff. May use filter cloth over inlet.								

XX TEMPORARY T MEASURE P PERMANENT MEASURE

CONTRACTOR TO LEAVE SESC BMP'S IN PLACE FOR USE IN CONTRACT NO. 2.

REVISIONS

Residual Removal Site Modifications

WTP

3/4/2025 BIDS & CONSTRUCTION

n By jreyes gner jsiwek

ewer krostrowski ager jsiwek


Hard copy is intended to be 22"x34" when plotted. Scale(s) indicated and graphic quality may not be accurate for any other size.

PROJECT NO.

241760

SHEET NO.

C101

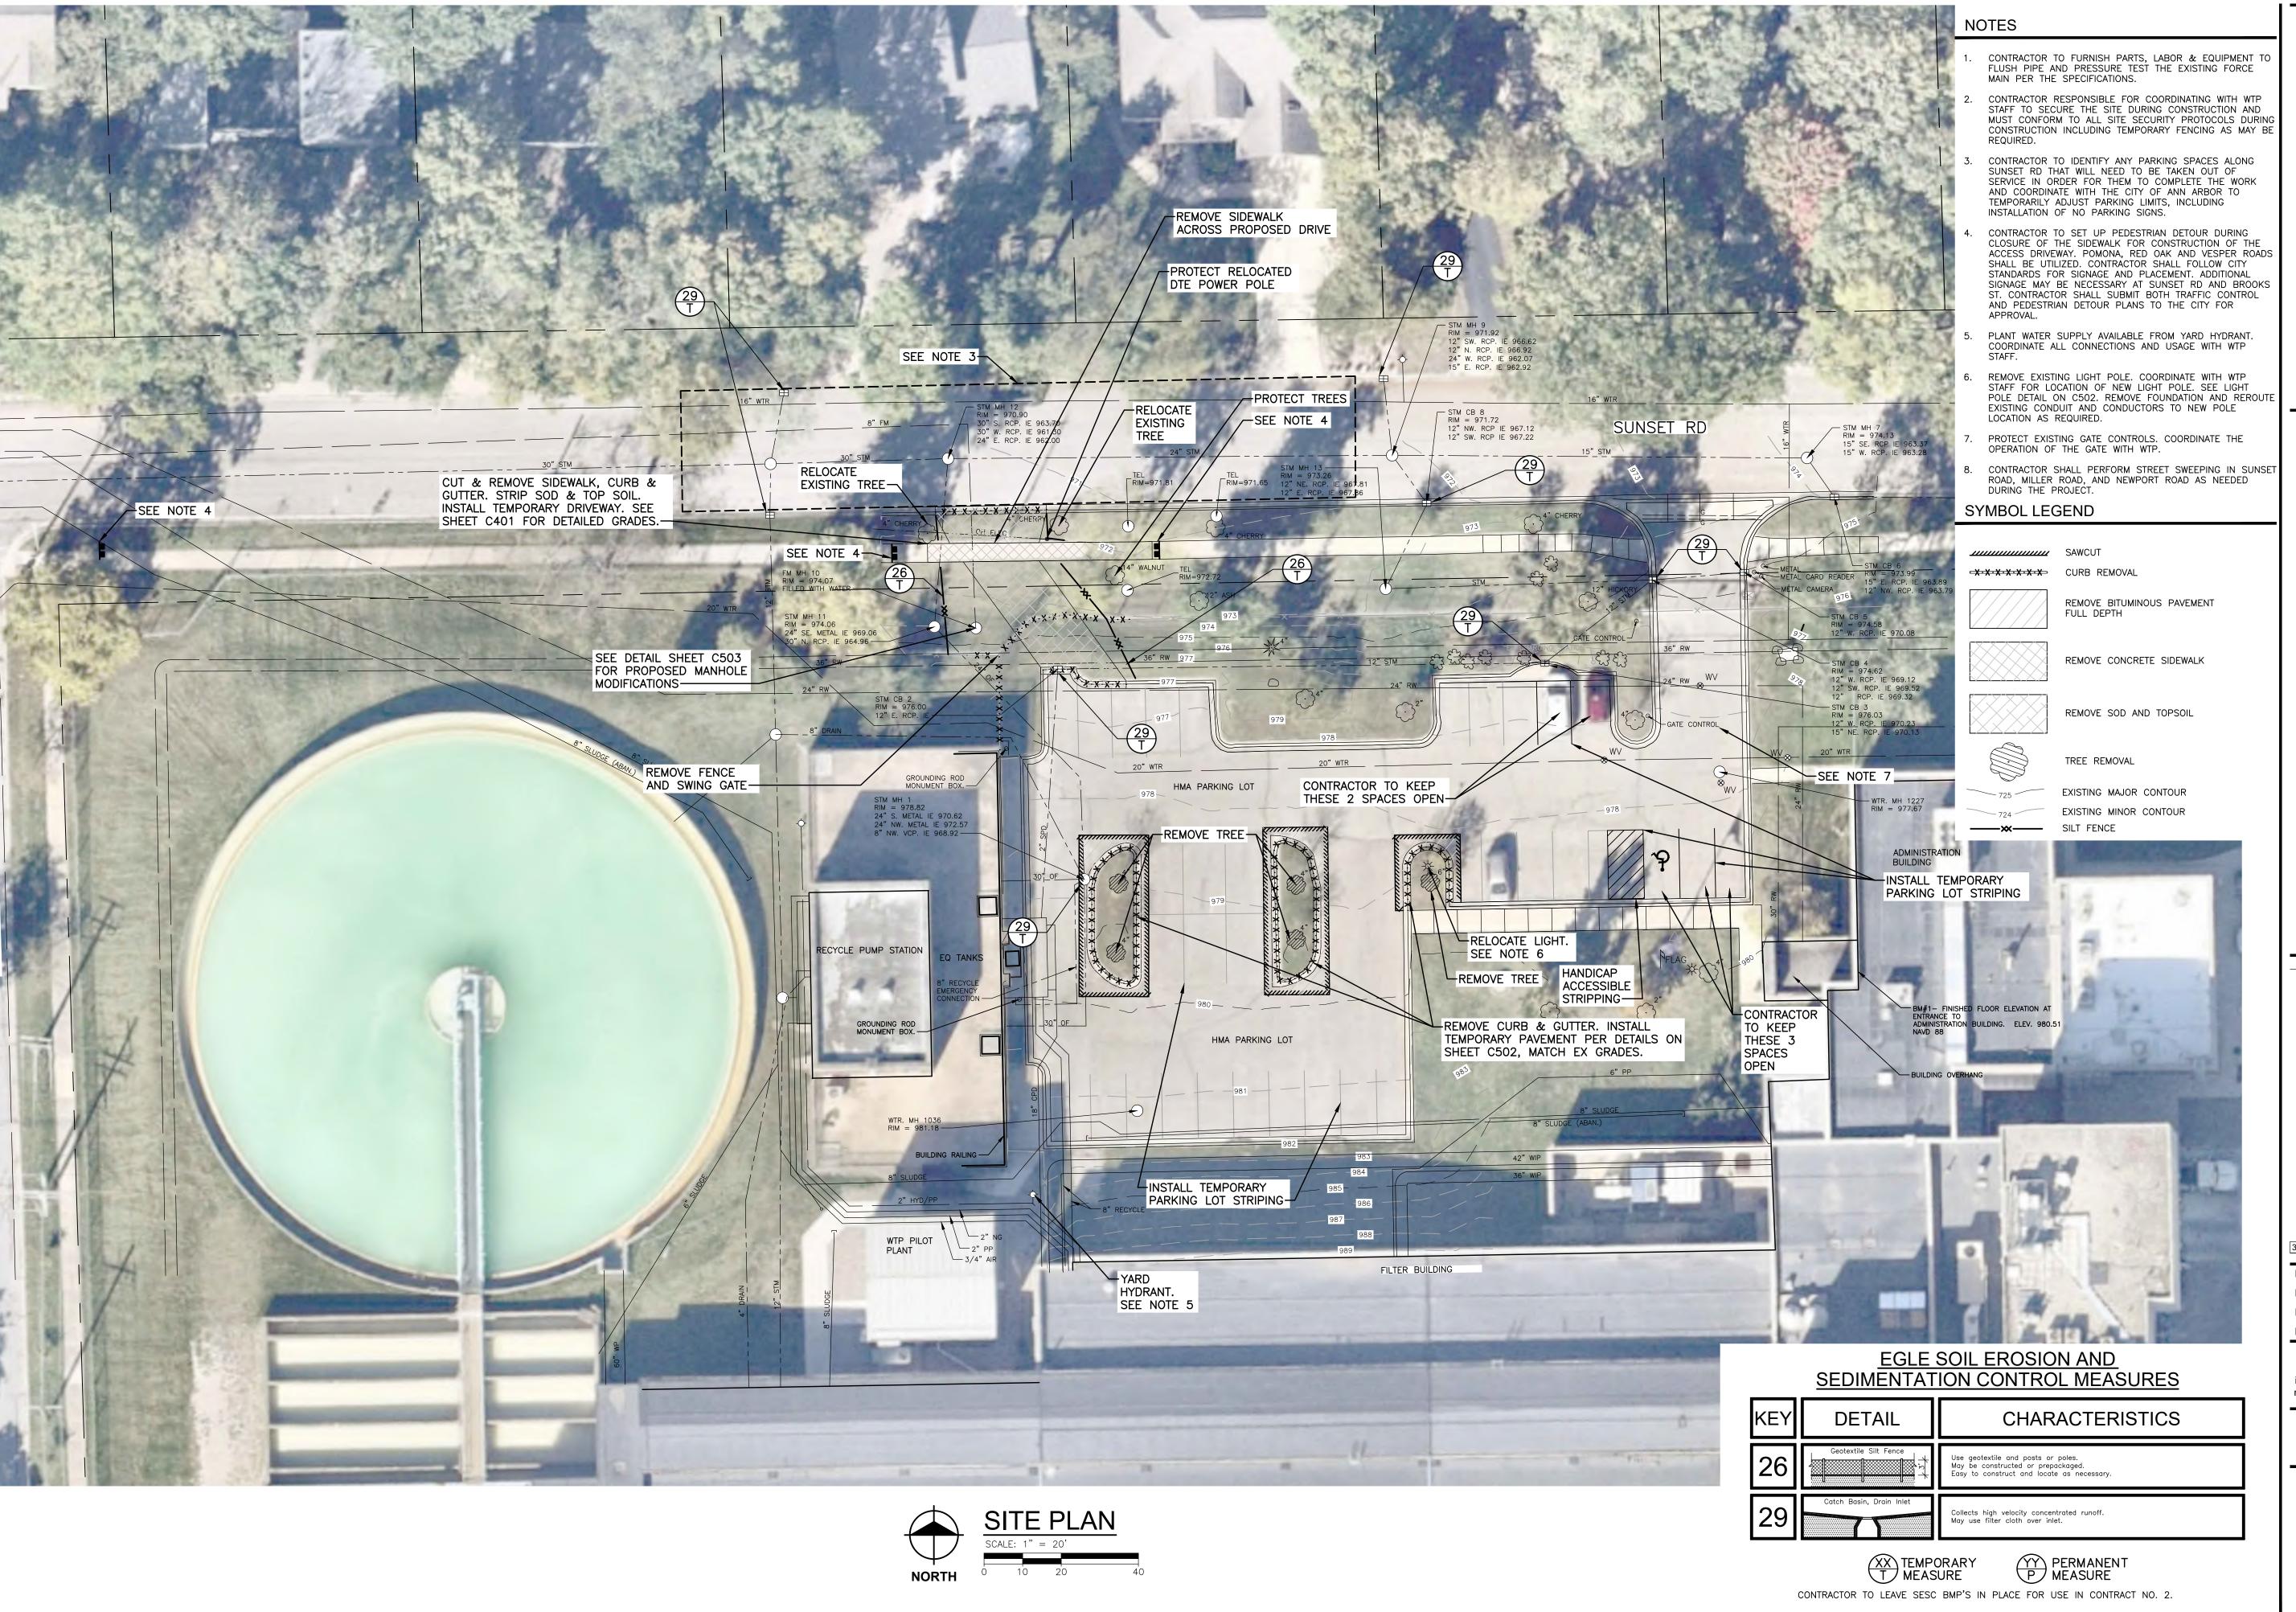

dual Removal Modifications

esidual

WTP

REVISIONS

3/4/2025 BIDS & CONSTRUCTION

Drawn By

Manager


Hard copy is intended to be 22"x34" when plotted. Scale(s) indicated and graphic quality may not be accurate for any other size.

> PROJECT NO. 241760


SHEET NO.

C102

PLAN - DRIVEWAY

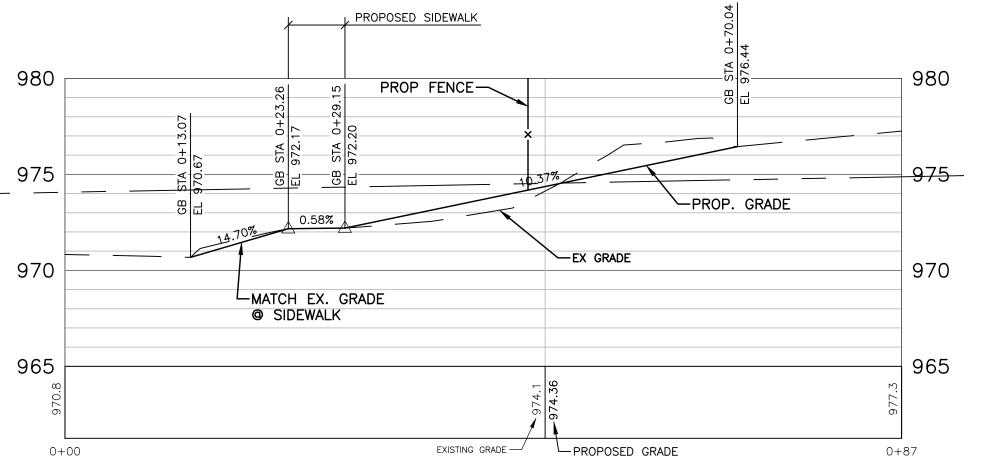

PROFILE - DRIVEWAY SCALE: 1" = 10'H, 1" = 5'V

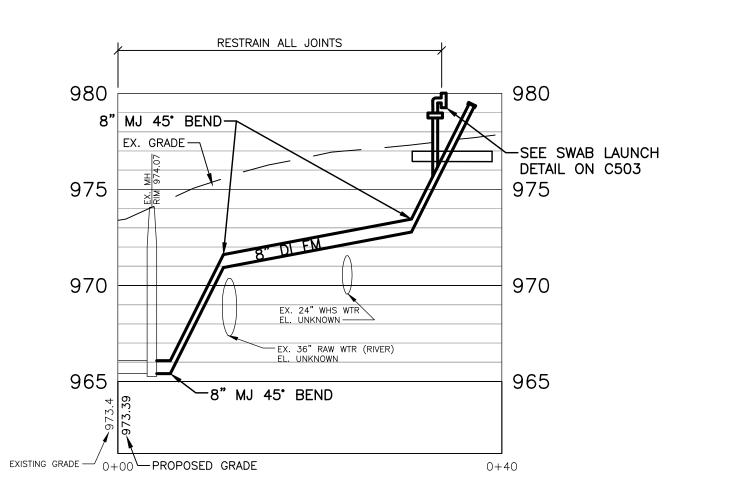

PROFILE - FORCEMAIN SCALE: 1" = 10'H, 1" = 5'V


1. PROFILE IS ASSUMED BASED ON EXISTING UTILITY INFORMATION. CONTRACTOR TO EXPOSE ALL EXISTING PIPES TO BE CROSSED BY THE PROPOSED FORCE MAIN PRIOR TO PIPE INSTALLATION. ADDITIONAL FITTINGS MAY BE REQUIRED TO CONSTRUCT WITH PROPER CLEARANCES, AND ARE TO BE PAID FOR PER CONTRACT ALLOWANCE FOR UTILITY CONFLICTS. CONTRACTOR TO PROVIDE AS NEEDED.

2. ABOVE GROUND DUCTILE IRON PIPE SHALL BE POLYURETHANE COATED: APPLY 2 COATS OF A POLYAMIDE—CURED EPOXY
RESIN FINISH AT 2.5 TO 3.5 DRY MILS, AND 1 FINAL COAT OF
AN ALIPHATIC POLYURETHANE ENAMEL AT 2.0 TO 3.0 DRY
MILS. BLACK IN COLOR.

4" THICK CONCRETE SIDEWALK

SYMBOL LEGEND

NOTES

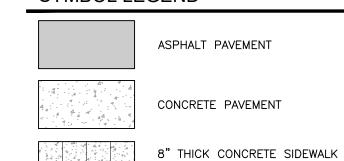

0

REVISIONS

Residual Removal Site Modifications

WTP Lime Contract 1 -

3/4/2025 BIDS & CONSTRUCTION Drawn By


Manager

Hard copy is intended to be 22"x34" when plotted. Scale(s) indicated and graphic quality may not be accurate for any other size.

> PROJECT NO. 241760

SHEET NO.



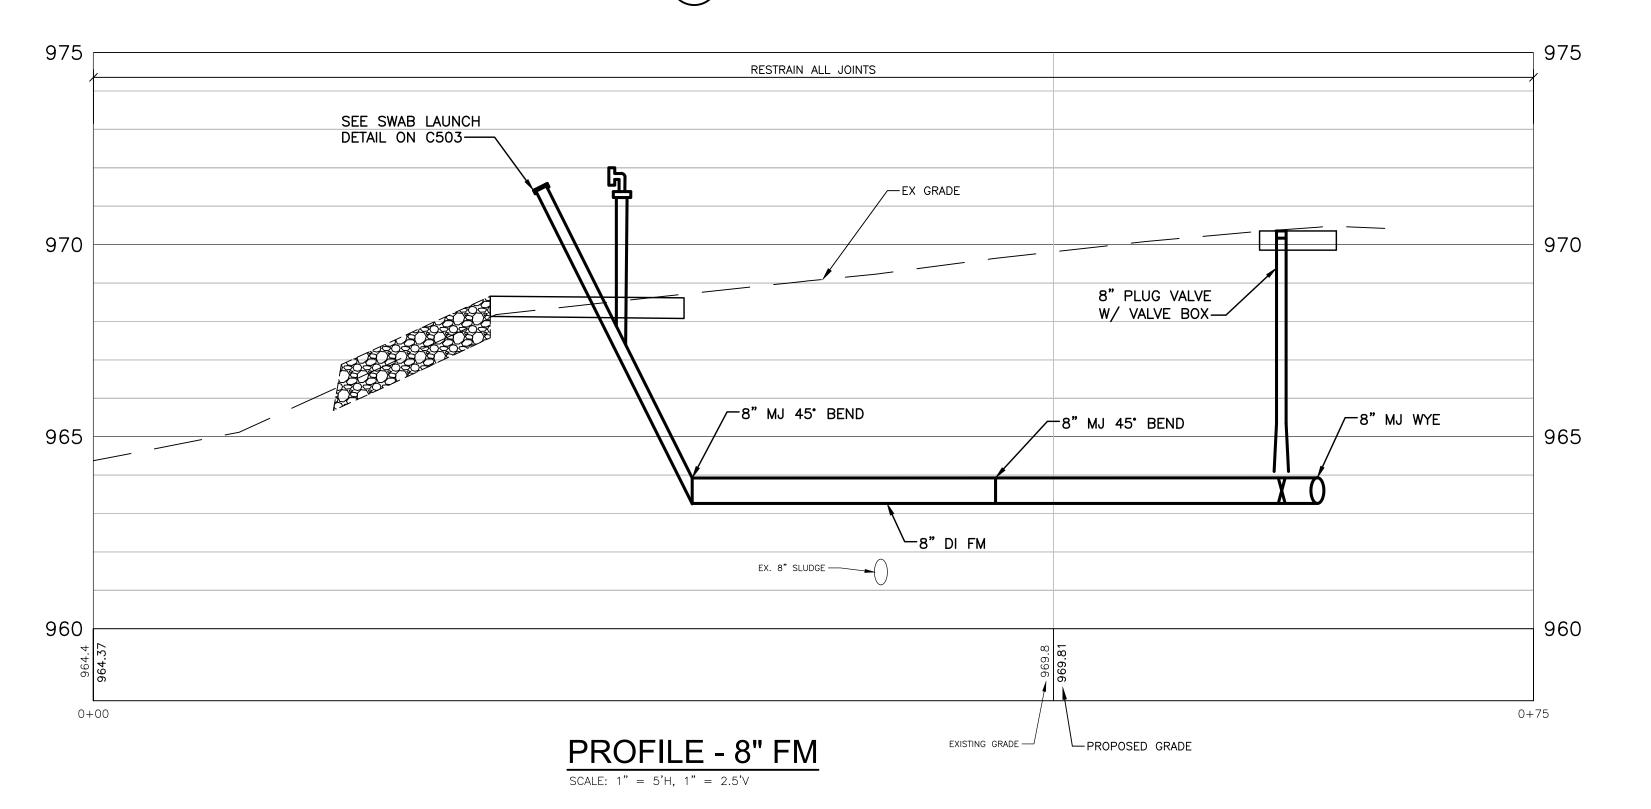

4 of City

Residual Removal - Site Modifications

WTP Lime Contract 1 -

REVISIONS

NOTES

MILS. BLACK IN COLOR.

SPECIFICATIONS.

SYMBOL LEGEND

1. ABOVE GROUND DUCTILE IRON PIPE SHALL BE POLYURETHANE COATED: APPLY 2 COATS OF A POLYAMIDE—CURED EPOXY RESIN FINISH AT 2.5 TO 3.5 DRY MILS, AND 1 FINAL COAT OF AN ALIPHATIC POLYURETHANE ENAMEL AT 2.0 TO 3.0 DRY

2. CONTRACTOR TO GRADE LOCATION FOR CONCRETE SLAB AND BACKELL TRENCH TO NECESSARY GRADE PER THE

CONCRETE PAVEMENT

EXISTING MAJOR CONTOUR

EXISTING MINOR CONTOUR

3/4/2025 BIDS & CONSTRUCTION Drawn By jreyes

Designer Reviewer

Manager

Hard copy is intended to be 22"x34" when plotted. Scale(s) indicated and graphic quality may not be accurate for any other size.

> PROJECT NO. 241760

SHEET NO.

-- Anchor to shoreline upstream

--Place Stone Bags on inside bottom face of Curtain las needed)

∕∼-Curtain Anchor (Typ)

E&S-1-A

IN-STREAM CONSTRUCTION


Re-directional (as needed)


SHORELINE CONSTRUCTION


Shore or Are Abutment


Bottom of the ---

Anchor toshoreline downstream

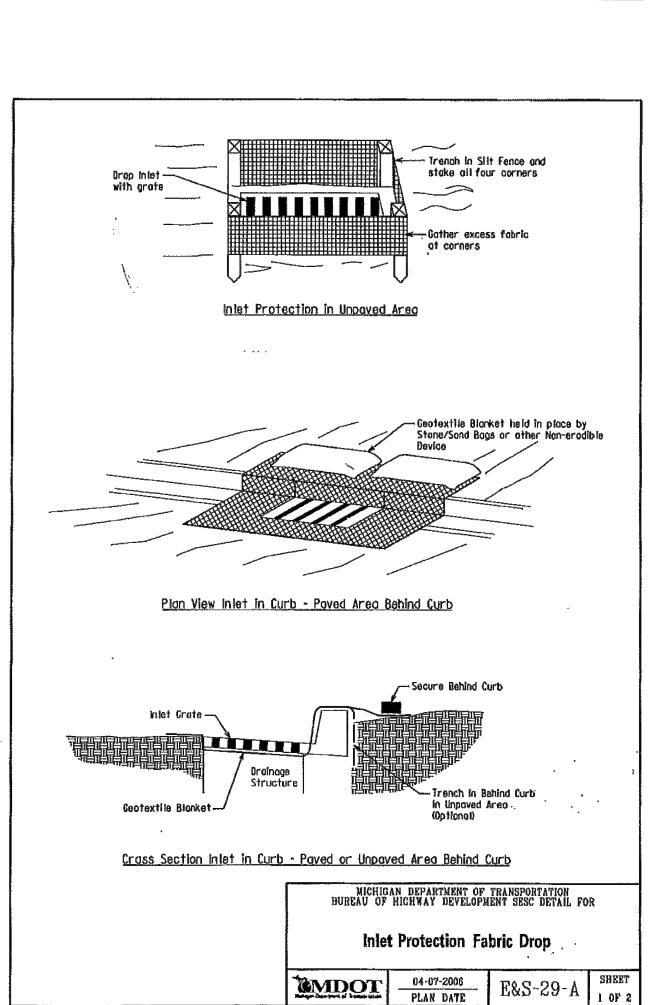

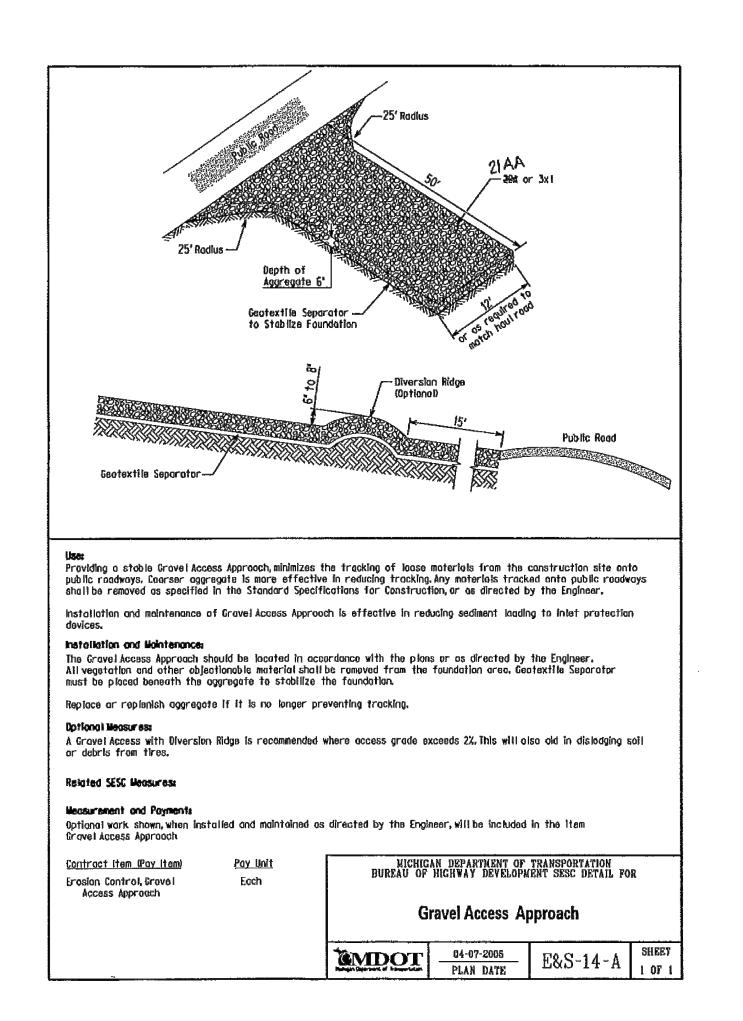

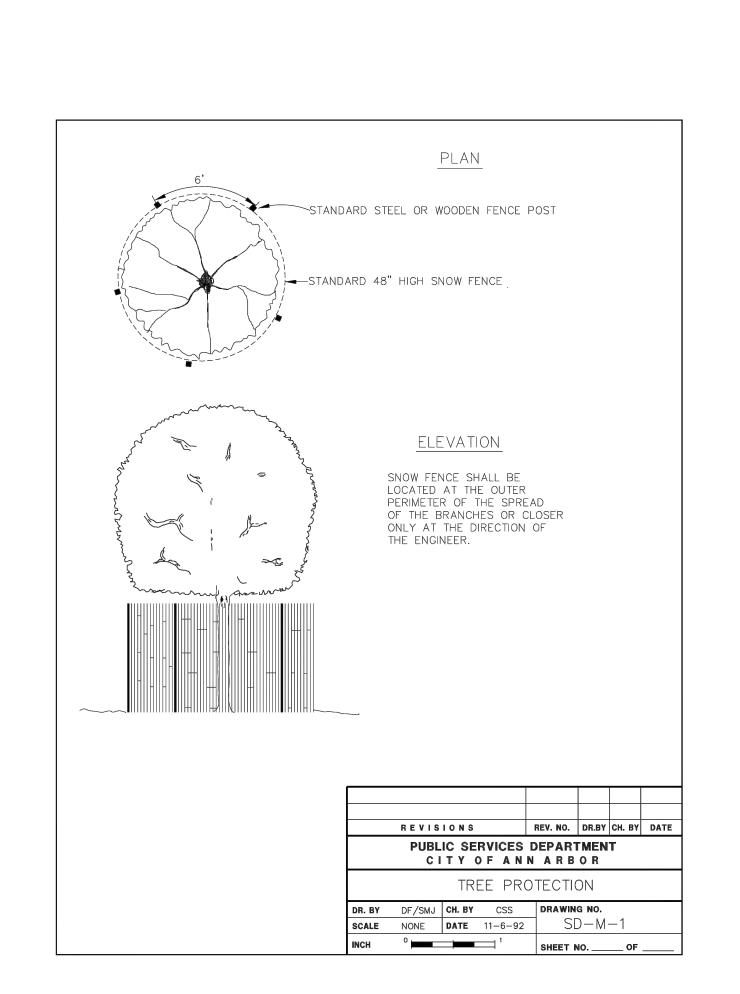

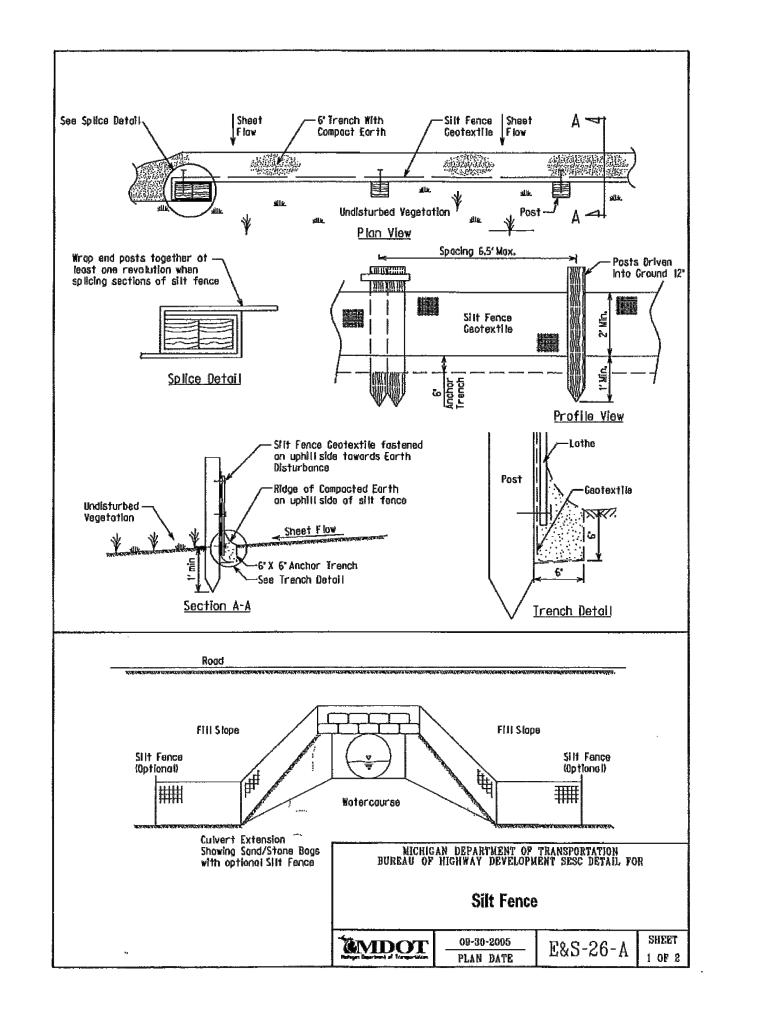



Residual Removal

WTP

Modifications

REVISIONS

3/4/2025 BIDS & CONSTRUCTION


Drawn By Designer

Reviewer Manager

Hard copy is intended to be 22"x34" when plotted. Scale(s) indicated and graphic quality may not be accurate for any other size.

> PROJECT NO. 241760

SHEET NO.

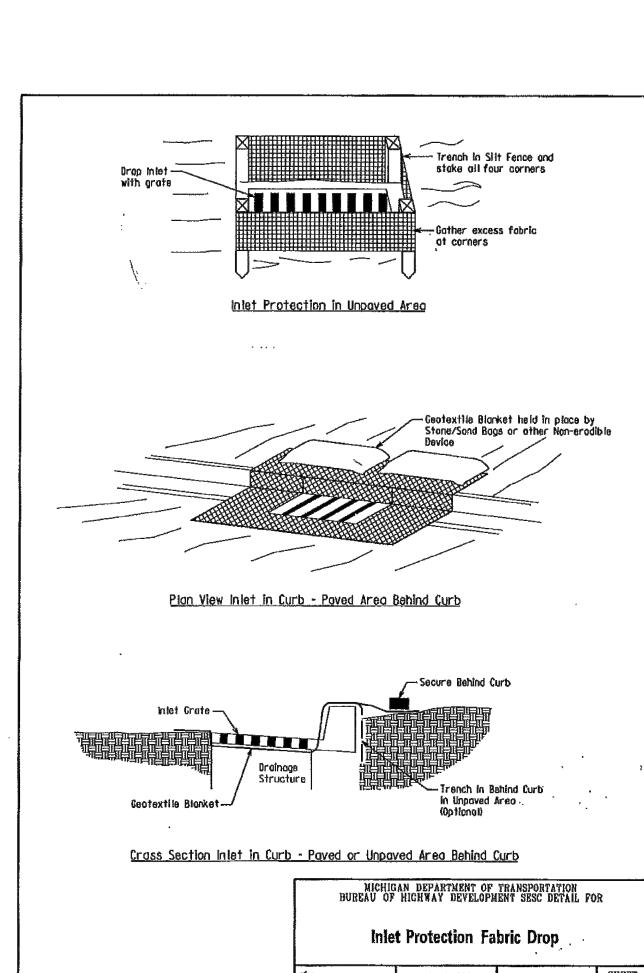

12'-0"

OVERHANG (OMIT FABRIC)

TRACK —

TRACK ASS'Y-

2" SQUARE UPRIGHT —

TRUSS ROD-


2" SQUARE


UPRIGHT ---


WARNING SIGN —

TENSION ROD-


1'-1"-

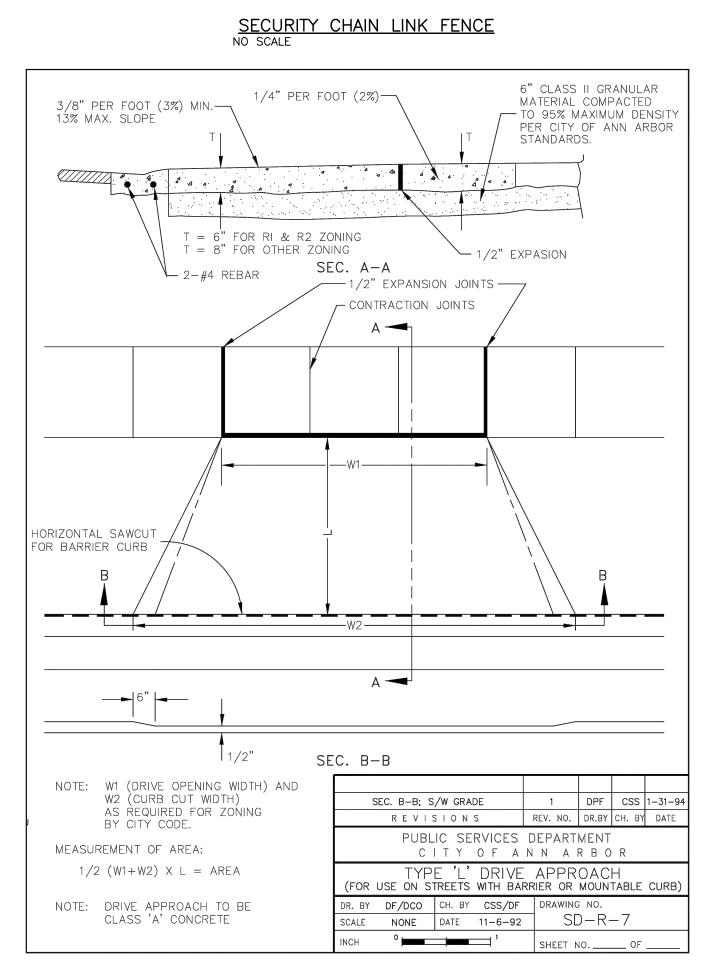

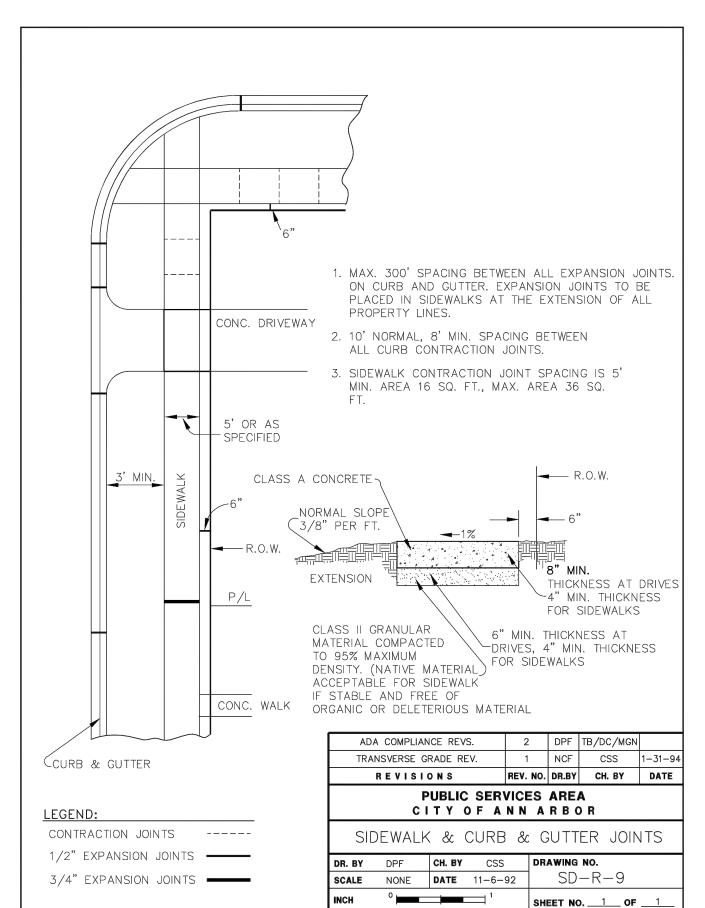


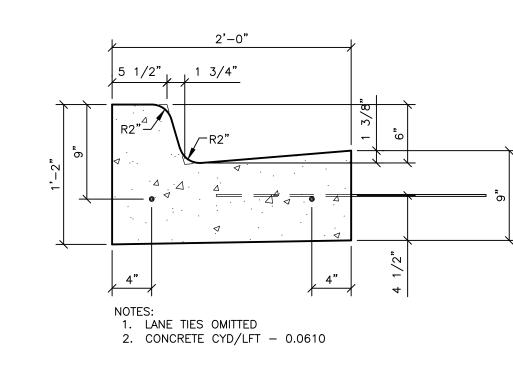

MDOT DETAIL F4 CURB & GUTTER NO SCALE

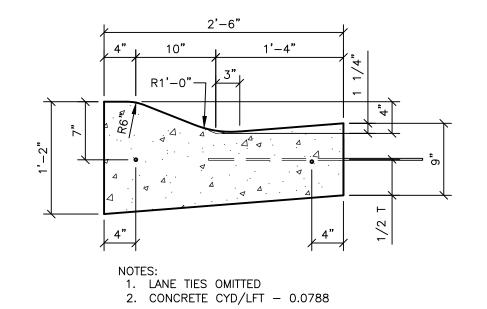

MDOT DETAIL D2 CURB & GUTTER NO SCALE

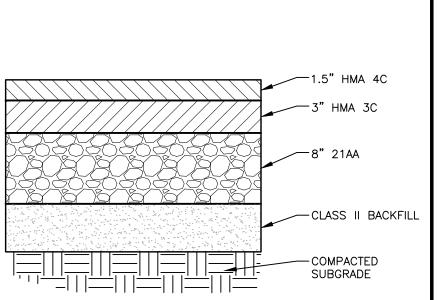

TEMPORARY PAVEMENT SECTION

3/4/2025 BIDS & CONSTRUCTION

REVISIONS

Residual Removal Site Modifications

WTP Lim Contract

0


Drawn By Designer Reviewer


Manager Hard copy is intended to be 22"x34" when plotted. Scale(s) indicated and graphic quality may not be accurate for any other size.

> PROJECT NO. 241760

SHEET NO.

©Copyright 2025 All Rights Reserved

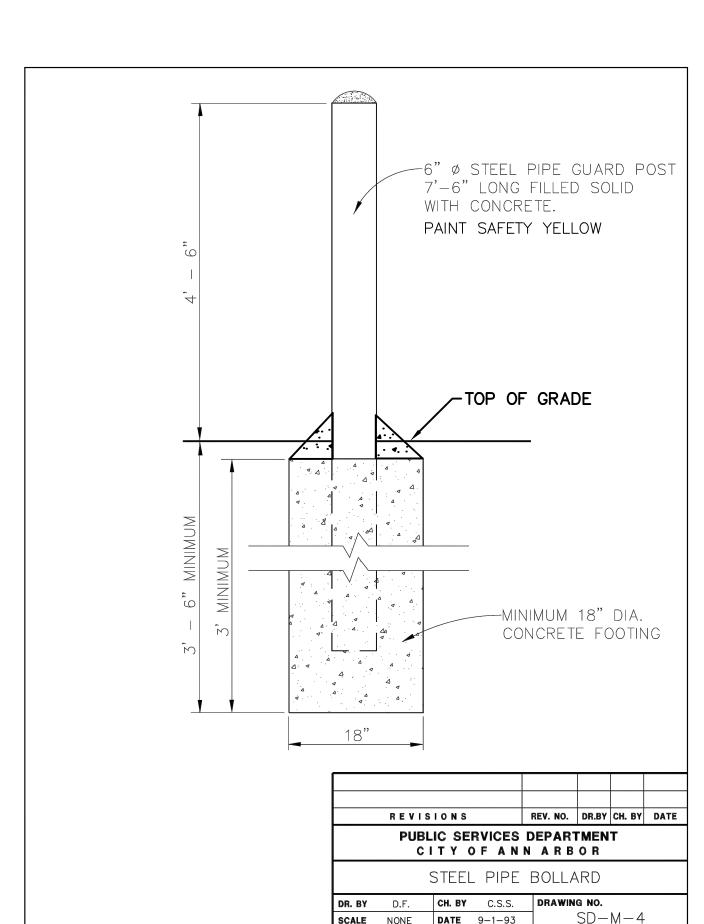

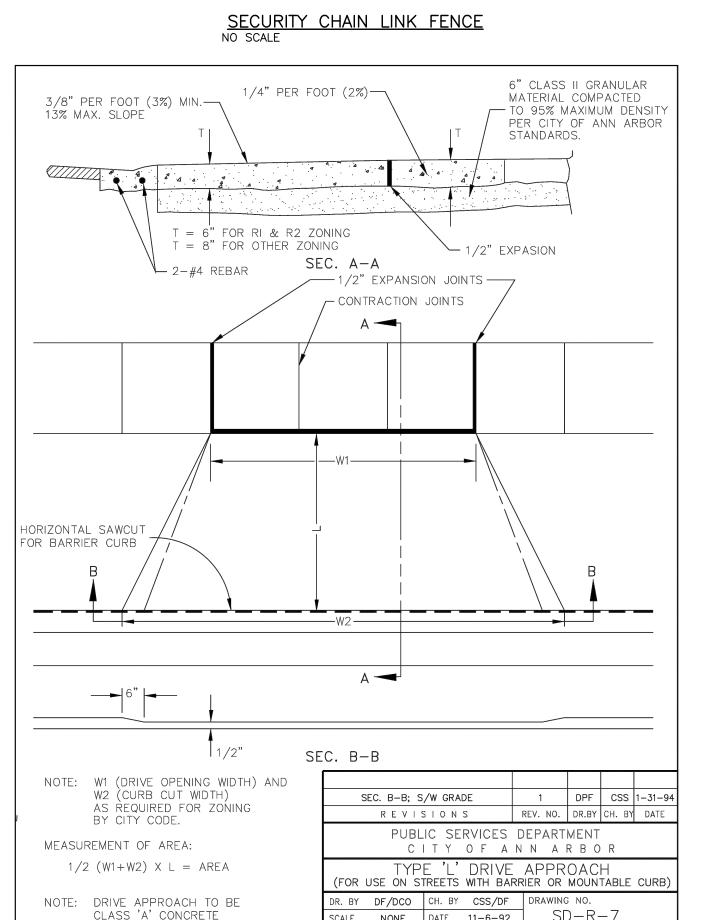

20'-0"

GATE PLAN

FABRIC AREA

-3 STRANDS OF

— TENSION

NOTE: CONTRACTOR TO PROVIDE CANTILEVERED GATE

ASSEMBLY PER DETAIL.

BARBED WIRE (TYP.)

L (NOT TO SCALE)

POST TOP

TO OPEN

-

KEEPER —

2" SQUARE BOTTOM RAIL—

2'-6"

2" SQUARE

2" MAX FOR SENSORED FENCES

GATE SECTION

BOTTOM RAIL-

5" MAX FOR NON-SENSORED FENCES

V_3 STRANDS OF

-POST TOP

BARBED WIRE (TYP.)

__3 STRANDS OF

-BRACE RAIL (TYP)

BARBED WIRE (TYP.)

FENCE FABRIC (TYP.)-

LINE POST -

— TRUSS ROD (TYP.) -BRACE RAIL (TYP.)

─GRADE LINE

-BOTTOM TENSION

WIRE OR RAIL AS


SPECIFIED (TYP.)


-PROVIDE GROUNDING

SPECIFICATIONS

RODS AND CLAMPS PER

TOP TENSION WIRE OR RAIL AS SPECIFIED

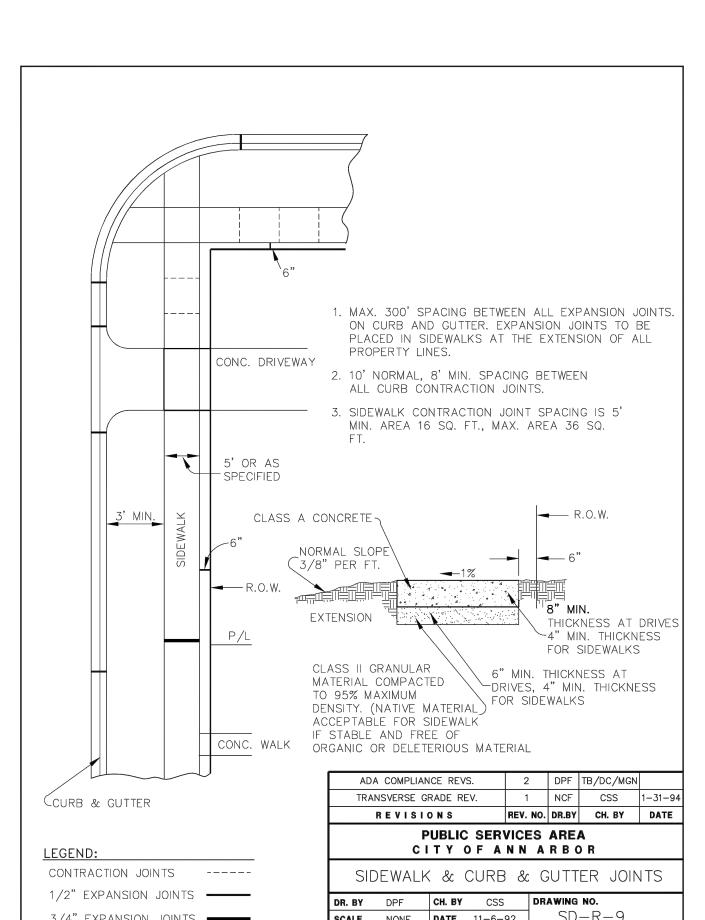

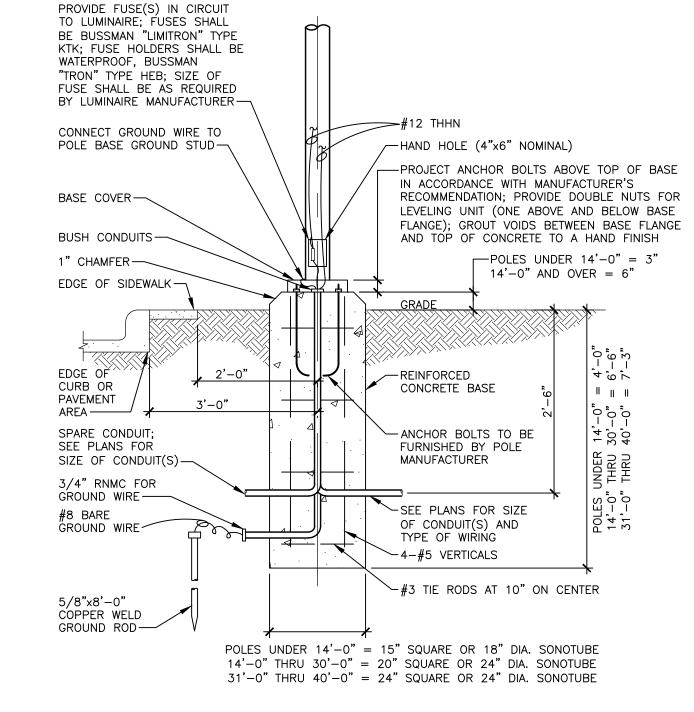


1. EXISTING POLE, LUMINAIRE, AND BASE TO BE DEMOLISHED AS INDICATED ON C102.
DISCONNECT AND MAINTAIN EXISTING CONDUIT AND CONDUCTORS FOR RECONNECTION
TO NEW LUMINAIRE IN NEW LOCATION. EXTEND CONDUIT AND CONDUCTORS AS
REQUIRED TO NEW LOCATION.
2. PROVIDE NEW POLE OF HEIGHT, DIAMETER, AND COLOR TO MATCH EXISTING POLES TO


- REMAIN. PROVIDE LITHONIA RSS POLE, WITH ALL ACCESSORIES REQUIRED FOR POLE BASE INSTALLATION AND FIXTURE MOUNTING.

 3. PROVIDE NEW LITHONIA POLE MOUNTED AREA LIGHTING FIXTURE. LITHONIA D SERIES SIZE O. FIXTURE COLOR TO MATCH POLE. FIELD VERIFY VOLTAGE REQUIRED BEFORE ORDERING. FIELD VERIFY COLOR TEMPERATURE OF EXISTING FIXTURES TO REMAIN AN MATCH FOR NEW FIXTURE. MODEL DSX0-LED-P1-(CCT TO MATCH
- SIZE O. FIXTURE COLOR TO MATCH POLE. FIELD VERIFY VOLTAGE REQUIRED BEFORE ORDERING. FIELD VERIFY COLOR TEMPERATURE OF EXISTING FIXTURES TO REMAIN AND MATCH FOR NEW FIXTURE. MODEL DSXO-LED-P1-(CCT TO MATCH EXISTING)-70CRI-T4M-MVOLT-RPA. VERIFY WITH OWNER IF ANY PHOTOCONTROL OR OTHER ACCESSORIES ARE REQUIRED BEFORE ORDERING.


OUTDOOR LIGHTING STANDARD CONCRETE BASE DETAIL

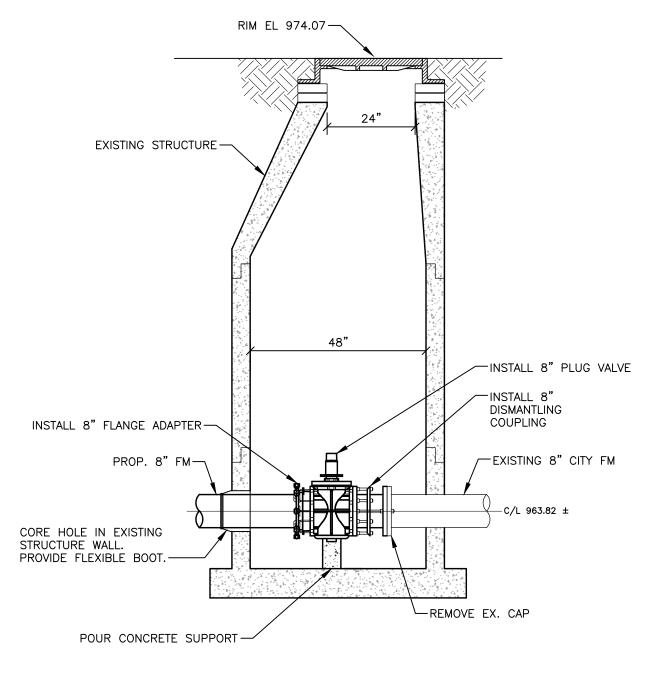

MANHOLE MODIFICATIONS — WTP SITE NO SCALE

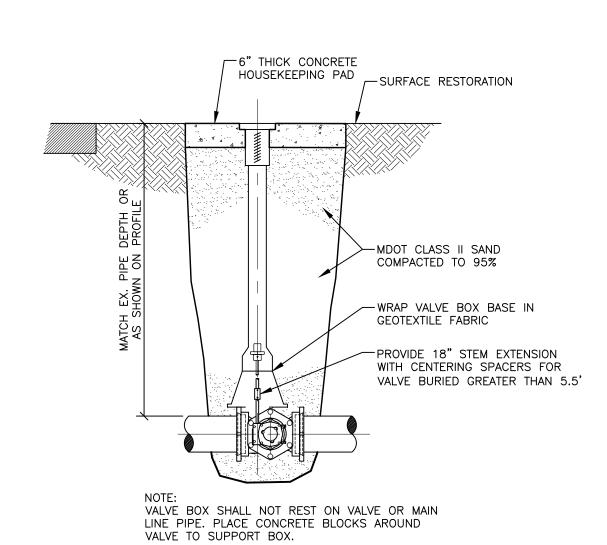

PLUG VALVE AND BOX

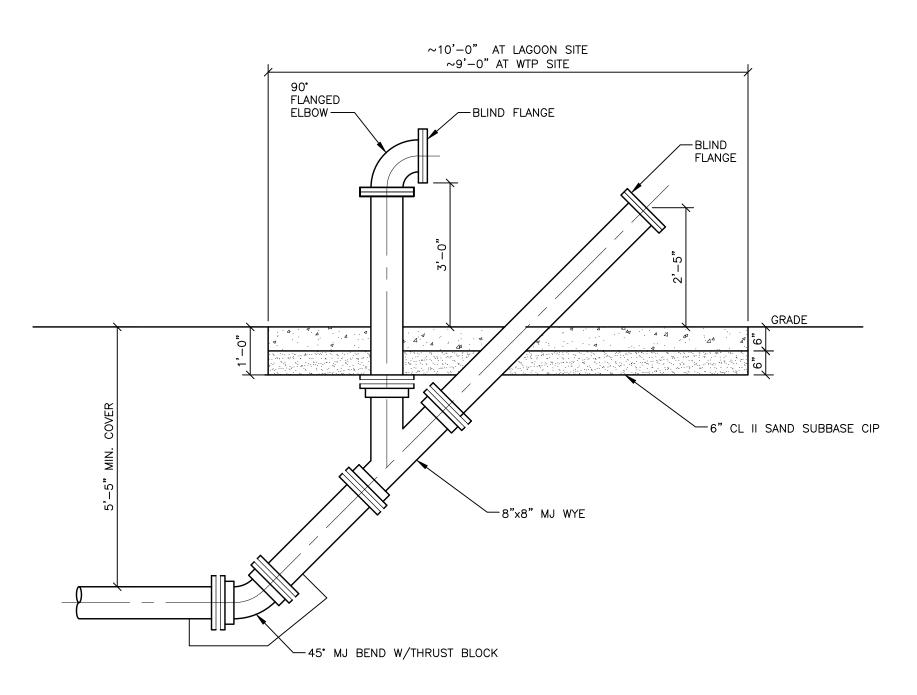


VAB LAUNCH AND PIPE CONNECTION DETAIL

MINIMUM STANDARDS

REACTION BACKING: The Class "A" concrete at the Fitting face shall extend to within (2) inches of the bell and shall extend from the fitting face a minimum of (2) feet to the UNDISTURBED SOLID GROUND. The dimensions of the reaction backing (thrust block) at the face of the undisturbed solid ground shall be as shown in the Table below. If there isn't sufficient space for the installation of the "thrust block" without interference with other services, another arrangement satisfactory to the engineer shall be used, i.e. encasement.

Fittings	PI	ug	Bends							Hydrant		
I.D.	Tee Cross			90°		45°	22	2 1/2°	1	1 1/4°	,	
Inches								,		<i>'</i>		
	W	Н	W	Н	W	Н	W	Н	w	Н	W	Н
2.5	1	1	1	1	1	1						
4	1	1	1	1	1	1						
6	2	1.5	2	2	2	1	1	1	1	1	2	1.5
8	2.5	2	3.5	2	2	2	2	1	1	1	2.5	2
12	3.5	3	5.5	3	3.5	2.5	2	2	2	1		
16	6	3.5	6	4	5	3	3.5	2.5	2	2		
20	8	4	12	4	6	4	4	3	3	2		
24	11	4	17	4	9	4	6	4	3.5	2		
30	11	4	17	4	9	4	6	4	3.5	2		

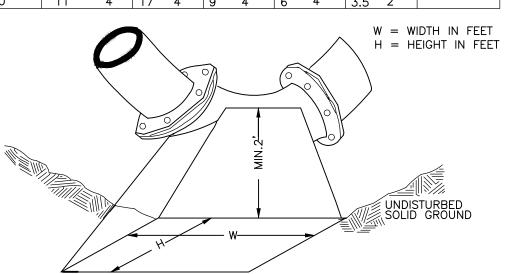

NOTE: THESE ARE MINIMUM STANDARDS. WHERE SOIL CONDITIONS DICTATE, ADJUSTMENTS IN SIZE SHALL BE MADE BY THE PUBLIC SERVICES DIRECTOR.

THRUST BLOCK
NO SCALE

City of Ann Arbo

WTP

esidual Removal

REVISIONS

3/4/2025 BIDS & CONSTRUCTION

Drawn By jreyes

Designer jsiwek

Reviewer krostrows

Manager jsiwek

Hard copy is intended to be
22"x34" when plotted. Scale(s)
indicated and graphic quality may


not be accurate for any other size.

PROJECT NO.

241760

SHEET NO.

C5U3

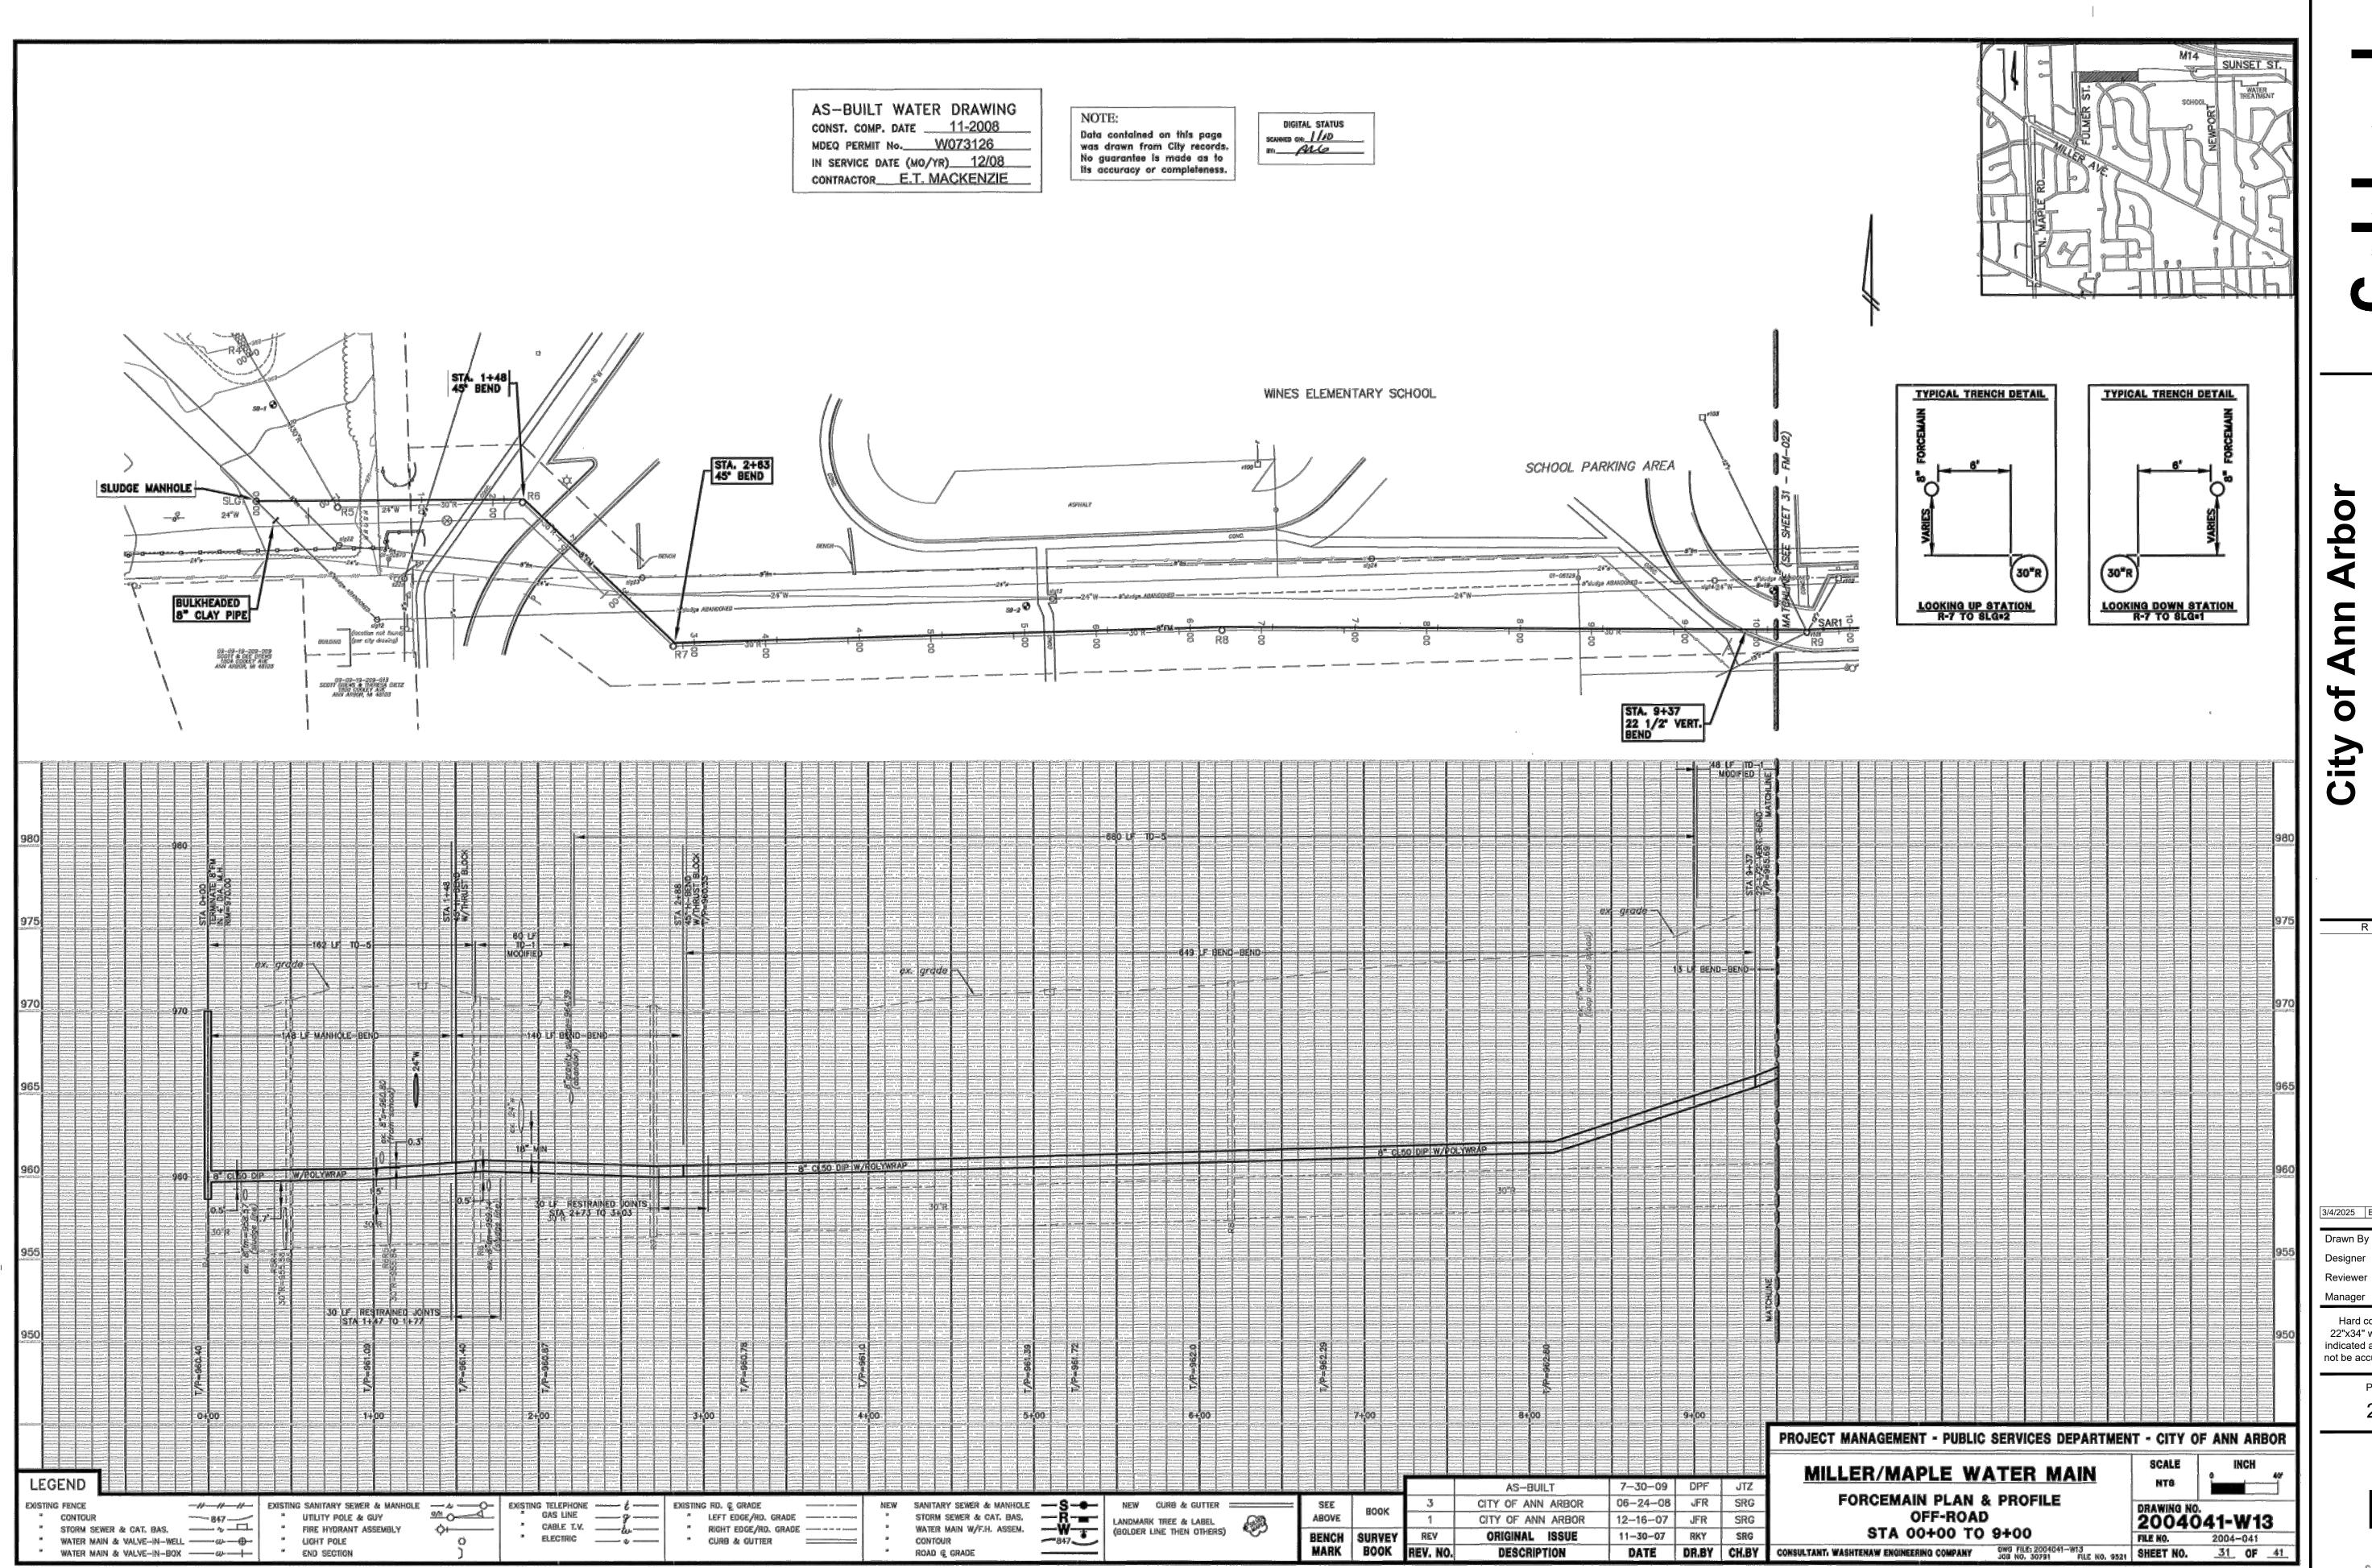

REVISIONS

WTP Lime Residual Removal Contract 1 - Site Modifications

3/4/2025 BIDS & CONSTRUCTION

Hard copy is intended to be 22"x34" when plotted. Scale(s) indicated and graphic quality may

not be accurate for any other size. PROJECT NO.

> 241760 SHEET NO.

Residual Removal - Site Modifications

WTP Lime | Contract 1 -

REVISIONS

3/4/2025 BIDS & CONSTRUCTION

Hard copy is intended to be 22"x34" when plotted. Scale(s) indicated and graphic quality may not be accurate for any other size.

PROJECT NO. 241760

SHEET NO.