

CITY OF ANN ARBOR ENGINEERING

NOTE

FOR PROTECTION OF UNDERGROUND UTILITIES AND IN CONFORMANCE WIT PUBLIC ACT 174 OF 2013, THE CONTRACTOR SHALL CALL 811 O 1-800-482-7171 A MINIMUM OF THREE FULL WORKING DAYS, EXCLUDIN SATURDAYS, SUNDAYS, AND HOLIDAYS, PRIOR TO BEGINNING EAC EXCAVATION IN AREAS WHERE PUBLIC UTILITIES HAVE NOT BEE PREVIOUSLY LOCATED. MEMBERS WILL THUS BE ROUTINELY NOTIFIED THIS DOES NOT RELIEVE THE CONTRACTOR OF THE RESPONSIBILITY O NOTIFYING UTILITY OWNERS WHO MAY NOT BE A PART OF THE "MISS DIGALERT SYSTEM.


THE UNDERGROUND LOCATIONS SHOWN FOR NATURAL GAS, TELEPHONE, ELECTRICAL POWER, CABLE TV AND FIBER OPTIC LINES ARE APPROXIMATE. THE CITY OF ANN ARBOR ASSUMES NO RESPONSIBILITY FOR THEIR ACCURATE REPRESENTATION IN THIS DRAWING. MISS DIG MUSBE CONTACTED PRIOR TO CONSTRUCTION TO LOCATE THESE UTILITIES.

THE CONSTRUCTION COVERED BY THESE PLANS SHALL CONFORM TO THE 1994 EDITION OF THE CITY OF ANN ARBOR PUBLIC SERVICES DEPARTMENT STANDARD SPECIFICATIONS, ITS DETAILS, WHICH ARE INCLUDED BY REFERENCE, AND THIS PROJECT'S CONTRACT DOCUMENTS. THE OMISSION OF ANY CURRENT STANDARD DETAIL DOES NOT RELIEVE THE CONTRACTOR FROM THIS REQUIREMENT.

PROJECT MANAGER

3/4/2022

SIDEWALK GAP ELIMINATION - 2022

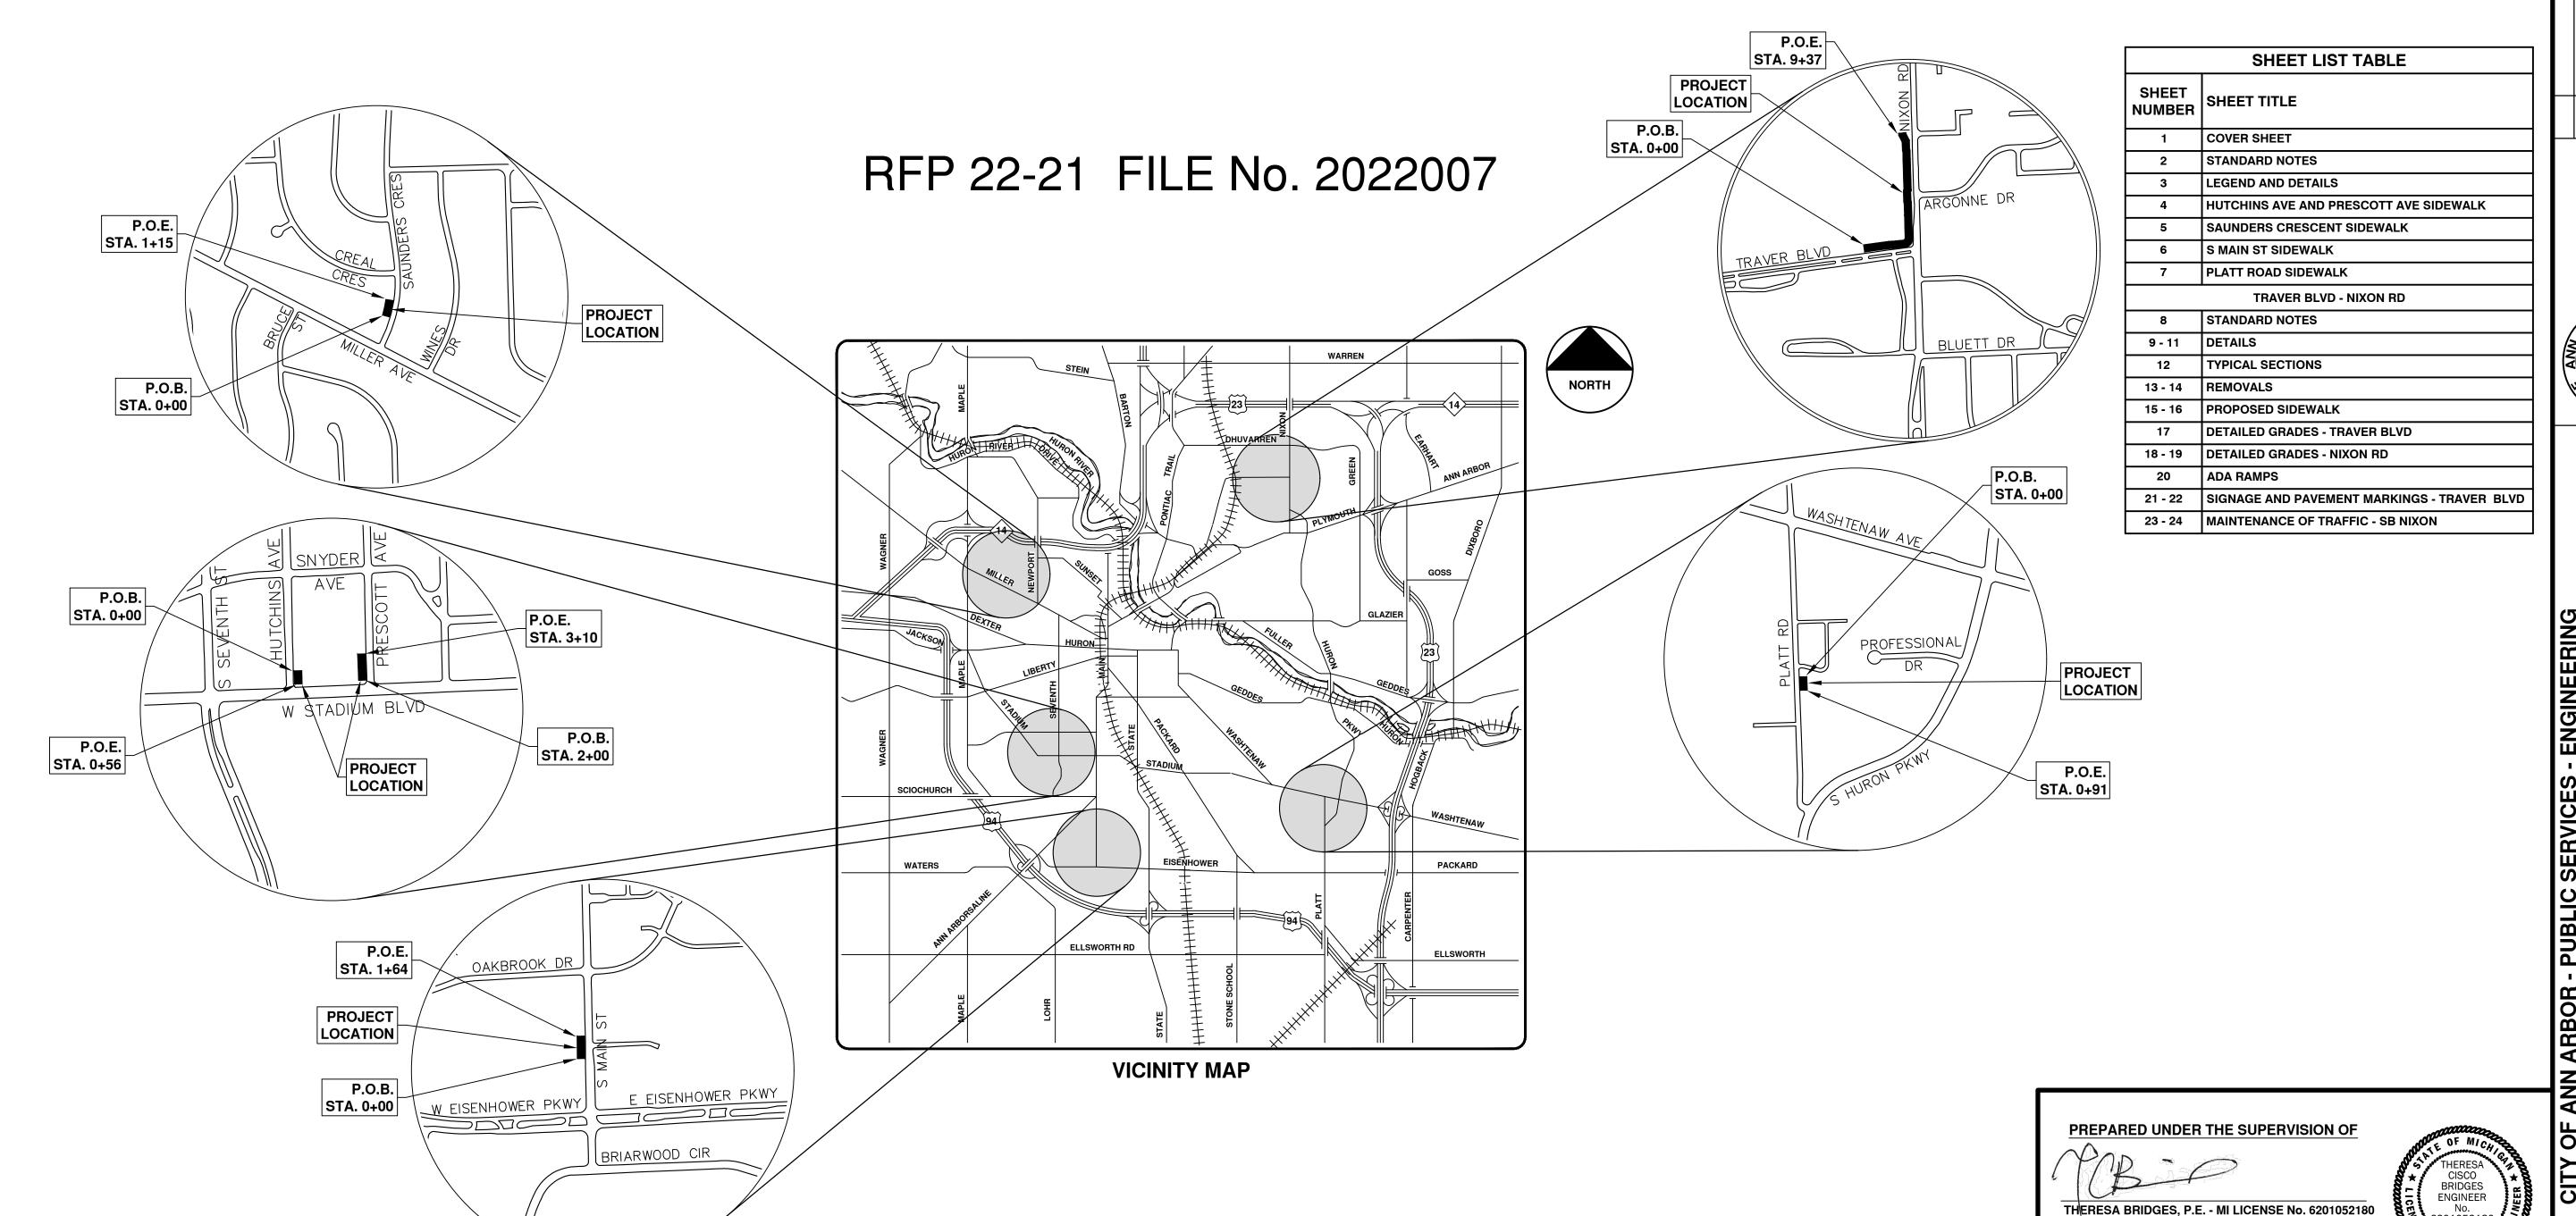

CONSTRUCTION NOTES:

- DRIVEWAYS AND ENTRANCES TO BUILDINGS, REAL PROPERTY, AND THE LIKE SHALL NOT BE BLOCKED EXCEPT FOR SHORT DURATIONS AND ONLY WHEN APPROVED BY THE ENGINEER. VEHICULAR AND PEDESTRIAN ACCESS SHALL BE MAINTAINED AT ALL TIMES. IT SHALL BE THE CONTRACTOR'S RESPONSIBILITY TO COORDINATE ALL NECESSARY DRIVEWAY CLOSURES WITH THE PROPERTY OWNER(S) AND RESIDENT(S) IN THE AREAS OF CONSTRUCTION.
- 2. THE LOCATION AND DEPTH OF ALL EXISTING UTILITIES AND SERVICE LEADS ARE TO BE FIELD VERIFIED BY THE CONTRACTOR PRIOR TO CONSTRUCTION.
- 3. LOCATION OF UTILITIES AS DEPICTED ON THE PLANS IS APPROXIMATE AND SHOWN ACCORDING TO THE BEST INFORMATION AVAILABLE. IT IS THE CONTRACTOR'S RESPONSIBILITY TO EXCAVATE AHEAD AND ADJUST DEPTH OF CONFLICT UTILITIES ACCORDINGLY. ANY DAMAGE TO UTILITIES IS THE CONTRACTOR'S RESPONSIBILITY TO AVOID AND/OR REPAIR AS NECESSARY.
- 4. DURING NON-WORKING HOURS NO TRENCH SHALL REMAIN OPEN UNLESS APPROVED BY THE ENGINEER; ANY OPEN TRENCH SHALL BE PROPERLY SECURED WITH PROTECTIVE FENCING. THIS WORK SHALL BE INCLUDED IN THE ITEM OF WORK "GENERAL CONDITIONS".
- 5. THE LOCATION OF MATERIAL STOCK PILES AND ON-SITE STAGING AREAS SHALL BE APPROVED BY THE ENGINEER. ALL MATERIAL STOCKPILES SHALL BE MAINTAINED SUCH THAT DRAINAGE AND SIGHT DISTANCES ARE NOT ADVERSELY IMPACTED. SOIL EROSION REQUIREMENTS SHALL APPLY TO ALL MATERIAL STOCKPILES.
- 6. ALL EXCAVATION REQUIRED FOR PROJECT GRADING WITHIN THE PROJECT LIMITS, INCLUDING PROPOSED PAVEMENT, SIDEWALK, AND SIDEWALK RAMPS SHALL BE INCLUDED IN "STATION GRADING,____.
- EXCAVATON AND BACKFILL BEHIND CURB AND GUTTER SHALL BE INCLUDED IN "STATION GRADING, ____." ALL BACKFILL UNDER PROPOSED CONCRETE PAVEMENTS SUCH AS DRIVE APPROACHES, RAMPS, SIDEWALK, ETC., SHALL BE MDOT CLASS II GRANULAR MATERIAL, COMPACTED TO 95% OF ITS MAX. DRY DENSITY AND WILL BE PAID FOR AS "SAND SUBBASE COURSE, CLASS II, C.I.P." BACKFILL FOR OTHER AREAS MUST BE APPROVED BY THE ENGINEER AND COMPACTED TO 95% OF ITS MAX. DRY DENSITY. NO PAYMENT WILL BE MADE FOR SUB-BASE OR AGGREGATE BASE THAT EXTENDS BEYOND 12" BEHIND THE BACK OF CURB OR PROPOSED SIDEWALK EDGE. REFERENCE THE TYPICAL CROSS SECTIONS.
- 8. ALL CURB, SIDEWALK, AND DRIVEWAY APPROACH REMOVALS SHALL BE APPROVED BY ENGINEER BEFORE THE WORK IS PERFORMED. ALL CONCRETE AND BITUMINOUS MATERIALS SHALL BE SAW-CUT FULL-DEPTH AT THEIR REMOVAL LIMITS PRIOR TO REMOVAL. SAW-CUTTING WILL NOT BE PAID FOR SEPARATELY, BUT SHALL BE INCLUDED IN THE "REMOVAL" ITEMS OF WORK.
- 9. PLACE 4" (MINIMUM) OR 6" (MINIMUM) THICKNESS CLASS II. GRANULAR MATERIAL COMPACTED TO 95% OF ITS MAX. DRY DENSITY UNDER CONCRETE SIDEWALK AS SHOWN ON THE DETAILS. THIS WORK SHALL BE INCLUDED IN THE CONTRACT ITEMS "SAND SUBBASE COURSE, CLASS II, C.I.P."
- 10. A UNIFORM COAT(S) OF CURING COMPOUND SHALL BE APPLIED TO FRESHLY PLACED CONCRETE ACCORDING TO THE STANDARD SPECIFICATIONS AND DETAILED SPECIFICATIONS REGARDLESS OF THE DIFFICULTY INVOLVED. THE CONTRACTOR SHALL TAKE CARE TO PREVENT OVERSPRAY WHEN APPLYING CURING COMPOUND. SEVERAL DIFFERENT METHODS MAY NEED TO BE DEVELOPED TO PROTECT VARIOUS SITUATIONS, BUT ALL METHODS USED TO PREVENT OVERSPRAY OF THE CURING COMPOUND SHALL BE COMPLETELY EFFECTIVE. METHODS USED SHALL BE APPROVED BY THE ENGINEER PRIOR TO USE. HOWEVER APPROVAL OF A METHOD DOES NOT GUARANTEE SUCCESS OR ACCEPTABILITY. NO ADDITIONAL COMPENSATION SHALL BE MADE FOR COMPLYING WITH THESE REQUIREMENTS.
- 11. "NO PARKING" SIGNS SHALL BE INSTALLED BY THE CONTRACTOR AT LOCATIONS AS APPROVED OR DIRECTED BY THE ENGINEER. ALL SIGNS SHALL BE INSTALLED IN ACCORDANCE WITH THE DETAILED SPECIFICATIONS.
- 12. POSTAL DELIVERY AND SOLID WASTE PICKUP SERVICE AS WELL AS EMERGENCY VEHICLE ASSESSIBILITY SHALL BE MAINTAINED AT ALL TIMES BY THE CONTRACTOR.
- 13. WHERE STREET CURBS ARE UNDERMINED DUE TO CONSTRUCTION ACTIVITIES, THEY SHALL BE REMOVED AND REPLACED AS DIRECTED BY THE ENGINEER.
- 14. THE CONTRACTOR SHALL BE RESPONSIBLE FOR THE CONTINUED MAINTENANCE OF SOIL EROSION CONTROL MEASURES WITHIN THE CONSTRUCTION AREA UNTIL THE FULL COMPLETION OF THE PROJECT. THIS WORK SHALL BE INCLUDED IN THE ITEM OF WORK "GENERAL CONDITIONS".
- 15. ALL STRUCTURES SHALL RECEIVE NEW CASTINGS AS DIRECTED BY THE ENGINEER, AS SPECIFIED ON THE STANDARD CASTING SCHEDULE. THE EXISTING CASTINGS ARE THE PROPERTY OF THE CITY OF ANN ARBOR. THE CONTRACTOR SHALL DELIVER TO CITY OF ANN ARBOR PUBLIC WORKS FACILITY AT THE W.R. WHEELER SERVICE CENTER LOCATED AT 4251 STONE SCHOOL
- 16. EXISTING STREET NAME, GUIDE, AND REGULATORY SIGNS, AND MAILBOXES WHICH CONFLICT WITH THE PROPOSED CONSTRUCTION SHALL BE REMOVED PRIOR TO CONSTRUCTION, STORED IN A MANNER WHICH WILL PREVENT DAMAGE, AND RE-SET IN LOCATIONS AS DIRECTED BY THE ENGINEER. THIS WORK WILL NOT BE PAID FOR SEPARATELY, BUT SHALL BE INCLUDED IN "STATION GRADING"

NOTIFY THE CITY OF ANN ARBOR SOIL EROSION CONTROL OFFICE 48 HOURS PRIOR TO BEGINNING WORK ON THE PROJECT. PHONE: 734-794-6265.

- 1. THE CONTRACTOR SHALL IMPLEMENT AND MAINTAIN THE SOIL EROSION CONTROL MEASURES AS SHOWN ON THE PLANS AND AS DIRECTED BY THE ENGINEER AT ALL TIMES DURING CONSTRUCTION. ANY MODIFICATIONS OR ADDITIONS TO THE SOIL EROSION CONTROL MEASURES DUE TO CONSTRUCTION OR CHANGED CONDITIONS SHALL BE AS DIRECTED AND APPROVED BY THE ENGINEER.
- 2. ALL SOIL EROSION AND SEDIMENTATION CONTROL WORK SHALL CONFORM TO THE PERMIT REQUIREMENTS OF THE CITY OF ANN ARBOR, CHAPTER 55 ANN ARBOR UNIFIED DEVELOPMENT CODE, CITY OF ANN ARBOR STANDARDS DIVISION VII, THE LAWS OF THE STATE OF MICHIGAN. AND THE REQUIREMENTS OF THE CONTRACT DOCUMENTS.
- 3. DAILY, OR AFTER ANY STORM EVENT, INSPECTIONS OF EROSION CONTROL MEASURES SHALL BE MADE BY THE CONTRACTOR. PERIODIC INSPECTIONS MAY BE MADE BY THE ENGINEER TO DETERMINE THE EFFECTIVENESS OF EROSION AND SEDIMENTATION CONTROL MEASURES. ANY NECESSARY CORRECTIONS SHALL BE MADE WITHOUT DELAY, AND WITHOUT ADDITIONAL COST TO THE CITY OF ANN ARBOR.
- 4. EROSION AND SEDIMENTATION FROM WORK ON THE SITE SHALL BE CONTAINED ON THE SITE AND NOT BE ALLOWED TO COLLECT ON ANY OFF-SITE AREAS, ROADWAYS OR WATERWAYS.
- 5. ALL MUD/SOIL TRACKED ONTO ROADWAYS FROM THE SITE DUE TO CONSTRUCTION, SHALL BE PROMPTLY REMOVED BY THE CONTRACTOR. IF SO ORDERED, THE CONTRACTOR SHALL PROVIDE AND OPERATE A VACUUM-TYPE STREET SWEEPER, AT NO ADDITIONAL COST TO THE CITY OF ANN ARBOR.
- 6. RESTORATION OF ALL DISTURBED AREAS, INCLUDING PLACEMENT OF TOPSOIL, SEED, FERTILIZER AND MULCH AND/OR SOD SHALL BE PERFORMED WITHIN FIVE (5) DAYS OF THE COMPLETION OF FINAL GRADE.
- 7. CONSTRUCTION OPERATIONS SHALL BE SCHEDULED AND PERFORMED SO THAT PREVENTATIVE SOIL EROSION CONTROL MEASURES ARE IN PLACE PRIOR TO EXCAVATION IN CRITICAL AREAS AND TEMPORARY STABILIZATION MEASURES ARE IN PLACE IMMEDIATELY FOLLOWING BACKFILLING OPERATIONS.
- 8. SPECIAL PRECAUTIONS WILL BE TAKEN IN THE USE OF CONSTRUCTION EQUIPMENT TO PREVENT SITUATIONS THAT PROMOTE EROSION.
- 9. PROPER DUST CONTROL SHALL BE MAINTAINED DURING CONSTRUCTION BY USE OF WATER TRUCKS AND/OR DUST PALLATIVE AS REQUIRED.
- 10. THE CONTRACTOR SHALL BE RESPONSIBLE FOR MAINTAINING ALL TEMPORARY SOIL EROSION CONTROL MEASURES AND REMOVAL OF SOME MEASURES UPON AUTHORIZED COMPLETION OF THE PROJECT. FINAL COMPLETION OF PROJECT WILL NOT BE AUTHORIZED UNTIL ALL SITE WORK AND UTILITY CONSTRUCTION IS COMPLETE AND ALL SOILS ARE STABILIZED.
- 11. THE CONTRACTOR SHALL NOT GRADE INTO ADJACENT PROPERTIES. SILT AND PROTECTIVE FENCE SHALL BE INSTALLED AND MAINTAINED TO PREVENT GRADING, EROSION AND SEDIMENTATION INTO THE ADJACENT PROPERTIES.
- 12. TREE PROTECTION FENCING MUST REMAIN INTACT UNTIL RESTORATION OF THE SITE IS COMPLETE.

SEQUENCE OF EROSION CONTROL MEASURES:

1. THE CONTRACTOR IS TO SUBMIT TO THE ENGINEER, A SEQUENCE OF CONSTRUCTION WITH RESPECT TO THE SOIL EROSION CONTROL MEASURES FOR REVIEW, COMMENT AND APPROVAL. THIS SCHEDULE IS TO INCLUDE INSPECTION AND REPAIR OF ALL TEMPORARY EROSION CONTROL MEASURES DAILY AND WITHIN 24 HOURS OF A STORM EVENT.

SAMPLE SOIL EROSION AND SEDIMENTATION CONTROL INSTALLATION MINIMUM

- 1.1. INSTALL SILT FENCE, TREE PROTECTION FENCING, MUD MATS, INLET FILTERS ON EXISTING DRAINAGE FEATURES, AND ALL OTHER TEMPORARY SOIL EROSION CONTROLS, PRIOR TO ANY CLEARING OR EARTH MOVING OPERATION.
- 1.2. STRIP AND STOCKPILE TOPSOIL. STABILIZE STOCKPILE AS REQUIRED.
- 1.3. PERFORM STATION GRADING OPERATIONS AND CONSTRUCT PAVEMENTS (MAINLINE, SIDEWALKS, DRIVES, ETC.).
- 1.4. CONTINUALLY MAINTAIN EROSION AND SEDIMENTATION CONTROL MEASURES. AS REQUIRED TO ALLOW DRAINAGE AND SEDIMENT REMOVAL. REMOVE ANY ACCUMULATED SEDIMENT IMMEDIATELY.
- 1.5. COMPLETE ALL FINE GRADING.
- 1.6. TEMPORARY SEED AND INSTALL EROSION CONTROL BLANKET IN ALL DISTURBED AREAS.
- 1.7. REFER TO PLANS FOR PERMANENT SITE STABILIZATION.
- 1.8. CLEAN OUT STORM SEWER SYSTEMS.
- 1.9. REMEDY ANY NOTED DEFECTS TO THE SATISFACTION OF THE CITY OF ANN ARBOR'S SOIL EROSION AND SEDIMENTATION CONTROL OFFICIAL.
- 1.10. ALL TEMP. SOIL EROSION CONTROL MEASURES MUST BE REMOVED, WITH ENGINEERS APPROVAL, PRIOR TO FINAL INSPECTION

NOTE: THIS SEQUENCE IS FOR INFORMATION ONLY. IT IS INTENDED TO SHOW THE SEQUENCE OF CONSTRUCTION WITH RESPECT TO THE SOIL EROSION AND SEDIMENTATION CONTROL MEASURES. THE CONTRACTOR IS RESPONSIBLE FOR SUBMITTING THEIR OWN DETAILED CONSTRUCTION SEQUENCE AND SCHEDULE TO THE ENGINEER FOR REVIEW, COMMENT, AND APPROVAL.

TEMPORARY SEEDING:

- SEED IN ACCORDANCE WITH PROJECT DRAWINGS AND SPECIFICATIONS.
- 2. ANY DISTURBED AREA NOT PAVED, SEEDED, MULCHED, SODDED OR BUILT UPON BY NOVEMBER 15TH OR JUNE 30TH IS TO BE TEMPORARILY STABILIZED PER SPECIFICATIONS.
- THE ESTIMATED COST OF SOIL EROSION AND SEDIMENTATION CONTROL MEASURES, TOPSOIL, SEEDING, AND MULCH = \$2,500

ON SITE SOILS PER THE USDA SOIL SURVEY OF WASHTENAW COUNTY. MICHIGAN: PLATT RD.

BnC - BOYER LOAMY SAND, 6 TO 12 PERCENT SLOPES

PRESCOTT AVE.

• StB - ST. CLAIR CLAY LOAM, 2 TO 6 PERCENT SLOPES

HUTCHINS AVE.

• StB - ST. CLAIR CLAY LOAM, 2 TO 6 PERCENT SLOPES

SAUNDERS CRES.

 WawabB — WAWASEE LOAM, 2 TO 6 PERCENT SLOPES WawabC — WAWASEE LOAM, 6 TO 12 PERCENT SLOPES

S. MAIN ST.

- MoB GLYNWOOD LOAM, 2 TO 6 PERCENT SLOPES
- Pe PEWAMO CLAY LOAM, O TO 2 PERCENT SLOPES

TRAVER ST./NIXON RD.

- Br BROOKSTON LOAM, 0 TO 2 PERCENT SLOPES
- WawabB WAWASEE LOAM, 2 TO 6 PERCENT SLOPES WawabC — WAWASEE LOAM, 6 TO 12 PERCENT SLOPES

ESTIMATE OF EXCAVATION AND FILL FROM **EXISTING TO FINAL GRADE:**

EXCAVATION = 20.9 CY, FILL = 4.4 CY

PERMITS REQUIRED TO BE OBTAINED BY THE CONTRACTOR DDIOD TO THE REGINNING OF CONSTRUCTION

| PERMIT | ISSUING AUTHORITY |
|--|------------------------------------|
| LANE CLOSURE PERMIT* | CITY OF ANN ARBOR ENGINEERING |
| "NO PARKING" SIGNS PERMIT* | CITY OF ANN ARBOR ENGINEERING |
| GRADING/SOIL EROSION & SEDIMENTATION CONTROL PERMIT* | CITY OF ANN ARBOR CUSTOMER SERVICE |
| RIGHT-OF-WAY PERMIT* | CITY OF ANN ARBOR CUSTOMER SERVICE |

| PUBLIC UTILITIES | OWNER | CONTACT |
|--------------------------|---|----------------------------------|
| | OWNER | CONTACT |
| WATER | | |
| SANITARY | | |
| STORM | CITY OF ANN ARBOR PUBLIC WORKS W.R. WHEELER SERVICE CENTER 4251 STONE SCHOOL ROAD | (734) 794–6350 |
| FORESTRY | ANN ARBOR, MI 48108 | |
| SIGNS | | MARK MORENO |
| SIGNALS STREET LIGHTS | | (734) 794–6361 |
| | OWNED | CONTACT |
| PRIVATE UTILITIES | OWNER | CONTACT |
| GAS | DTE ENERGY 3150 E. MICHIGAN AVE, YPSILANTI TOWNSHIP, MI 48198 | (734) 544-7818 |
| ELECTRIC | DTE ENERGY WESTERN WAYNE SERVICE CENTER 8001 HAGGERTY ROAD BELLEVILLE, MI 48111 | ANTHONY IGNASI (734) 397-4447 |
| CABLE | COMCAST 27800 FRANKLIN ROAD SOUTHFIELD, MI 48034 | RON SOUTHERLA (313) 999-8300 |
| PHONE | AT&T 550 S. MAPLE ROAD ANN ARBOR, MI 48103 | MARC GOODELL (313) 405-0574 |
| FIBER OPTIC | MCI 2800 N. GLENFILLE ROAD RICHARDSON, TX 75082 | DEAN BOYERS (972) 729-6016 |
| FIBER OPTIC | WINDSTREAM 1295 S LINDEN ROAD, SUITE B FLINT, MI 48532 | GREG SERICH (810) 244-3500 |
| STREET LIGHTING | DTE ENERGY 8001 HAGGERTY ROAD BELLEVILLE, MI 48111 | LANCE ALLEY (734) 397-4188 |

| | SAUNDERS CRESCENT BENCHMARKS | | |
|------|------------------------------|--|--|
| BM# | ELEV | DESCRIPTION | |
| 1 | 954.85 | NORTH SIDE OF DRIVEWAY, NW CORNER OF SIDEWALK WHERE IT MEETS THE DRIVE | |
| CPT1 | 964.00 | CONTROL PT #1, TOP OF PK NAIL IN ASPHALT | |

| | | PLATT ROAD BENCHMARKS |
|-----|--------|--|
| BM# | ELEV | DESCRIPTION |
| 1 | 816.06 | SE CORNER OF CONCRETE WHERE SIDEWALKS MEET |
| 2 | 817.04 | SPIKE IN WEST SIDE OF POWER POLE |

| | | S MAIN ST BENCHMARKS |
|------|--------|--|
| BM# | ELEV | DESCRIPTION |
| 1 | 890.95 | CENTER OF TELEPHONE MANHOLE |
| CPT2 | 891.39 | CONTROL PT #2, TOP OF PK NAIL IN ASPHALT |


| | HUTCHINS AVE BENCHMARKS | |
|-----|-------------------------|-------------------------------|
| BM# | ELEV | DESCRIPTION |
| 1 | 921.00 | CENTER OF GAS VALVE STRUCTURE |

| | | PRESCOTT AVE BENCHMARKS |
|-----|--------|--------------------------------------|
| BM# | ELEV | DESCRIPTION |
| 1 | 912.55 | CENTER OF CATCH BASIN AT GUTTER LINE |



ARI

CITY SHEET No.

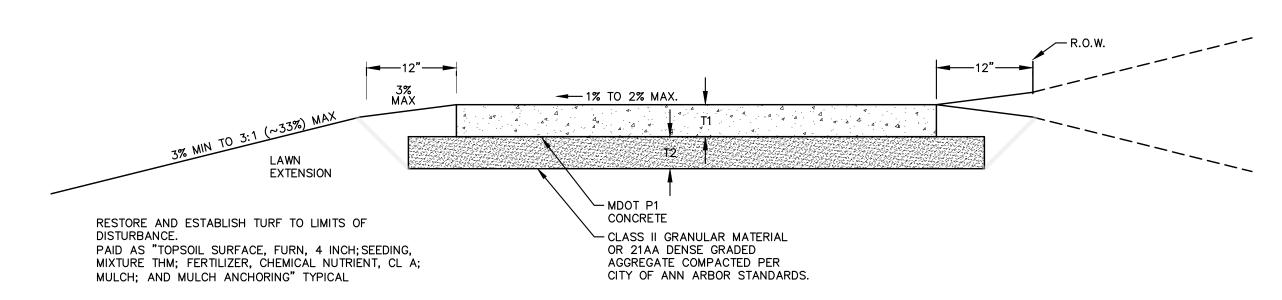

- 1. SIDEWALK SHALL BE A DESIGNED AND CONSTRUCTED TO MEET ALL ADA STANDARDS AND REQUIREMENTS.
- 2. CITY OF ANN ARBOR MINIMUM STANDARD WIDTH OF SIDEWALK IS FIVE (5) FEET.
- 3. CONCRETE SIDEWALK THICKNESS (T1) SHALL BE A MINIMUM OF FOUR (4) INCHES.
- 4. SIDEWALK THICKNESS (T1) SHALL BE INCREASED AT DRIVE APPROACHES TO SIX (6) INCHES FOR SINGLE-FAMILY OR DUPLEX RESIDENTIAL USES. ALL OTHER USES REQUIRE A MINIMUM EIGHT (8) INCH THICKNESS WITHIN THE DRIVE APPROACH.
- 5. BASE THICKNESS (T2) SHALL BE A MINIMUM OF FOUR (4) INCHES.


STANDARD DETAILS AND SPECIFICATIONS.


- 6. THICKNESS OF THE BASE (T2) SHALL BE INCREASED TO A MINIMUM OF SIX (6) INCHES WITHIN THE DRIVE APPROACH.
- 7. IF EXISTING SUBGRADE MATERIAL IS APPROVED BY THE ENGINEER FOR USE, COMPACT THE EXISTING SUBGRADE TO 95% OF THE MATERIAL'S MAXIMUM DRY DENSITY.
- 8. NATIVE MATERIAL MAY BE ACCEPTABLE FOR SIDEWALK CONSTRUCTION, IF THE BASE IS STABLE AND FREE OF ORGANIC OR DELETERIOUS MATERIALS.
- 9. SIDEWALK RAMPS SHALL BE CONSTRUCTED AT STREET INTERSECTIONS AS DIRECTED AND SHALL COMPLY WITH THE REQUIREMENTS OF MDOT DETAIL R-28 (LATEST VERSION).
- FEATURES. 11. EXPANSION AND CONTRACTION JOINTS SHALL BE PROVIDED PER CITY OF ANN ARBOR

10. SIDEWALKS MAY MEANDER WITHIN THE RIGHT-OF-WAY TO PROTECT AND PRESERVE NATURAL


SIDEWALK CROSS SECTION, SD-R-9

| ΞX | ISTING LEGEND | | | PF | OPOSED LEGEND | |
|------------------|------------------------------|---|--|--------------------------|-------------------------|----------------|
| <u></u> | FIRE HYDRANT | | WATER MAIN | | | |
| ₹' • | GATE VALVE IN BOX | | WATER MAIN ABANDONED | • | HYDRANT (PLAN) | |
| • ⊗ | GATE VALVE IN WELL | | STORM SEWER | ⊗ | WATER GATE WELL REDUCER | |
| e) | STOP BOX | | STORM SEWER ABANDONED | V | WATER GATE VALVE | |
| w | WATER VAULT | s | SANITARY SEWER | • | WATER STOP BOX | |
| D | WELL | // | SANITARY SEWER ABANDONED | W | WATER VAULT | |
| | CATCH BASIN (SQ) | g | GAS MAIN | • | INLET | |
| ₽ | CATCH BASIN (RD) | — g (Dead)—— —— —— —— | GAS MAIN (DEAD) | | | |
| O | STORM MANHOLE | o\\\\o | ELECTRICAL OVER HEAD | • | INLET JUNCTION CHAMBER | : · |
| | NON-CURB CATCH BASIN (SQ) | | ELECTRICAL UNDER GROUND | | ROUND CATCH BASIN | |
|) | END SECTION | e duct bank | ELECTRICAL DUCT BANK | 0 | STORM MANHOLE | |
| O | SANITARY MANHOLE | · oht · | TELEPHONE OVER HEAD | • | DRAIN ARROW | . • |
| O | CLEAN-OUT | · t · | TELEPHONE UNDER GROUND | | FLARED END SECTION | |
| | POST | t duct bank | TELEPHONE DUCT BANK | | SANITARY MANHOLE | |
| ₽ | PEDESTRIAN SIGNAL | ohtv | CABLE TV OVER HEAD | © | CLEAN-OUT | |
| <u> </u> | SIGN | | CABLE TV UNDER GROUND | • | BARREL | |
| | HAND HOLE | fo | FIBER OPTIC | | SIGN | |
| ₹. * <u>.</u> | ORNAMENTAL LIGHT FLOOD LIGHT | fo duct bank | FIBER OPTIC DUCT BANK | | PUSH BUTTON | |
| ก | UNKNOWN MANHOLE | | BOUNDARY | • | HAND HOLE | |
| 9 9) | TELEPHONE MANHOLE | | BUILDING | | | |
| à | TELEPHONE RISER | | CENTERLINE OF DITCH | | | |
| _ | GAS VALVE | | CENTERLINE/CROWN OF ROAD | | | |
|) | GAS VENT | | CONTOUR MAJOR | | | (=0(=0) |
| ∄ | GAS BOX | | CONTOUR MINOR | | | مست |
| Ž | ELECTRICAL RISER | | EDGE OF WATER | | | |
| \leq | TRANSFORMER | | FLOODPLAIN | | | |
| of . | UTILITY POLE | | FENCE | | | |
| \supset | LAMP POLE | ::: | GRAVEL | | | |
| - | GUY ANCHOR | | GUARDRAIL | | | |
| 7 | GUY POLE | 000000000000000000000000000000000000000 | STONE WALL | | | |
| IW) | MONITORING WELL | | R.O.W. | | | |
| W. | MAILBOX | | TREELINE | | | |
| • | SOIL BORING | \ullip\ullip\ullip | WETLAND | | | |
| •\ | TRAVERSE POINT | | EDGE OF BRUSH | | | |
| ۲ ` | BENCH MARK | | HEDGE | | | |
| , ∘ | IRON PIPE MON BOX | | | | | |
| צ | MON BOX | | | | | |
| | | | TREE (DECIDUOUS) | | | |
| | | | | | | |
| | | | | | | |
| | | | | | | |
| | | Z . 7 | TREE (CONIFEROUS) | | | |
| | | | THEE (GOIVII ENGOS) | | | |
| | | | | | | |
| | | | | | | |
| | | £(`)} | SHRUB (DECIDUOUS) | | | |
| | | | | | | |
| | | | STUMP | | | |
| | | | | | | |
| | | | R.7. | | | |
| | | | TREE TO REMAIN & PROTECT (DECIDUOUS) | | | |
| | | | CRITICAL ROOT ZONE (C.R.Z.) = DIAMETER | R BREAST HEIGHT (IN | NCHES) X 10 | |
| | | | | | | |
| | | . ^ | 1 | | | |
| | | LMY C.F | 3.4. | | | |
| | | > ~~ | TREE TO REMAIN & PROTECT (CONIFEROUS) CRITICAL ROOT ZONE (C.R.Z.) = DIAMETER |) R BREAST HEIGHT (IN | NCHES) X 10 | |
| | | Z | (/ | | • | |
| | | VV | | | | |
| | | | | | | |
| | | | | | | |
| | | | | | | |
| | | | | | | |

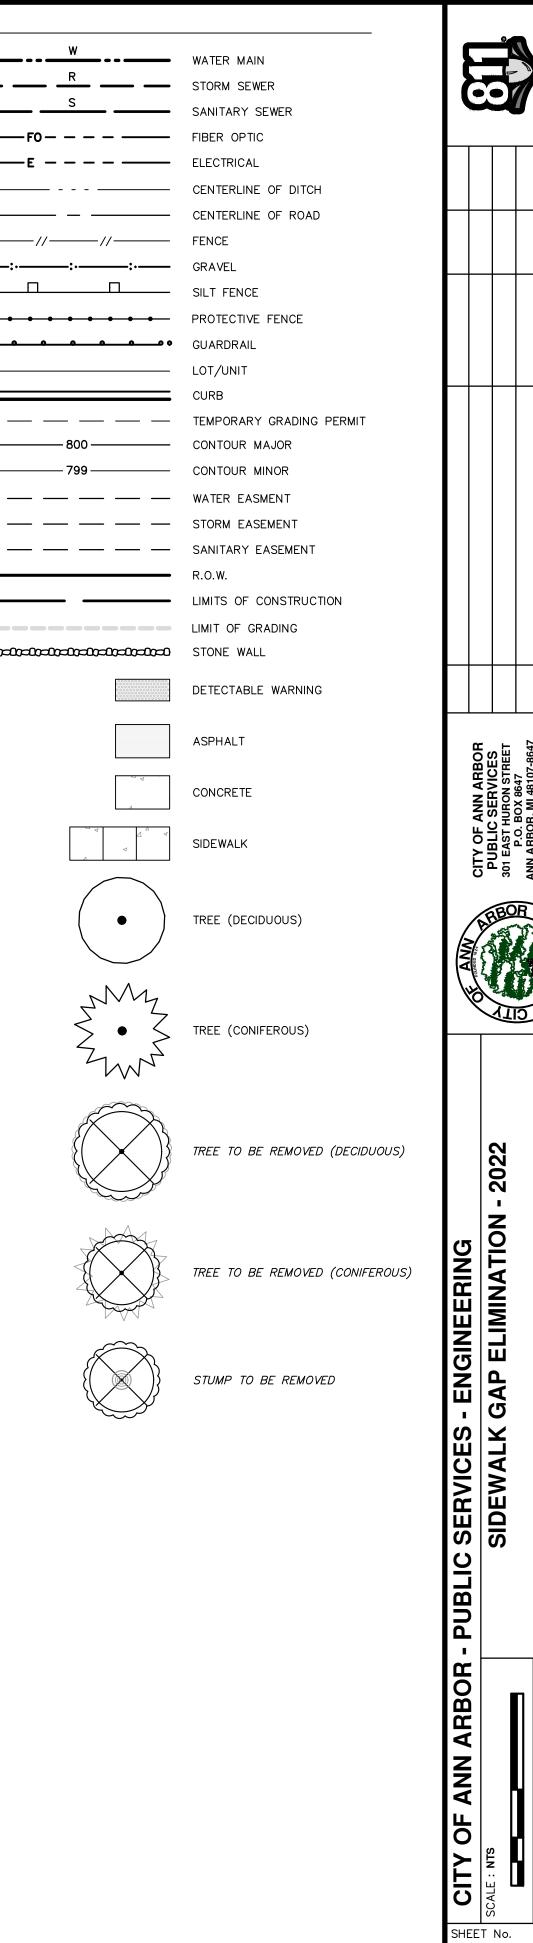

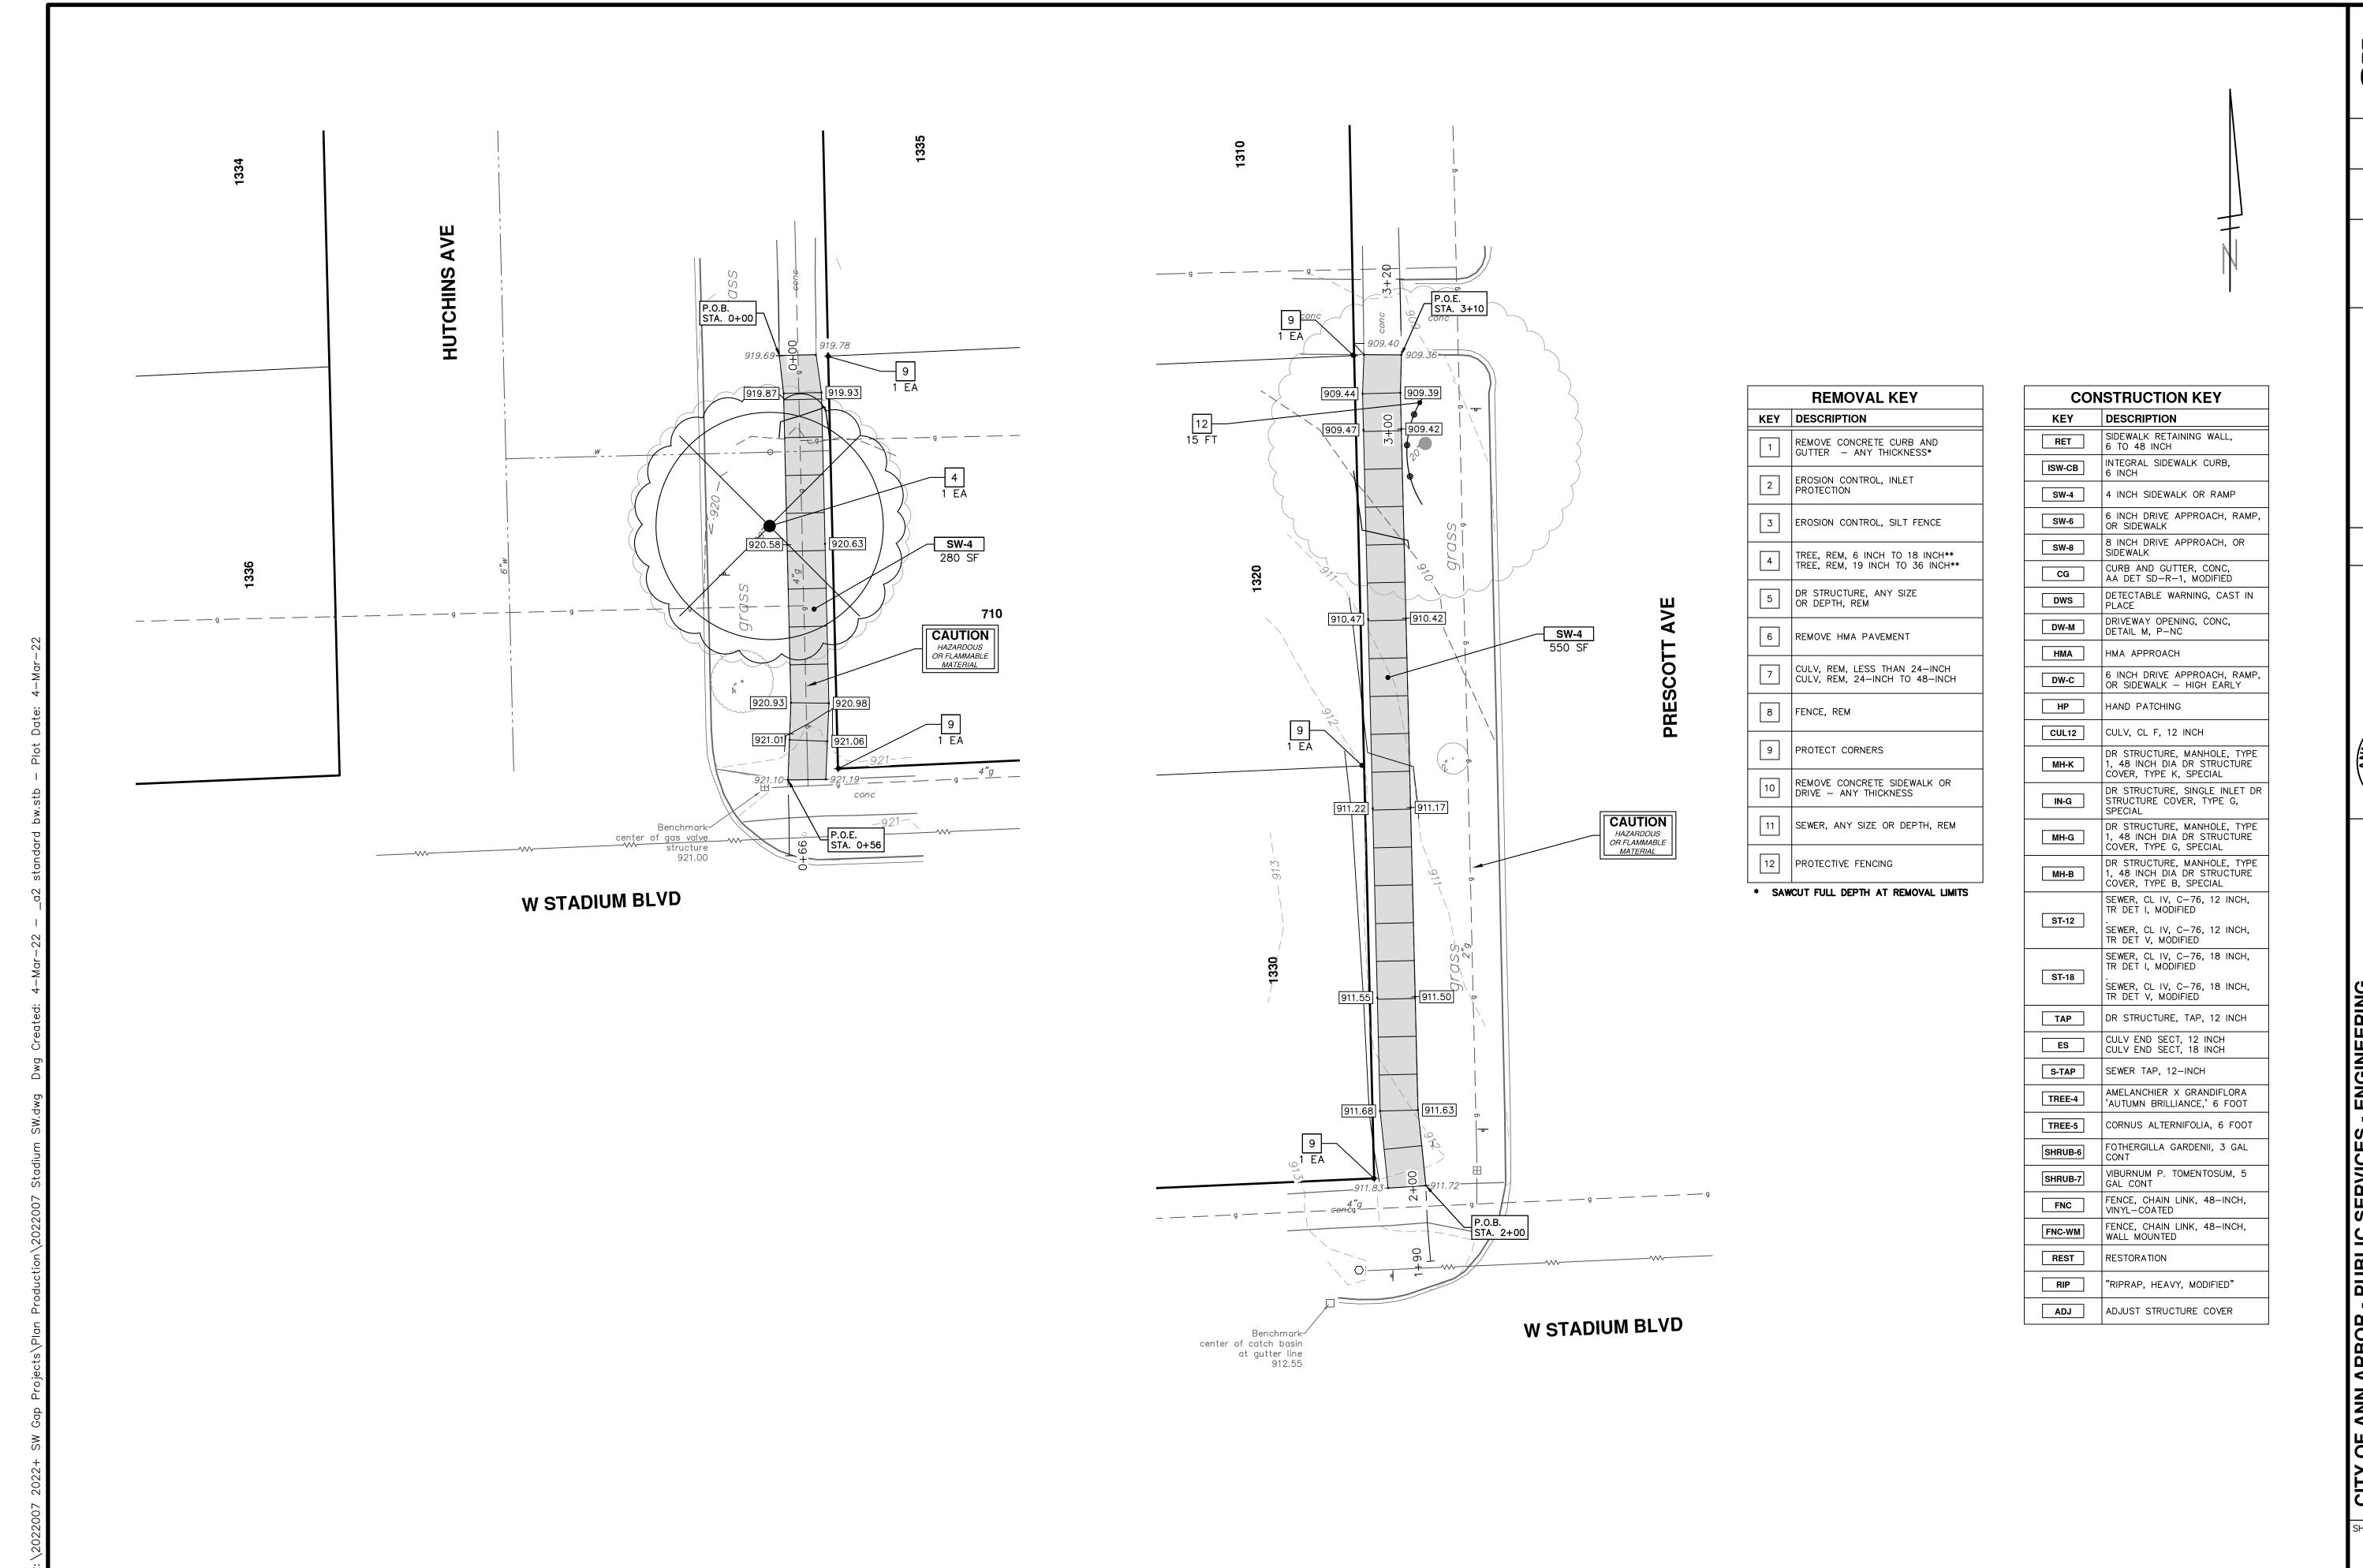


CITY OF ANN ARBOR - PUBLIC SHEET No. 4 OF 24

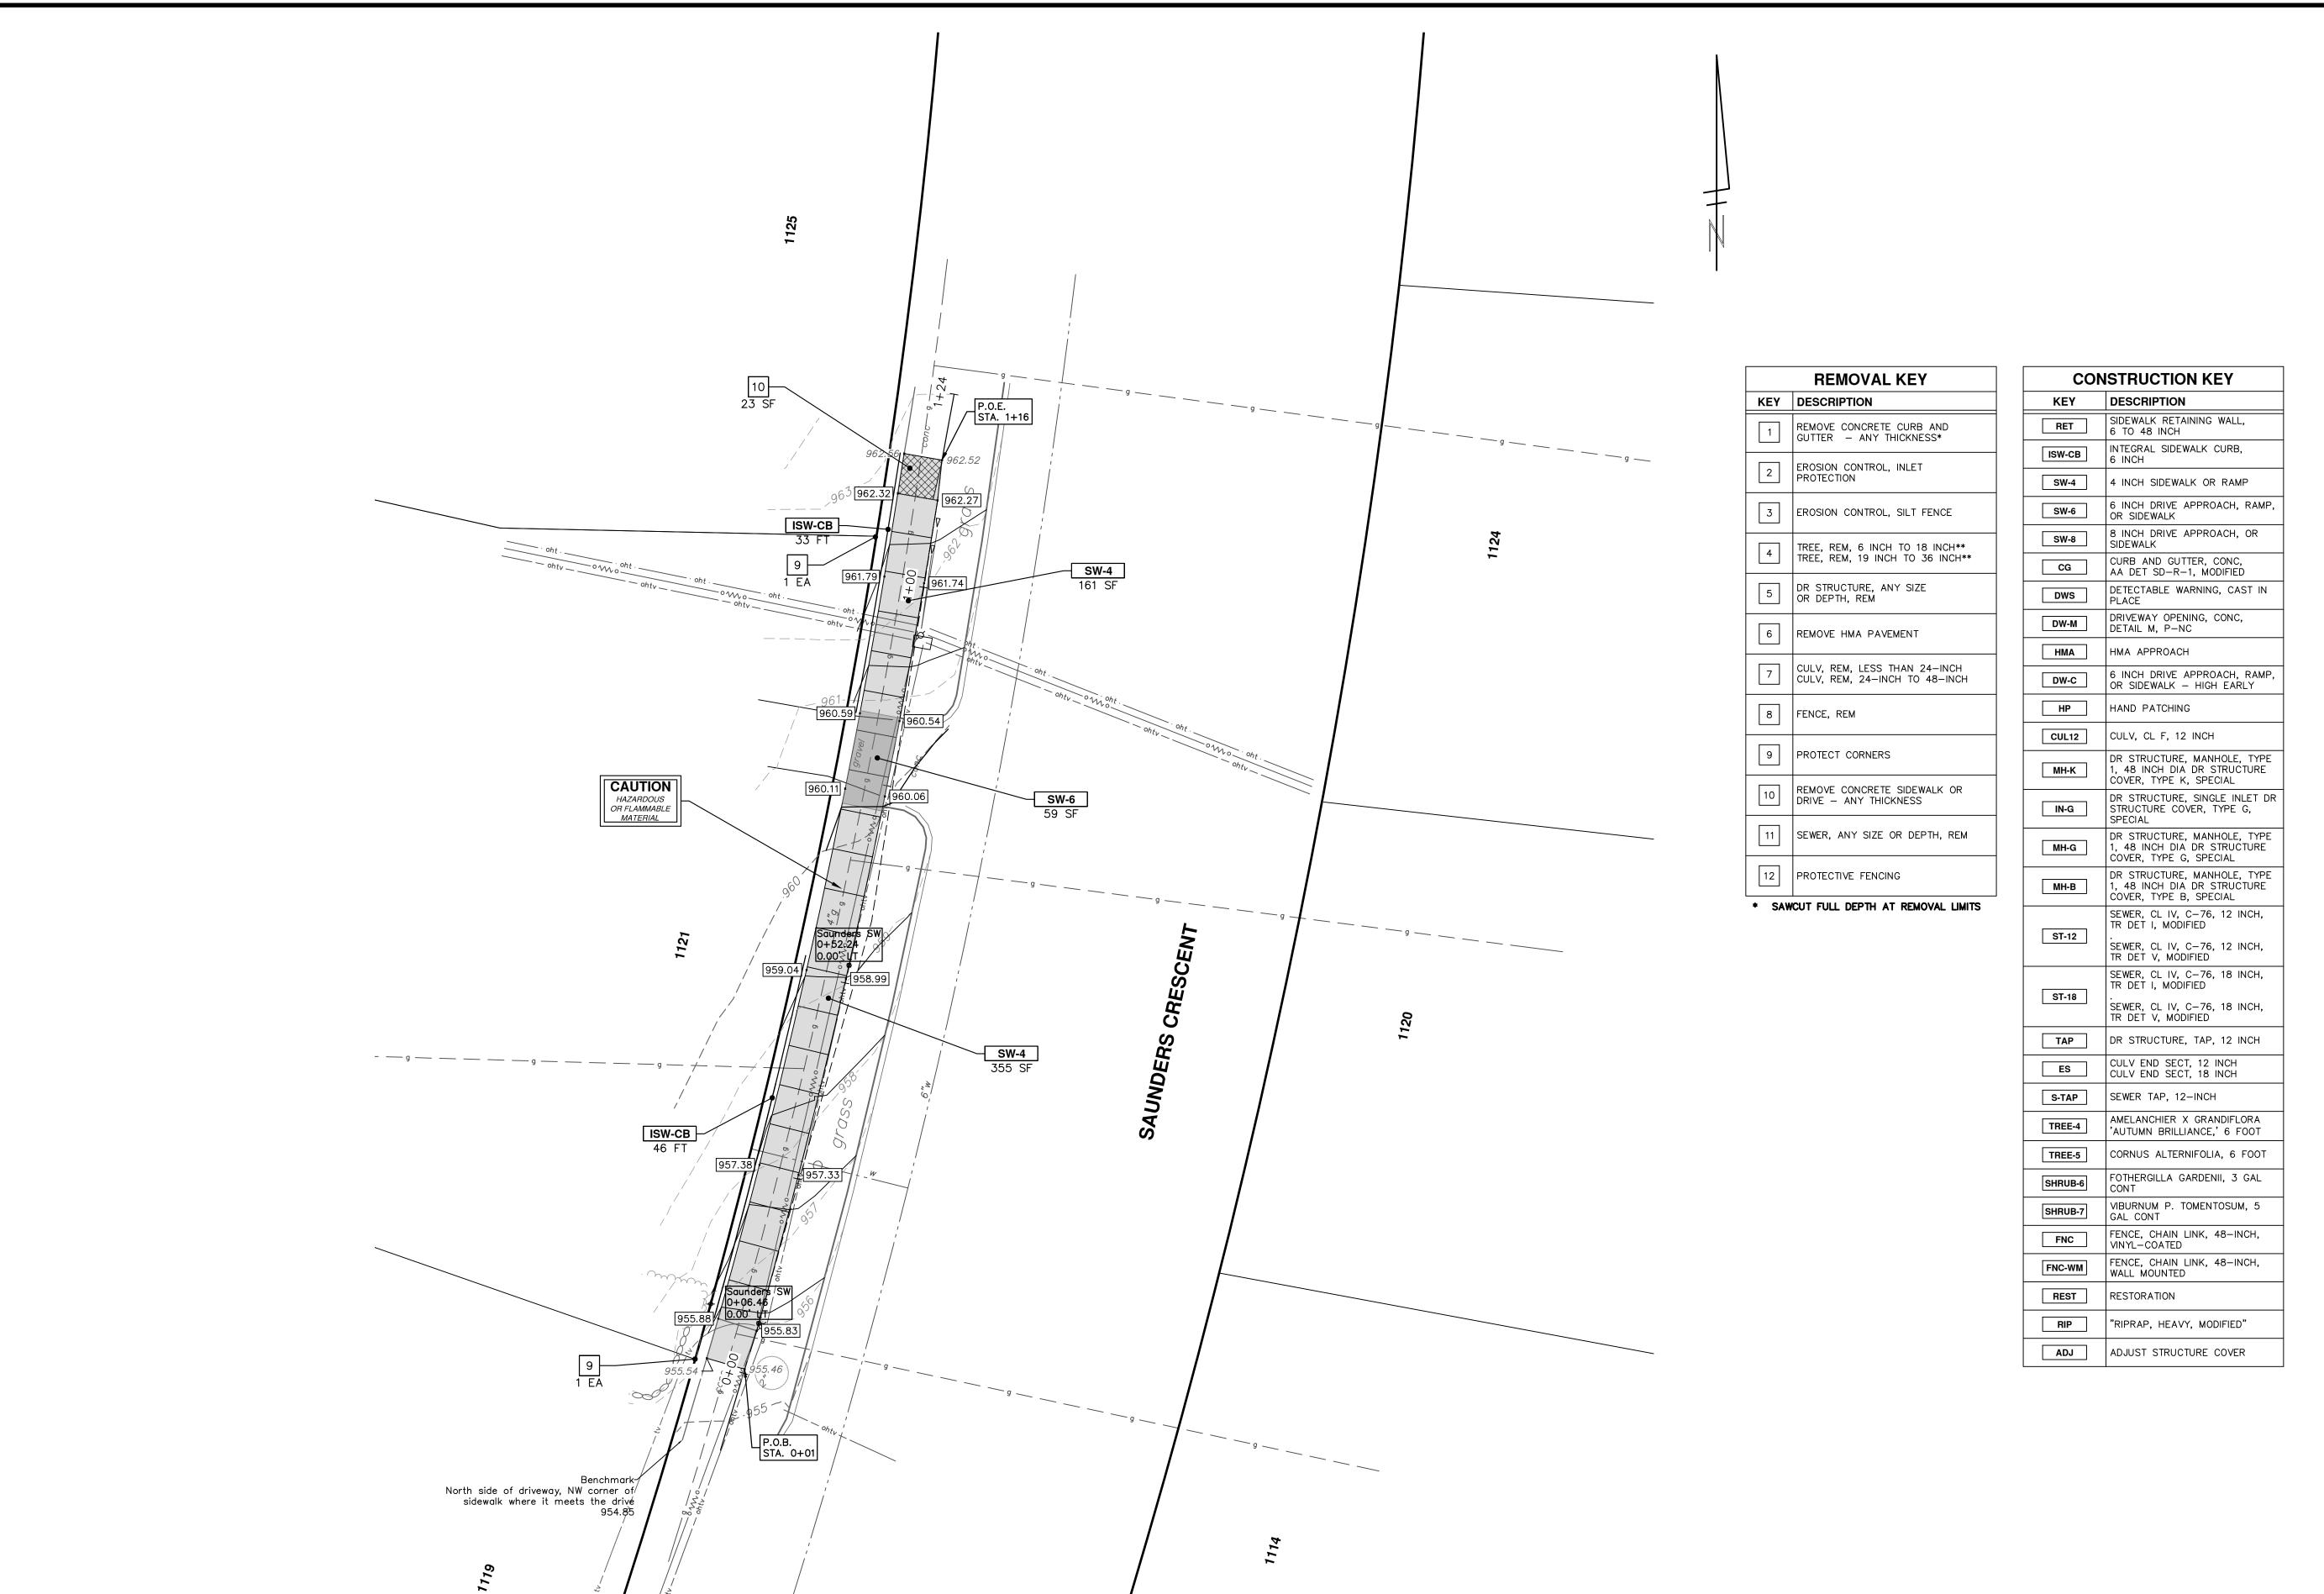


| CON | STRUCTION KEY |
|---------|--|
| KEY | DESCRIPTION SIDEWALK RETAINING WALL, |
| RET | 6 TO 48 INCH INTEGRAL SIDEWALK CURB, |
| ISW-CB | 6 INCH |
| SW-4 | 4 INCH SIDEWALK OR RAMP 6 INCH DRIVE APPROACH, RAMP, |
| SW-6 | OR SIDEWALK |
| SW-8 | 8 INCH DRIVE APPROACH, OR SIDEWALK |
| CG | CURB AND GUTTER, CONC, AA DET SD-R-1, MODIFIED |
| DWS | DETECTABLE WARNING, CAST IN PLACE |
| DW-M | DRIVEWAY OPENING, CONC, DETAIL M, P-NC |
| НМА | HMA APPROACH |
| DW-C | 6 INCH DRIVE APPROACH, RAMP, OR SIDEWALK — HIGH EARLY |
| HP | HAND PATCHING |
| CUL12 | CULV, CL F, 12 INCH |
| МН-К | DR STRUCTURE, MANHOLE, TYPE 1, 48 INCH DIA DR STRUCTURE COVER, TYPE K, SPECIAL |
| IN-G | DR STRUCTURE, SINGLE INLET DR STRUCTURE COVER, TYPE G, SPECIAL |
| MH-G | DR STRUCTURE, MANHOLE, TYPE 1, 48 INCH DIA DR STRUCTURE COVER, TYPE G, SPECIAL |
| МН-В | DR STRUCTURE, MANHOLE, TYPE 1, 48 INCH DIA DR STRUCTURE COVER, TYPE B, SPECIAL |
| | SEWER, CL IV, C-76, 12 INCH, TR DET I, MODIFIED |
| ST-12 | SEWER, CL IV, C-76, 12 INCH, TR DET V, MODIFIED |
| ST-18 | SEWER, CL IV, C-76, 18 INCH, TR DET I, MODIFIED |
| 31-10 | SEWER, CL IV, C-76, 18 INCH, TR DET V, MODIFIED |
| TAP | DR STRUCTURE, TAP, 12 INCH |
| ES | CULV END SECT, 12 INCH CULV END SECT, 18 INCH |
| S-TAP | SEWER TAP, 12-INCH |
| TREE-4 | AMELANCHIER X GRANDIFLORA 'AUTUMN BRILLIANCE,' 6 FOOT |
| TREE-5 | CORNUS ALTERNIFOLIA, 6 FOOT |
| SHRUB-6 | FOTHERGILLA GARDENII, 3 GAL CONT |
| SHRUB-7 | VIBURNUM P. TOMENTOSUM, 5 GAL CONT |
| FNC | FENCE, CHAIN LINK, 48-INCH, VINYL-COATED |
| FNC-WM | FENCE, CHAIN LINK, 48—INCH, WALL MOUNTED |
| REST | RESTORATION |
| RIP | "RIPRAP, HEAVY, MODIFIED" |
| ADJ | ADJUST STRUCTURE COVER |

CITY OF ANN ARBOR - PUBLIC SERVICES - ENGINEERING
SCALE PLAN: 1"= 10" SIDEWALK GAP ELIMINATION

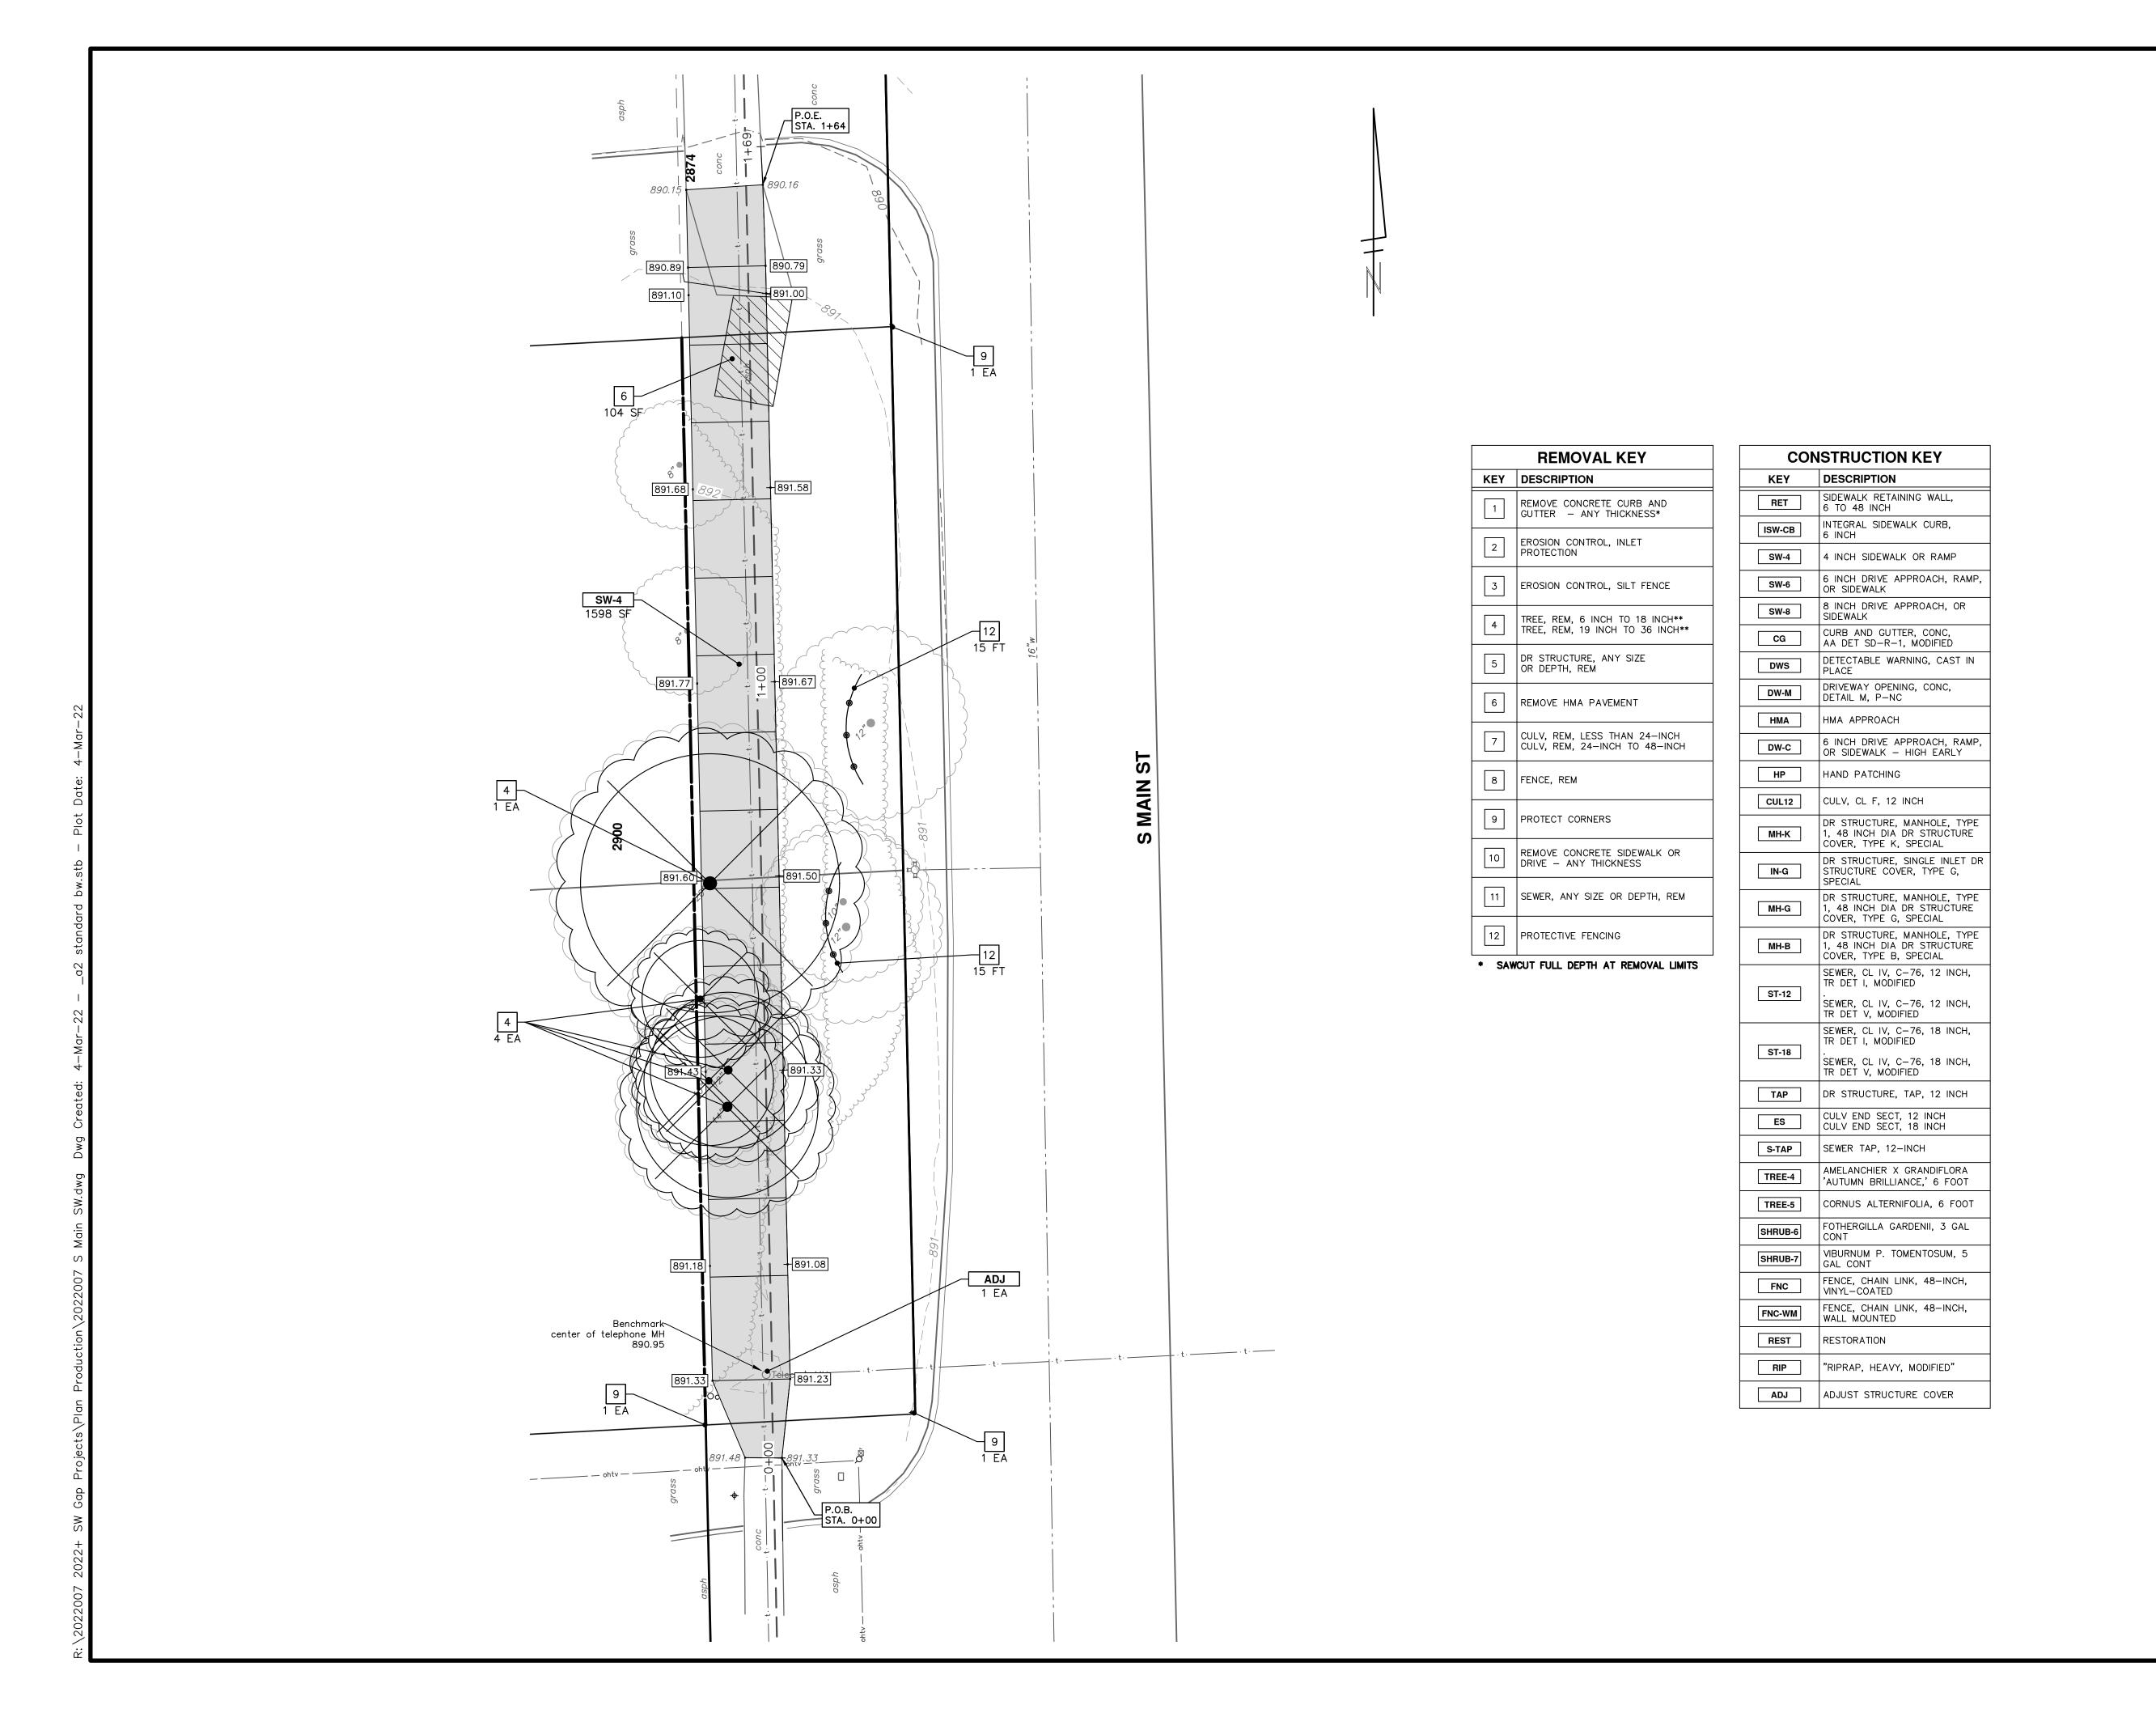


CITY OF ANN ARBOR - PUBLIC SHEET No. 6 OF 24

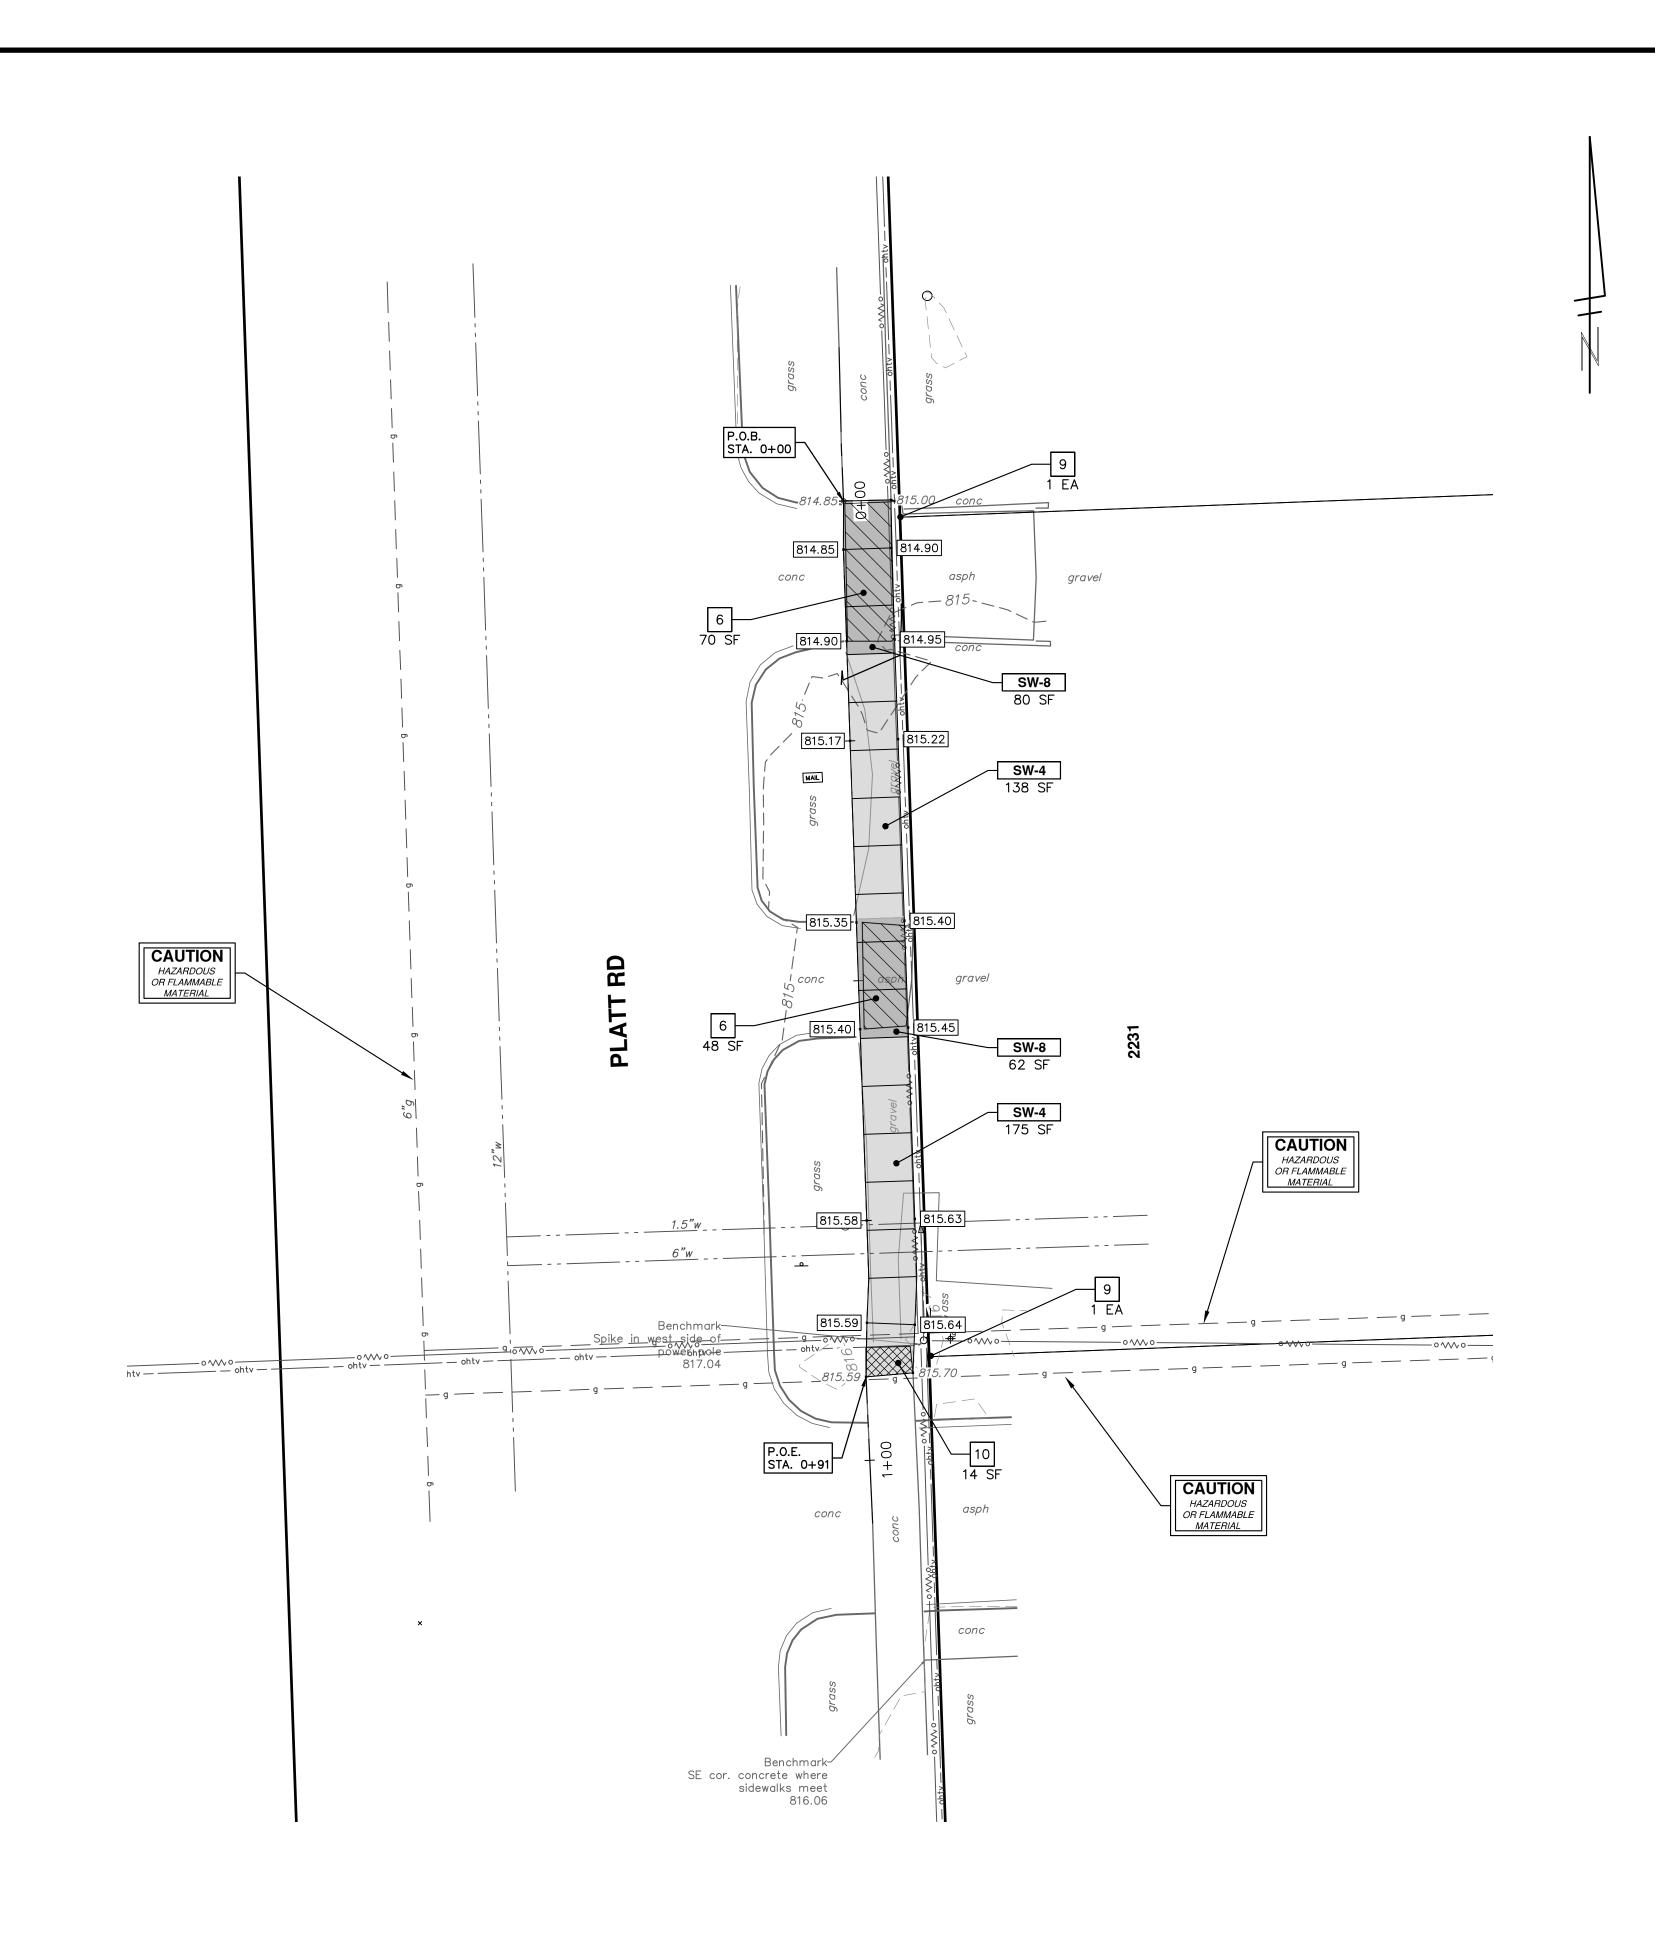

| | REMOVAL KEY |
|-----|--|
| KEY | DESCRIPTION |
| 1 | REMOVE CONCRETE CURB AND GUTTER — ANY THICKNESS* |
| 2 | EROSION CONTROL, INLET PROTECTION |
| 3 | EROSION CONTROL, SILT FENCE |
| 4 | TREE, REM, 6 INCH TO 18 INCH** TREE, REM, 19 INCH TO 36 INCH** |
| 5 | DR STRUCTURE, ANY SIZE OR DEPTH, REM |
| 6 | REMOVE HMA PAVEMENT |
| 7 | CULV, REM, LESS THAN 24-INCH CULV, REM, 24-INCH TO 48-INCH |
| 8 | FENCE, REM |
| 9 | PROTECT CORNERS |
| 10 | REMOVE CONCRETE SIDEWALK OR DRIVE — ANY THICKNESS |
| 11 | SEWER, ANY SIZE OR DEPTH, REM |
| 12 | PROTECTIVE FENCING |

* SAWCUT FULL DEPTH AT REMOVAL LIMITS

| CO | NSTRUCTION KEY |
|---------|--|
| KEY | DESCRIPTION |
| RET | SIDEWALK RETAINING WALL, 6 TO 48 INCH |
| ISW-CB | INTEGRAL SIDEWALK CURB, 6 INCH |
| SW-4 | 4 INCH SIDEWALK OR RAMP |
| SW-6 | 6 INCH DRIVE APPROACH, RAMP, OR SIDEWALK |
| SW-8 | 8 INCH DRIVE APPROACH, OR SIDEWALK |
| CG | CURB AND GUTTER, CONC, AA DET SD-R-1, MODIFIED |
| DWS | DETECTABLE WARNING, CAST IN PLACE |
| DW-M | DRIVEWAY OPENING, CONC, DETAIL M, P-NC |
| НМА | HMA APPROACH |
| DW-C | 6 INCH DRIVE APPROACH, RAMP, OR SIDEWALK — HIGH EARLY |
| HP | HAND PATCHING |
| CUL12 | CULV, CL F, 12 INCH |
| МН-К | DR STRUCTURE, MANHOLE, TYPE 1, 48 INCH DIA DR STRUCTURE COVER, TYPE K, SPECIAL |
| IN-G | DR STRUCTURE, SINGLE INLET DR STRUCTURE COVER, TYPE G, SPECIAL |
| MH-G | DR STRUCTURE, MANHOLE, TYPE 1, 48 INCH DIA DR STRUCTURE COVER, TYPE G, SPECIAL |
| МН-В | DR STRUCTURE, MANHOLE, TYPE 1, 48 INCH DIA DR STRUCTURE COVER, TYPE B, SPECIAL |
| ST-12 | SEWER, CL IV, C-76, 12 INCH, TR DET I, MODIFIED |
| 01-12 | SEWER, CL IV, C-76, 12 INCH, TR DET V, MODIFIED |
| ST-18 | SEWER, CL IV, C-76, 18 INCH, TR DET I, MODIFIED |
| | SEWER, CL IV, C-76, 18 INCH, TR DET V, MODIFIED |
| TAP | DR STRUCTURE, TAP, 12 INCH |
| ES | CULV END SECT, 12 INCH CULV END SECT, 18 INCH |
| S-TAP | SEWER TAP, 12-INCH |
| TREE-4 | AMELANCHIER X GRANDIFLORA 'AUTUMN BRILLIANCE,' 6 FOOT |
| TREE-5 | CORNUS ALTERNIFOLIA, 6 FOOT |
| SHRUB-6 | FOTHERGILLA GARDENII, 3 GAL CONT |
| SHRUB-7 | VIBURNUM P. TOMENTOSUM, 5 GAL CONT |
| FNC | FENCE, CHAIN LINK, 48-INCH, VINYL-COATED |
| FNC-WM | FENCE, CHAIN LINK, 48-INCH, WALL MOUNTED |
| REST | RESTORATION |
| RIP | "RIPRAP, HEAVY, MODIFIED" |
| ADJ | ADJUST STRUCTURE COVER |

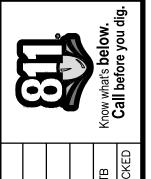

| DRAWN | DATE | DESCRIPTION | EV. |
|----------|--------|---------------|-----|
| KB/DF/CC | 3-4-22 | 00 OUT TO BID | 00 |
| | | | |
| | | | |
| | | | |
| | | | |



CITY OF ANN ARBOR - PUBLIC SERVICES - ENGINEERING

SCALE PLAN: 1" = 10" SIDEWALK GAP ELIMINATION

CONSTRUCTION NOTES:

- DRIVEWAYS, SIDEWALKS AND ENTRANCES TO REAL PROPERTY, AND THE LIKE SHALL NOT BE BLOCKED EXCEPT FOR SHORT DURATIONS AND ONLY WHEN APPROVED BY THE ENGINEER. VEHICULAR AND PEDESTRIAN ACCESS SHALL BE MAINTAINED AT ALL TIMES. IT SHALL BE THE CONTRACTOR'S RESPONSIBILITY TO COORDINATE ALL NECESSARY DRIVEWAY CLOSURES WITH THE PROPERTY OWNER(S) AND RESIDENT(S) IN THE AREAS OF CONSTRUCTION.
- 2. THE LOCATION AND DEPTH OF ALL EXISTING UTILITIES AND SERVICE LEADS ARE TO BE FIELD VERIFIED BY THE CONTRACTOR PRIOR TO CONSTRUCTION.
- 3. LOCATION AND DEPTH OF UTILITIES AS DEPICTED ON THE PLANS IS APPROXIMATE AND SHOWN ACCORDING TO THE BEST INFORMATION AVAILABLE. IT IS THE CONTRACTOR'S RESPONSIBILITY TO EXCAVATE AHEAD AND ADJUST DEPTH OF CONFLICT UTILITIES ACCORDINGLY. ANY DAMAGE TO UTILITIES IS THE CONTRACTOR'S RESPONSIBILITY TO AVOID AND/OR REPAIR AS NECESSARY.
- 4. DURING NON-WORKING HOURS NO TRENCH SHALL REMAIN OPEN
- 5. THE CONTRACTOR SHALL BACKFILL TRENCHES IN ACCORDANCE WITH TRENCH DETAIL SPECIFIED ON PLANS. ALL CONCRETE REMOVALS AND REPLACEMENTS REQUIRED FOR THIS WORK WILL BE PAID FOR SEPARATELY.
- 10. POSTAL DELIVERY AND REFUSE PICKUP SERVICE SHALL BE MAINTAINED AT ALL TIMES BY THE CONTRACTOR.
- 11. THE CONTRACTOR SHALL BE RESPONSIBLE FOR THE CONTINUOUS MAINTENANCE OF THE TEMPORARY SOIL EROSION CONTROL MEASURES WITHIN THE CONSTRUCTION AREA UNTIL THE FULL COMPLETION OF THE PROJECT. THIS WORK SHALL BE INCLUDED IN THE VARIOUS EROSION CONTROL ITEMS OF WORK.
- 12. ALL CURB, SIDEWALK, DRIVEWAY APPROACH REMOVALS SHALL BE APPROVED BY ENGINEER BEFORE THE WORK IS DONE.
- 13. THE LOCATION OF MATERIAL STOCK PILES AND ON-SITE STAGING AREAS ARE TO BE APPROVED BY THE ENGINEER.
- 14. EXISTING STREET NAME, GUIDE, AND REGULATORY SIGNS, AND MAILBOXES WHICH CONFLICT WITH THE PROPOSED CONSTRUCTION SHALL BE REMOVED PRIOR TO CONSTRUCTION, STORED IN A MANNER WHICH WILL PREVENT DAMAGE, AND RE-SET IN LOCATIONS AS DIRECTED BY THE ENGINEER. THIS WORK WILL NOT BE PAID FOR SEPARATELY, BUT SHALL BE INCLUDED IN "SIDEWALK GRADING"

SOIL EROSION AND SEDIMENTATION CONTROL NOTES

NOTIFY THE CITY OF ANN ARBOR SOIL EROSION CONTROL OFFICE 48 HOURS PRIOR TO BEGINNING WORK ON THE PROJECT. PHONE: 734-794-6265.

- THE CONTRACTOR SHALL IMPLEMENT AND MAINTAIN THE SOIL EROSION CONTROL MEASURES AS SHOWN ON THE PLANS AND AS DIRECTED BY THE ENGINEER AT ALL TIMES DURING CONSTRUCTION. ANY MODIFICATIONS OR ADDITIONS TO THE SOIL EROSION CONTROL MEASURES DUE TO CONSTRUCTION OR CHANGED CONDITIONS SHALL BE AS DIRECTED AND APPROVED BY THE ENGINEER.
- 2. ALL SOIL EROSION AND SEDIMENTATION CONTROL WORK SHALL CONFORM TO THE PERMIT REQUIREMENTS OF THE CITY OF ANN ARBOR. CITY ORDINANCE CHAPTER 63. CITY OF ANN ARBOR STANDARDS DIVISION VII, THE LAWS OF THE STATE OF MICHIGAN, 4. INSPECT & REPAIR OR REPLACE ALL TEMPORARY SESC MEASURES WEEKLY AND WITHIN AND THE REQUIREMENTS OF THE CONTRACT DOCUMENTS.
- 3. DAILY, OR AFTER ANY STORM EVENT, INSPECTIONS OF EROSION CONTROL MEASURES SHALL BE MADE BY THE CONTRACTOR. PERIODIC INSPECTIONS MAY BE MADE BY THE ENGINEER TO DETERMINE THE EFFECTIVENESS OF EROSION AND SEDIMENTATION CONTROL MEASURES. ANY NECESSARY CORRECTIONS SHALL BE MADE WITHOUT DELAY, AND WITHOUT ADDITIONAL COST TO THE CITY OF ANN ARBOR.
- 4. EROSION AND SEDIMENTATION FROM WORK ON THE SITE SHALL BE CONTAINED ON THE SITE AND NOT BE ALLOWED TO COLLECT ON ANY OFF-SITE AREAS, ROADWAYS OR WATERWAYS.
- 5. ALL MUD/SOIL TRACKED ONTO ROADWAYS FROM THE SITE DUE TO CONSTRUCTION, SHALL BE PROMPTLY REMOVED BY THE CONTRACTOR. IF SO ORDERED, THE CONTRACTOR SHALL PROVIDE AND OPERATE A VACUUM-TYPE STREET SWEEPER, AT NO ADDITIONAL COST TO THE CITY OF ANN ARBOR, WITHIN FOUR (4) HOURS OF BEING SO ORDERED.
- 6. ALL AREAS TO BE PERMANENTLY RESTORED WITH GRASS SHALL RECIEVE TOPSOIL HYDROSEED, AND STAKED EROSION CONTROL BLANKETS (MULCH BLANKETS) AND SHALL 2. ANY DISTURBED AREA NOT PAVED, SEEDED, MULCHED, SODDED OR BUILT UPON BY BE PERFORMED WITHIN FIVE (5) DAYS OF THE COMPLETION OF FINAL GRADE.
- CONSTRUCTION OPERATIONS SHALL BE SCHEDULED AND PERFORMED SO THAT PREVENTATIVE SOIL EROSION CONTROL MEASURES ARE IN PLACE PRIOR TO EXCAVATION THE ESTIMATED COST OF SOIL EROSION AND SEDIMENTATION CONTROL MEASURES, TOPSOIL, IN CRITICAL AREAS AND TEMPORARY STABILIZATION MEASURES ARE IN PLACE IMMEDIATELY FOLLOWING BACKFILLING OPERATIONS.
- SPECIAL PRECAUTIONS WILL BE TAKEN IN THE USE OF CONSTRUCTION EQUIPMENT TO PREVENT SITUATIONS THAT PROMOTE EROSION.
- 9. PROPER DUST CONTROL SHALL BE MAINTAINED DURING CONSTRUCTION BY USE OF WATER TRUCKS AND/OR DUST PALLATIVE AS REQUIRED.
- 10. THE CONTRACTOR SHALL BE RESPONSIBLE FOR MAINTAINING ALL TEMPORARY SOIL EROSION CONTROL MEASURES AND REMOVAL OF SOME MEASURES UPON AUTHORIZED COMPLETION OF THE PROJECT. FINAL COMPLETION OF PROJECT WILL NOT BE AUTHORIZED UNTIL ALL SITE WORK AND UTILITY CONSTRUCTION IS COMPLETE AND ALL SOILS ARE STABILIZED.
- 11. THE CONTRACTOR SHALL NOT GRADE INTO ADJACENT PROPERTIES. SILT AND PROTECTIVE FENCE SHALL BE INSTALLED AND MAINTAINED TO PREVENT GRADING, EROSION AND SEDIMENTATION INTO THE ADJACENT PROPERTIES.

12. TREE PROTECTION FENCING MUST REMAIN INTACT UNTIL RESTORATION OF THE SITE IS COMPLETE.

SOIL EROSION SEQUENCE OF CONSTRUCTION:

- PLACE INLET FILTERS ON EXISTING DRAINAGE FEATURES THAT WILL REMAIN IN PLACE AFTER CONSTRUCTION BEGINS.
- 2. INSTALL SIDEWALKS, RETAINING WALLS, AND STORM SEWER AND STRUCTURES.
- RESTORE ALL DISTURBED AREAS TO A CONDITION THAT IS BETTER THAN, OR EQUAL TO, THAT WHICH EXISTED PRIOR TO THE COMMENCEMENT OF CONSTRUCTION ACTIVITIES.
- 24 HOURS OF A STORM EVENT.
- 5. ESTABLISH VEGETATION FOR ALL DISTURBED AREAS WITHIN CONSTRUCTION LIMITS.
- 6. CLEAN OUT STORM SEWER SYSTEMS.
- 7. REMOVE TEMPORARY SESC FEATURES (CALL FOR FINAL INSPECTION)
- REMEDY ANY NOTED DEFECTS TO THE SATISFACTION OF THE CITY'S SESC OFFICIAL.

THIS SEQUENCE IS FOR INFORMATION ONLY. IT IS INTENDED TO SHOW THE SEQUENCE OF CONSTRUCTION WITH RESPECT TO THE SOIL EROSION CONTROL MEASURES. THE CONTRACTOR IS RESPONSIBLE FOR SUBMITTING THEIR OWN DETAILED CONSTRUCTION SEQUENCE AND SCHEDULE TO THE ENGINEER FOR REVIEW, COMMENT AND ACCEPTANCE.


- 1. SEED IN ACCORDANCE WITH PROJECT DRAWINGS AND SPECIFICATIONS.
- NOVEMBER 15TH OR JUNE 30TH IS TO BE TEMPORARILY STABILIZED PER SPECIFICATIONS.

SEEDING. AND MULCH = \$2.856

ON SITE SOILS PER THE USDA SOIL SURVEY OF WASHTENAW COUNTY, MICHIGAN:

NIXON ROAD

 WawabC - WAWASEE LOAM, 6 TO 12 PERCENT SLOPE WawabB - WAWASEE LOAM, 2 TO 6 PERCENT SLOPE

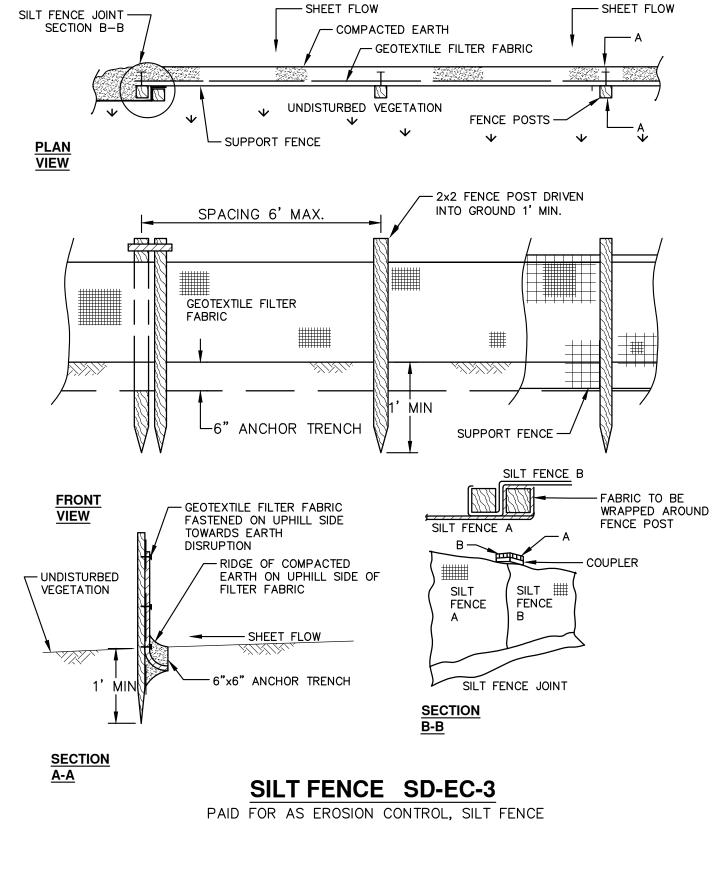

- CURB OPENING 1" REBAR FOR BAG REMOVAL FROM INLET OPTIONAL OVERFLOW SILTSACK -DUMP LOOPS (REBAR -NOT INCLUDED) **SIDE VIEW INSTALLED** EXPANSION -**INSTALLATION DETAIL**

SILTSACK DETAIL PAID FOR AS EROSION CONTROL, INLET PROTECTION, FABRIC DROP

NOTE: THE SILTSACK WILL BE MANUFACTURED FROM A WOVEN POLYPROPYLENE FABRIC THAT MEETS OR EXCEEDS THE FOLLOWING SPECIFICATIONS.

REGULAR FLOW SILTSACK

| (FOR AREAS OF LOW TO MODERATE | PRECIPITATION AND | RUN-OFF) |
|---|---|--|
| <u>PROPERTIES</u> | REQUIRED VALUE | TEST METHOD |
| GRAB TENSILE STRENGTH GRAB TENSILE ELONGATION PUNCTURE MULLEN BURST TRAPEZOID TEAR UV RESISTANCE APPARENT OPENING SIZE FLOW RATE PERMITTIVITY | ASTM D-4632 ASTM D-4632 ASTM D-4833 ASTM D-3786 ASTM D-4533 ASTM D-4355 ASTM D-4751 ASTM D-4491 ASTM D-4491 | 300 LBS 20% 120 LBS 800 PSI 120 LBS 80% 40 US SIEVE 40 GAL/MIN/SQ FT 0.55 SEC -1 |

HI-FLOW SILTSACK


(FOR AREAS OF MODERATE TO HEAVY PRECIPITATION AND RUN-OFF)

| <u>PROPERTIES</u> | REQUIRED VALUE | TEST METHOD |
|---|---|---------------------------|
| RAB TENSILE STRENGTH RAB TENSILE ELONGATION UNCTURE | ASTM D-4632 ASTM D-4632 ASTM D-4833 | 265 LBS 20% 135 LBS |
| UNCTURE IULLEN BURST RAPEZOID TEAR | ASTM D-4633 ASTM D-3786 ASTM D-4533 | 420 PSI 45 LBS |
| V RESISTANCE PPARENT OPENING SIZE | ASTM D-4355 ASTM D-4751 | 90% 20 US SIEVE |
| LOW RATE | ASTM D-4491 | 200 GAL/MIN/SQ FT |

OIL-ABSORBANT SILTSACK

(FOR AREAS WHERE THERE IS A CONCERN FOR OIL RUN-OFF OR SPILLS)

IT IS THE INTENT OF THE PLANS AND SPECIFICATIONS THAT THE CONTRACTOR INSTALL THE REBAR AS SHOWN IN THIS DETAIL TO PROVIDE A FULLY FUNCTIONING UNIT. ALL COSTS ASSOCIATED WITH FURNISHING, CLEANING AS MANY TIMES AS REQUIRED, DISPOSAL OF SEDIMENT, AND REMOVING THE INLET FILTER WHEN NO LONGER NEEDED IS INCLUDED IN THE ITEM OF WORK AND WILL NOT BE

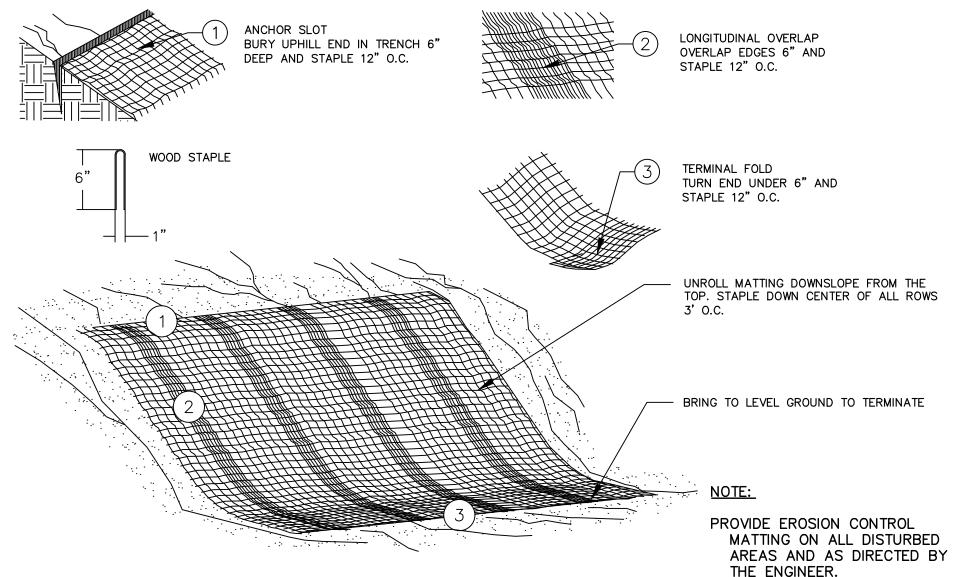

MULCH BLANKET DETAIL

APPLIES TO ALL AREAS TO BE PERMANENTLY RESTORED WITH GRASS. PAID FOR AS MULCH BLANKET, MODIFIED

PERMITS REQUIRED TO BE OBTAINED BY THE CONTRACTOR BRIGHTO THE REGINALING OF CONCERNATION

| PERMIT | ISSUING AUTHORITY |
|--|---------------------------------------|
| LANE CLOSURE PERMIT* | CITY OF ANN ARBOR ENGINEERING |
| "NO PARKING" SIGNS PERMIT* | CITY OF ANN ARBOR ENGINEERING |
| GRADING/SOIL EROSION & SEDIMENTATION CONTROL PERMIT* | CITY OF ANN ARBOR CUSTOMER SERVICE |
| RIGHT-OF-WAY PERMIT* | CITY OF ANN ARBOR CUSTOMER SERVICE |

OWNER

CONTACT INFORMATION

PUBLIC UTILITIES

| WATER | | |
|-----------------------------------|---|-------------------------------------|
| SANITARY | | |
| STORM | CITY OF ANN ARBOR PUBLIC WORKS W.R. WHEELER SERVICE CENTER 4251 STONE SCHOOL ROAD | (734) 794–6350 |
| FORESTRY | ANN ARBOR, MI 48108 | |
| SIGNS SIGNALS STREET LIGHTS | | (734) 794–6361 |
| PRIVATE UTILITIES | OWNER | CONTACT |
| GAS | DTE ENERGY 3150 E. MICHIGAN AVE, YPSILANTI TOWNSHIP, MI 48198 | ROBERT CZAPIEWSKI (734) 544–7818 |
| ELECTRIC | DTE ENERGY WESTERN WAYNE SERVICE CENTER 8001 HAGGERTY ROAD BELLEVILLE, MI 48111 | CLAY COMBEE (734) 397-4112 |
| CABLE | COMCAST 27800 FRANKLIN ROAD SOUTHFIELD, MI 48034 | RON SUTHERLAND (313) 999-8300 |
| PHONE | AT&T 550 S. MAPLE ROAD ANN ARBOR, MI 48103 | (734) 996–2135 |
| FIBER OPTIC | MCI 2800 N. GLENFILLE ROAD RICHARDSON, TX 75082 | DEAN BOYERS (972) 729-6016 |

| TRAVER/NIXON BENCHMARKS | | | |
|-------------------------|---------|--|--|
| BM# | ELEV | DESCRIPTION | |
| 5 | 909.089 | NORTHEAST BOLT ON METAL LIGHT POLE, 25' WEST OF NIXON CENTERLINE, 70' SOUTH OF TRAVER CENTERLINE | |
| 6 | 915.098 | EAST SIDE OF SANITARY MANHOLE, CENTERLINE NIXON, 194'± NORTH OF TRAVER BLVD | |
| 7 | 930.99 | EAST SIDE OF SANITARY MANHOLE, CENTERLINE NIXON, 91'± NORTH OF ARGONNE DRIVE | |
| 8 | 938.395 | WEST SIDE OF STORM MANHOLE, 12'± WEST OF CENTERLINE NIXON, 194'± SOUTH OF WESTBURY COURT | |


ANN ARBOR


ENGINEERING

GAP | TRAV


CONTACT

SHEET No. 8 OF 24

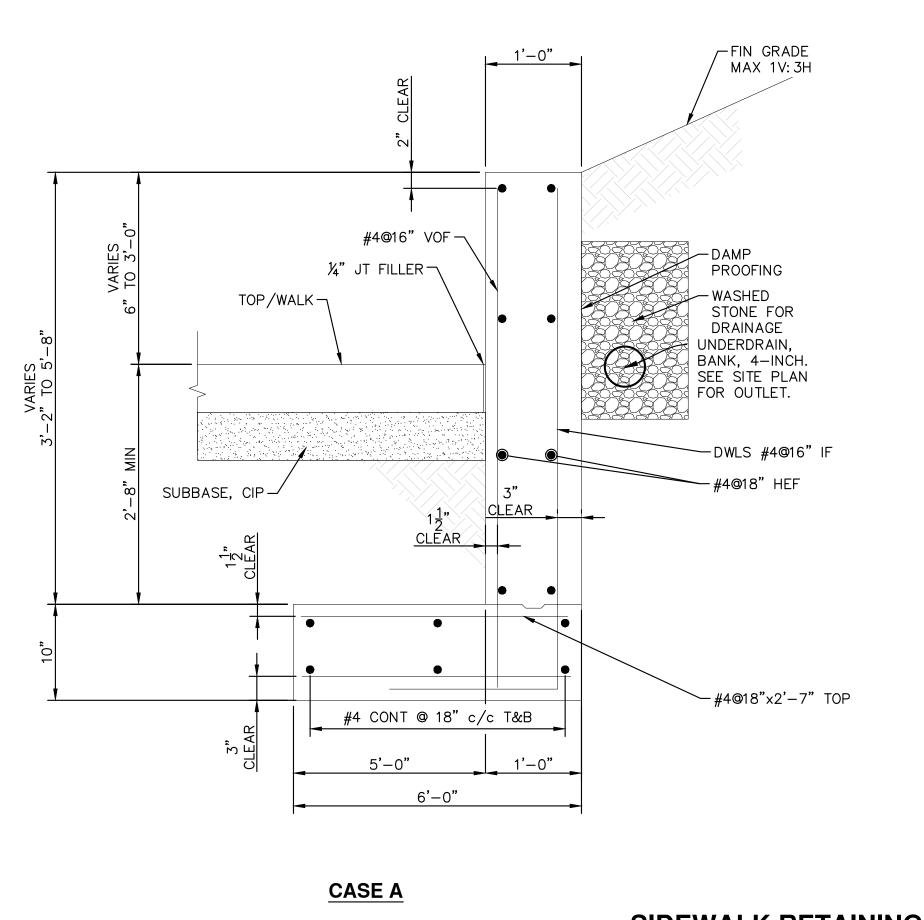

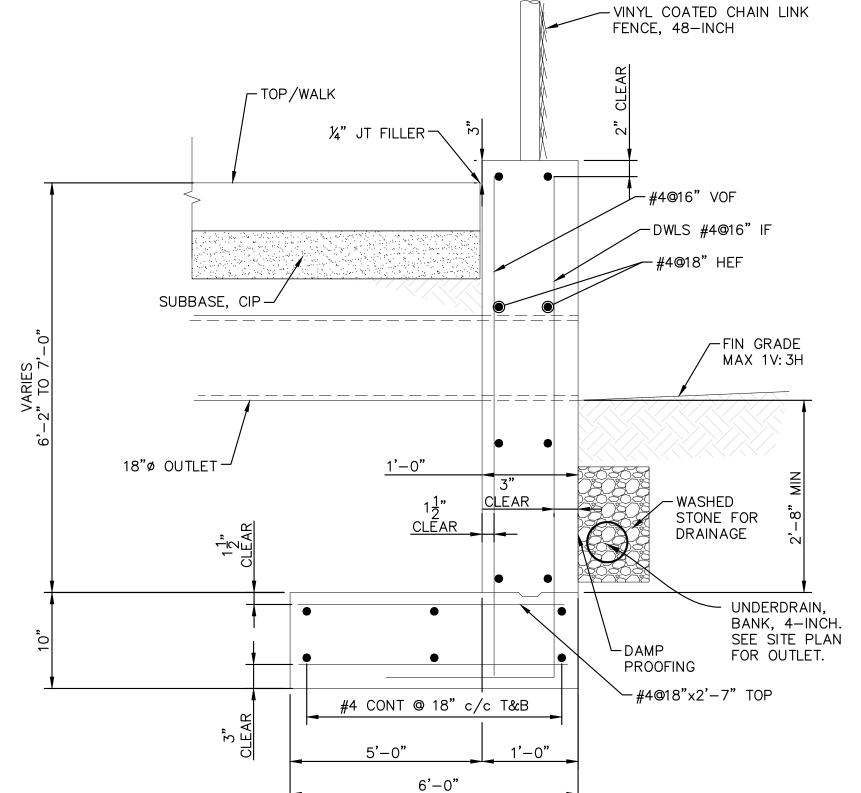


SIDEWALK RETAINING WALL, 6-INCH TO 48-INCH

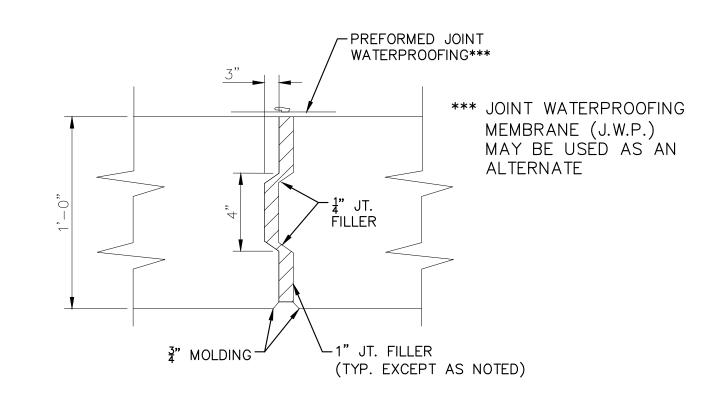


WALL EXPANSION JOINT DETAIL


FOR USE ON SIDEWALK RETAINING WALL, 6 TO 48 INCH

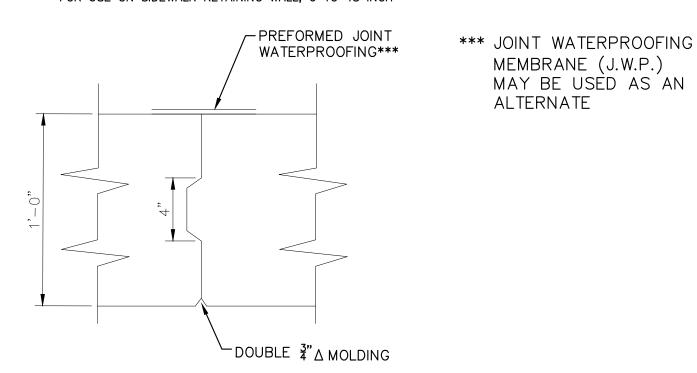

WALL CONSTRUCTION JOINT DETAIL FOR USE ON SIDEWALK RETAINING WALL, 6 TO 48 INCH

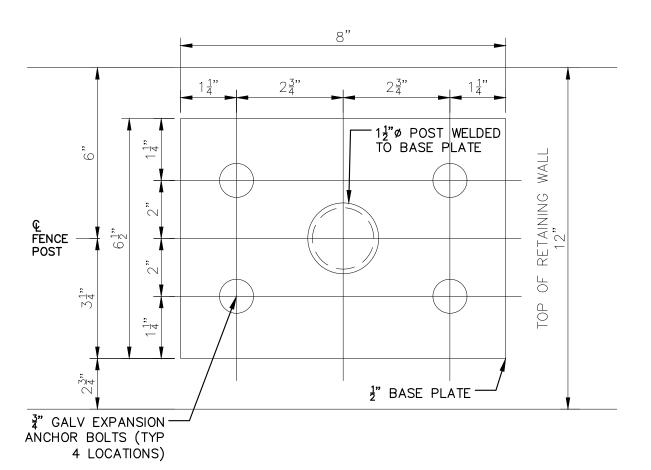


FENCE POST AND BASE PLATE PLAN FOR USE ON FENCE, CHAIN LINK, 48-INCH, WALL MOUNTED

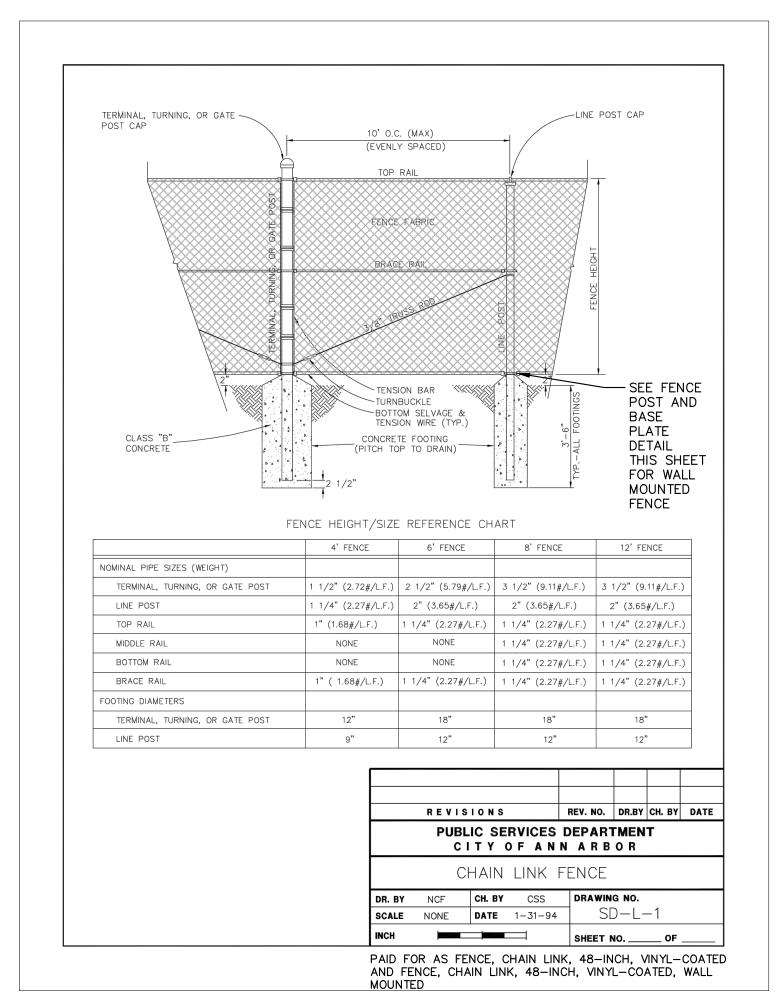



RETAINING WALL NOTES: 1. CONCRETE SHALL BE 3,500 PSI. 2. STEEL REINFORCEMENT SHALL MEET THE REQUIREMENTS OF ASTM A615, GRADE 60. CASE C

CITY OF ANN ARBOR - PUBLIC

SHEET No.

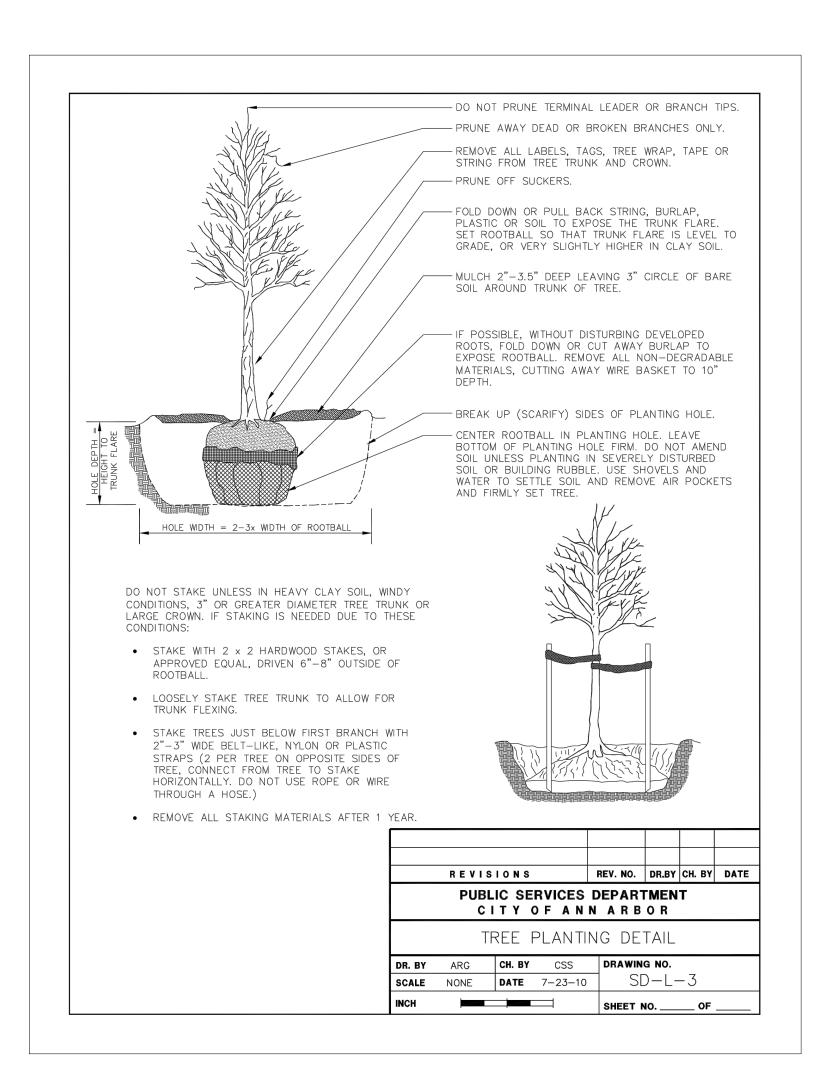

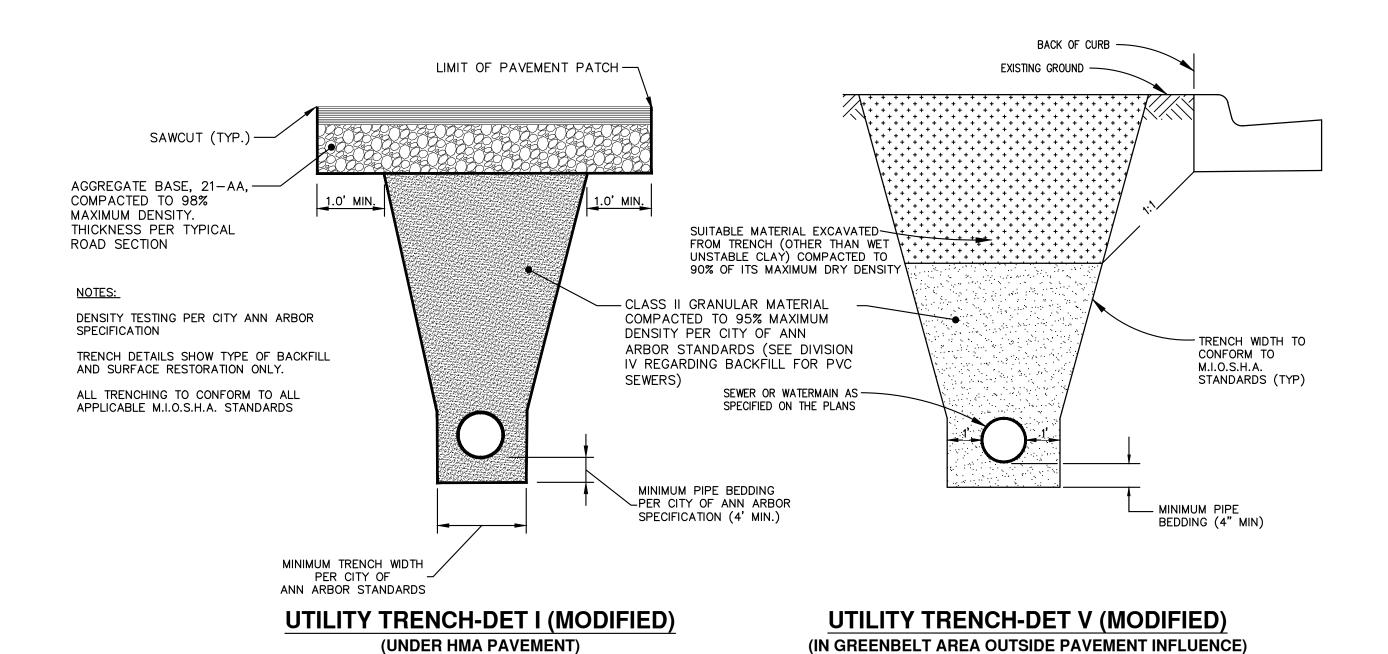

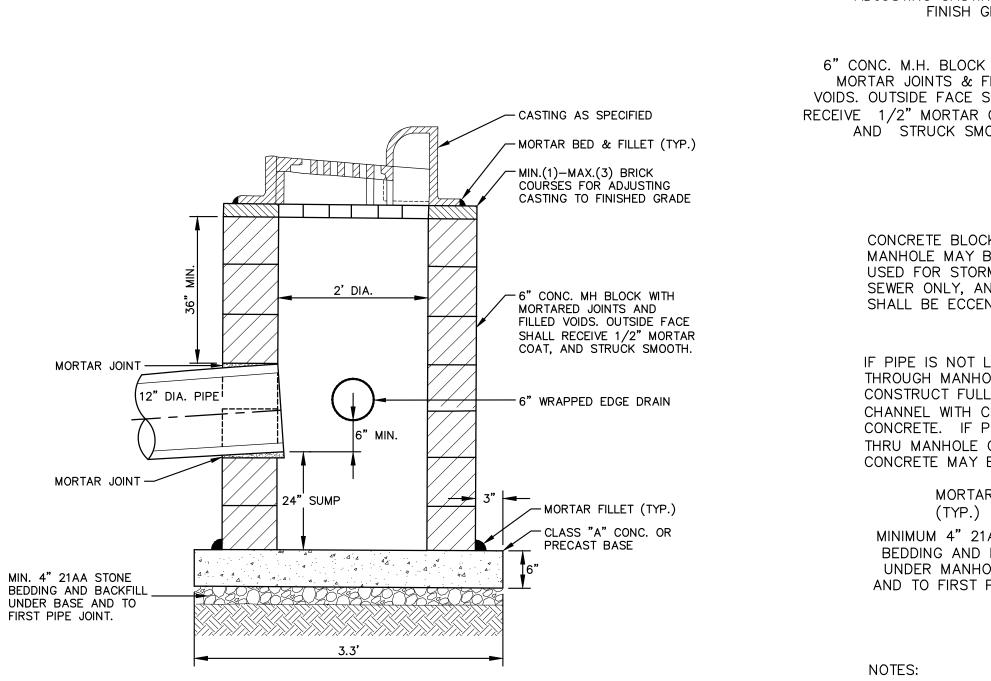


NOTES:

- 1. MAY BE USED WITH ONLY SINGLE OUTLET PIPE, AND NO INLET PIPE
- 2. FRONT EDGE OF INLET CASTING SHALL BE FLUSH WITH FRONT EDGE OF GUTTER (EDGE-OF-METAL)

SINGLE INLET STRUCTURE SD-S-10

PAID FOR AS DR STRUCTURE, SINGLE INLET, 24 INCH DIA

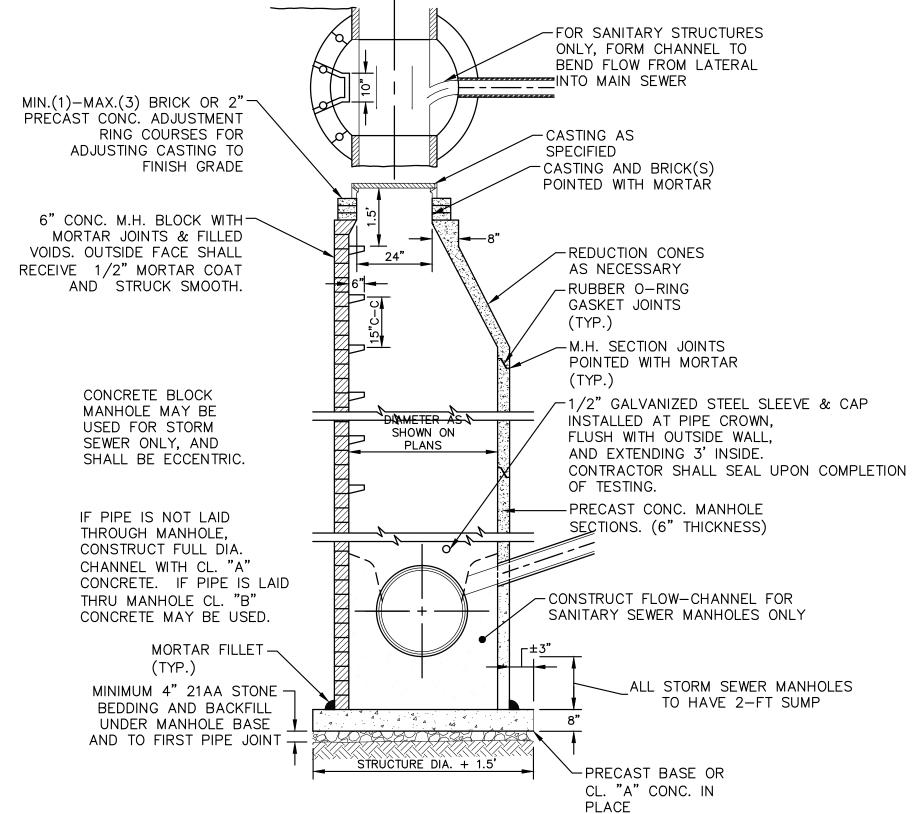

- 1. ALL SANITARY MANHOLES SHALL BE PRECAST CONCRETE.
- 2. ALL MANHOLES MUST HAVE ECCENTRIC CONES BOTH STORM AND SANITARY
- 3. ALL SANITARY SEWER OPENINGS SHALL BE PRECAST WITH RUBBER BOOT CONNECTIONS.
- 4. 2' SUMP REQUIRED ON ALL DRAINAGE STRUCTURES.


STANDARD MANHOLE (TYPE I)

PAID FOR AS DR STRUCTURE, MANHOLE, TYPE 1, 48 INCH

SERVICES SIDEWALK


ANN ARBOR CITY

SHEET No. 10 OF 24

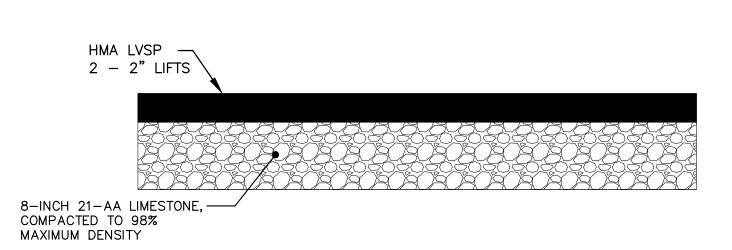


HMA PAVEMENT DETAIL

APPLIES TO HMA APPROACH

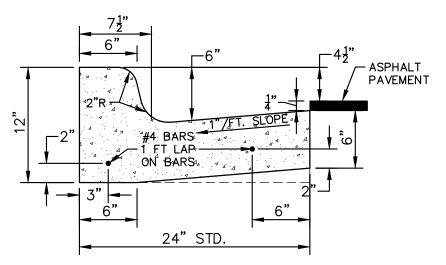

CURB AND GUTTER, CONC, DET SD-R-1, SPECIAL


PAID FOR AS CURB AND GUTTER, CONC, AA DET SD-R-1, MODIFIED

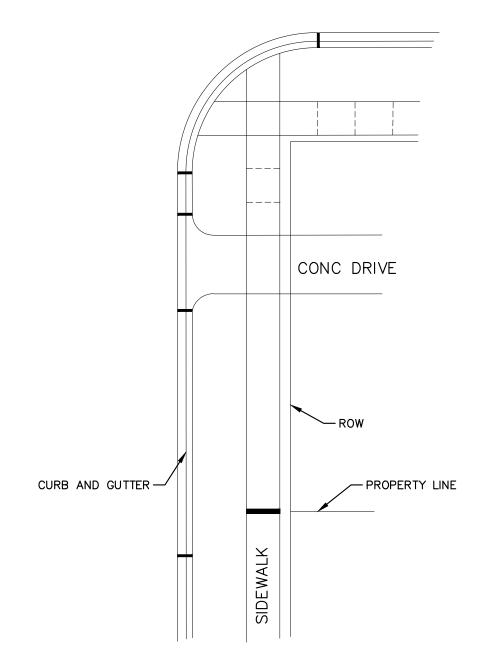

LEGEND:
CONTRACTION JOINTS

1/2" EXPANSION JOINTS

3/4" EXPANSION JOINTS

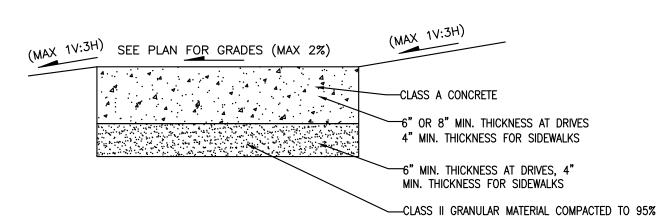


MAXIMUM DENSITY. (NATIVE MATERIAL ACCEPTABLE

FOR SIDEWALK IF STABLE AND FREE OF ORGANIC

OR DELETERIOUS MATERIAL)

- 1. MAX. 300' SPACING BETWEEN ALL EXPANSION JOINTS. ON CURB AND GUTTER. EXPANSION JOINTS TO BE PLACED IN SIDEWALKS AT THE EXTENSION OF ALL PROPERTY LINES.
- 10' NORMAL, 8' MIN. SPACING BETWEEN ALL CURB CONTRACTION JOINTS.
 SIDEWALK CONTRACTION JOINT SPACING IS 5' MIN. AREA 16 SQ. FT., MAX. AREA 36


INCH SIDEWALK

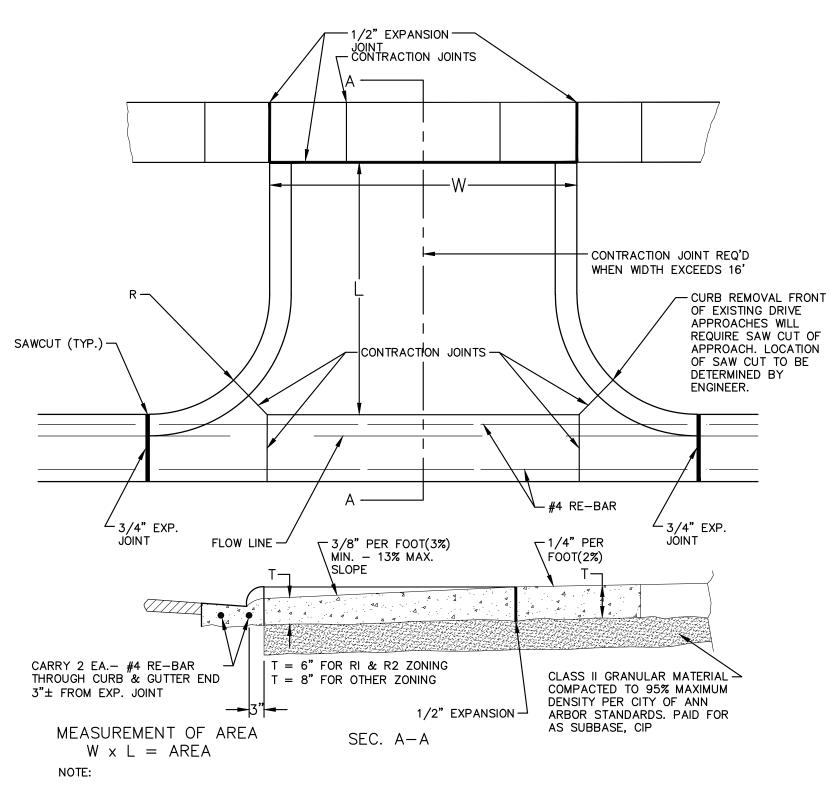



- 1. DRIVE APPROACH TO BE CLASS 'A' CONCRETE.
- 2. R(RADIUS) AND W(DRIVE WIDTH) AS REQUIRED FOR ZONING BY CITY CODE
- 3. IF GUTTER IS OVERLAYED, GUTTER OF THE APPROACH SHALL BE AT SAME ELEVATION AS EXISTING GUTTER AND ASPHALT WEDGE SHALL BE PLACED IN THE APPROACH.

TYPE 'M' DRIVE APPROACH SD-R-6


PAID FOR AS DRIVEWAY OPENING, CONC, DETAIL M, P-NC

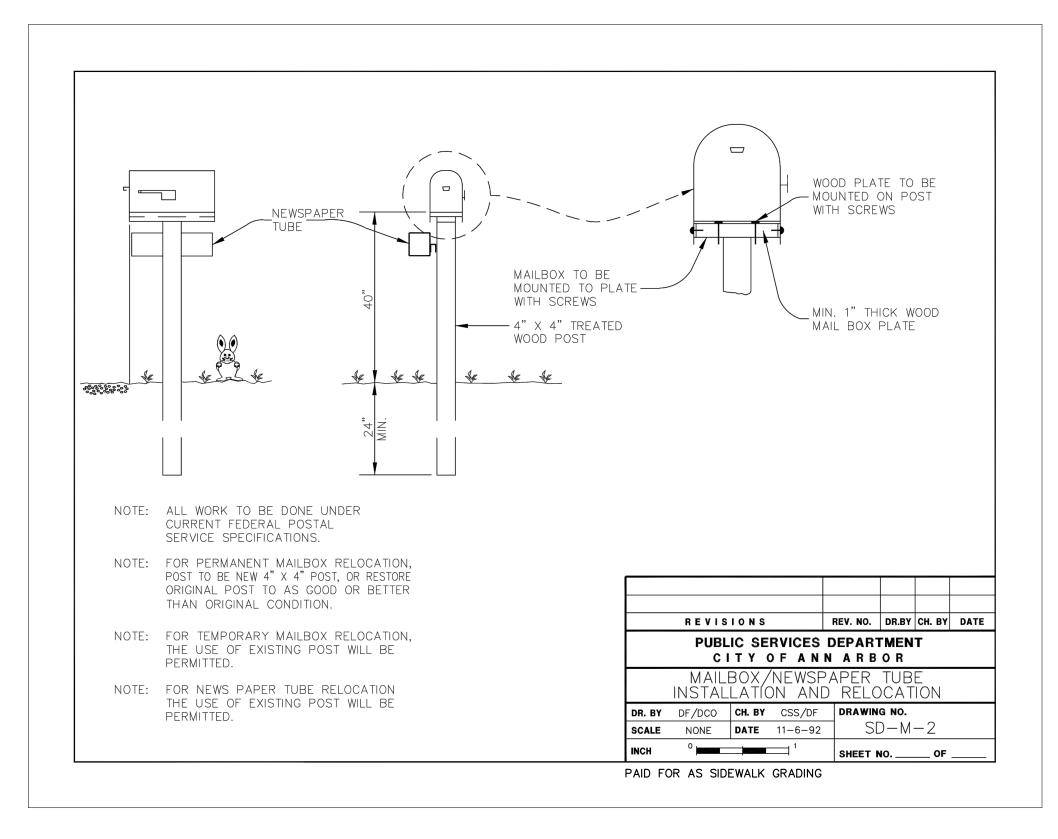

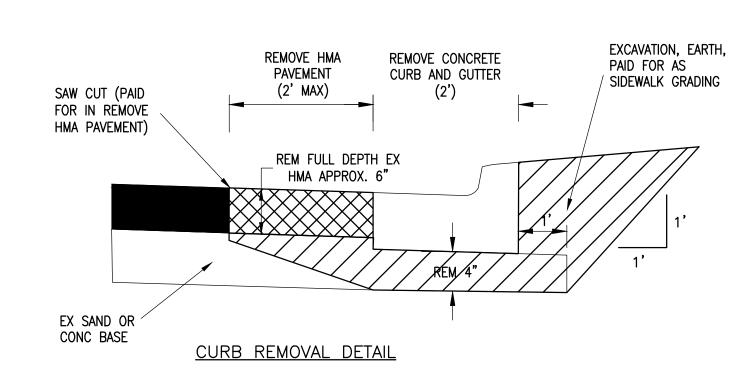

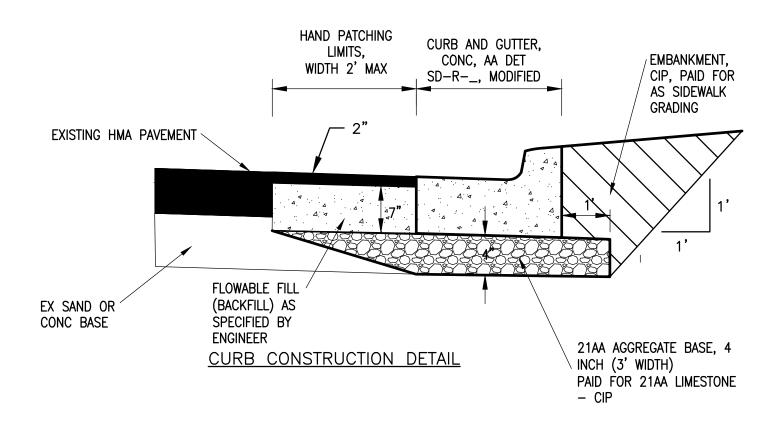

DETAIL FOR CURB REPLACEMENT AREAS

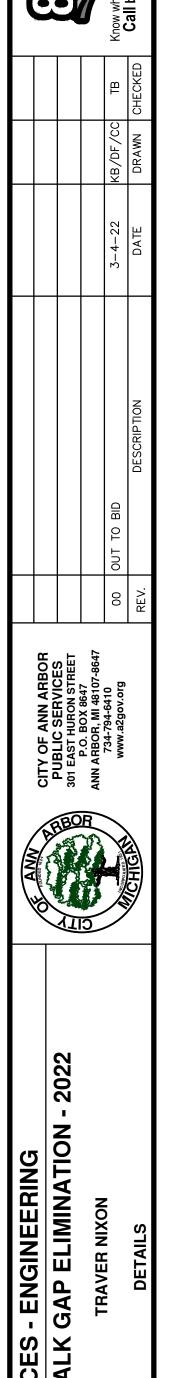



OF ANN ARBOR - PUBLIC SERVICES - ENGINEERING
SIDEWALK GAP ELIMINATION
TRAVER NIXON
THAVER NIXON
THAVEN NIXON

SHEET No.


11 OF 24

CIT

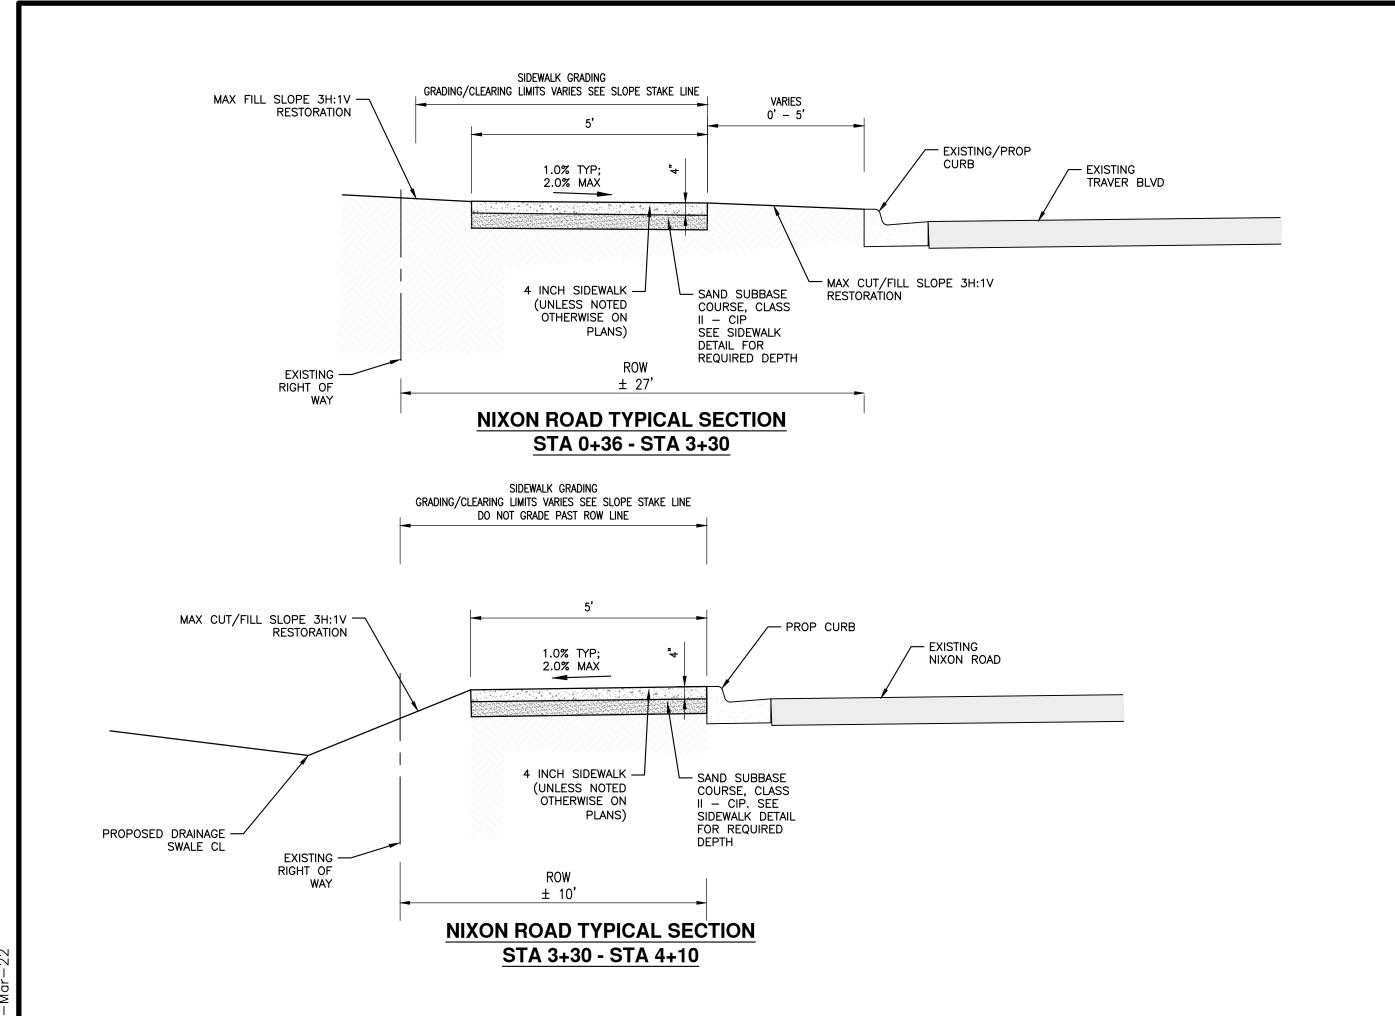


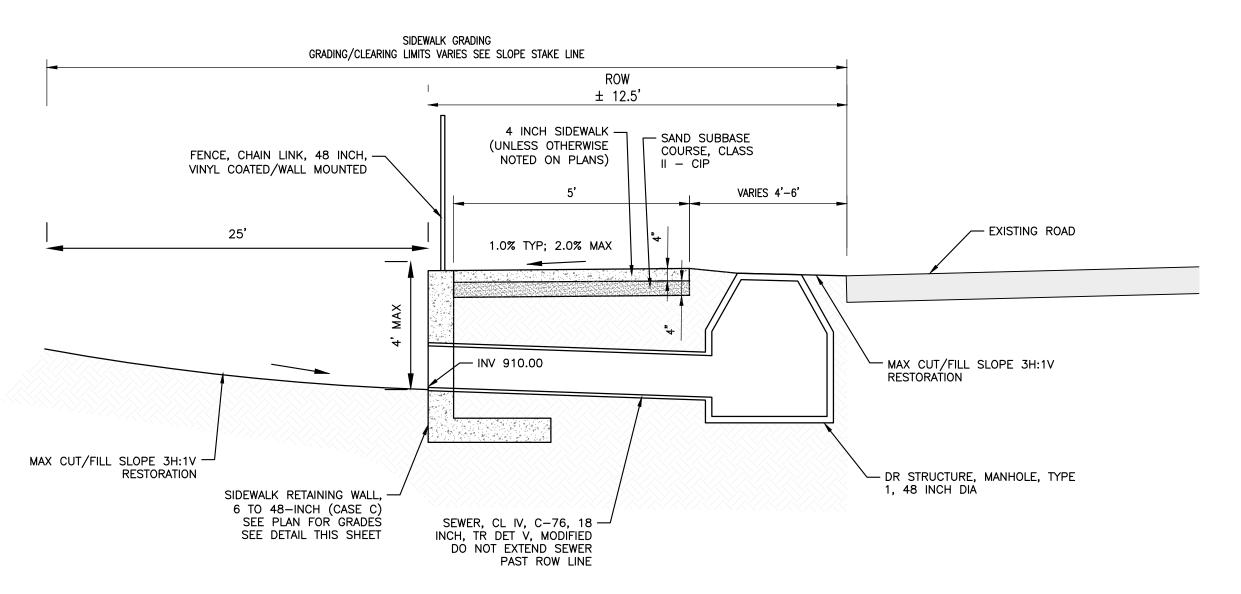

NIXON ROAD TYPICAL SECTION STA 4+42 - STA 4+58

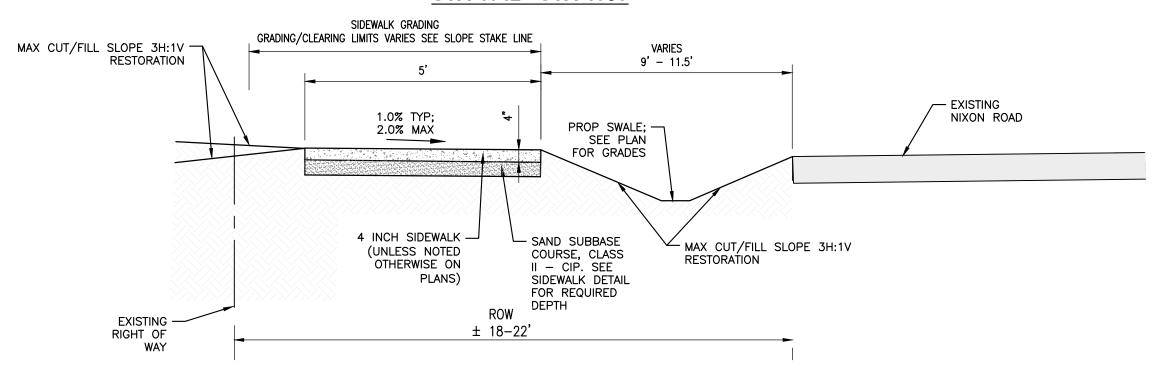


NIXON ROAD TYPICAL SECTION STA 4+85 - STA 5+73 STA 7+83 - STA 9+07

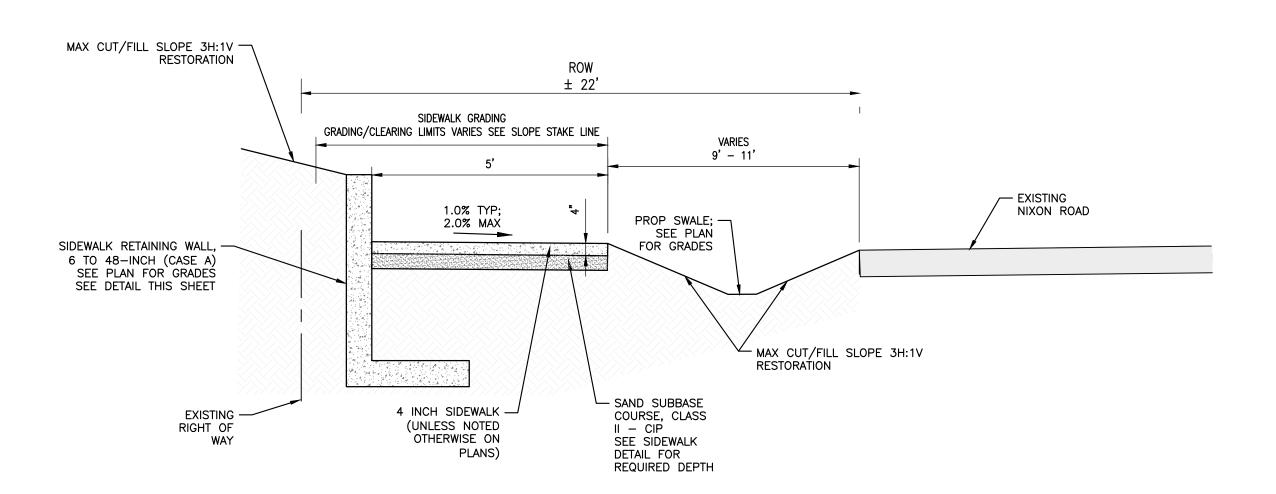

NIXON ROAD TYPICAL SECTION STA 6+53 - STA 7+83


CITY OF ANN ARBOR - PUBLIC SERVICES


SHEET No.

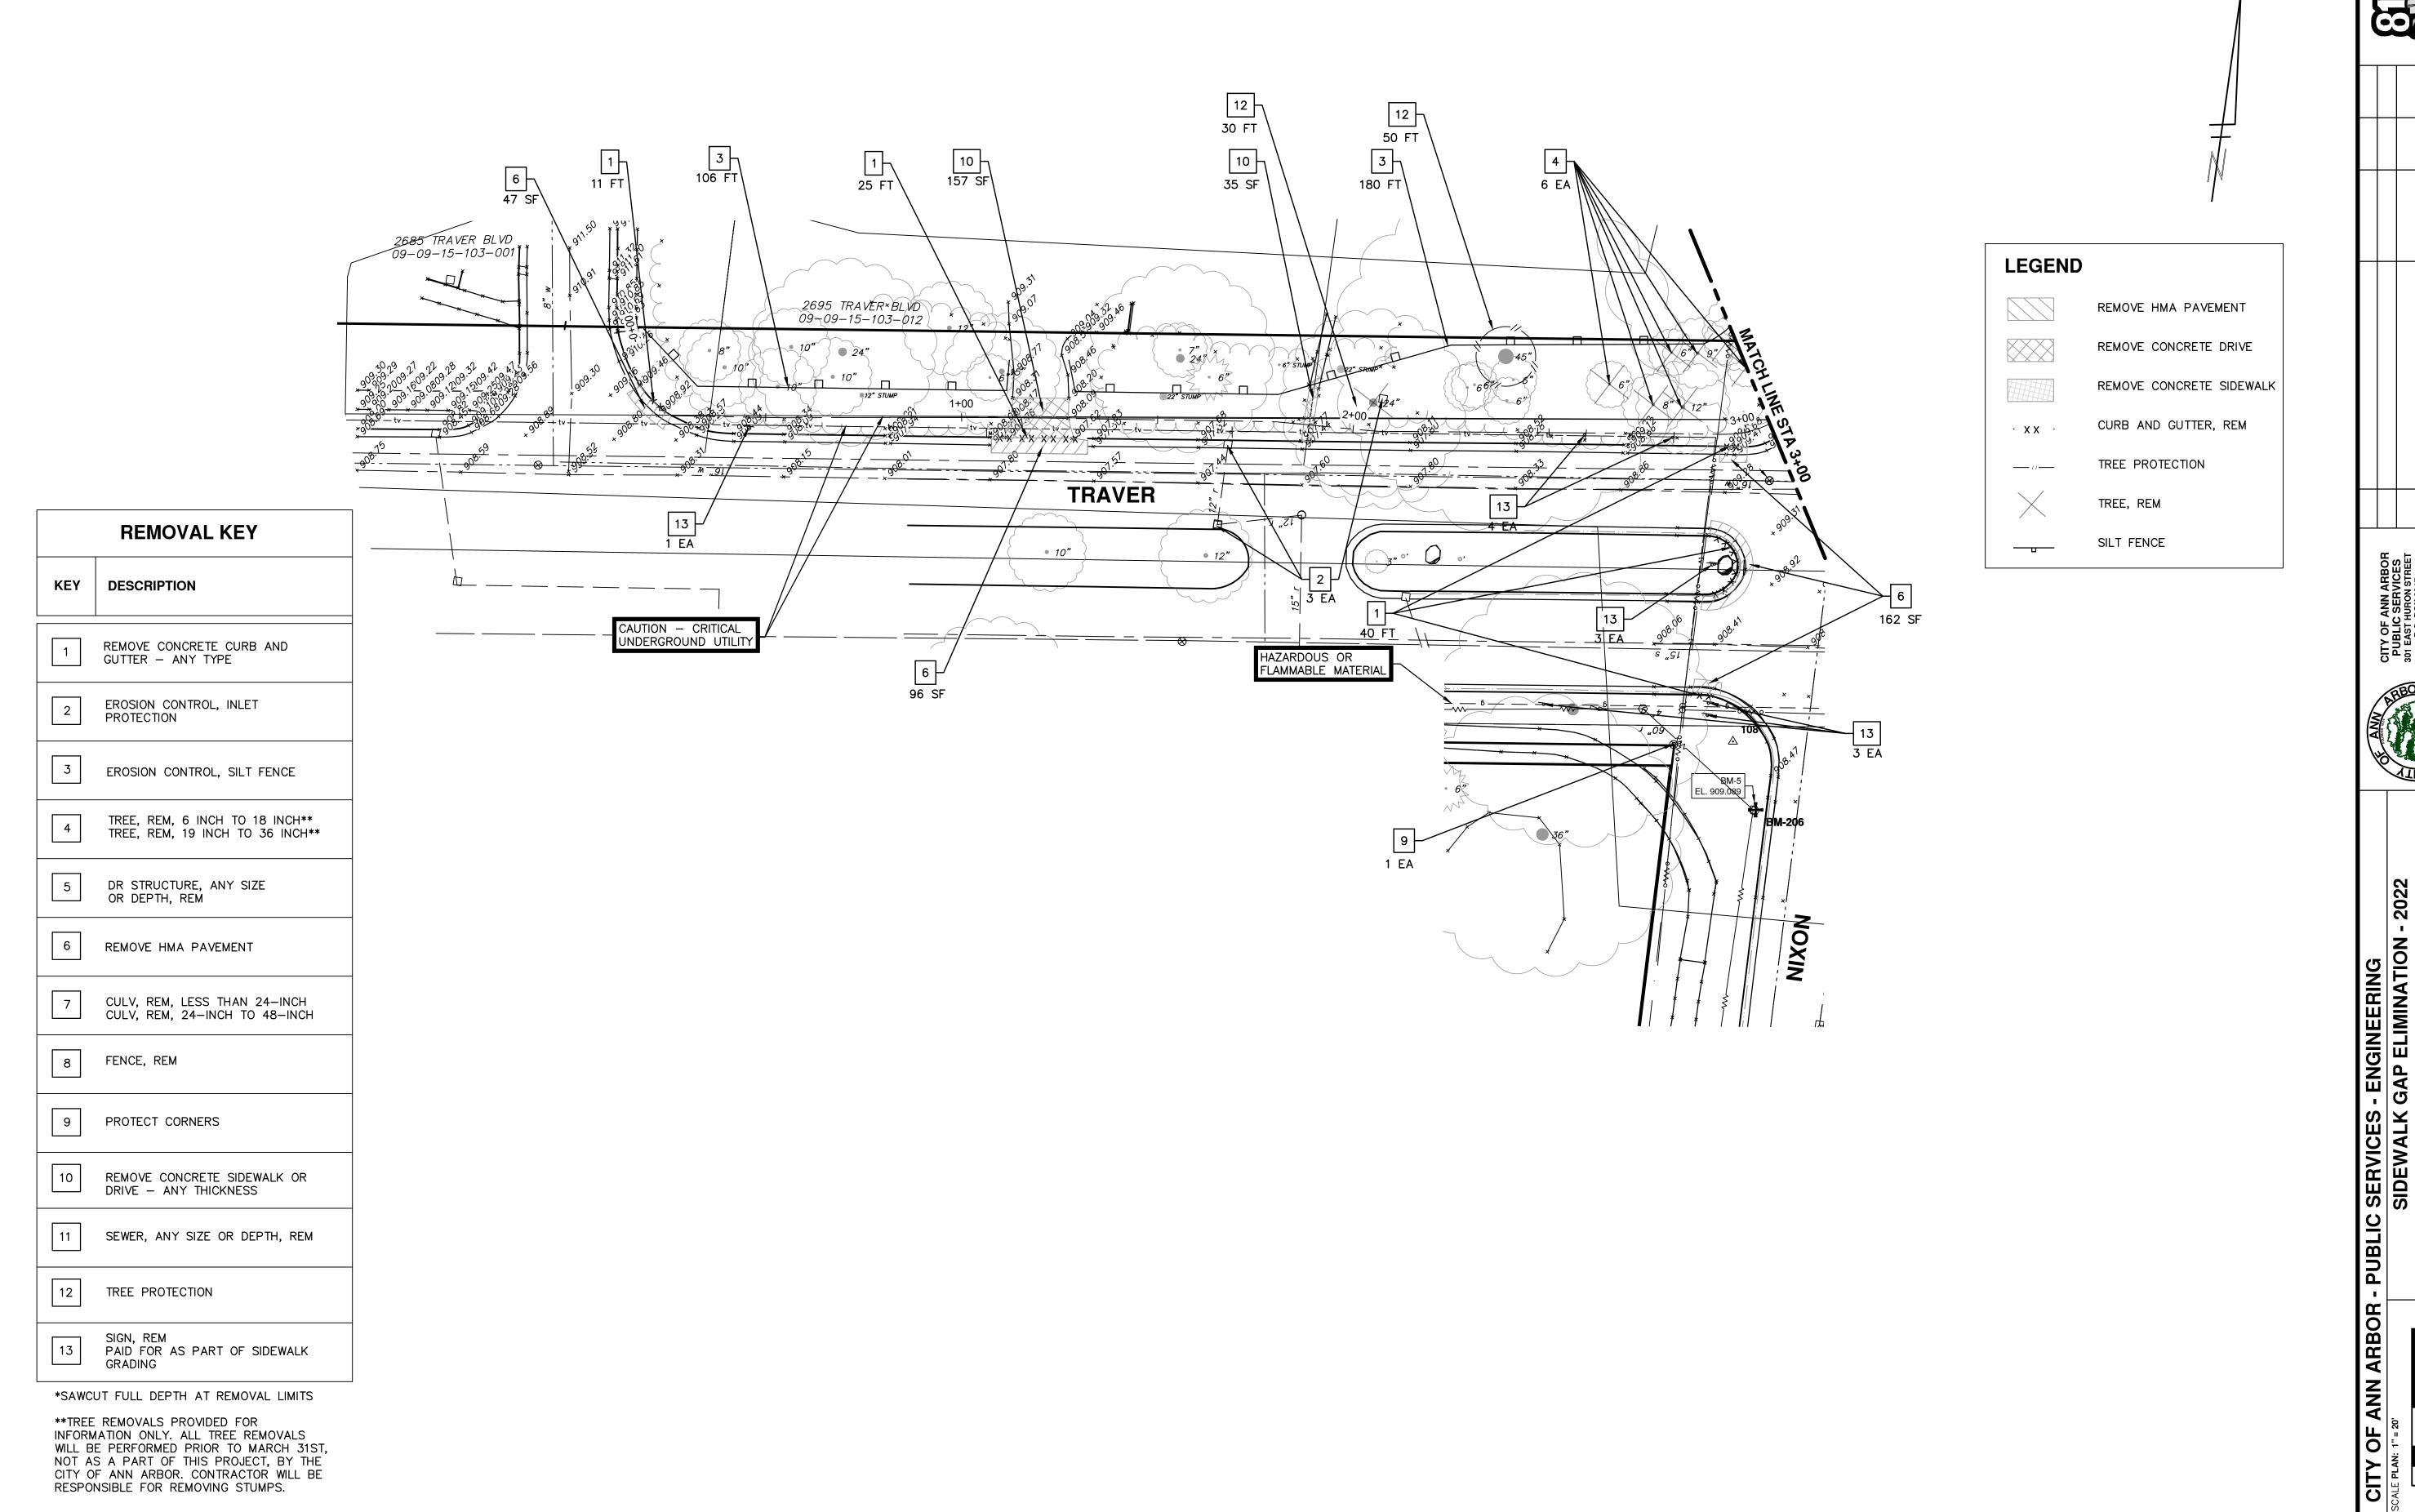






SHEET No. 13 OF 24

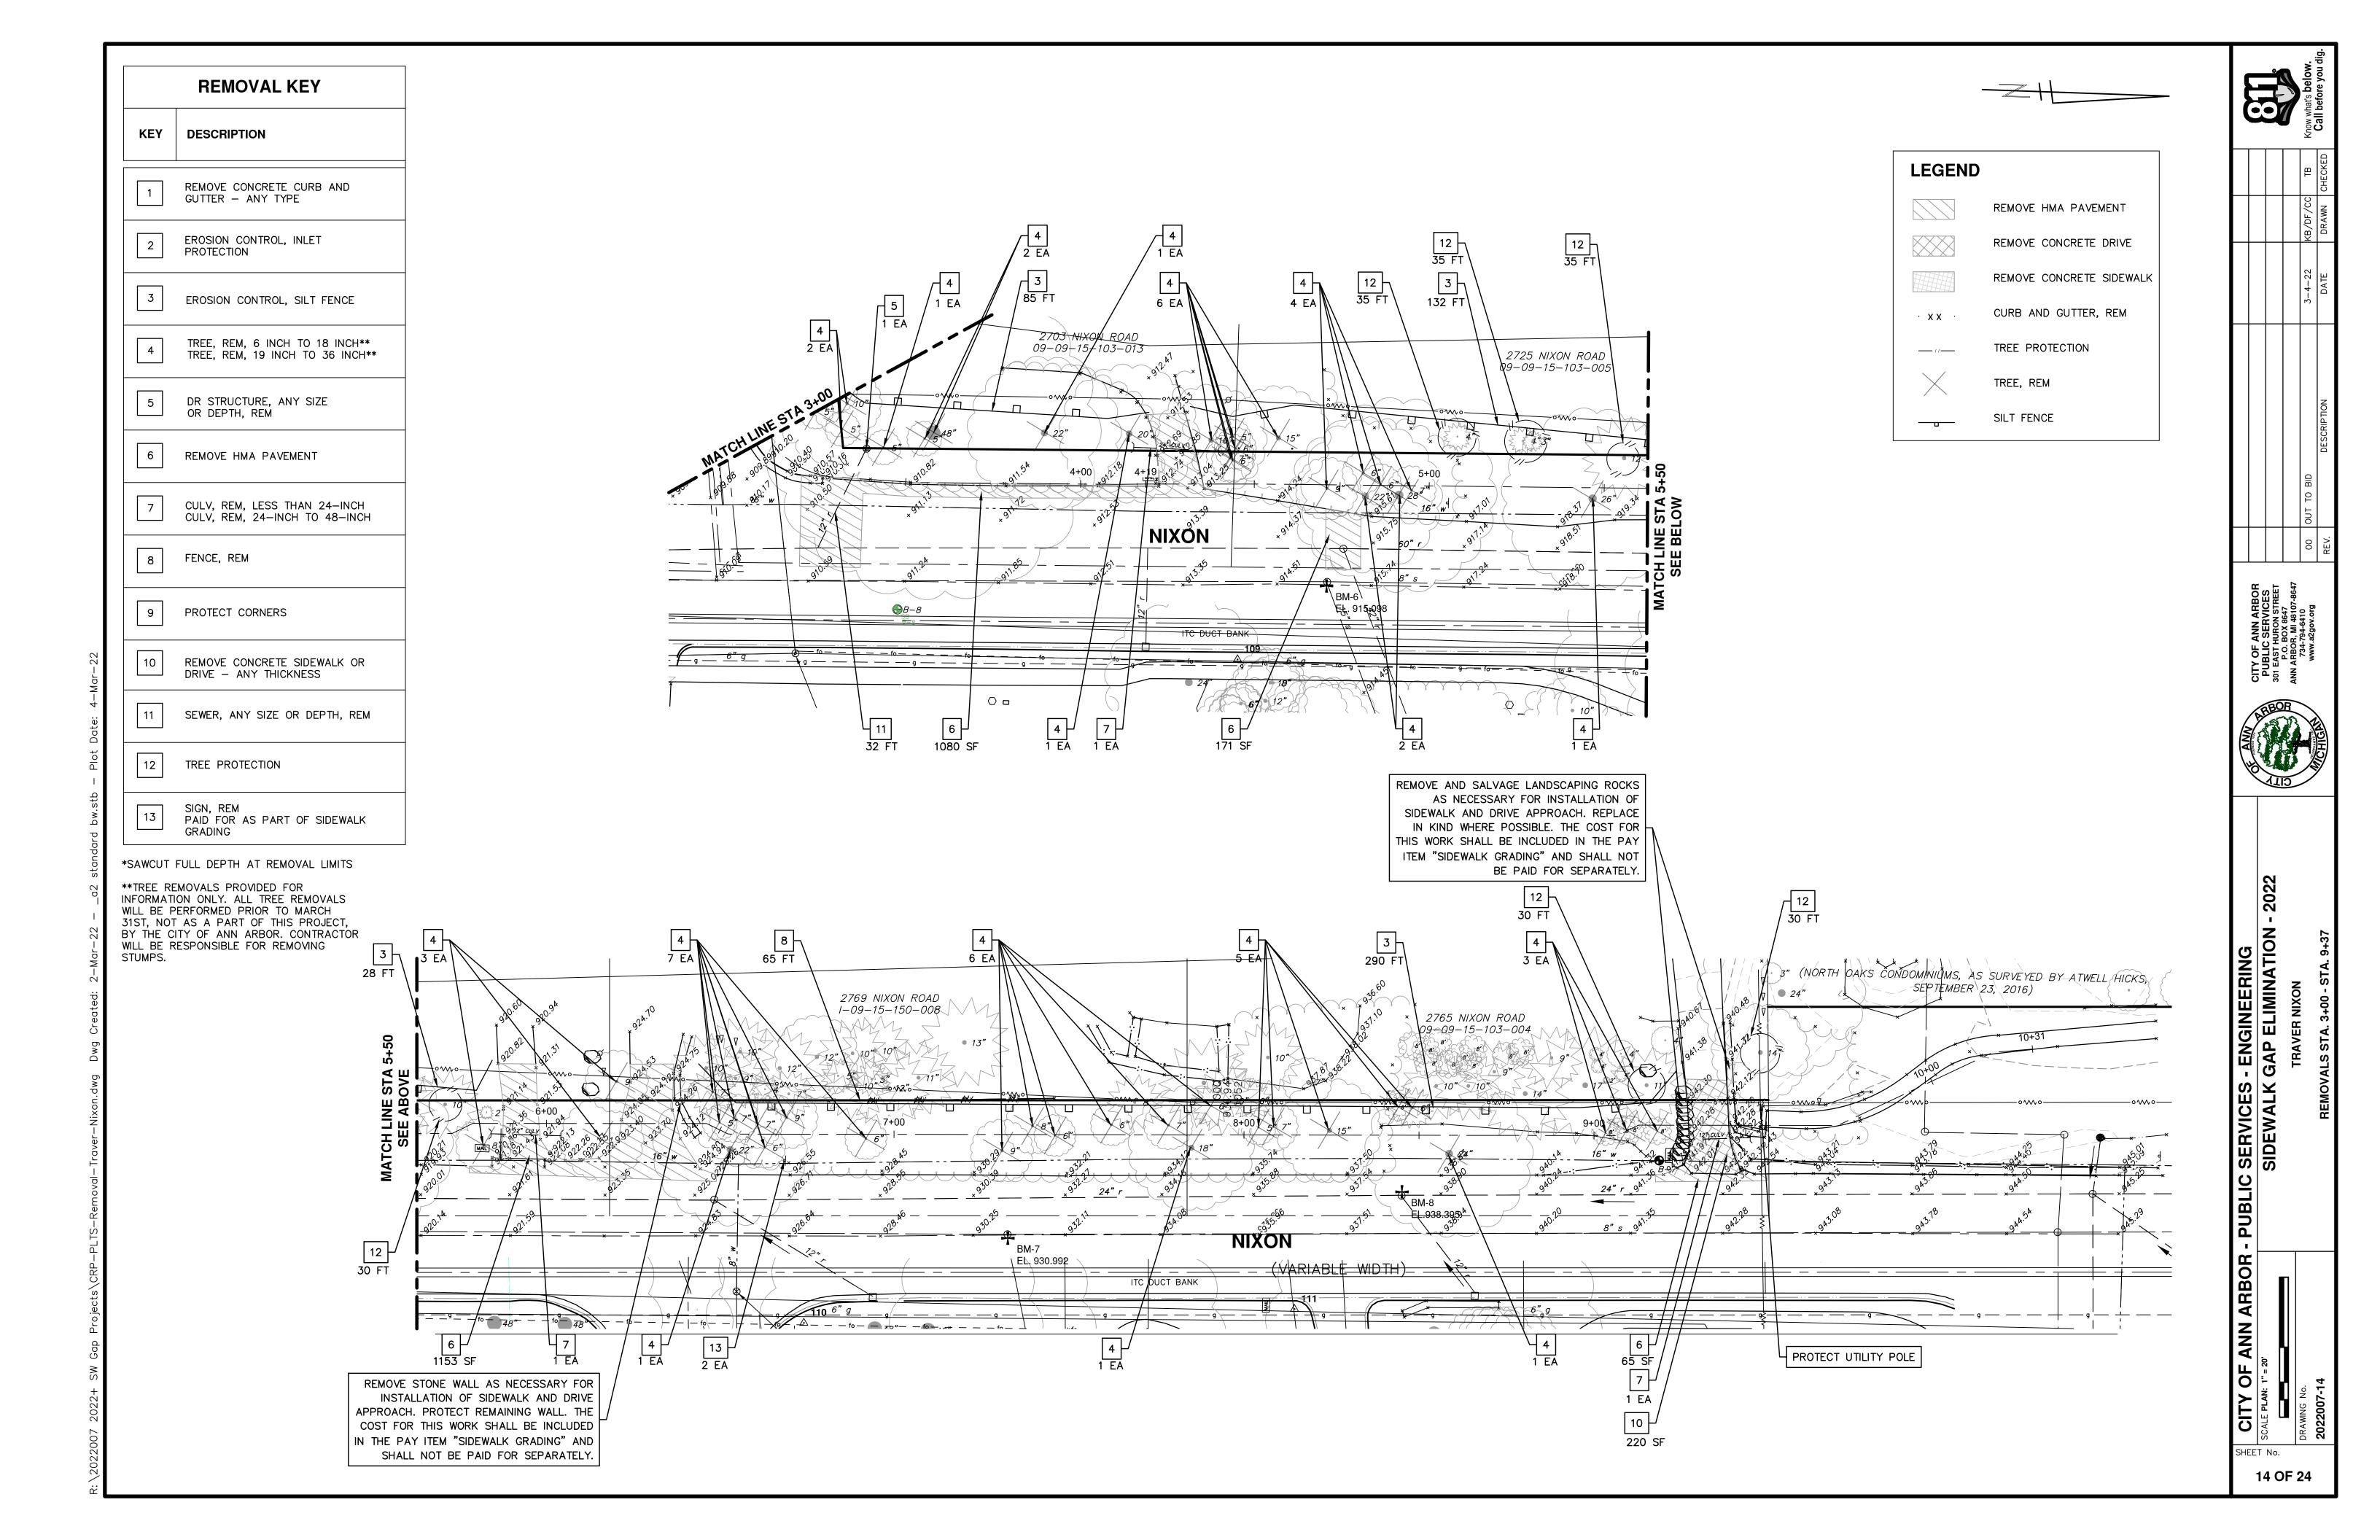


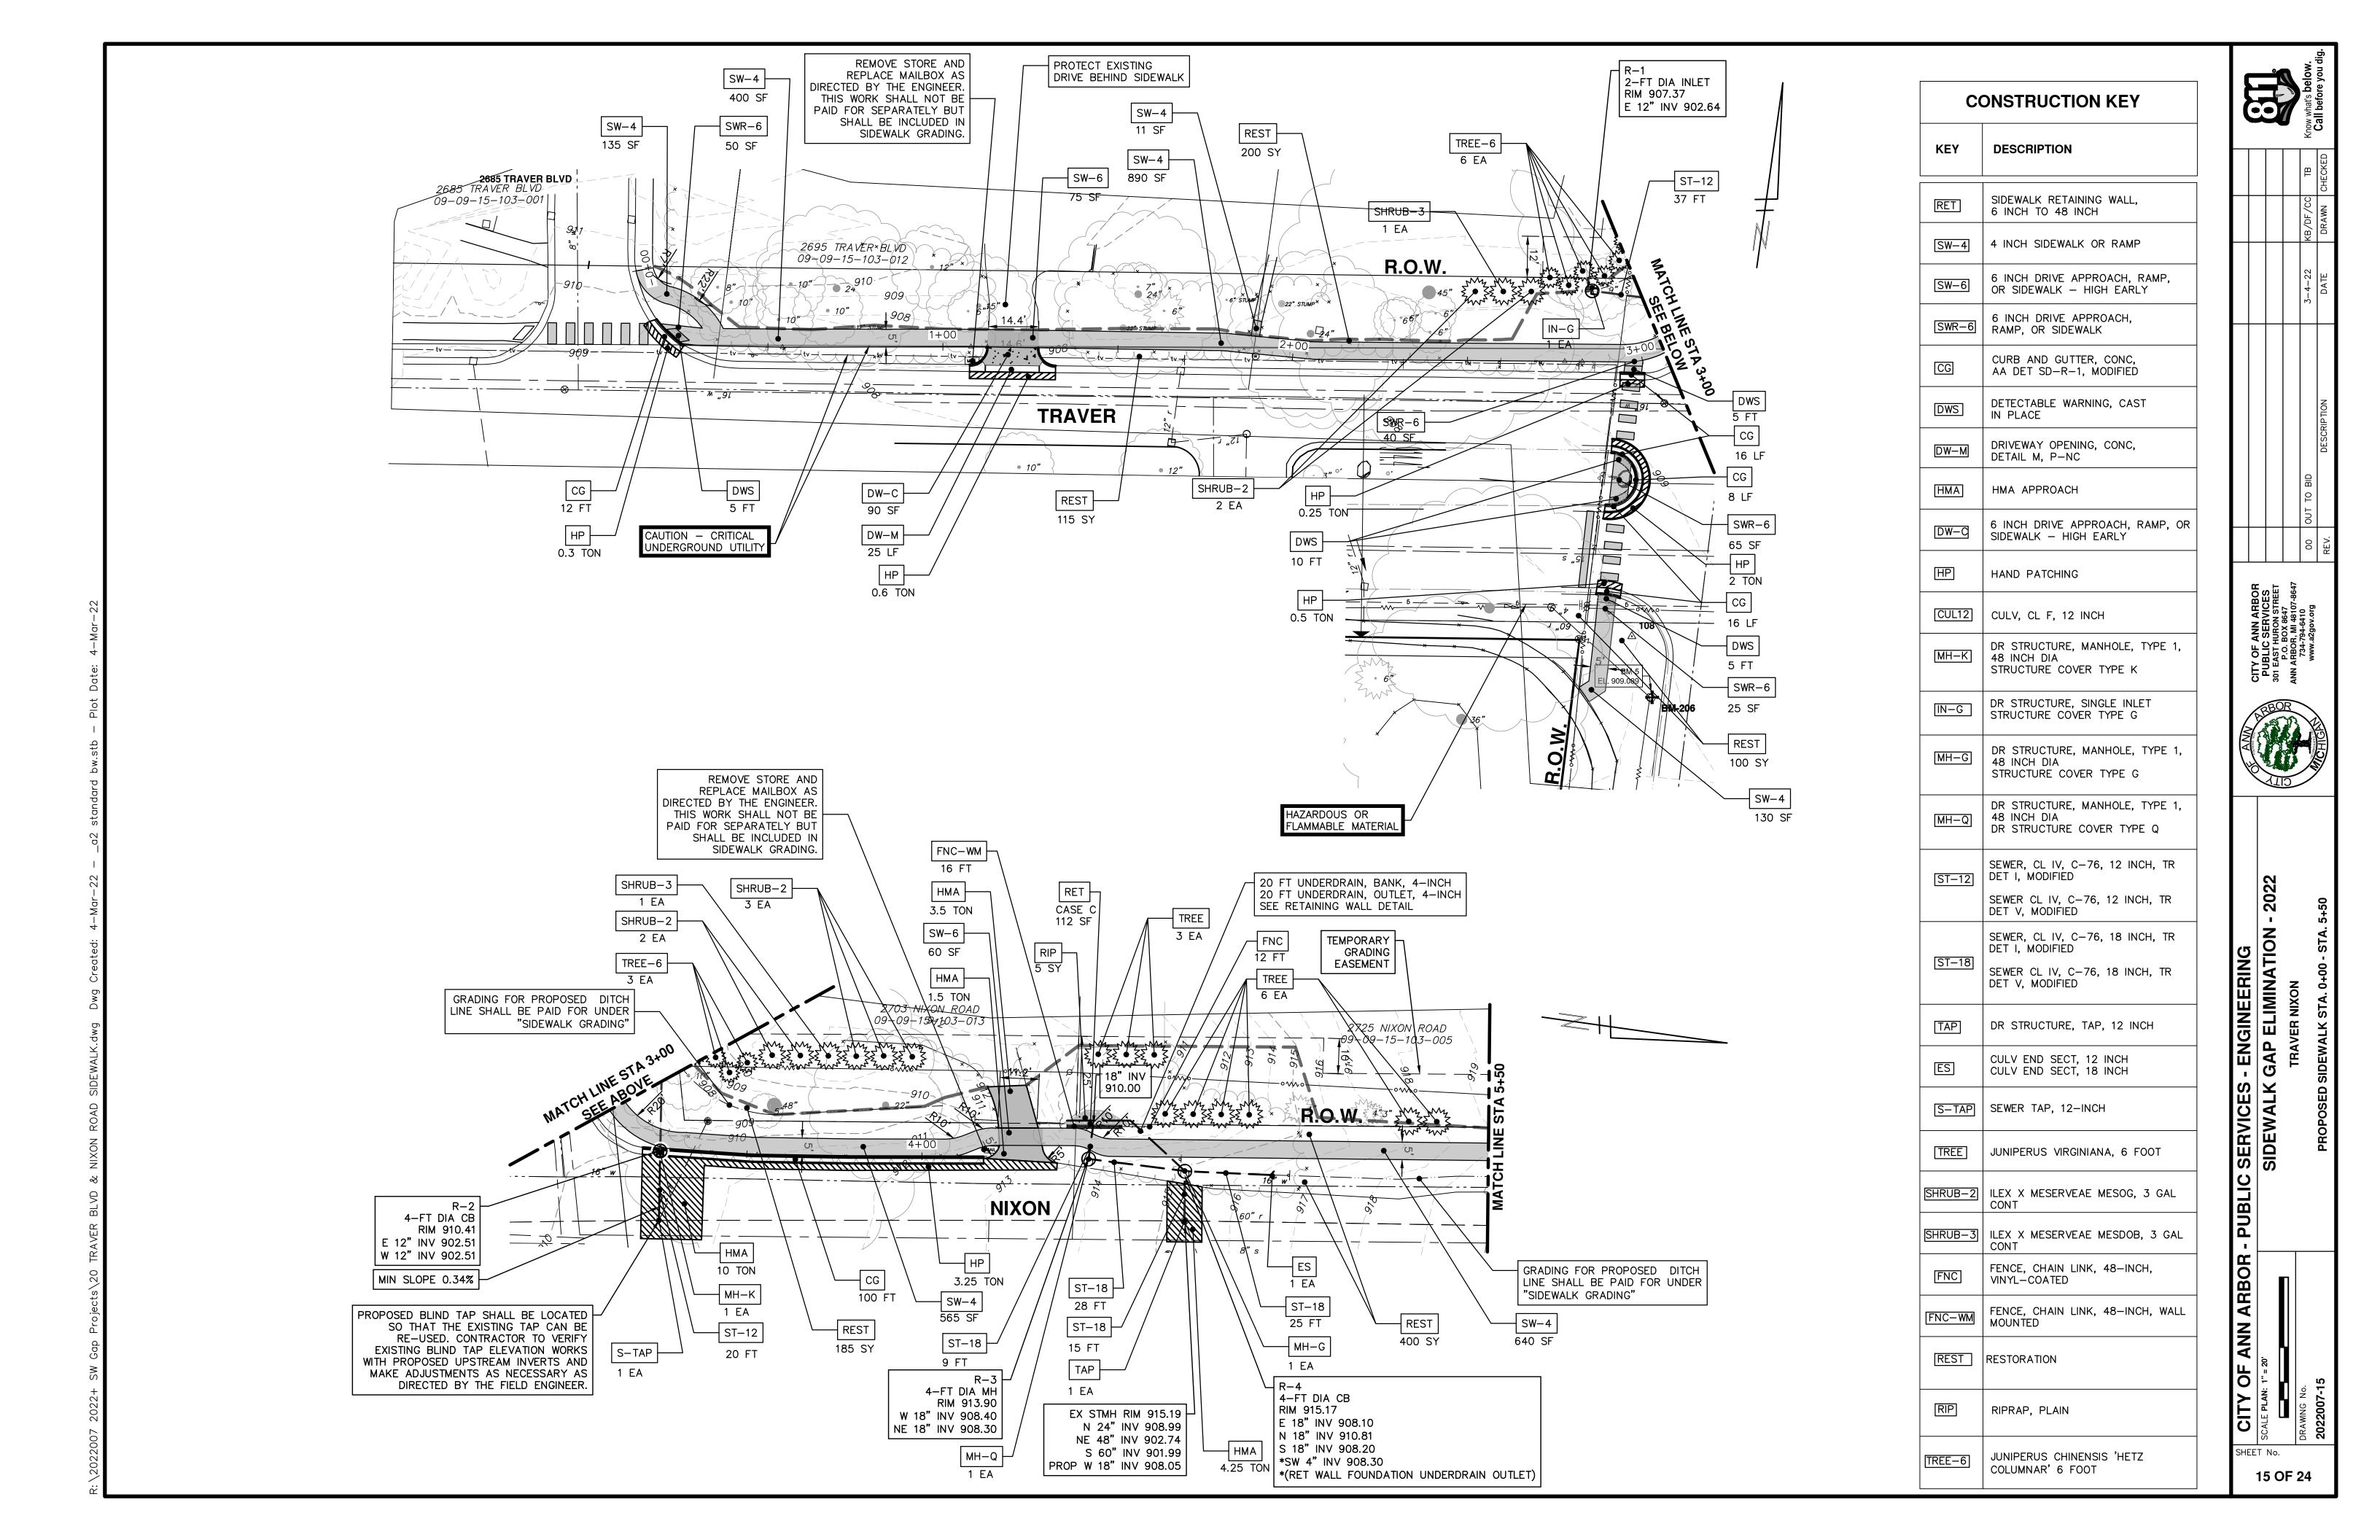

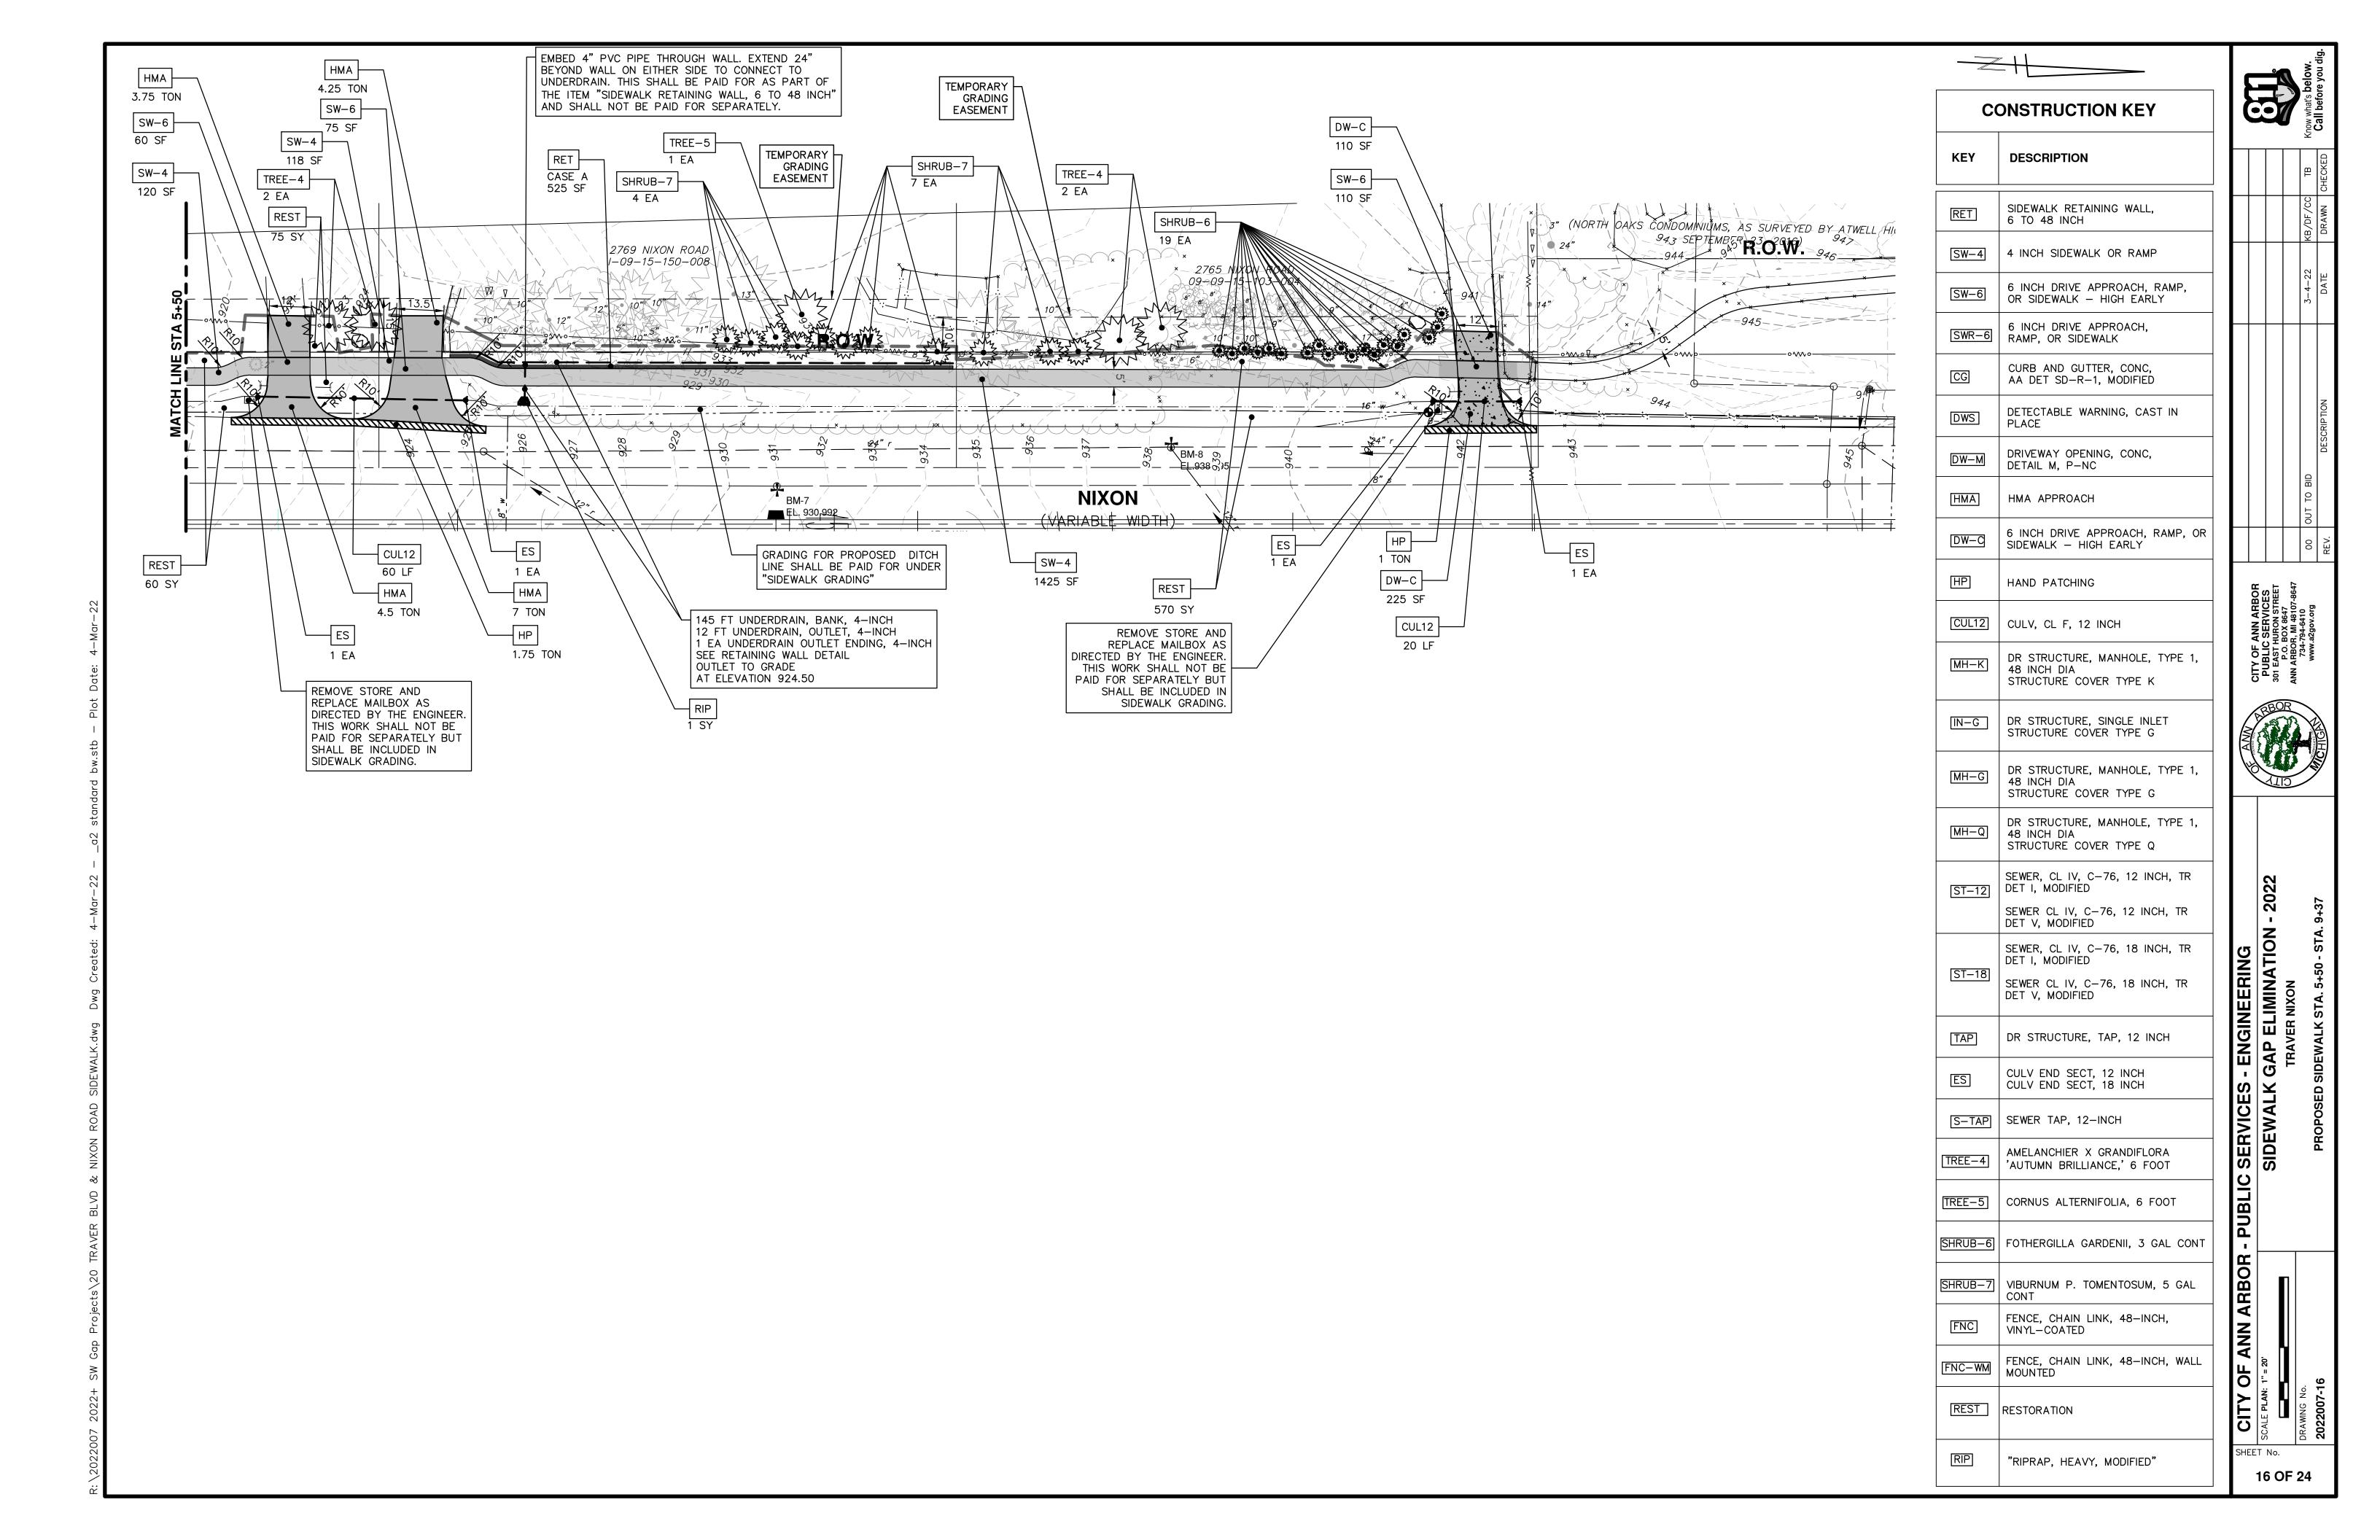


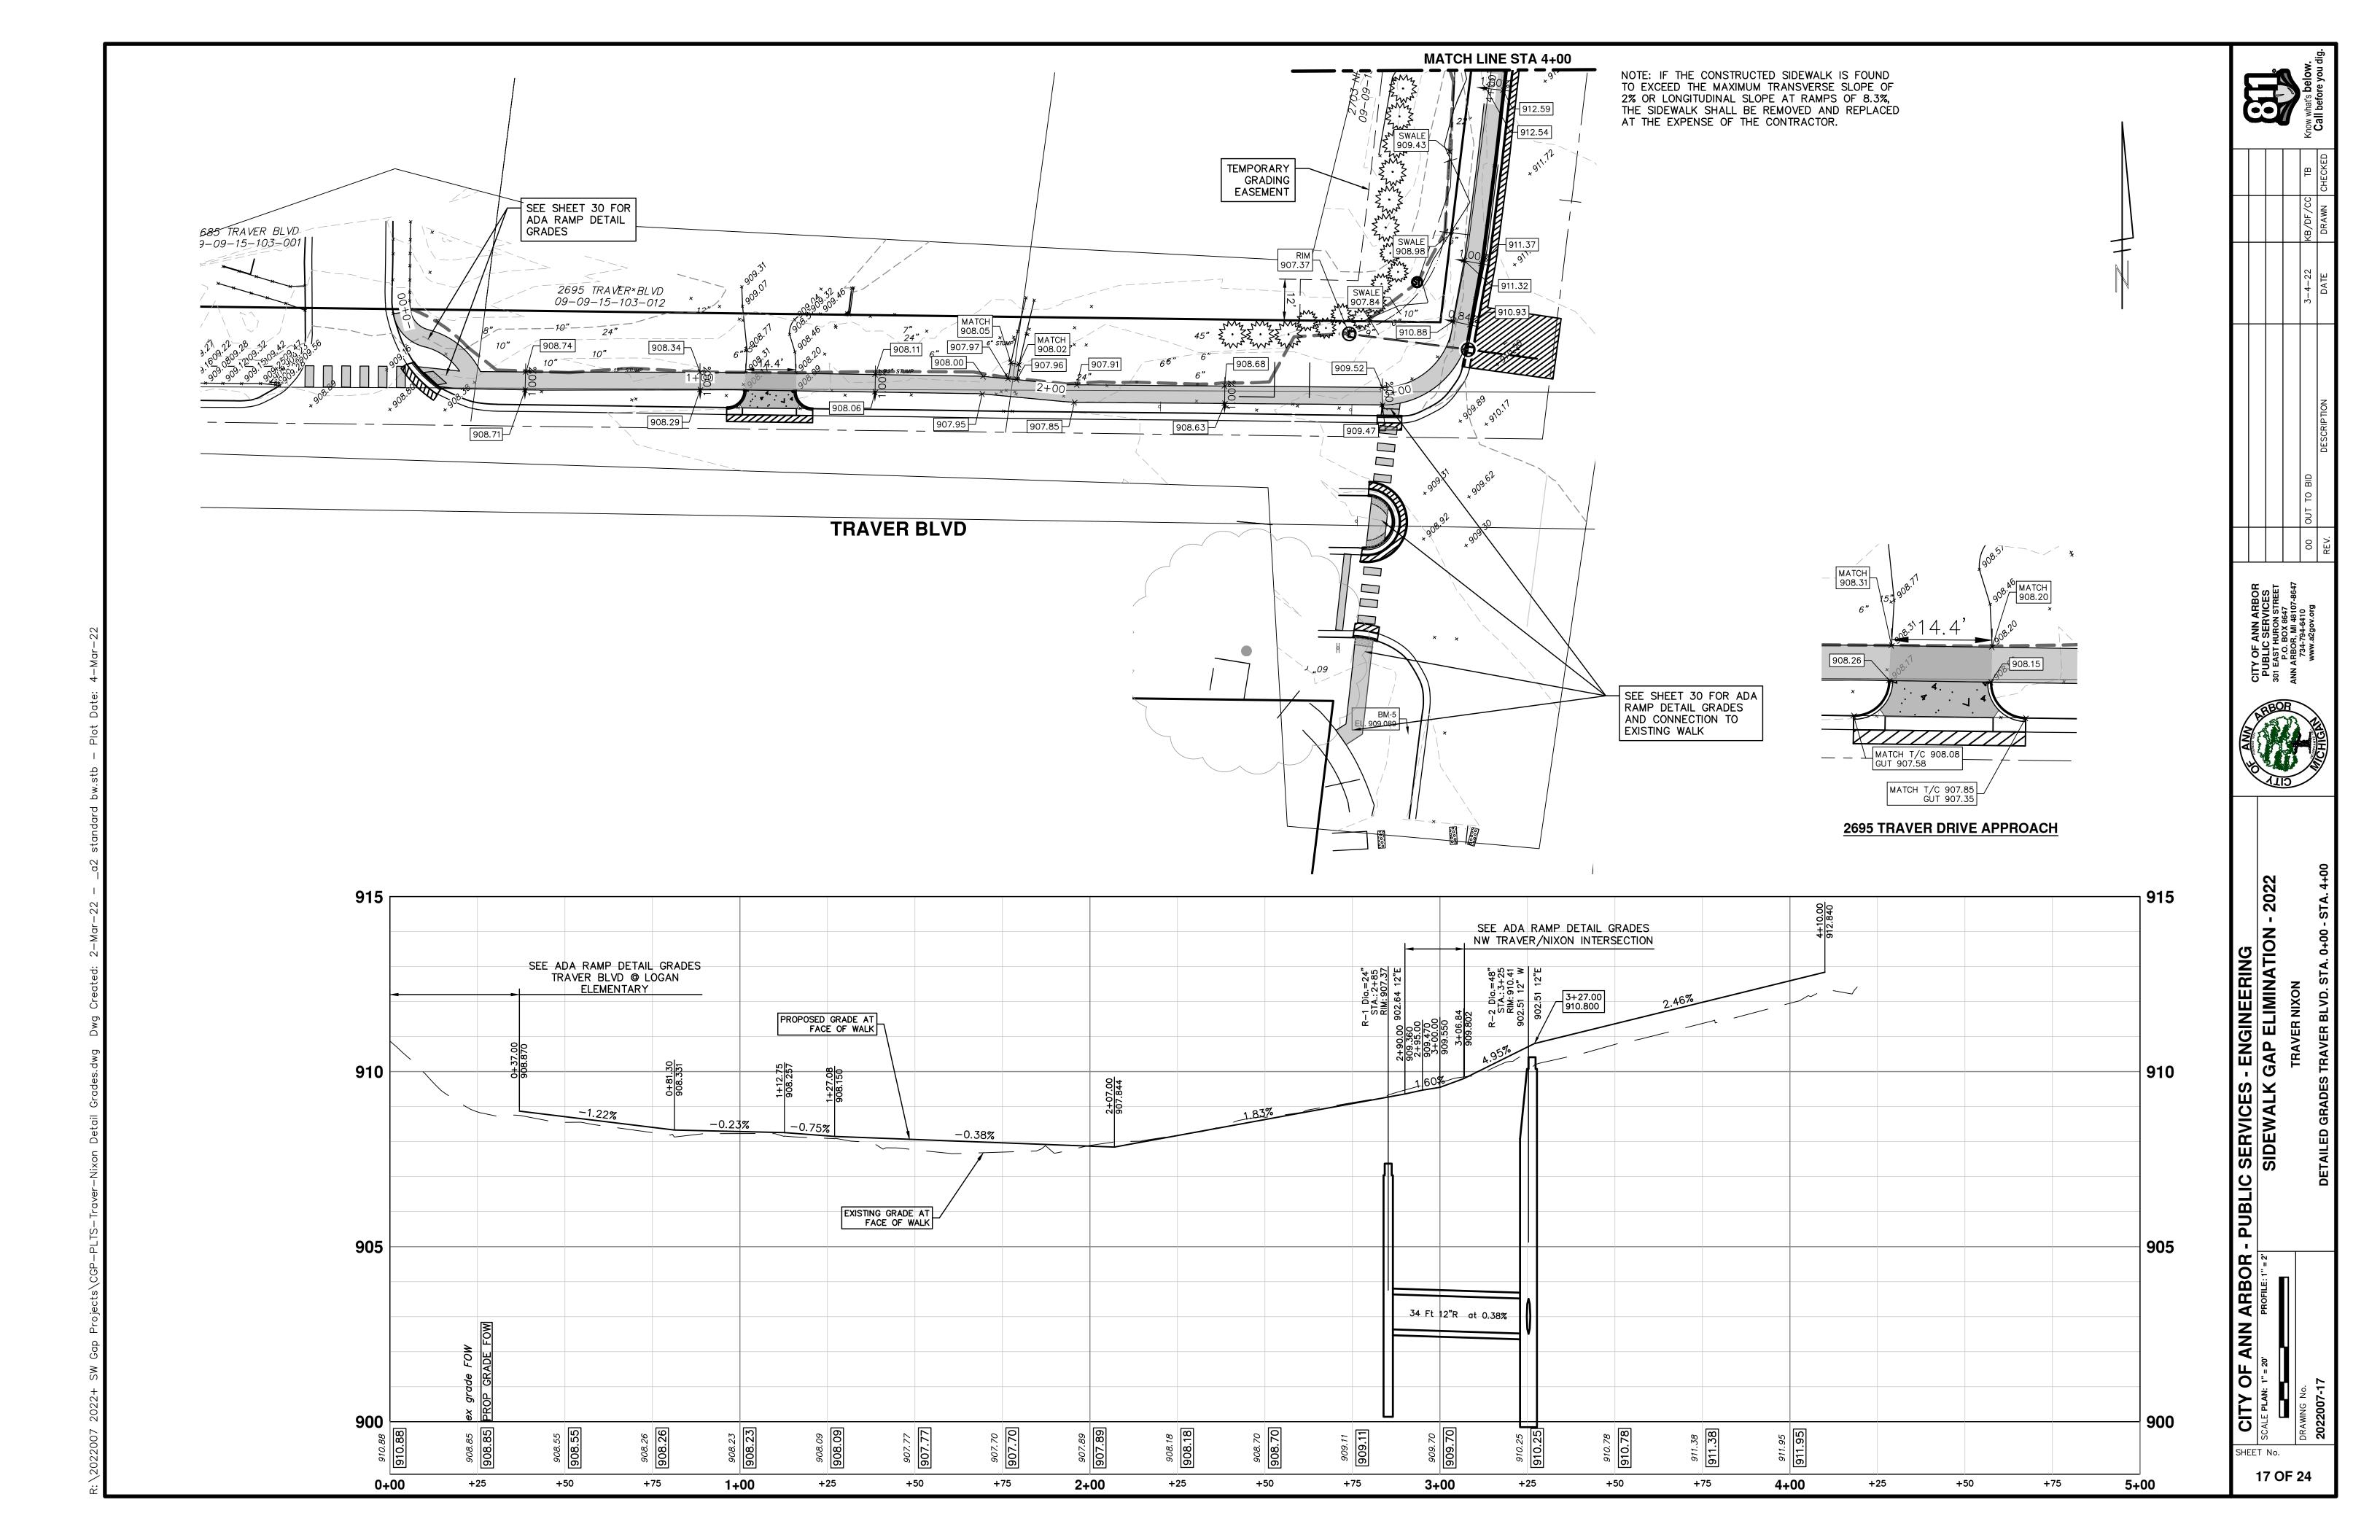


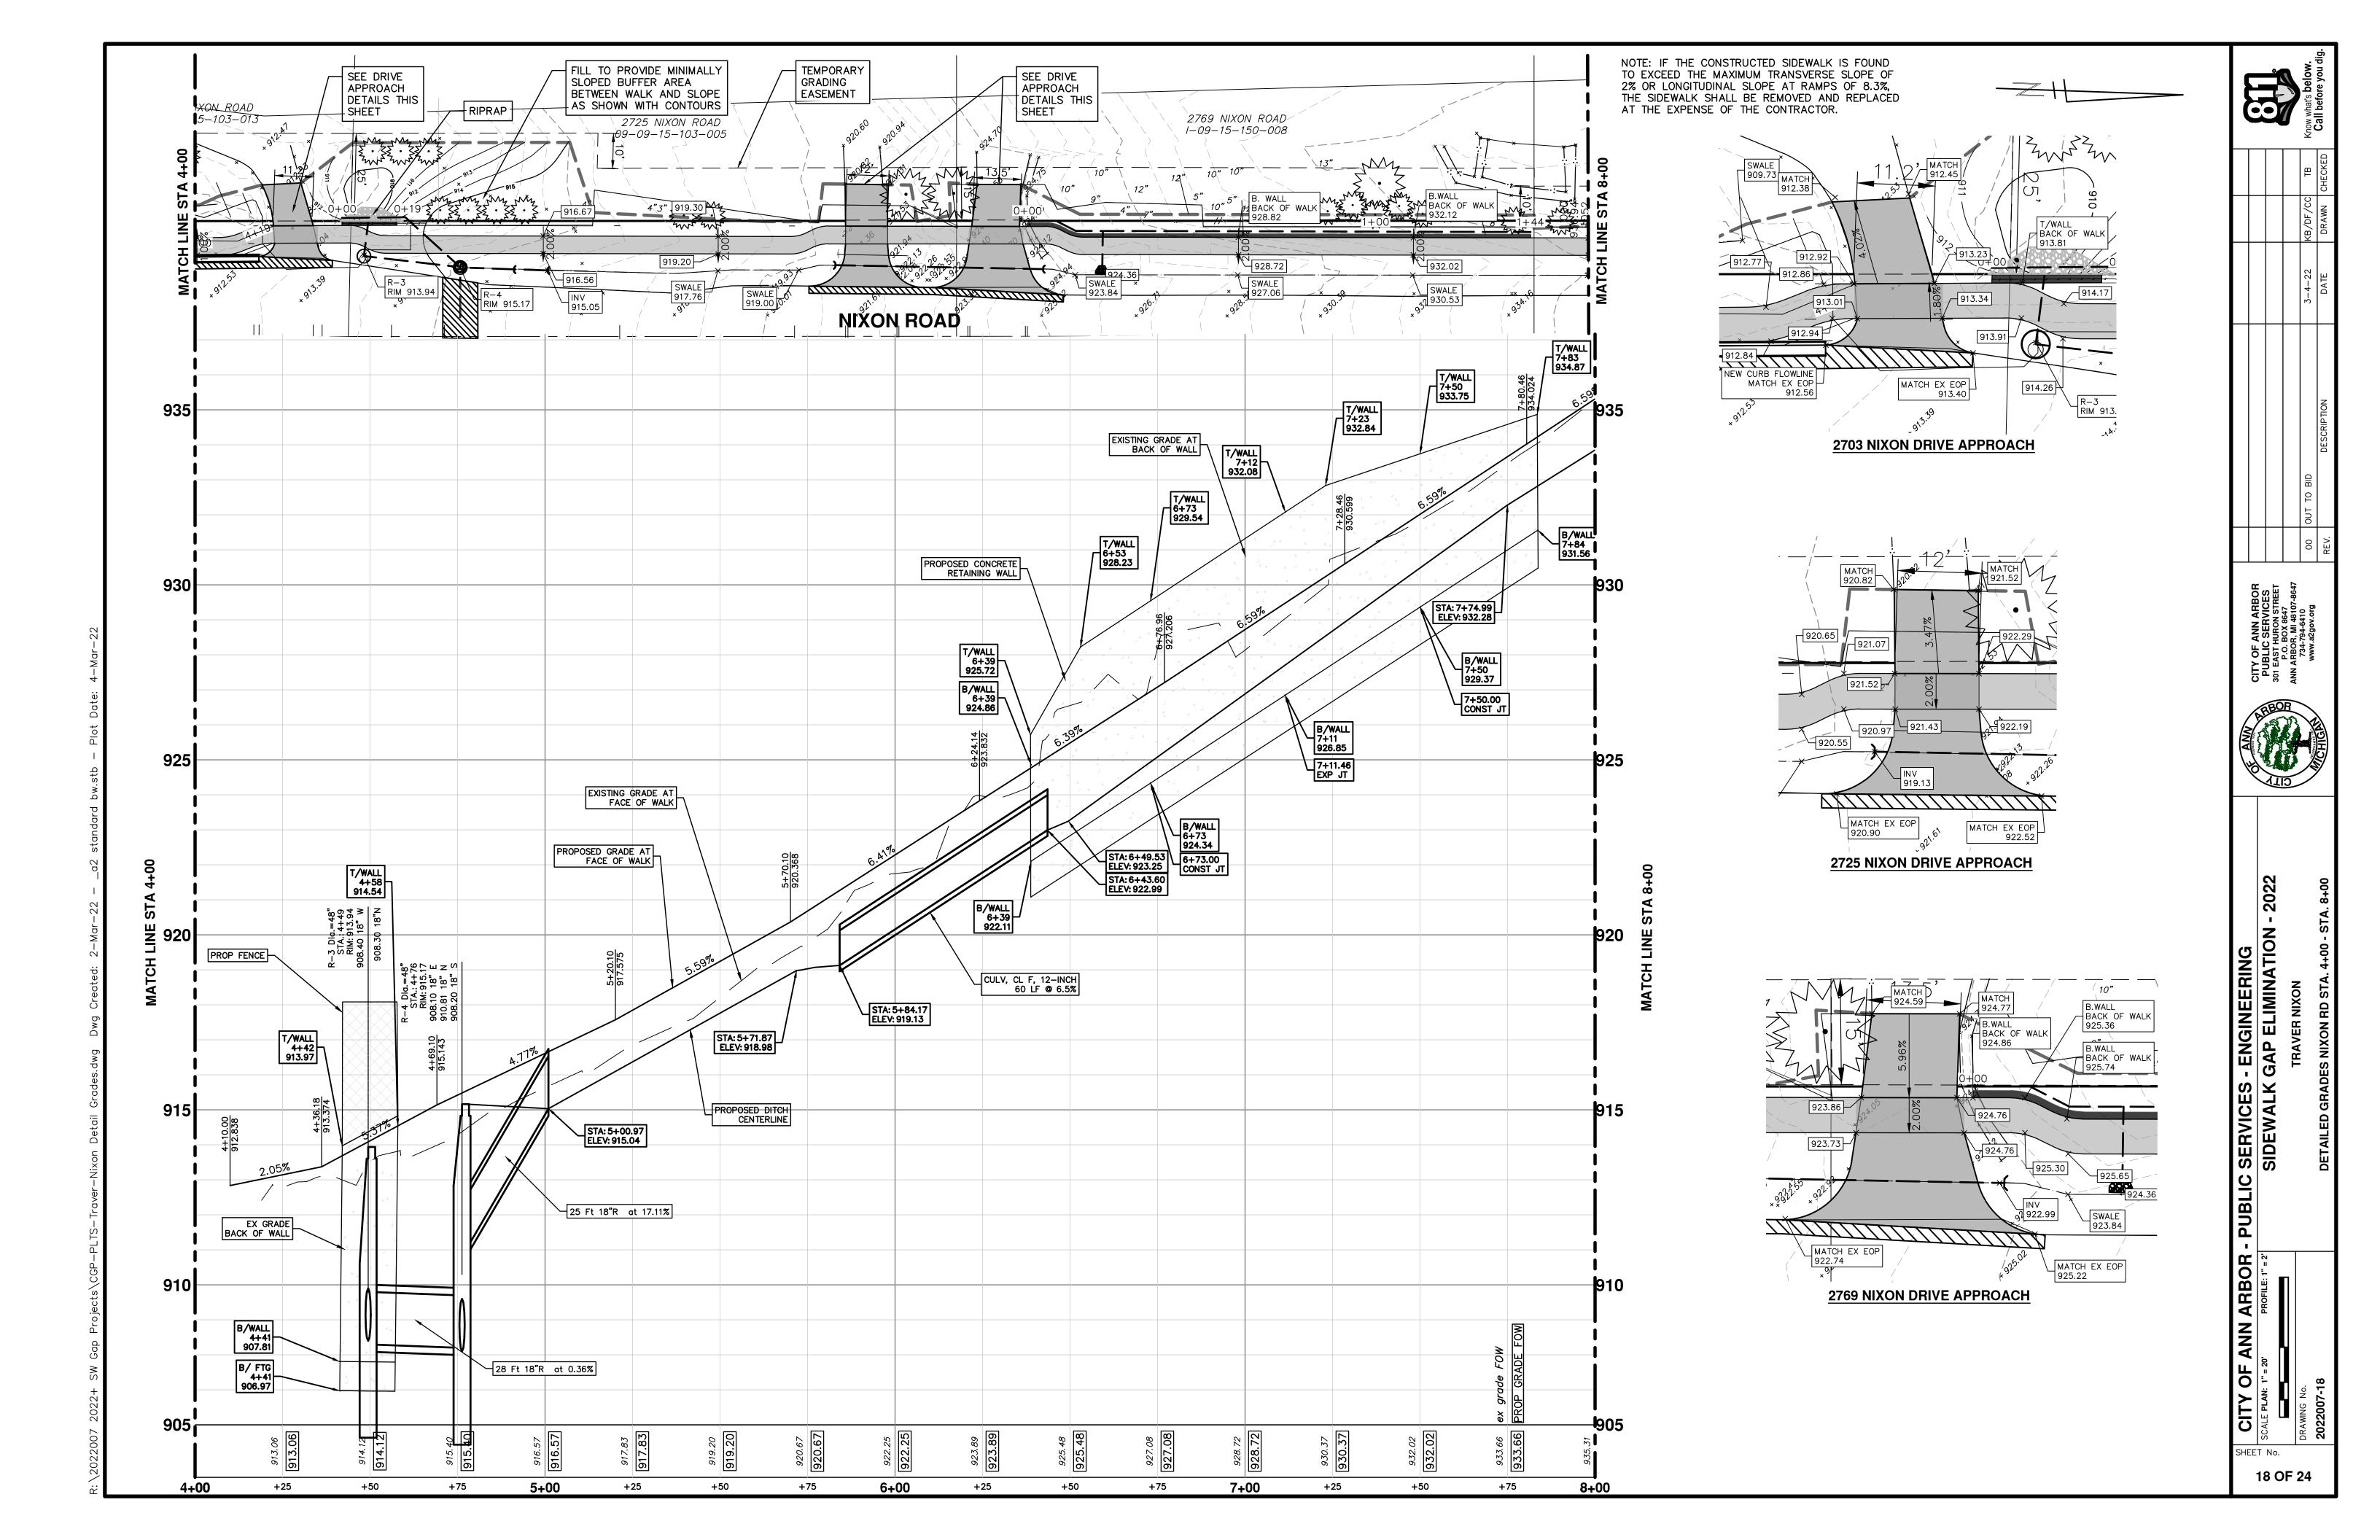

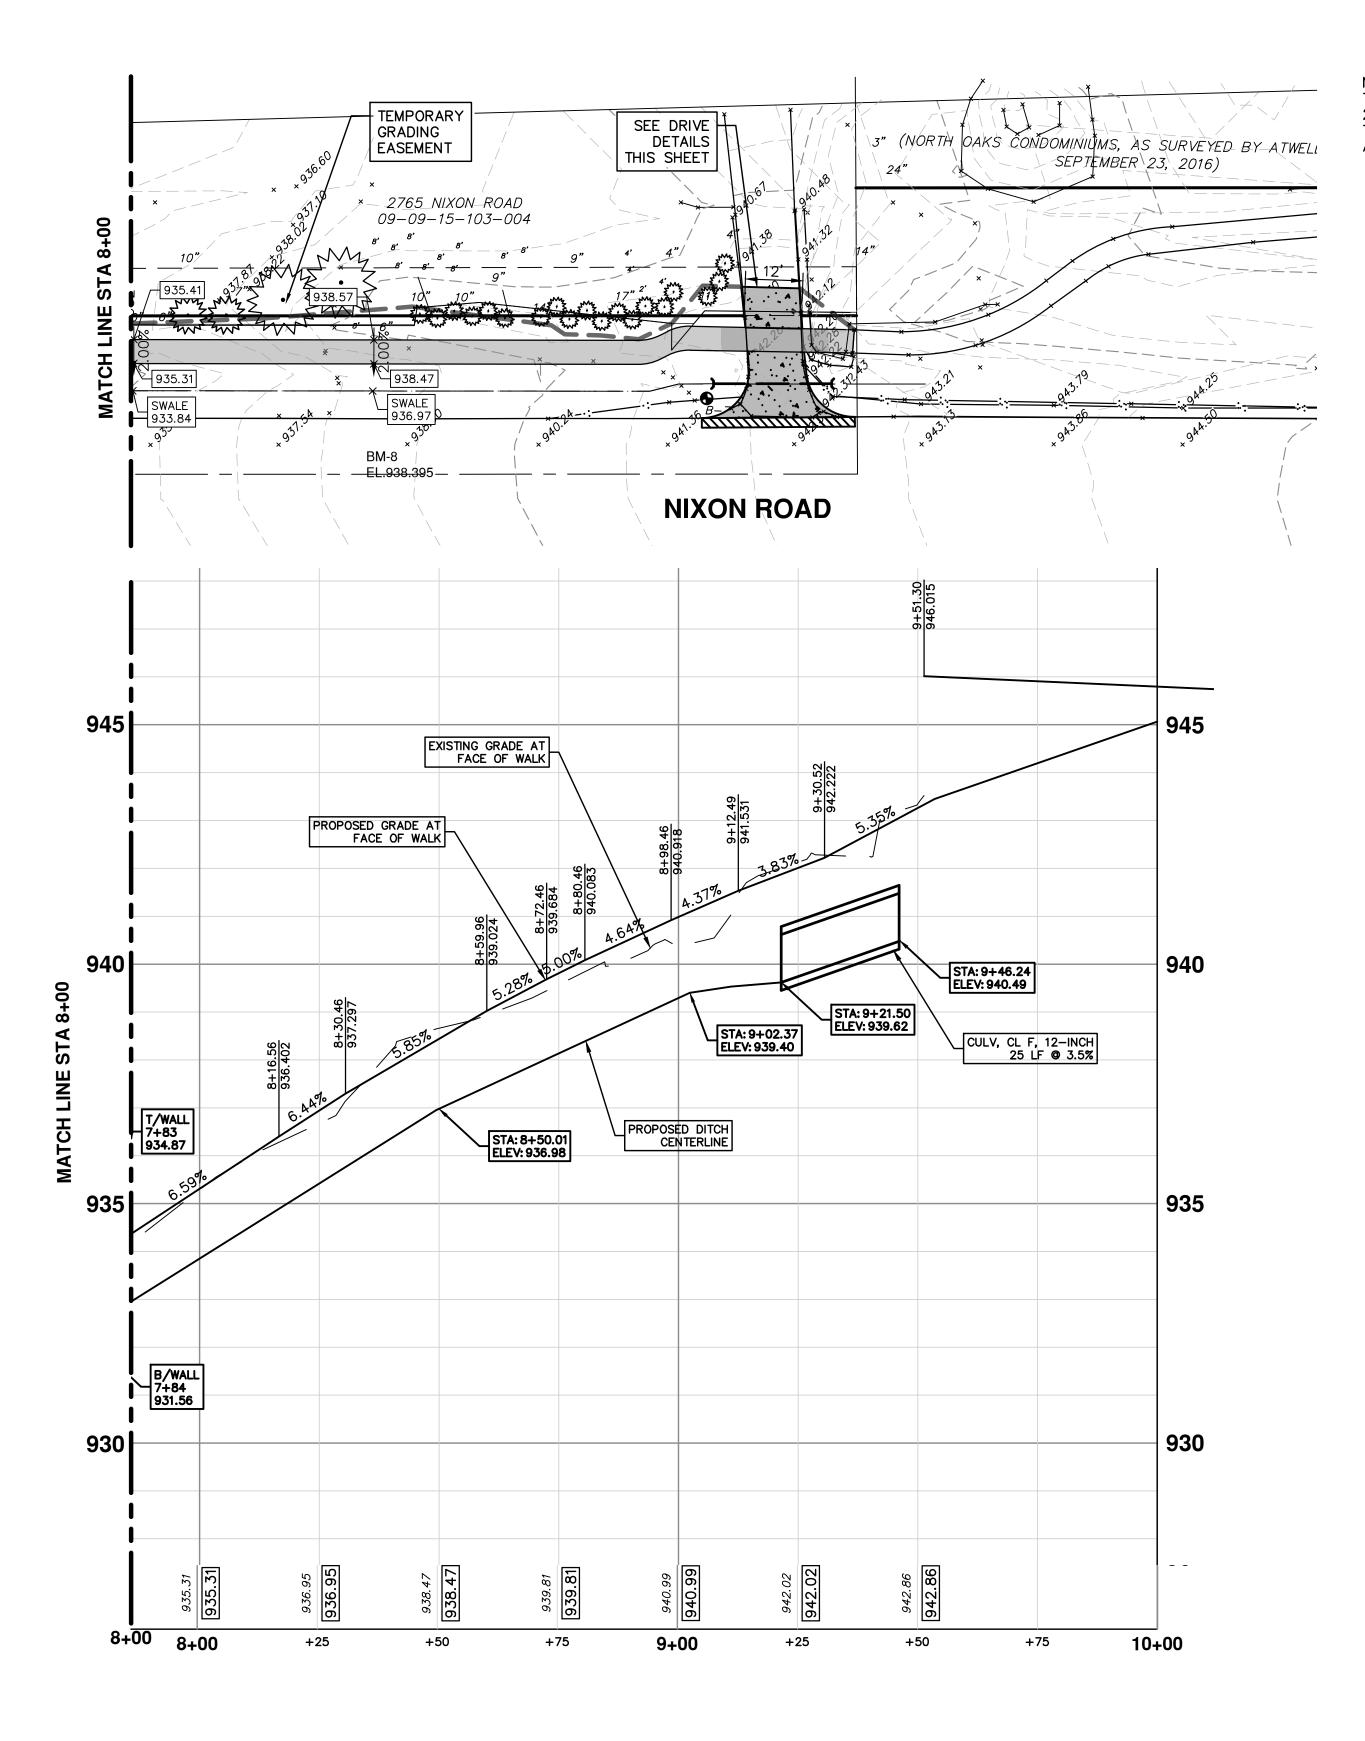

NOTE: IF THE CONSTRUCTED SIDEWALK IS FOUND TO EXCEED THE MAXIMUM TRANSVERSE SLOPE OF 2% OR LONGITUDINAL SLOPE AT RAMPS OF 8.3%, THE SIDEWALK SHALL BE REMOVED AND REPLACED AT THE EXPENSE OF THE CONTRACTOR.

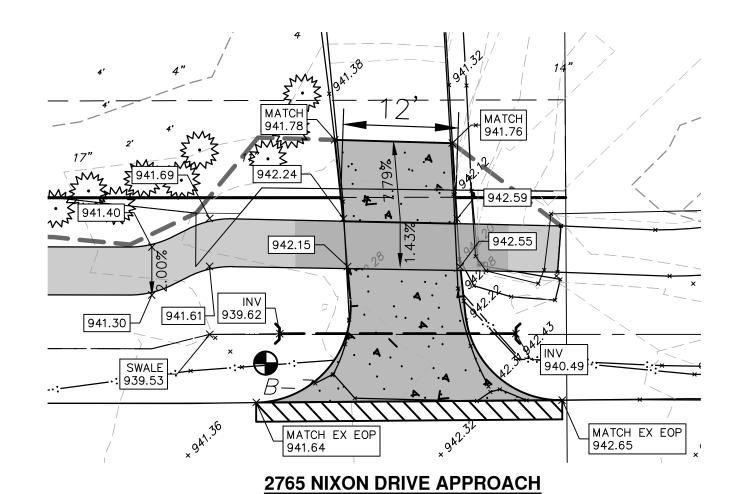

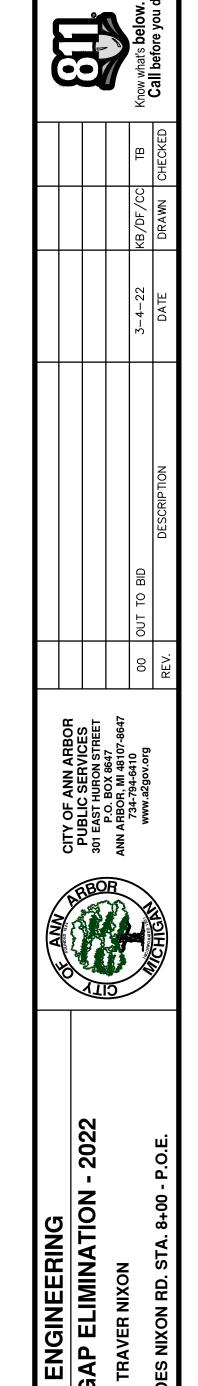



CITY OF ANN ARBOR - PUBLIC SERVICES - ENGINEERING


SCALE PLAN: 1" = 20' PROFILE: 1" = 2' SIDEWALK GAP ELIMINATION


DRAWING NO.


TRAVER NIXON

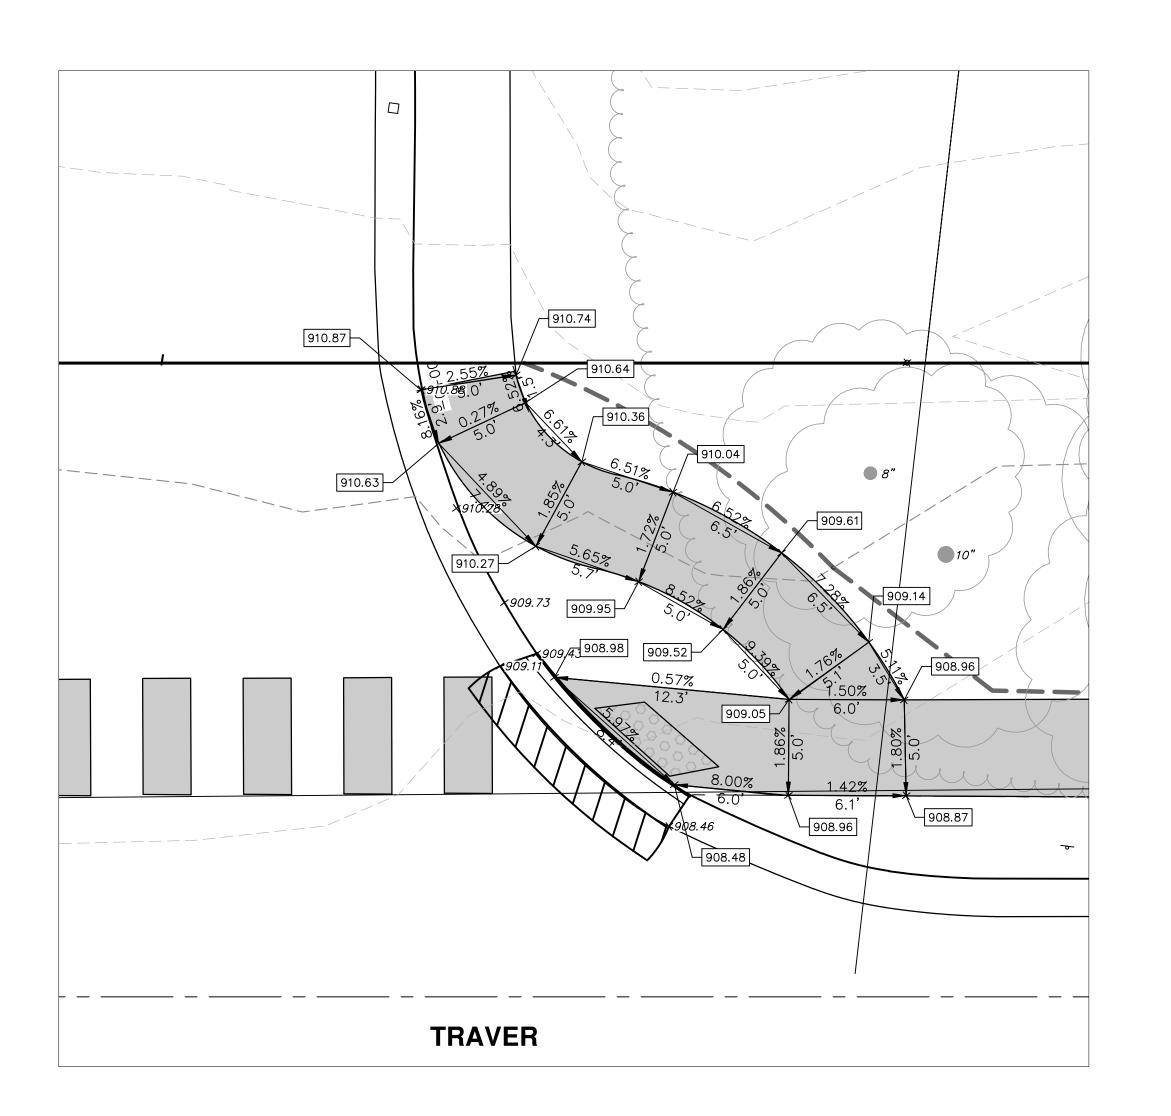


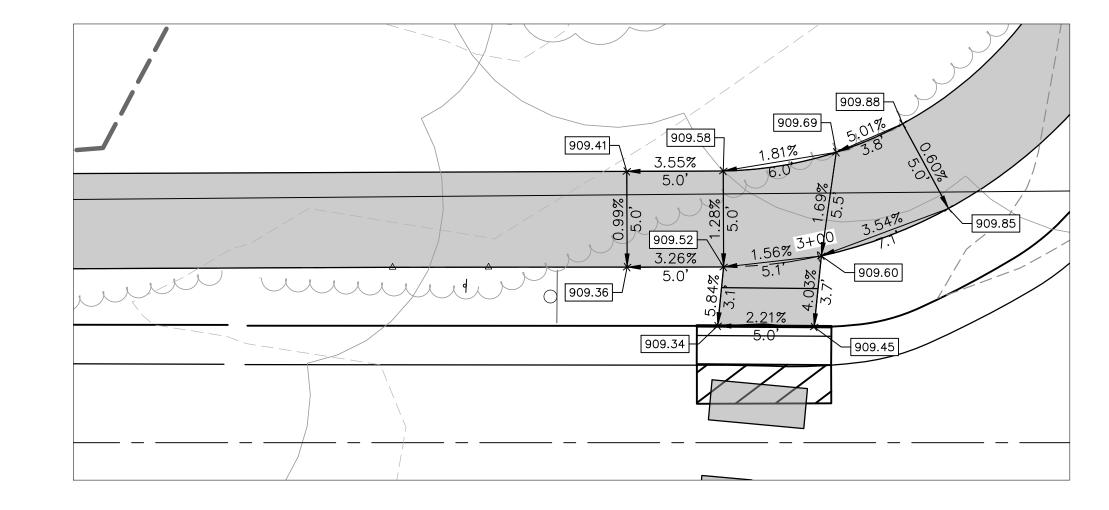


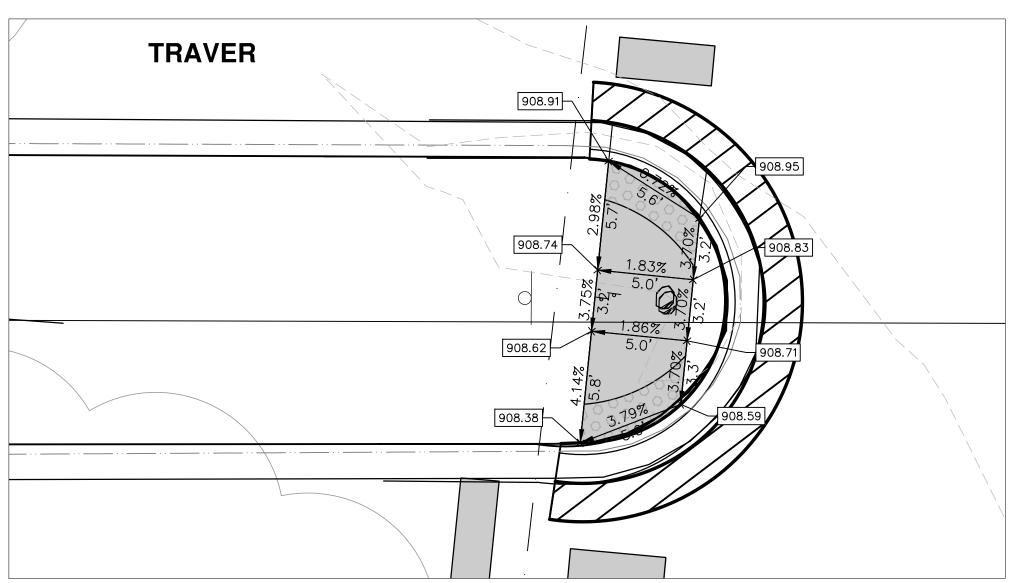

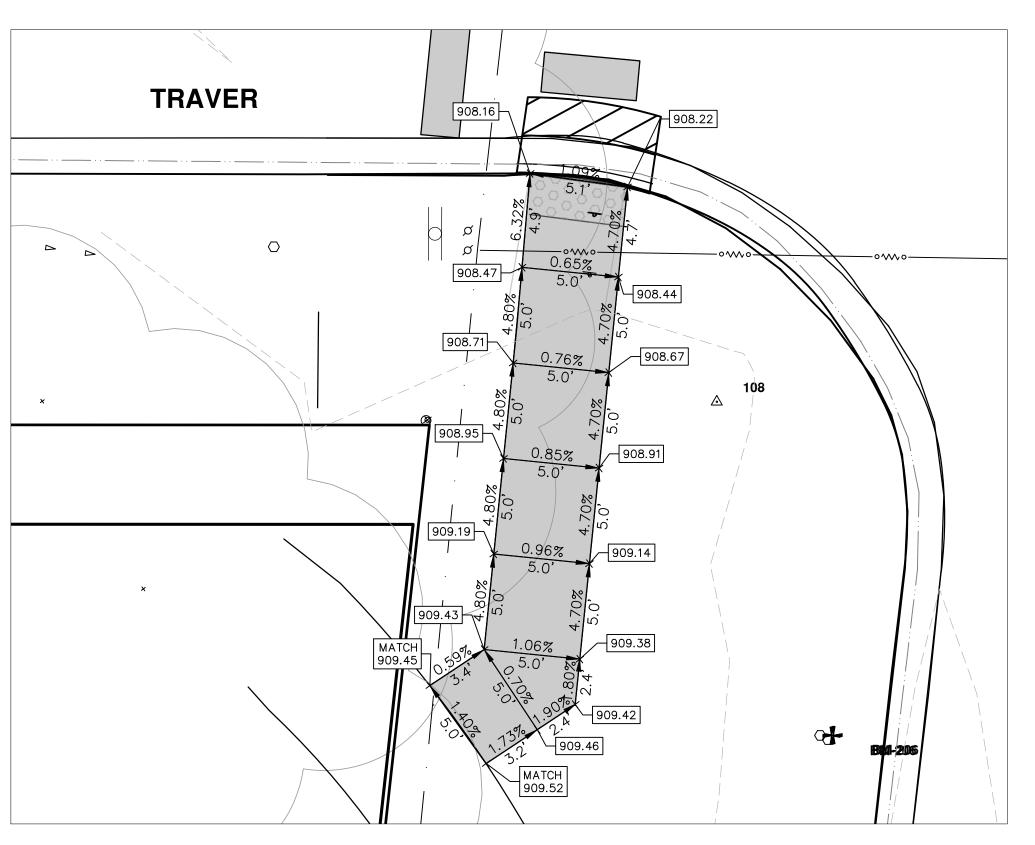

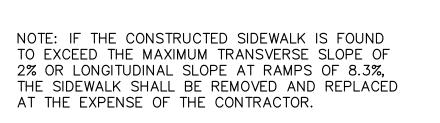

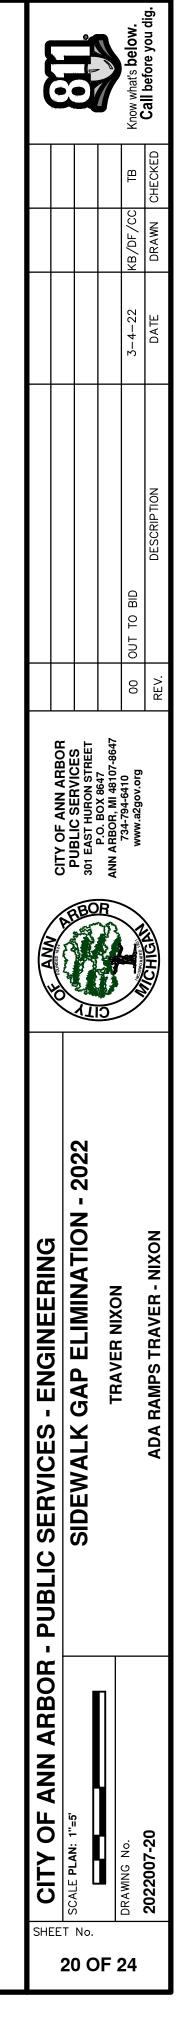

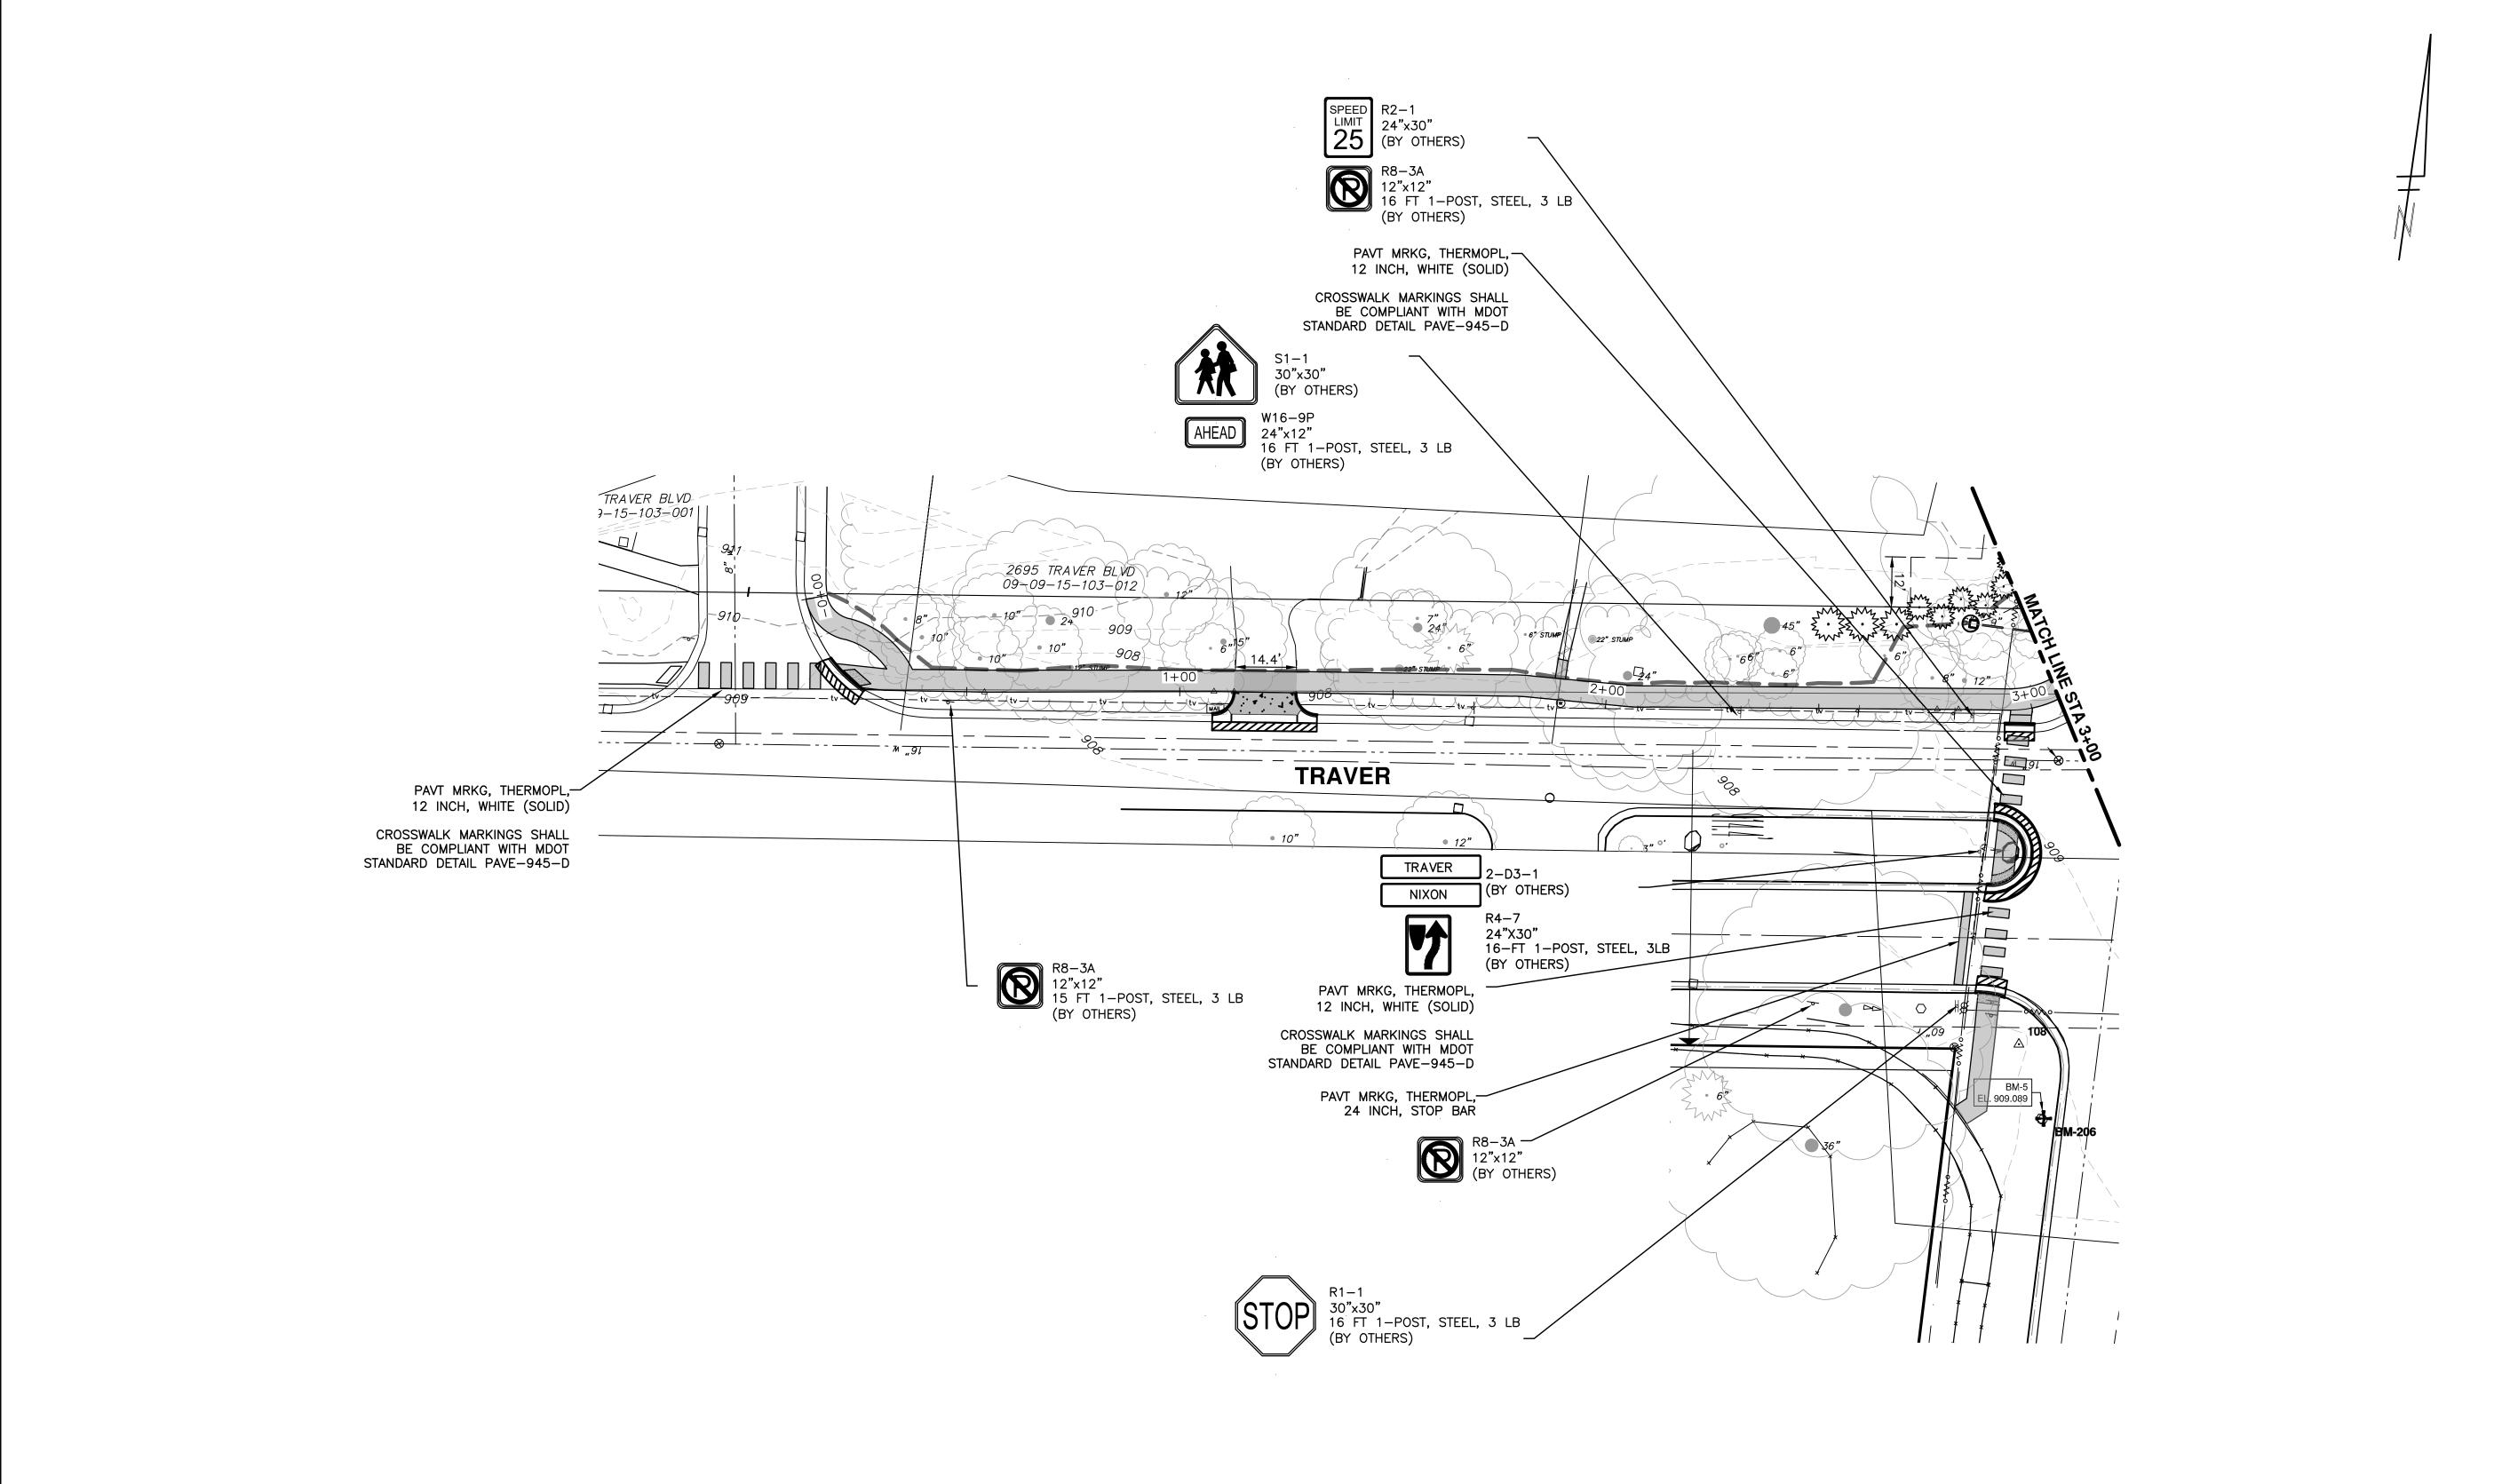

PAVEMENT MARKING QUANTITIES


24 FT PAVT MRKG, THERMOPL, 24 INCH, STOP BAR
136 FT PAVT MRKG, THERMOPL, WHITE, 12 INCH, SOLID

CITY OF ANN ARBOR - PUBLIC SERVICES - ENGINEERING

SCALE PLAN: 1"= 20"

SIDEWALK GAP ELIMINATION

TRAVER NIXON SHEET No. 21 OF 24

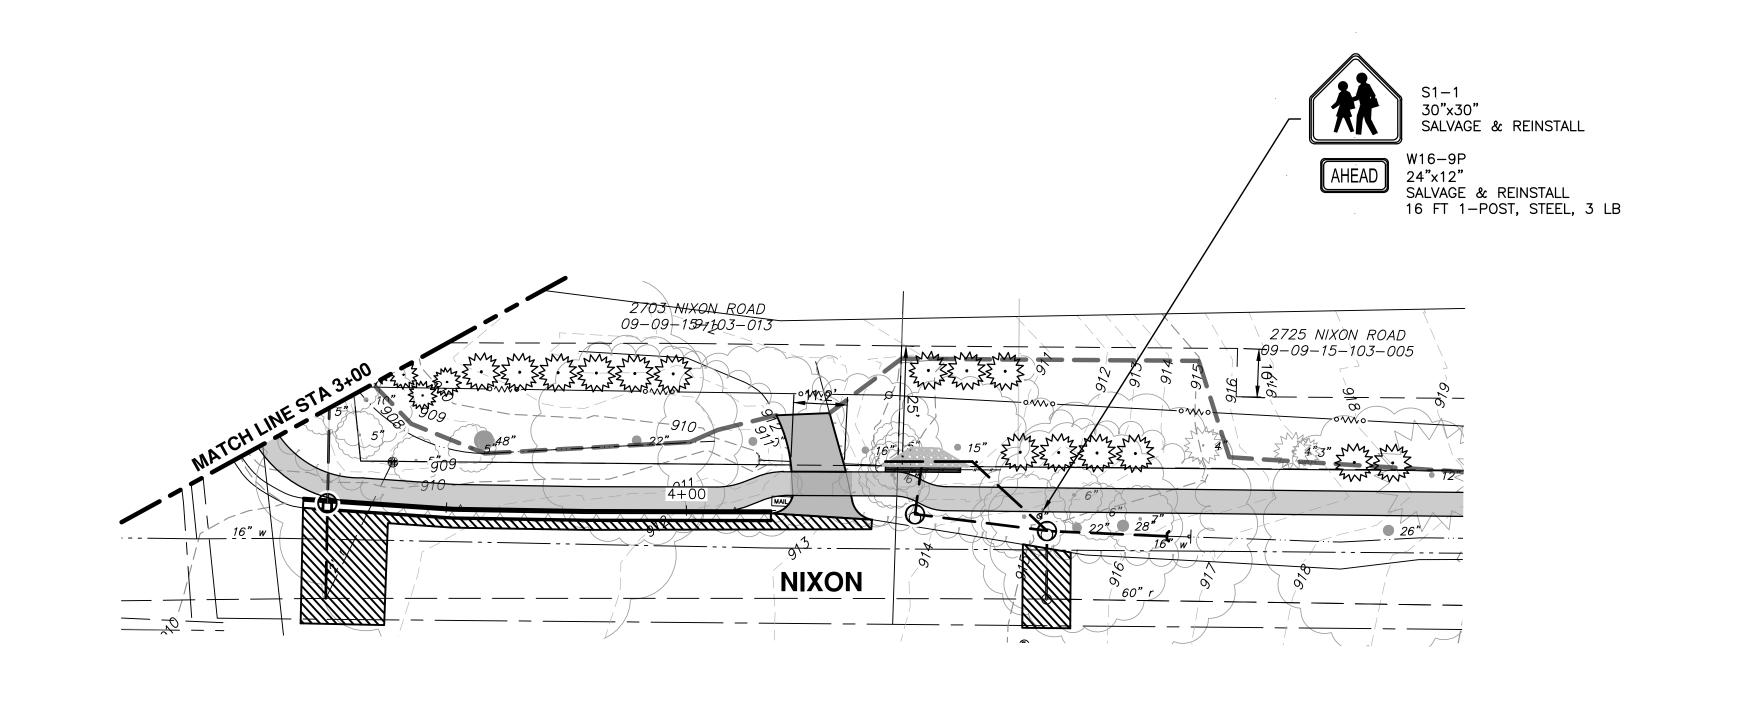



SCALE PLAN: 1" = 20' SIDEWALK GAP ELIMINATION - 2022

DRAWING No.

SIGNAGE AND PAVEMENT MARKINGS NIYON CTA 2.00 CTA

SIGNAGE AND PAVEMENT MARKINGS NIYON CTA 2.00 CTA

