




# ISLAND PARK PEDESTRIAN BRIDGE ABUTMENT REPAIR

BID SET

JANUARY 2015

ITB No. 4349

Stantec Project Number: 2075120212

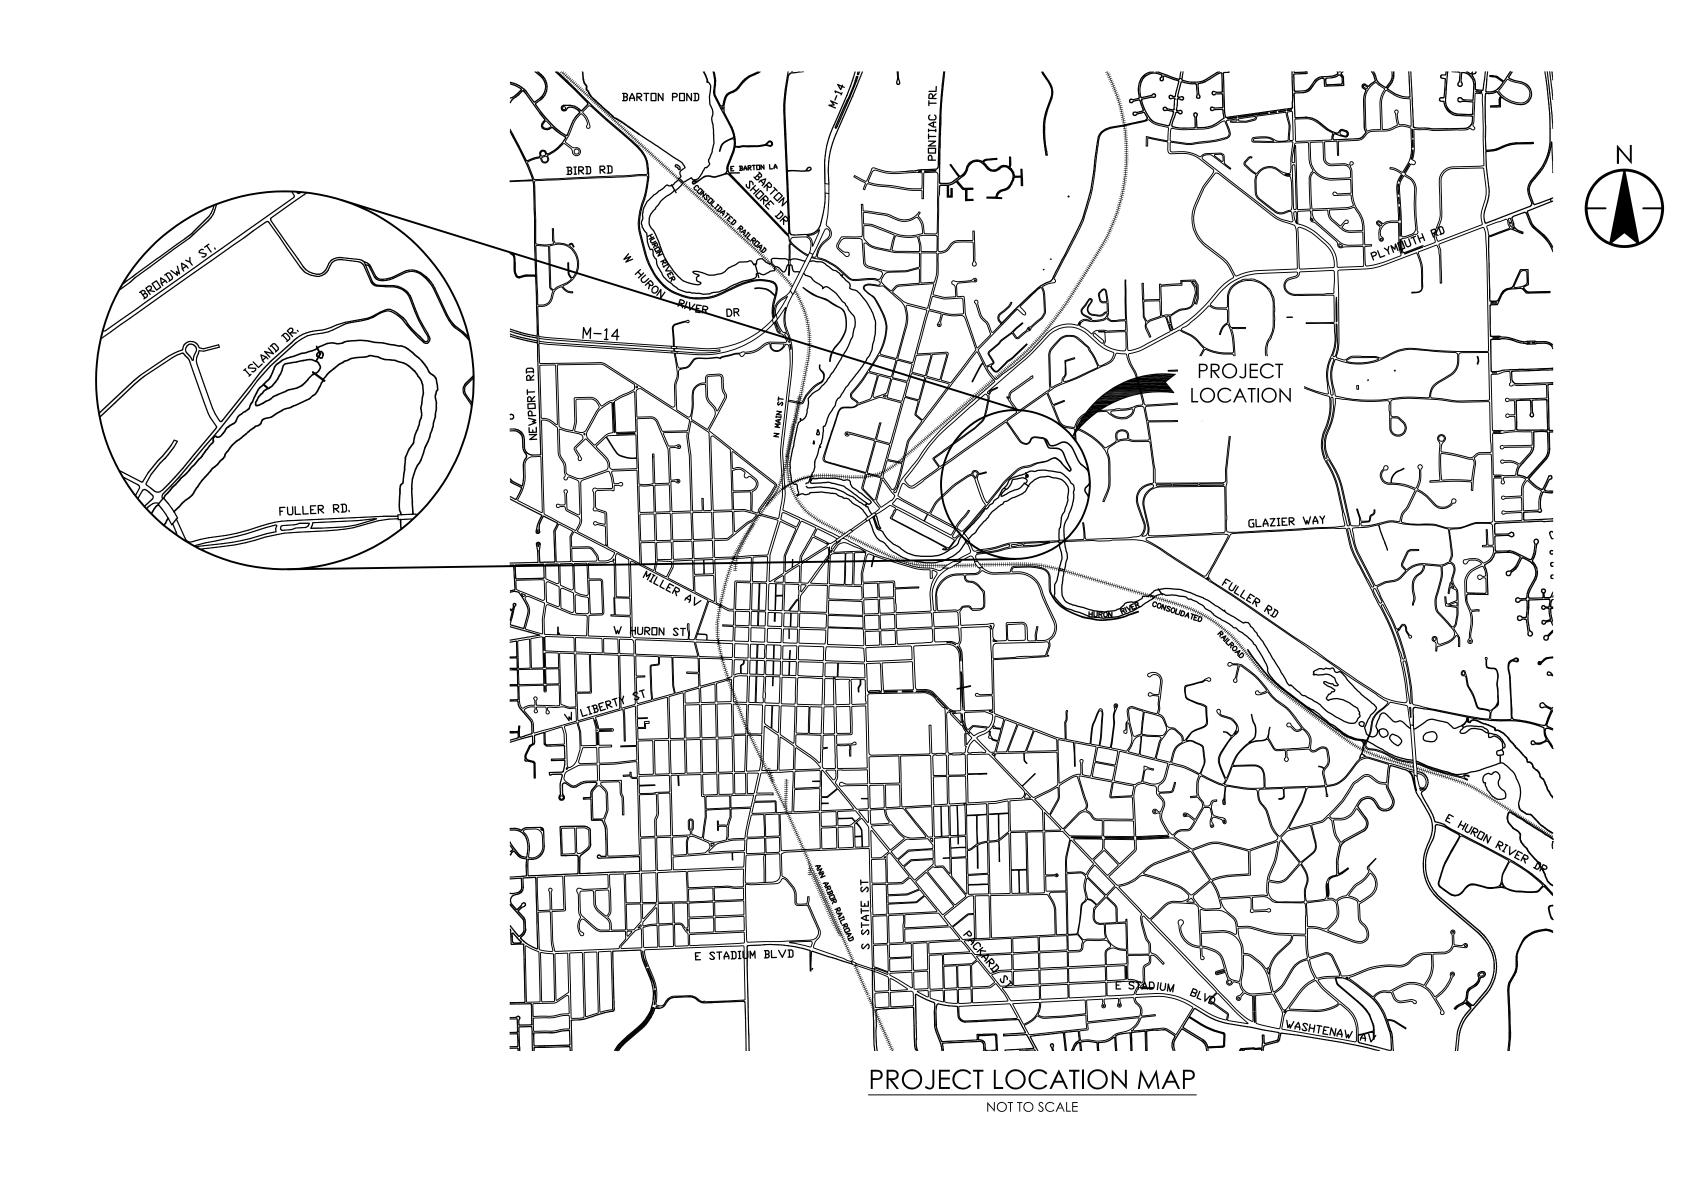

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## **GENERAL NOTES:**

#### <u>GENERAL</u>

- 1. ALL WORK SHALL CONFORM TO ALL REQUIREMENTS OF MIOSHA, AND OSHA.
- 2. DIMENSIONS AND ELEVATIONS SHOWN ON EXISTING STRUCTURES ARE APPROXIMATE ONLY. THE CONTRACTOR IS RESPONSIBLE FOR VERIFYING WITH FIELD MEASUREMENTS, ALL DIMENSIONS AND ELEVATIONS WHICH ARE REQUIRED FOR FABRICATION AND INSTALLATION OF REPAIRS TO STRUCTURES BEING MADE UNDER THIS CONTRACT. CONTRACTOR SHALL VERIFY ALL DIMENSIONS BEFORE PROCEEDING WITH THE REPAIRS.
- 3. ALL NEW REINFORCING STEEL AND WIRE TIES SHALL BE EPOXY COATED.
- 4. ANY EXISTING REINFORCING STEEL EXPOSED DURING THE DEMOLITION SHALL BE HANDTOOL CLEANED WITH SCOTCH BRITE AND PROTECTED WITH CORROSION INHIBITOR PRIOR TO CONCRETE REPAIRS.
- 5. CONCRETE TRUCKS SHALL NOT BE PERMITTED ON THE BANKS OF THE RIVER. CONCRETE PLACEMENT SHALL BE BY WHEELBARROW, PUMP, OR OTHER OWNER/OWNER REPRESENTATIVE APPROVED MEANS.
- 6. EXCAVATE AS NECESSARY AND BACKFILL.
- 7. CONTRACTOR IS NOT PERMITTED TO BLOCK OR RESTRICT ACCESS TO THE PARKS PAVILION AND RESTROOMS.
- 8. CONTRACTOR IS NOT PERMITTED TO USE THE PARKS RESTROOM FACILITIES.
- 9. CONTRACTOR SHALL SUBMIT A FOLIAGE REMOVAL PLAN FOR REVIEW AND APPROVAL BY THE OWNER/OWNER'S REPRESENTATIVE. NO TREES SHALL BE REMOVED WITHOUT PRIOR APPROVAL BY THE OWNER. CONTRACTOR SHALL REPLACE ANY TREES REMOVED TO PERFORM THE WORK.
- 10. CONTRACTOR SHALL REPAIR ALL CRACKS IN THE ABUTMENTS WITH SIKA INJECTOCEM-190 OR APPROVED EQUIVALENT.
- 11. CONTRACTOR IS TO REPAIR ANY DAMAGE TO THE BRIDGE GUARDRAIL SYSTEM, AND PRESTRESSED CONCRETE SPAN CAUSED DURING THE COURSE OF THE PROJECT.
- 12. NO LARGE VEHICLES WILL HAVE ACCESS TO THE SOUTH ABUTMENT. CONTRACTOR SHALL PROVIDE A LIST OF ANY VEHICLES TO HAVE ACCESS TO THE SOUTH ABUTMENT FOR REVIEW AND APPROVAL.

## **DEMOLITION**

- 1. PROVIDE WRITTEN PLAN AND DESCRIPTION OF ALL DEMOLITION ON EXISTING STRUCTURES, FOR REVIEW AND APPROVAL PRIOR TO BEGINNING WORK.
- 2. PROVIDE MEASURES TO PREVENT ANY NEW OR DEMOLISHED CONCRETE AND/OR DEBRIS FROM ENTERING THE RIVER WATER. THE MEASURES TO BE PROVIDED SHALL BE SUBMITTED TO THE OWNER/OWNER'S REPRESENTATIVE FOR REVIEW AND APPROVAL.
- 3. SAW CUTS SHALL BE MADE FOR ALL FORM/POUR REPAIRS. PROVIDE CLEAN, DEFINED, PARALLEL OR PERPENDICULAR LINES. ANY REINFORCING STEEL THAT IS CUT SHALL BE REPLACED BY THE CONTRACTOR AND IS CONSIDERED INCIDENTAL TO THIS CONTRACT. IN GENERAL, WHEN REMOVING CONCRETE THE CONTRACTOR SHALL ATTEMPT TO PRESERVE REINFORCING STEEL UNLESS SHOWN ON THE DRAWINGS OR APPROVED BY THE OWNER/OWNER'S REPRESENTATIVE.
- 4. DETERMINE ALL DIMENSIONS AND THE EXTENT OF ALL REMOVAL, WITH THE OWNER/OWNER'S REPRESENTATIVE PRIOR TO THE START OF DEMOLITION. DETERIORATED CONCRETE SHALL BE REMOVED TO SOUND MATERIAL. THE EXTENT OF THE CONCRETE REMOVAL AND REPAIR MAY VARY FROM THAT SHOWN ON THE DRAWINGS. REPAIRS BEYOND THE LIMITS IDENTIFIED IN THE PLAN SET MUST BE AUTHORIZED BY THE OWNER/OWNER'S REPRESENTATIVE PRIOR TO DEMOLITION.
- 5. TAKE ALL NECESSARY MEASURES TO PREVENT DAMAGE TO THE EXISTING STRUCTURES PRIOR TO DEMOLITION WORK. ALL DAMAGE SHALL BE REPAIRED TO THE COMPLETE SATISFACTION OF THE OWNER/OWNER'S REPRESENTATIVE AT THE CONTRACTORS EXPENSE.
- 6. IF FRACTURE OF ADJACENT CONCRETE OCCURS DURING DEMOLITION WORK, THE REPAIR SHALL BE WITH AN ENGINEER APPROVED PRESSURE INJECTED EPOXY, TO THE COMPLETE SATISFACTION OF THE ENGINEER, AT THE CONTRACTORS EXPENSE.
- 7. CONTRACTOR SHALL PROPERLY SUPPORT ABUTMENTS DURING THE DEMOLITION WORK.
- 8. THE RIVER SHALL BE PROTECTED AND SECURED AT ALL TIMES FROM LOSS OF SOIL BY UTILIZING THE PROPER SCREENS AND FILTERS WHILE THE CONTRACTOR IS DEWATERING.

MIN. 6" INTO GROUND

9. ITEMS DESIGNATED FOR REMOVAL AND REPLACEMENT SHALL BE STORED AND PROTECTED FOR THE DURATION OF THE PROJECT AND REINSTALLED.

# **SOIL EROSION CONTROL NOTES:**

#### <u>GENERAL</u>

- 1. THE CONTRACTOR SHALL IMPLEMENT AND MAINTAIN THE SOIL EROSION CONTROL MEASURES AS SHOWN ON THE PLANS AT ALL TIMES DURING THE CONSTRUCTION OF THE PROJECT.ANY MODIFICATIONS OR ADDITIONS TO THE SOIL EROSION CONTROL MEASURES DUE TO CONSTRUCTION OR CHANGED CONDITIONS SHALL BE COMPILED WITH AS REQUIRED OR DIRECTED BY OWNER OR OWNER'S REPRESENTATIVE.
- 2. ALL SOIL EROSION CONTROL WORK SHALL CONFORM TO THE PERMIT REQUIREMENTS.
- 3. DAILY INSPECTION OF THE SOIL EROSION CONTROL SHALL BE MADE BY THE CONTRACTOR. ANY NECESSARY CORRECTIONS SHALL BE MADE WITHOUT DELAY.
- 4. THE RIVER SHALL BE PROTECTED AND SECURED AT ALL TIMES FROM SEDIMENTS AND DEBRIS CONSEQUENT TO THE CONTRACTOR'S ACTIVITIES.
- 5. CONSTRUCTION OPERATIONS SHALL BE SCHEDULED AND PERFORMED SO THAT SOIL EROSION CONTROL MEASURES ARE IN PLACE PRIOR TO EXCAVATION.
- ROADS SHALL BE KEPT OF FREE OF DIRT, SILT, AND CONSTRUCTION DEBRIS.
- 7. CONTRACTOR SHALL REMOVE SILT FENCING AT THE COMPLETION OF THE PROJECT.

# **EROSION CONTROL ESTIMATED QUANTITIES:**

- FOR PERMIT USE ONLY. - SHALL NOT BE USED FOR BIDDING PURPOSES.


AREA TO BE DISTURBED: < 400 SFT


EXCAVATION: < 21.4 CYD ADDITIONAL FILL: 27 CYD

EROSION CONTROL: SILT FENCE = 56 LFT

RIPRAP = 27 CYD

ALUM.	ALUMINIUM	HK.	HOOK
В.	ВОТТОМ	HORIZ.	HORIZONTAL
BLDG.	BUILDING	HT.	HEIGHT
ВМ.	BEAM	I.D.	INSIDE DIAMETER
BSMT.	BASEMENT	I.E.	INVERT ELEVATION
C-C	CENTER TO CENTER	I.F.	INSIDE FACE
CJ	CONSTRUCTION JOINT	IN.	INCHES
CFT.	CUBIC FEET	INT.	INTERIOR
CLR.	CLEAR	JT.	JOINT
COL.	COLUMN	KIP	THOUSAND POUNDS
CONC.	CONCRETE	LFT.	LINEAR FEET
CONSTR.	CONSTRUCTION	LGTH.	LENGTH
CONT.	CONTINUOUS	MAX.	MAXIMUM
COR.	CORNER	MIN.	MINIMUM
CYD	CUBIC YARD	NA	NOT APPLICABLE
D	DEEP	N.F.	NEAR FACE
DIA.	DIAMETER	N.T.S.	NOT TO SCALE
DIP	DUCTILE IRON PIPE	O.C.	ON CENTER
DIAG.	DIAGONAL	O.D.	OUTSIDE DIAMETER
DWLS.	DOWELS	O.F.	OUTSIDE FACE
EJ	EXPANSION JOINT	OPNG.	OPENING
E.E.	EACH END	P.O.C.	POINT OF CONNECTIO
E.F.	EACH FACE	REINF.	REINFORCEMENT
E.W.	EACH WAY	RE:	REFER TO
EA.	EACH	SF	SQUARE FEET
EL.	ELEVATION	SHTS.	SHEETS
EX.	EXISTING	SIM.	SIMILAR
EXT.	EXTERIOR	SJ	SLAB CONTROL JOINT
FIN.	FINISH	SS	STAINLESS STEEL
FL.	FLOOR	STIR.	STIRRUPS
FND.	FOUNDATION	STRUCT.	STRUCTURAL
FRP.	FIBERGLASS	T/	TOP
	REINFORCED PLASTIC	TYP.	TYPICAL
FT.	FEET	U.N.O.	UNLESS NOTED
GALV.	GALVANIZED		OTHERWISE
GR.	GRADE	VERT.	VERTICAL
Н.	HIGH	V.I.F.	VERIFY IN FIELD

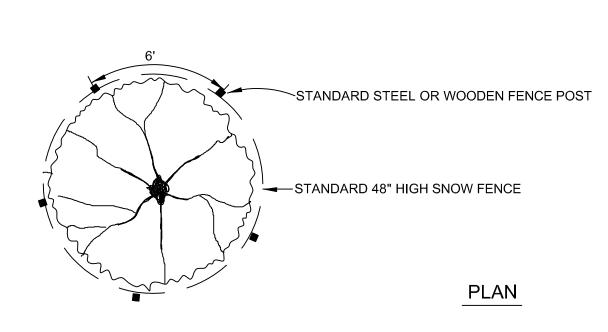

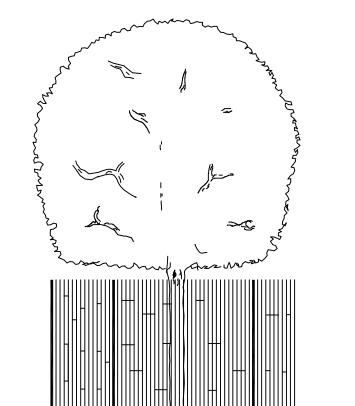

SNOW FENCE SHALL BE LOCATED AT THE OUTER PERIMETER OF THE SPREAD OF THE BRANCHES OR CLOSER ONLY AT THE DIRECTION OF THE ENGINEER.

**ELEVATION** 

TREE PROTECTION FENCE

ABUTMENT REPAIR Ann Arbor, Michigan

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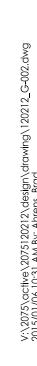
GENERAL NOTES AND **ABBREVIATIONS** 

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Project No. Scale 2075120212 Sheet Drawing No. Revision

ISLAND PARK PEDERSTRIAN BRIDGE

2 of 10



5/16" GALVANIZED

FLOTATION -

WATER

FILTERED

THROUGH

CABLE

PVC SLOT CONNECTOR

**IMPERMEABLE** 

FABRIC

FILTER FABRIC

CHAIN BALLAST

**TURBIDITY CURTAIN** 



#24 SAFETY HOOK AND 0-RING

100 FT. LENGTH

STANDARD

<sup>10'</sup> MAX. C/O 48" HIGH (MIN.) FENCE POSTS (STEEL EITHER "T" OR "U" TYPE OR 2" X 2" WOOD) 24" MIN. HEIGHT OF FILTER ABOVE GROUND SURFACE - 48" MIN. FENCE SILT FENCES SHALL CONSIST OF FILTER FABRIC AND WOODEN LATHS FENCES SHALL BE PLACED WOVEN WIRE FENCE DOWNGRADIENT OF CONSTRUCTION AREAS, AS (MIN. 14 GAUGE, 6" MAX. NECESSARY TO CONTROL SEDIMENT AND MINIMIZE MESH SPACING EROSION UNTIL VEGETATION IS ESTABLISHED. ALL SILT FENCING IS TO BE IN PLACE PRIOR TO ANY CONSTRUCTION. EXTRA-STRENGTH FILTER FABRIC (50 lbs./lin.in.min.) MAY BE USED IN LIEU OF THE STANDARD FILTER FABRIC STRENGTH (30 lbs./lin.in.min.) FILTER FABRIC AND THE 14 GAUGE WOVEN WIRE FENCE COMBINATION. FLOW EMBEDDED FILTER FABRIC SILT FENCE

SILT FENCE

Appd. YY.MM.DD

By Appd. YY.MM.DD

 BWA
 NW
 NW
 14.07.25

 Dwn.
 Chkd.
 Dsgn.
 YY.MM.DD





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A PLACE 2 SIGNS AT ENTRANCE CHANNEL: "DANGER! CHANNEL CLOSED DUE TO CONSTRUCTION". SIZE = 2'x3' MINIMUM WITH 3" LETTERS.

B CONSTRUCTION SAFETY FENCE.

C WARNING SIGN: "DANGER! BRIDGE CLOSED DUE TO CONSTRUCTION". SIZE = 2'x3' MINIMUM WITH 3" LETTERS.

D STORE BRIDGE ON BLOCKING.

E COFFERDAM. SEE S-101 FOR DETAILS.

F TURBIDITY CURTAIN.

Revision		By	Appd.	YY.MM.DD
A BID SET			GRW	15.01.06
Issued	BWA	By	Appd.	14.07.25
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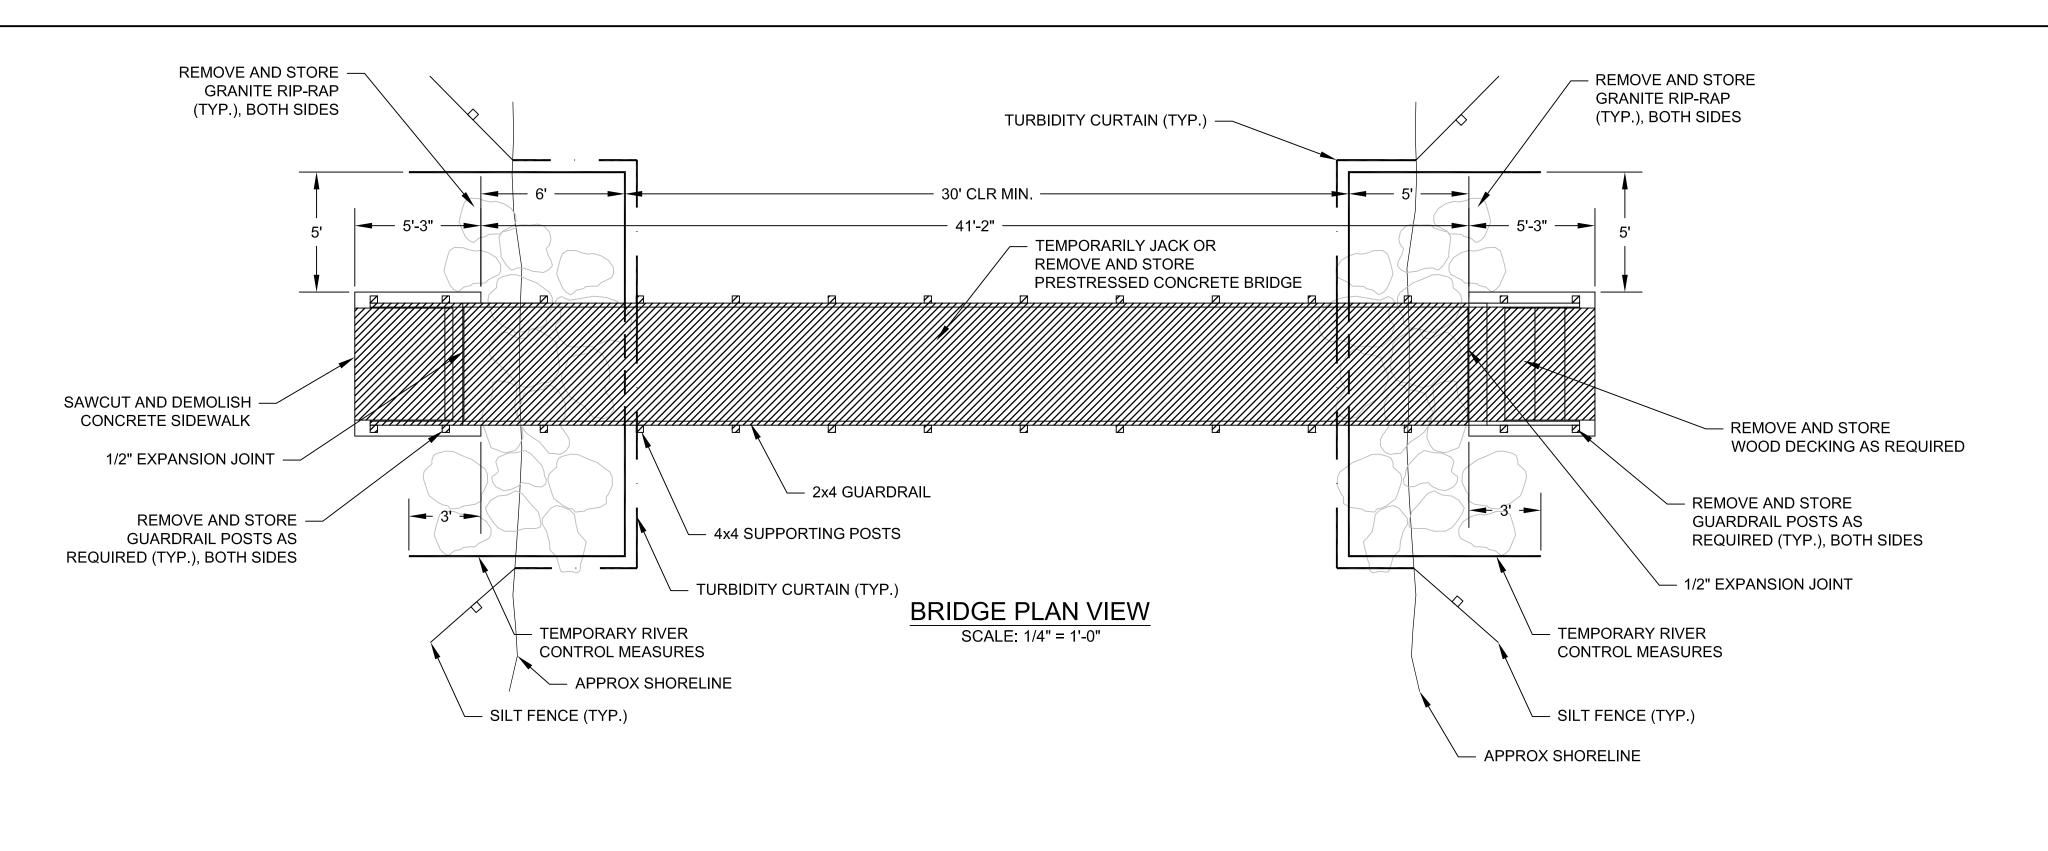
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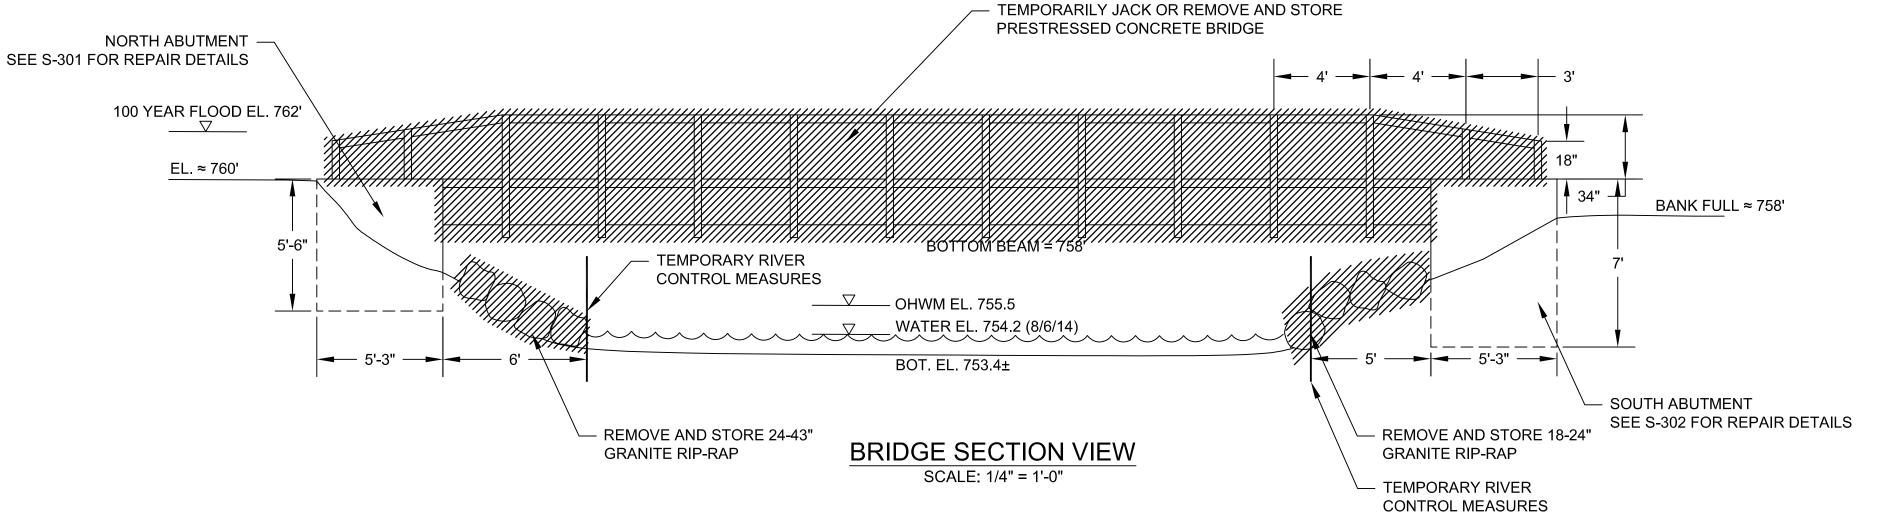
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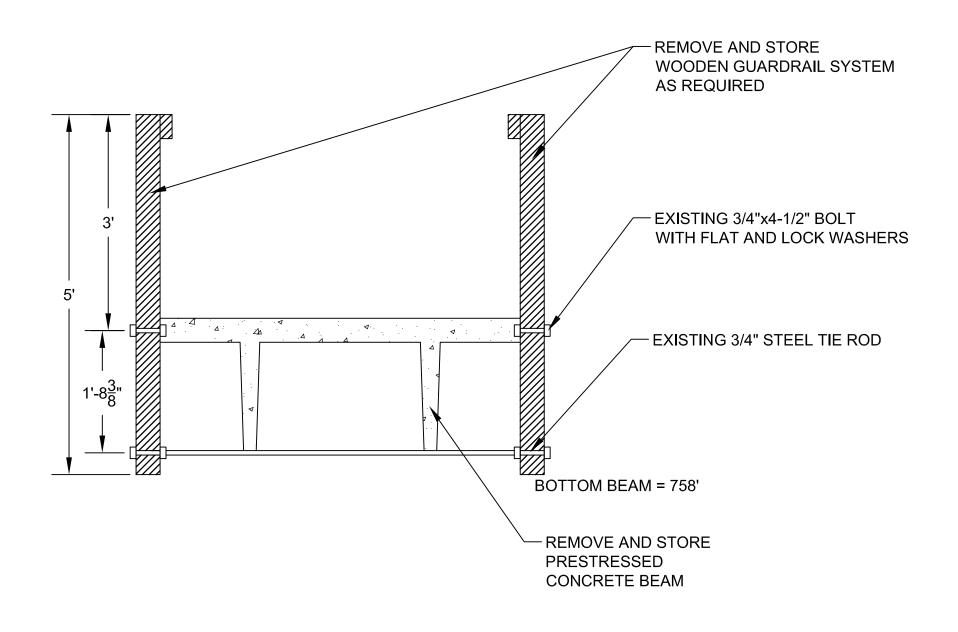
ISLAND PARK PEDERSTRIAN BRIDGE ABUTMENT REPAIR Ann Arbor, Michigan

ACCESS AND STAGING PLAN

Project No. 2075120212	Scale O	40' 80'
Drawing No.	Sheet	Revision
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BRIDGE SECTION VIEW

SCALE: 3/4" = 1'-0"



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#### NOTES:

- CONTRACTOR SHALL DESIGN AND INSTALL COFFERDAM OR
   OTHER RIVER CONTROL DEVICE WITHIN LIMITS SHOWN.
- 2. ALL ELEVATIONS ARE APPROXIMATE.

 Revision
 By
 Appd.
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 A BID SET
 NW GRW 15.01.06

 Issued
 By Appd.
 YY.MM.DD

 File Name: 120212C-101.DWG
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ISLAND PARK PEDERSTRIAN BRIDGE ABUTMENT REPAIR Ann Arbor, Michigan

Title

SITE PREPARATION AND SEDIMENT CONTROL


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2075120212 AS NOTED


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IOTE:

1. ALL ELEVATIONS ARE APPROXIMATE.

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ISLAND PARK PEDERSTRIAN BRIDGE ABUTMENT REPAIR

Ann Arbor, Michigan

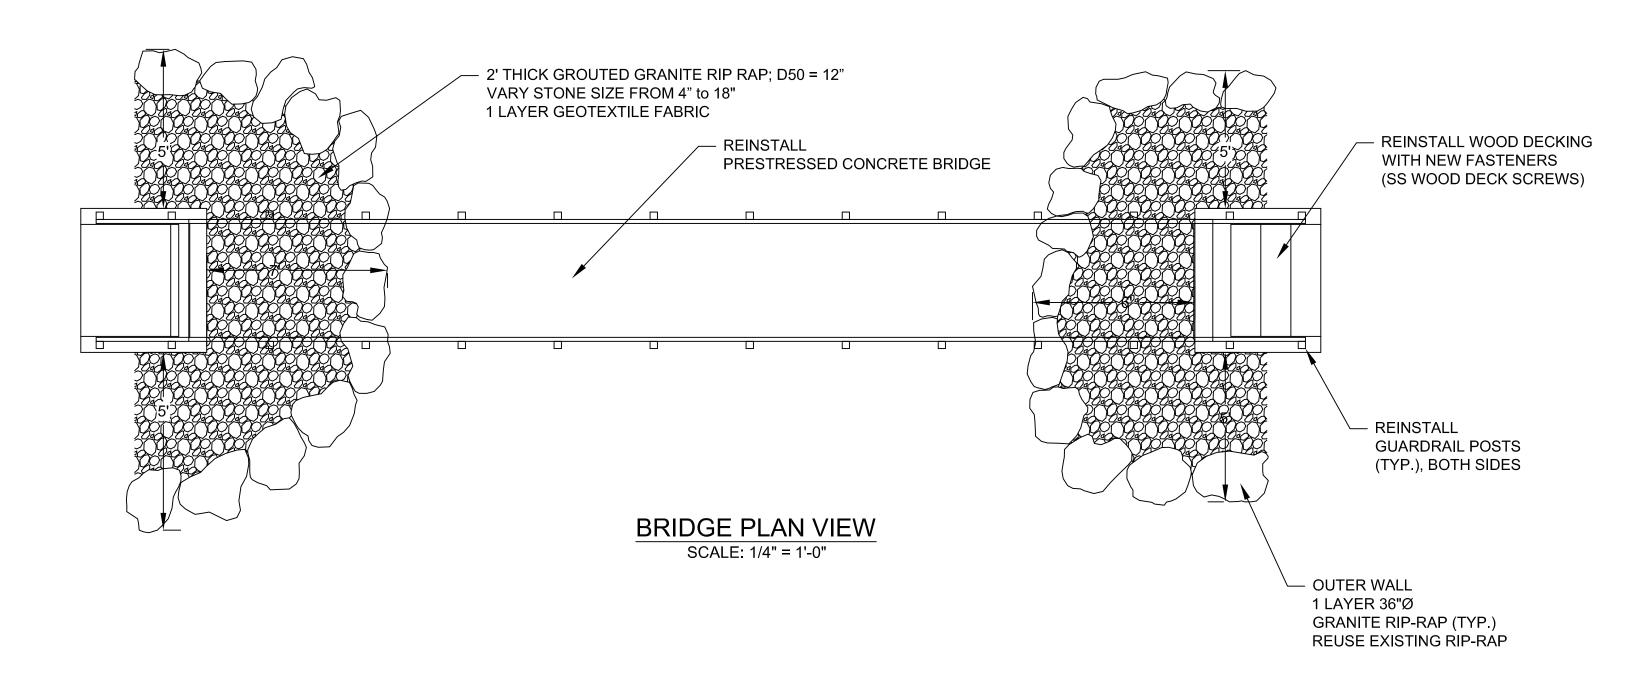
SITE RESTORATION

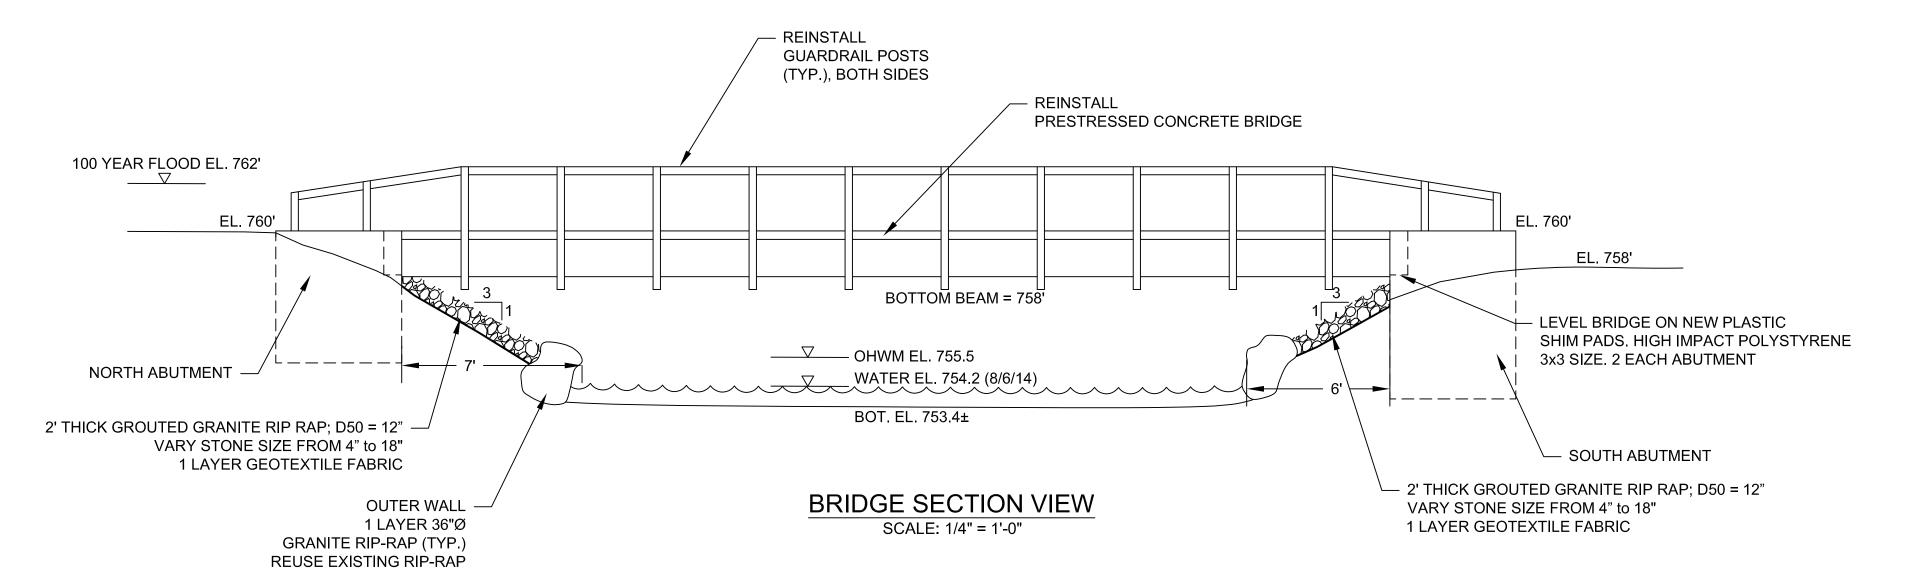
Project No.
2075120212


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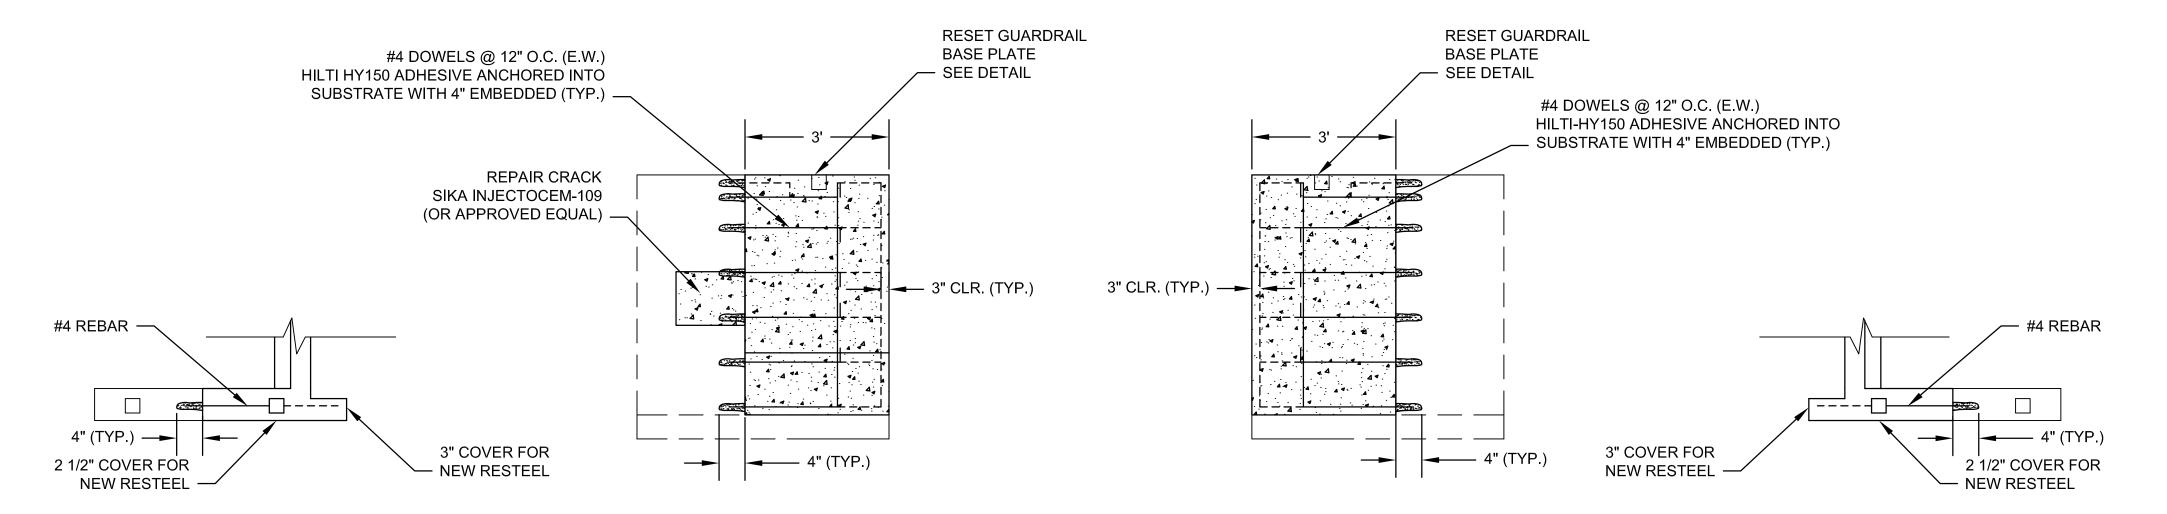




PLAN DEMOLITION SCALE: 1/2" = 1'-0"

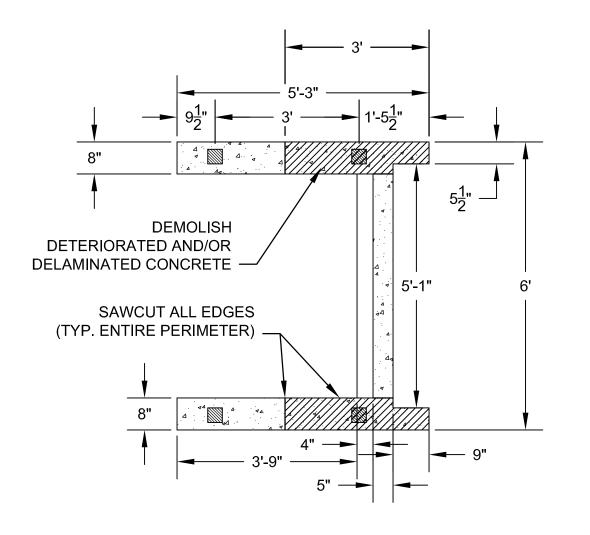
WEST ELEVATION DEMOLITION SCALE: 1/2" = 1'-0"

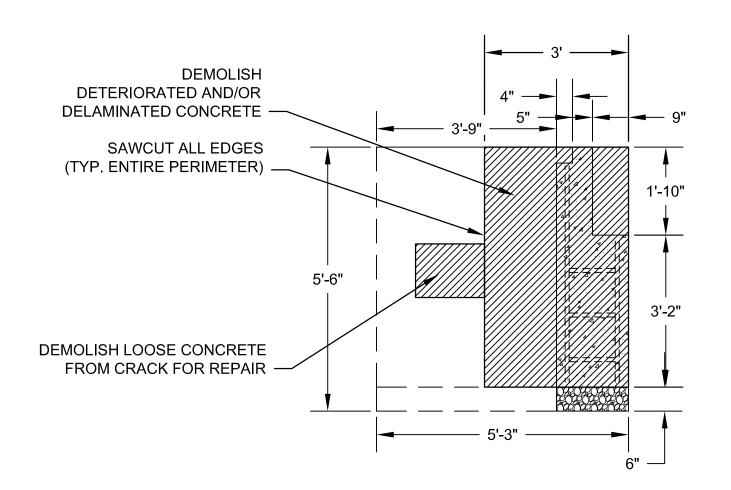EAST ELEVATION DEMOLITION SCALE: 1/2" = 1'-0"

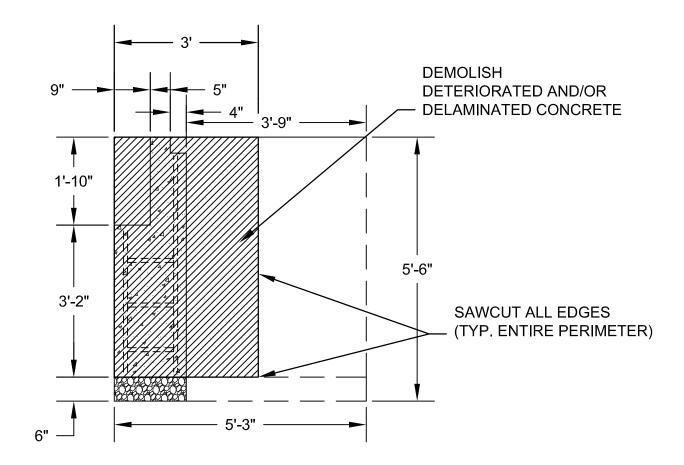

WEST ELEVATION REPAIRS SCALE: 1/2" = 1'-0"

EAST ELEVATION REPAIRS SCALE: 1/2" = 1'-0"

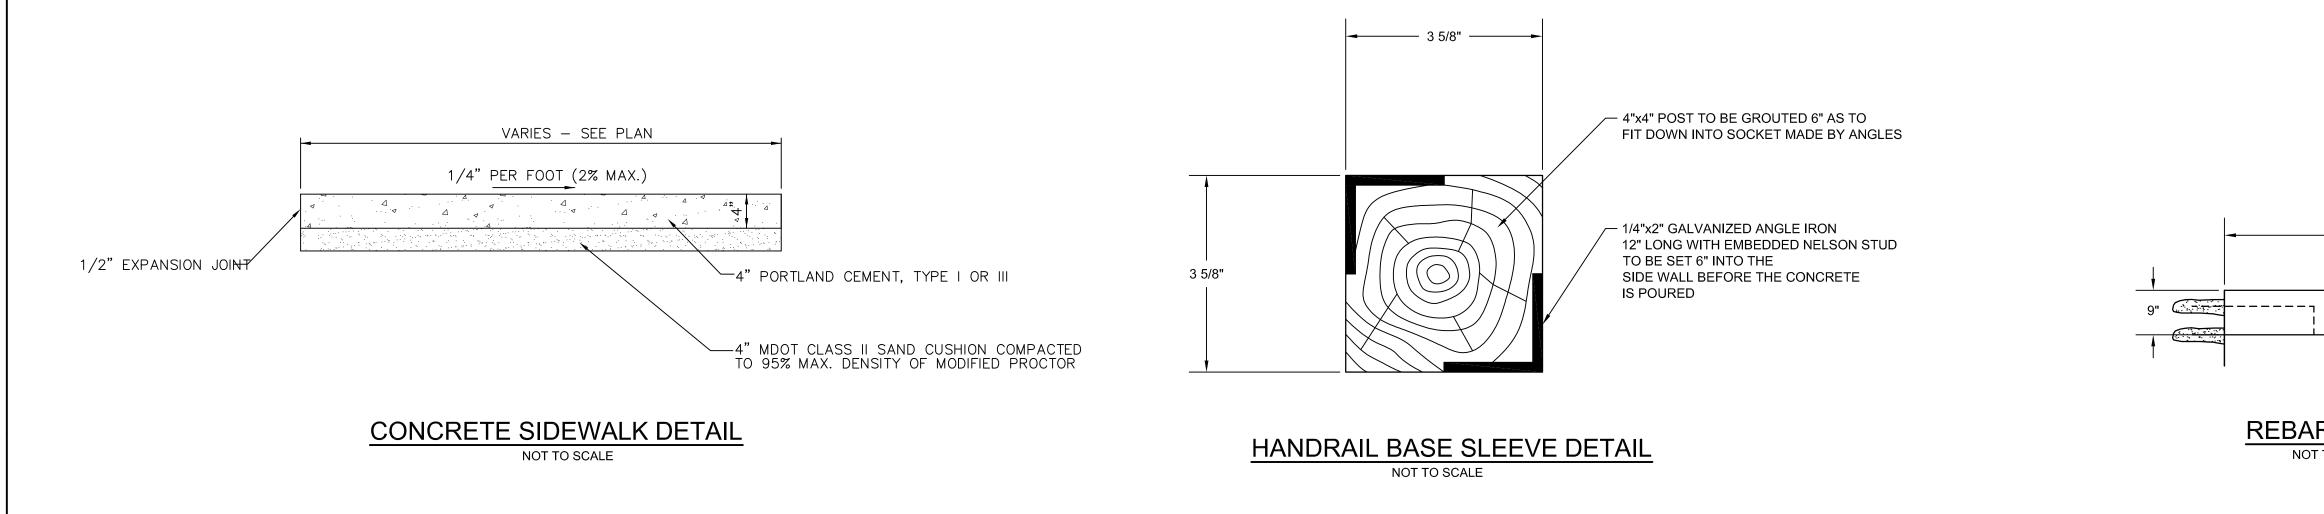




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TO BE DEMOLISHED



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Ann Arbor, Michigan

Title


— 3" COVER FOR NEW RESTEEL

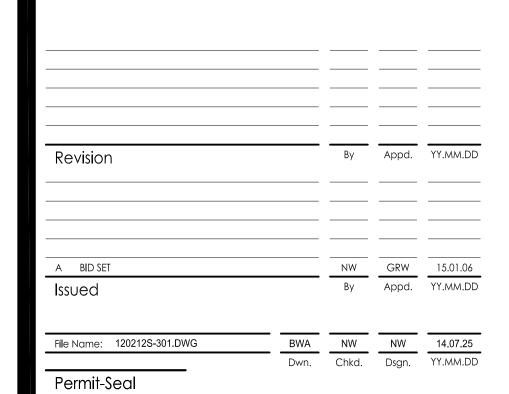NORTH ABUTMENT DEMOLITION AND REPAIRS

Project No. Sheet Drawing No. Revision S-301

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**REBAR DETAIL** NOT TO SCALE



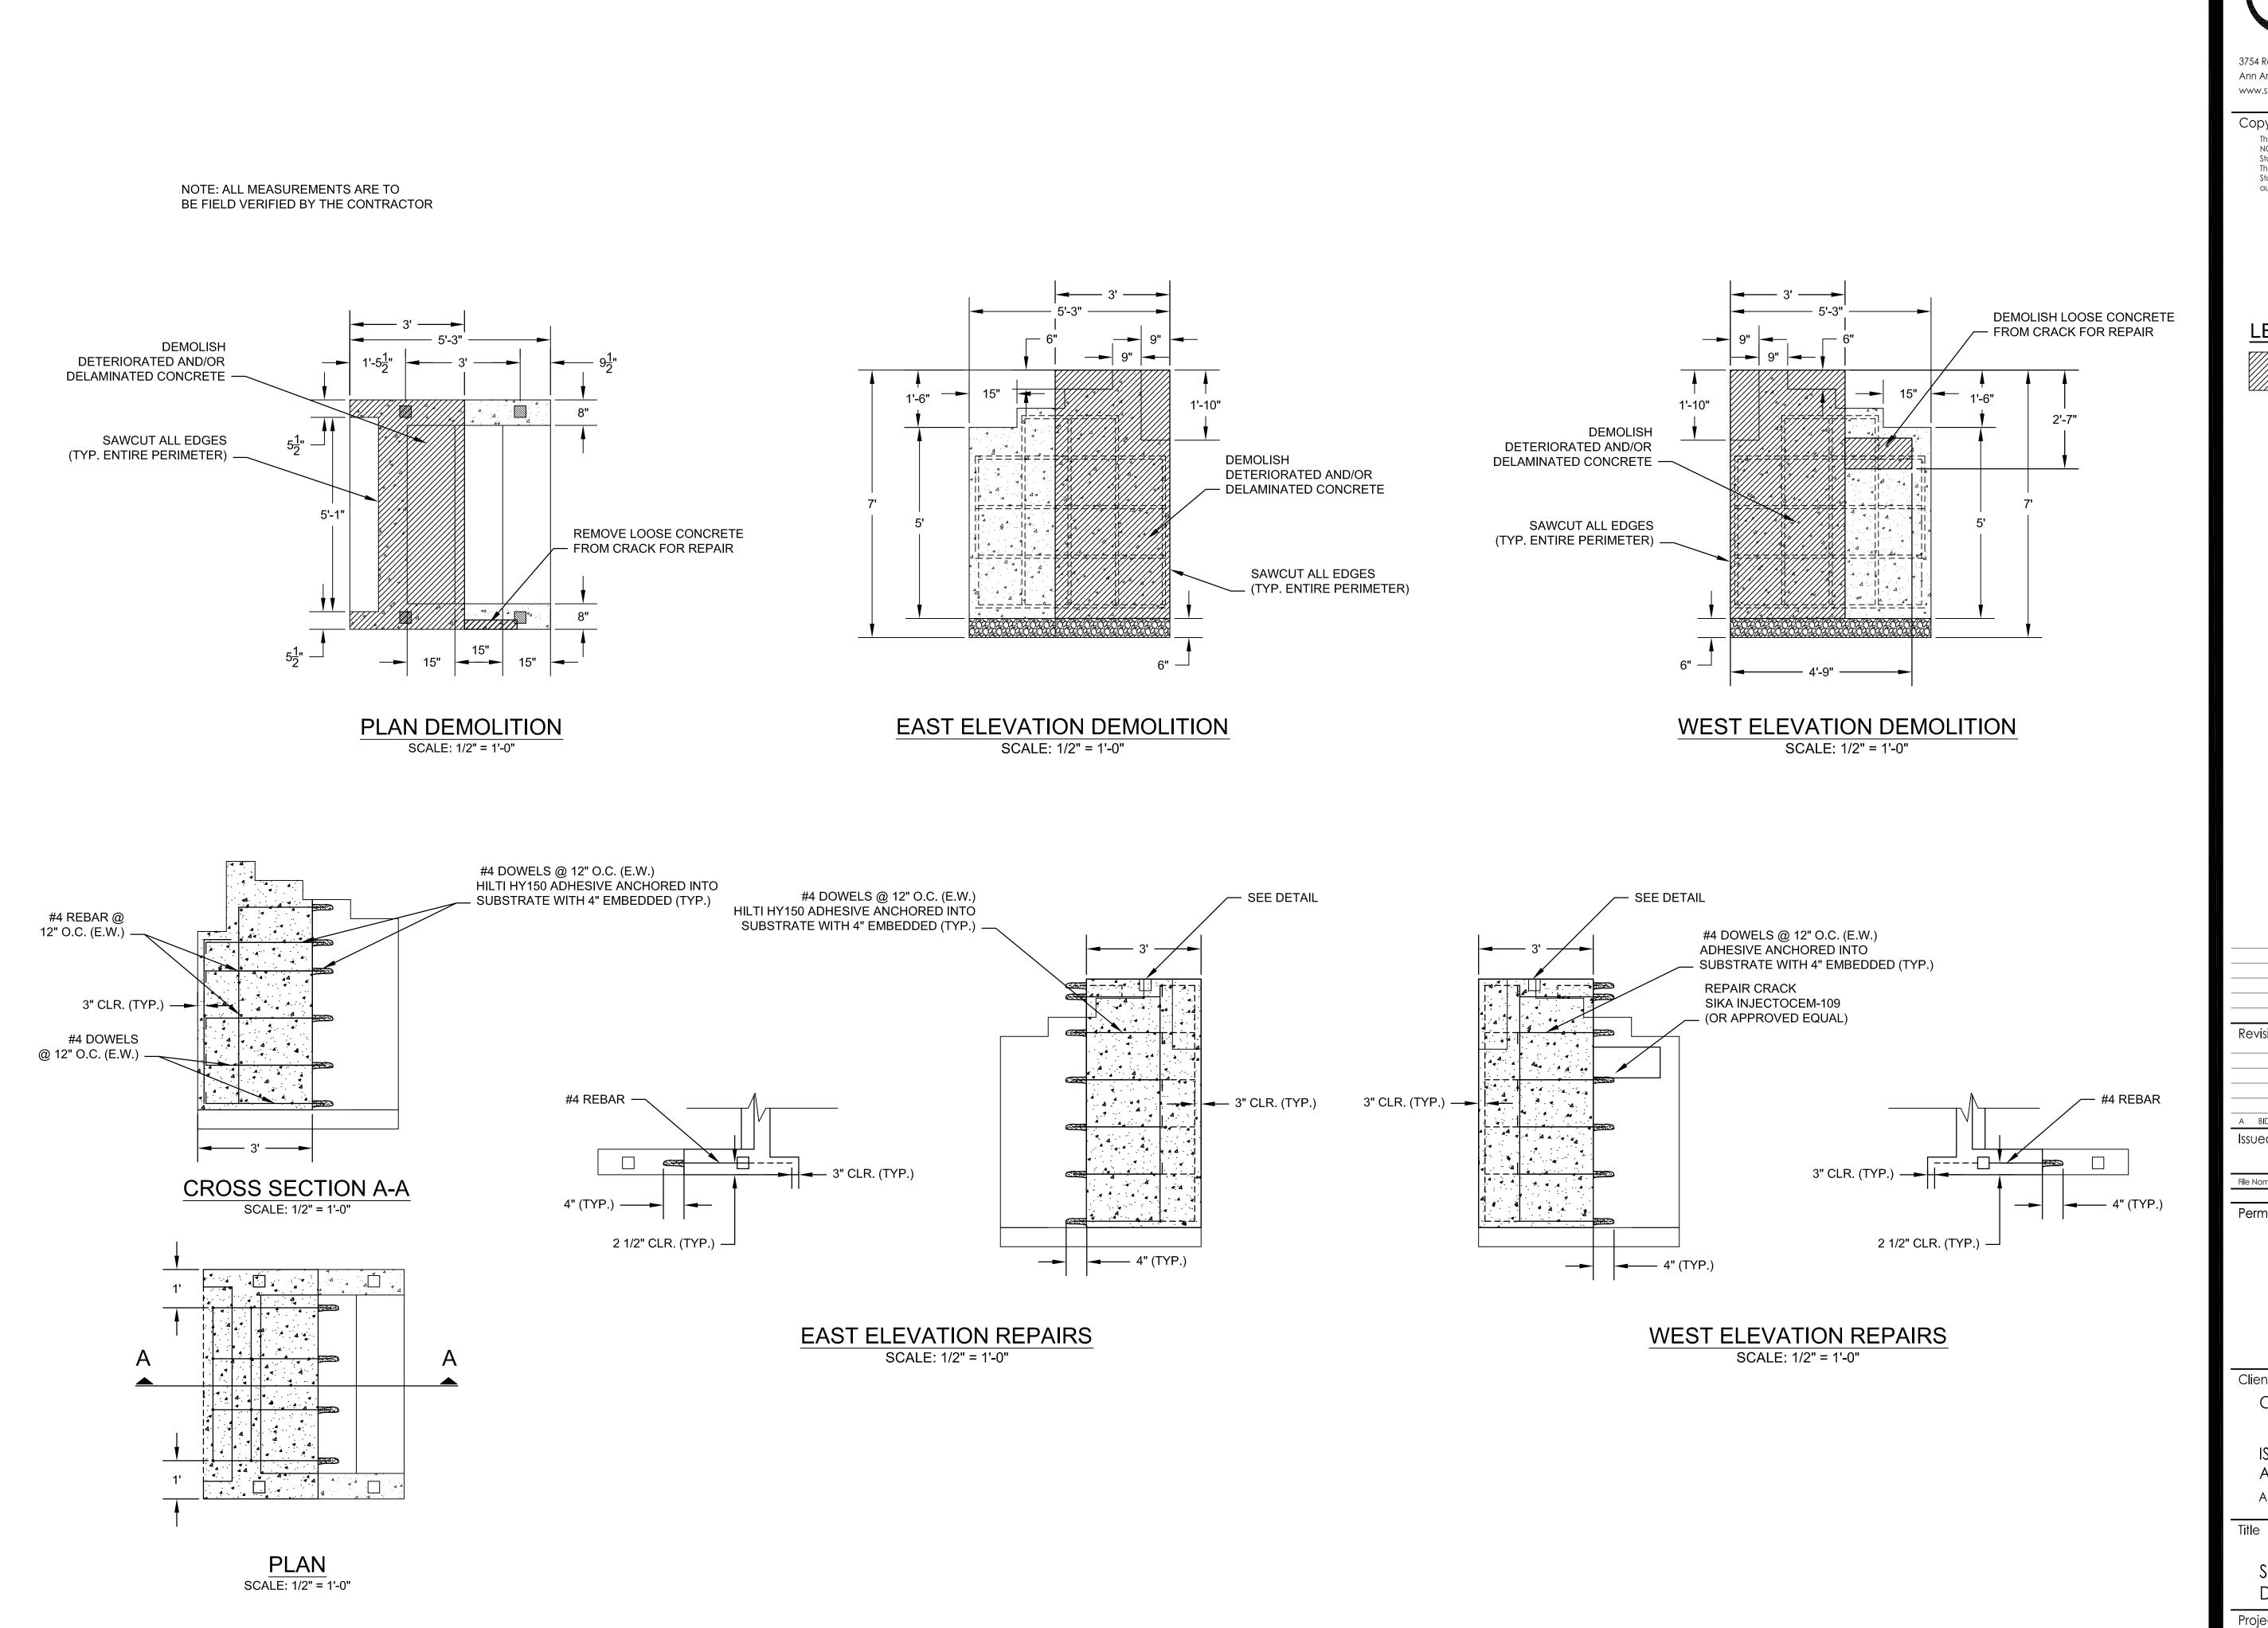


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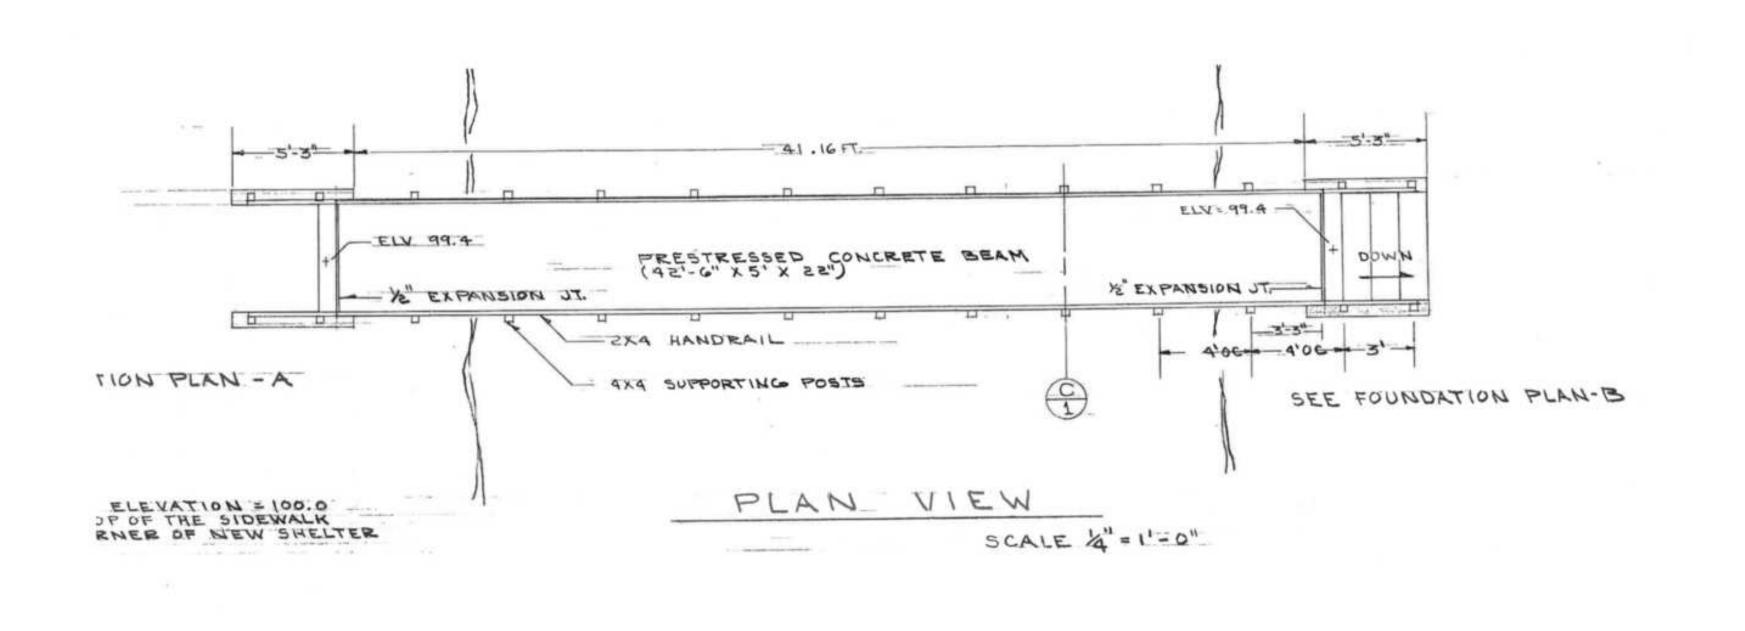
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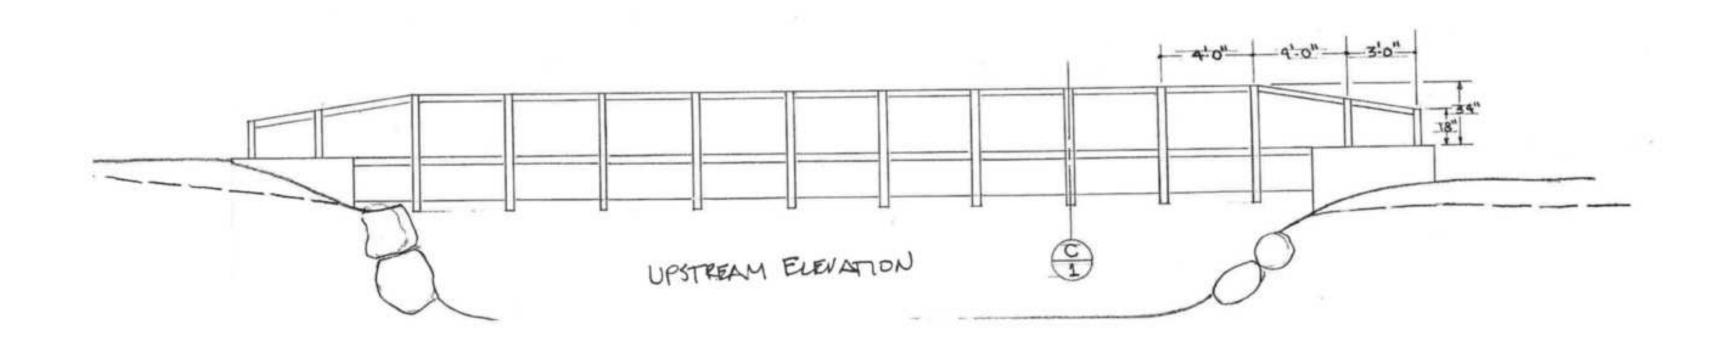
ISLAND PARK PEDERSTRIAN BRIDGE ABUTMENT REPAIR Ann Arbor, Michigan


SOUTH ABUTMENT DEMOLITION AND REPAIRS


Project No. Sheet Revision Drawing No. S-302

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SCALE 2" = 1'-0"

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A BID SET		NW By	GRW Appd.	15.01.06 YY.MM.DD
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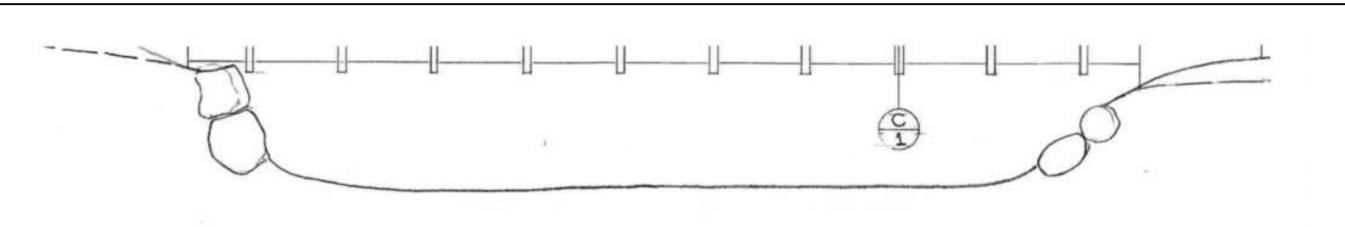
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ISLAND PARK PEDERSTRIAN BRIDGE ABUTMENT REPAIR Ann Arbor, Michigan

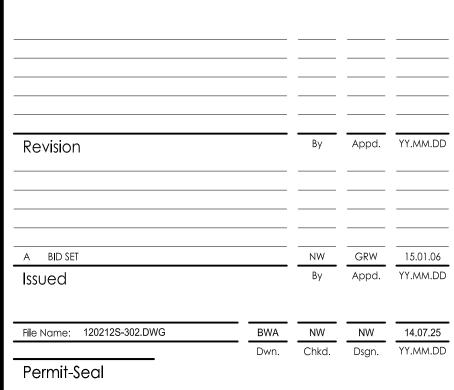
REFERENCE DRAWINGS I
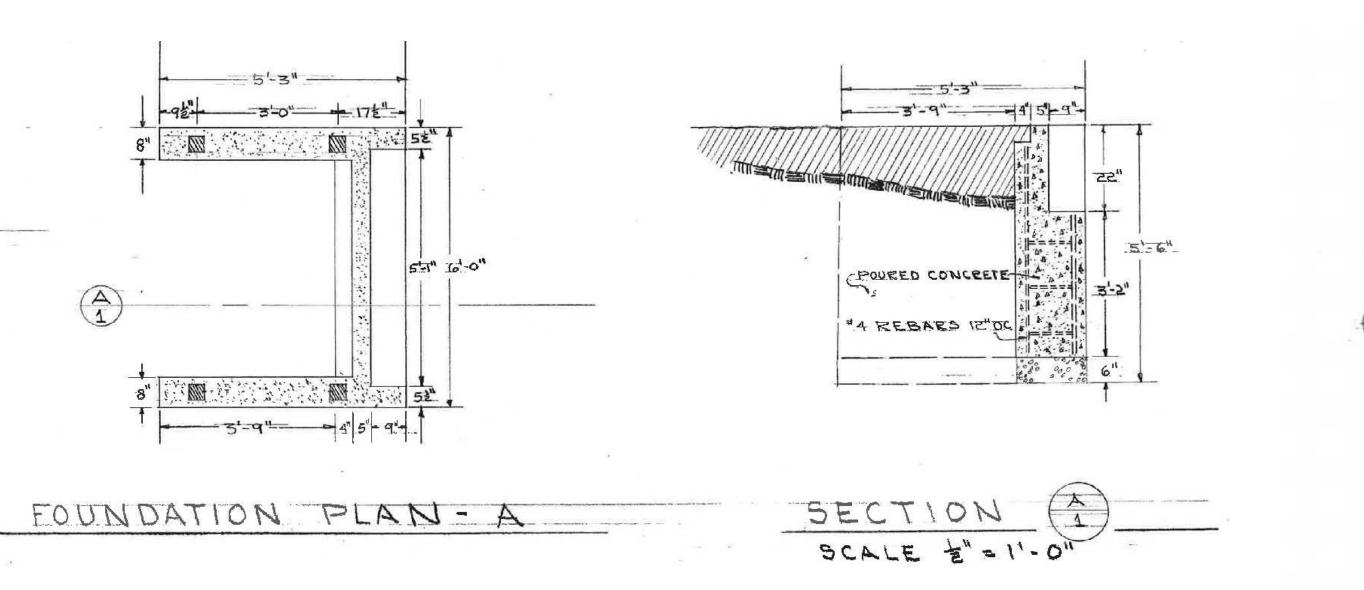
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# UPSTREAM ELEVATION

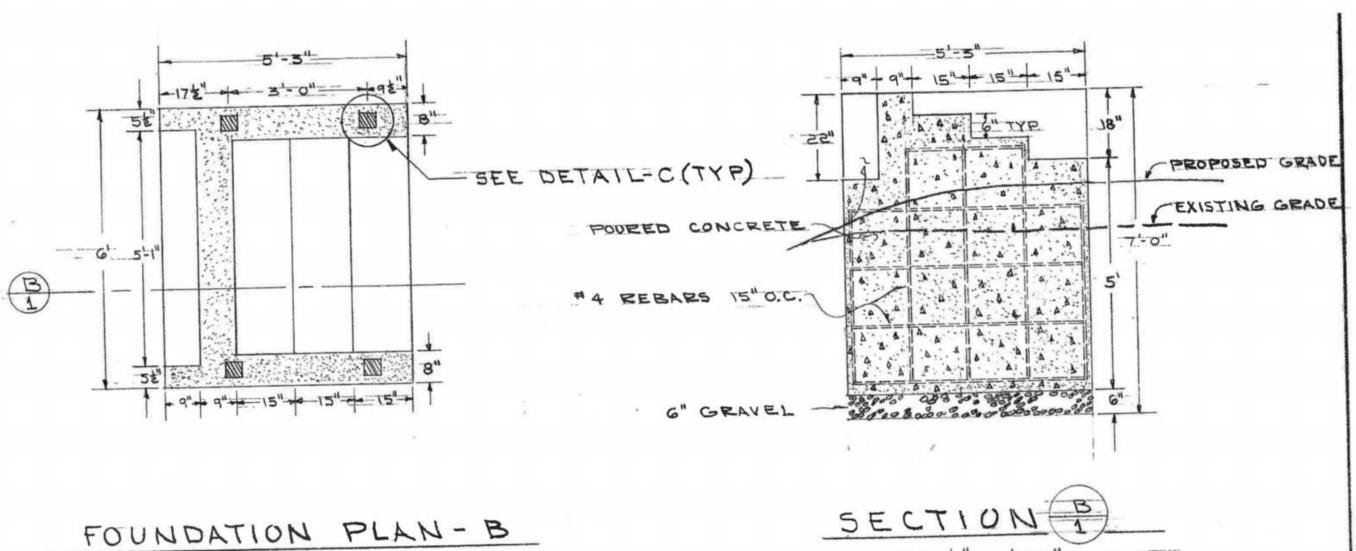
SCALE 4"= 1'-0"




SECTION C SCALE 34" = 1'-0"

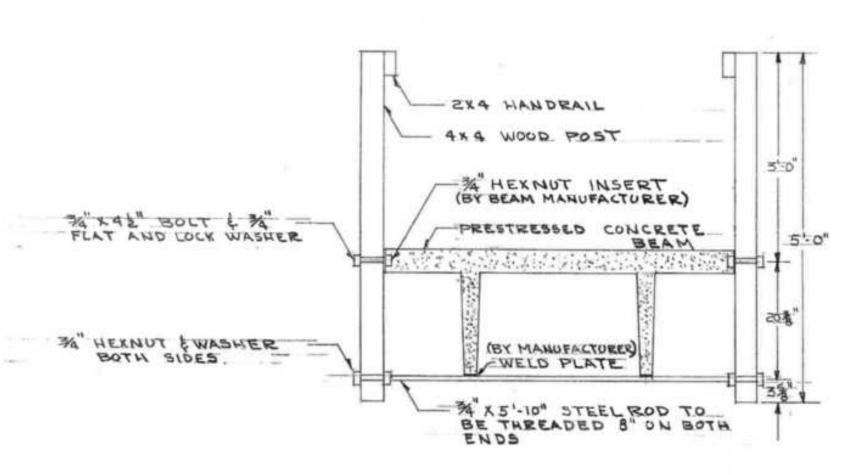
DETAIL-C PLAN & ISOME

ANGLE

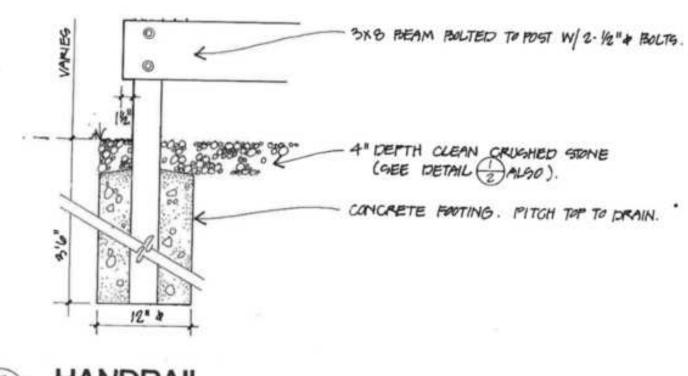

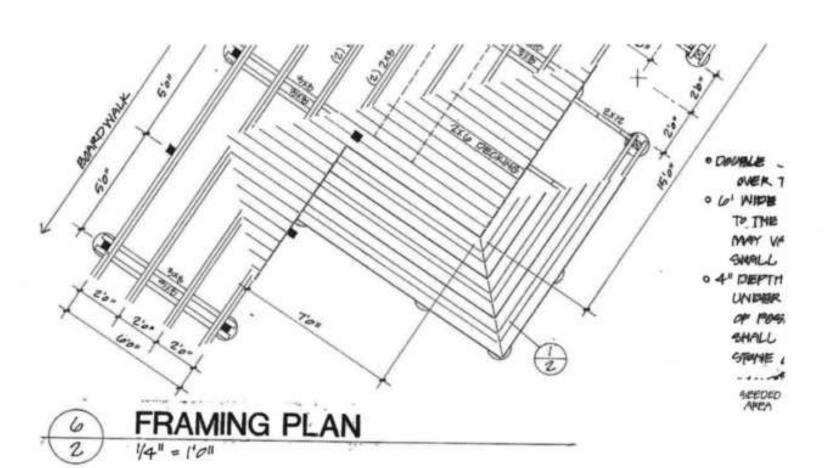



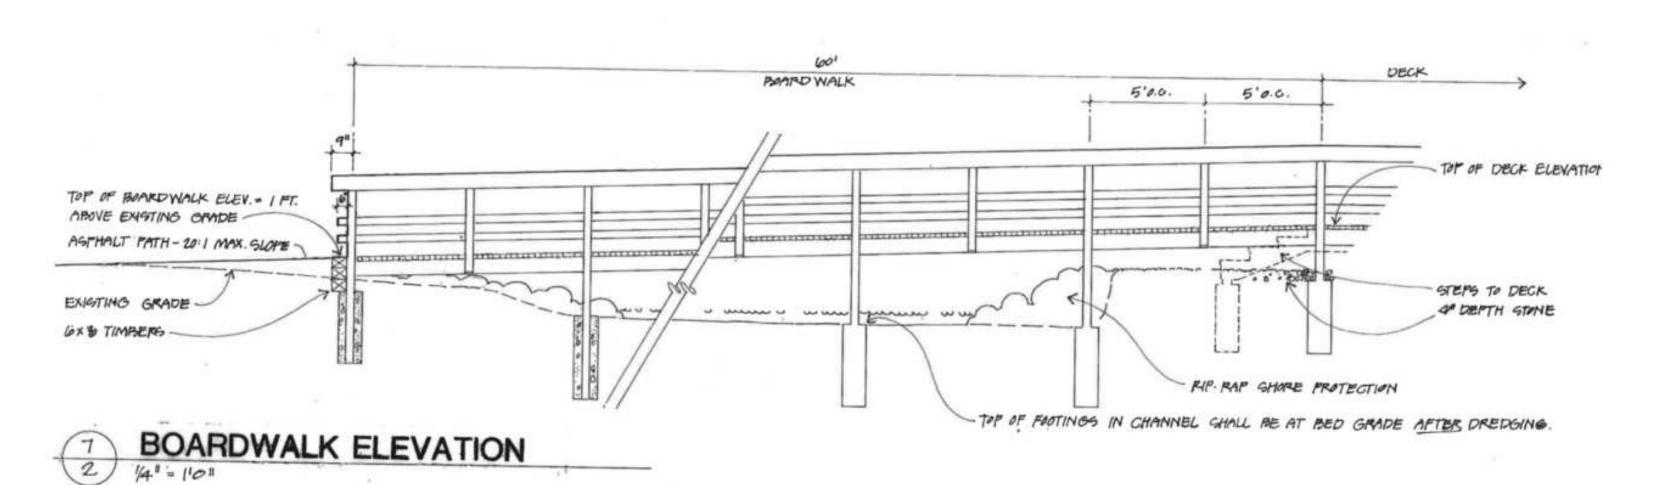



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A BID SET			GRW	15.01.06
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				44.07.05
File Name: 120212R-502.DWG	BWA	NW	NW	14.07.25 YY.MM.DD
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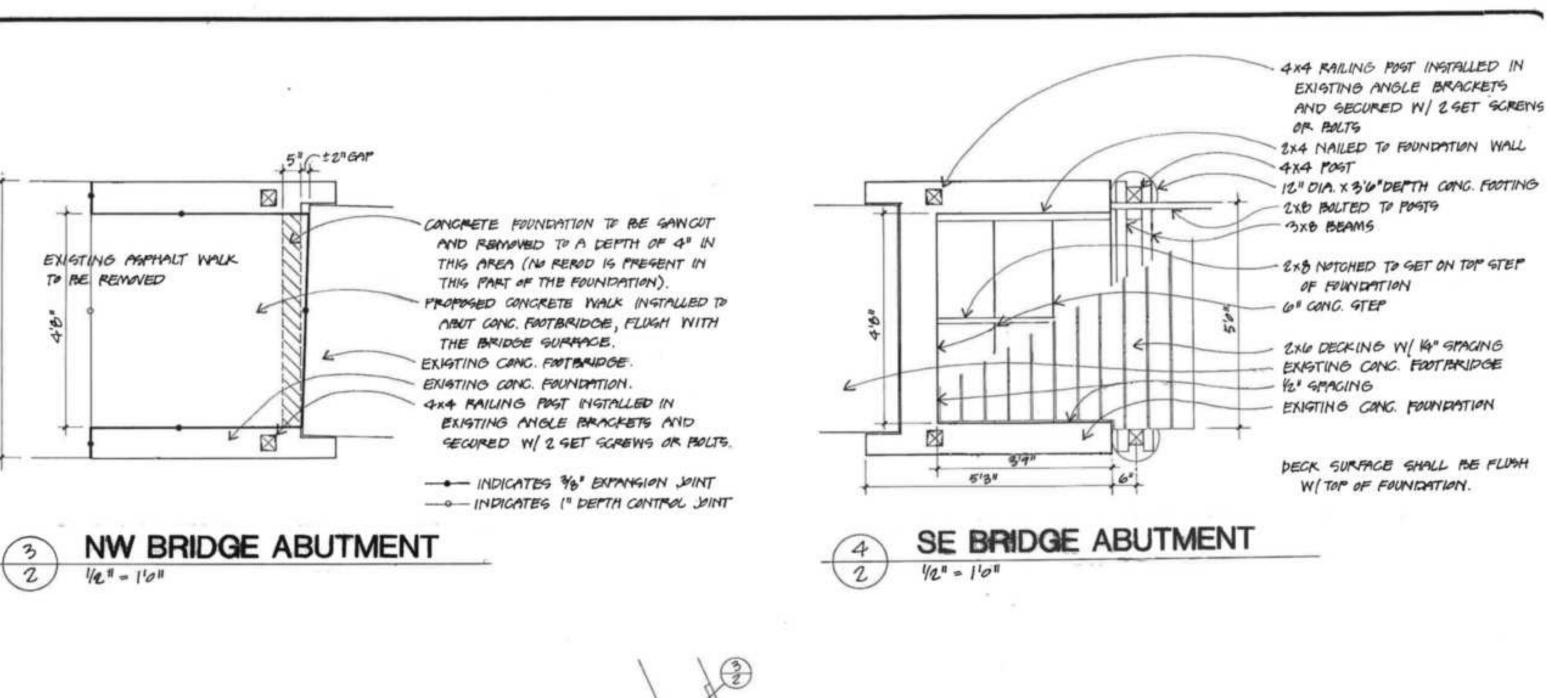
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Title


REFERENCE DRAWINGS II


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OALL 3XB BEAMS SHALL BE BOLTED TO POSTS W/2-1/2"+ MACHINE BOLTS.

- O THE OUTSIDE JOISTS ON BOTH THE 5' & 6' BANKDWALKS SHALL BE BOLTED TO POSTS W/2- 96" & MACHINE BOLTS. O INTERMEDIATE RAILING POSTS SHALL BE BOLTED TO JOISTS W/2- NO" MACHINE BOCTS.
- · ALL MAGNINE BOLTS SHALL BE INSTALLED W/ 2 FLAT WASHERS PER BOLT, CARRIAGE BOLTS W/ SINGLE WAGHER. END OF BOLTS SHALL BE PEENED TO HINDER UNAUTHURIZED REMOVAL.
- · 3×8 BEAMS SHALL BE NO. I DOUGLAS FIR. ALL OTHER LUMBER SHALL BE NO. 2 GYP. ALL LUMBER TO BE COA TREATED PER AWPA GRECG.



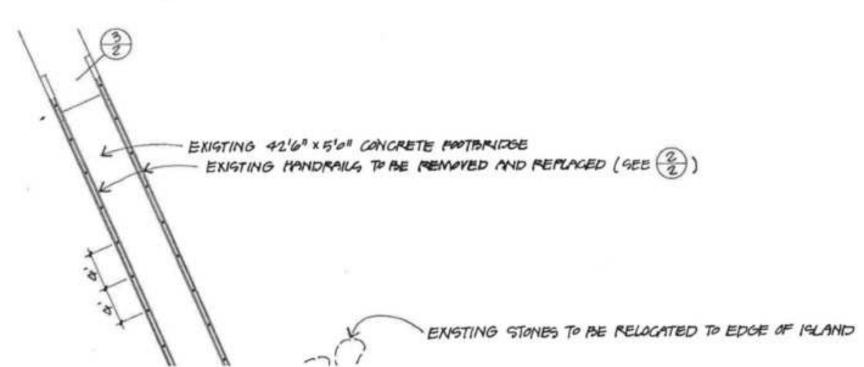

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Revision		By	Appd.	YY.MM.DD
A BID SET		  NW	GRW	15.01.06
Issued	_	Ву	Appd.	YY.MM.DD
File Name: 120212R-503.DWG	BWA	NW	NW	14.07.25
	Dwn.	Chkd.	Dsgn.	YY.MM.DD
Permit-Seal				

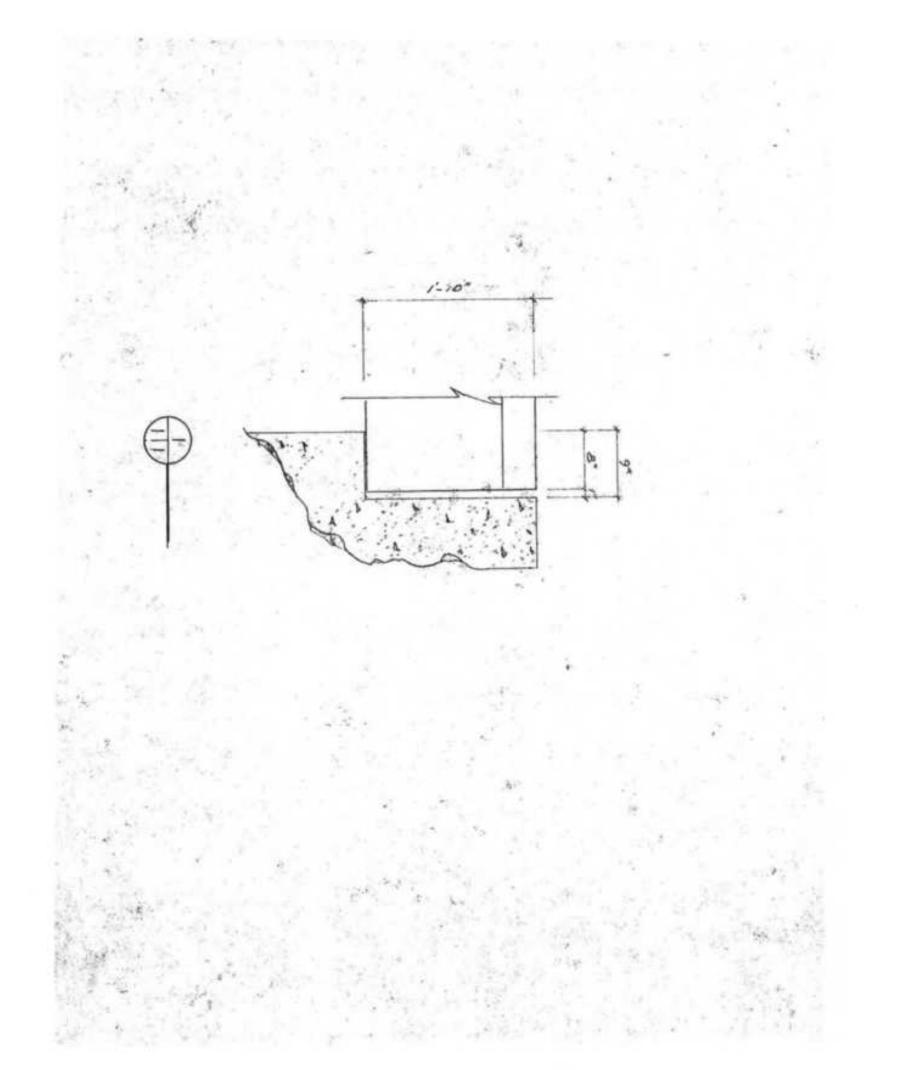Client/Project

CITY OF ANN ARBOR

ISLAND PARK PEDERSTRIAN BRIDGE ABUTMENT REPAIR Ann Arbor, Michigan

REFERENCE DRAWINGS III

Project No.	Scale	
2075120212	AS NOTED	
Drawing No.	Sheet	Revision
R-503	10 of 10	$\cap$