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PROPOSED SANITARY PLAN & PROFILE STA 0+00 TO STA 3+00

PROPOSED WATER MAIN PLAN & PROFILE STA 0+00 TO STA 3+00

PROPOSED WATER MAIN PLAN & PROFILE STA 3+00 TO STA 6+00

PROPOSED WATER MAIN PLAN & PROFILE STA 6+00 TO STA 9+00 PROPOSED WATER MAIN PLAN & PROFILE STA 9+00 TO STA 12+45

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PROPOSED TYPICAL CROSS SECTION

ALIGNMENT PLAN STA 0+00 to STA 5+00

ALIGNMENT PLAN STA 5+00 TO STA 10+00 PROPOSED PAVING STA 0+00 TO STA 3+00

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PROPOSED PAVING STA 10+00 TO STA 13+00

MAINTENANCE OF TRAFFIC PLAN

SOIL BORING LOG INFORMATION

SUMMARY OF QUANTITIES

CITY OF ANN ARBOR ENGINEERING


STANDARD SPECIFICATIONS, ITS DETAILS, WHICH ARE INCLUDED BY OF ANY CURRENT STANDARD DETAIL DOES NOT RELIEVE THE CONTRACTOR

RIVERVIEW DRIVE SANITARY SEWER AND WATER MAIN EXTENSION PROJECT

ITB No. 4555, FILE No. 2017-031

PACKARD

ELLSWORTH

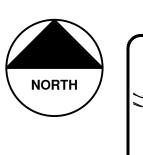

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		VICINITY MAP	

CITY OF ANN ARBOR STANDARD DETAILS						
REQUIRED ON THIS PROJECT	ITEM OF WORK	DETAIL				
Х	STANDARD MANHOLE (TYPE I)	SD-S-1				
Х	DROP MANHOLE CONNECTION	SD-S-5				
X	SEWER CONNECTION	SD-S-6				
x	SANITARY SEWER CONNECTION WITH RISER	SD-S-7				
X	THRUST BLOCK	SD-W-2				
Х	FIRE HYDRANT ASSEMBLY	SD-W-1				
x	GATE WELL FOR MAIN 12" AND SMALLER	SD-W-3				
х	PERMANENT BLOW-OFF/AIR RELIEF	SD-W-6				
X	TEMPORARY TESTING BLOW-OFF	SD-W-7				
x	MANHOLE CASTING ADJUSTMENT	SD-GU-6				
x	VALVE/MONUMENT BOX ADJUSTMENT	SD-GU-7				
x	STRUCTURE PLATE	SD-GU-8				
х	MH; VALVE/MONUMENT BOX LOWERING	SD-GU-9				

PREPARED UNDER THE SUPERVISION OF

VAUGHN C. MARTIN, P.E. - MI LICENSE No. 52002 **PROJECT MANAGER**

11/7/2018



PROJECT NAME BENCHMARKS						
ELEV	DESCRIPTION					
847.027	SPIKE IN EAST SIDE OF POWER POLE ACROSS FROM HOUSE #645.					
843.990	SPIKE IN EAST SIDE OF UTILITY POLE ON WEST SIDE OF RIVERVIEW, ACROSS FROM HOUSE #615.					
809.801	SPIKE IN WEST SIDE OF 24" TREE BETWEEN HOUSE #519 AND #508 ON EAST SIDE OF RIVERVIEW.					
827.613	NORTHERLY RIM OF STORM MANHOLE AT CENTERLINE OF RIVERVIEW OPPOSITE HOUSE NORTH OF #580.					
817.365	NORTHERLY RIM OF STORM MANHOLE AT CENTERLINE OF RIVERVIEW OPPOSITE HOUSE #559.					
801.362	NORTHERLY RIM OF SANITARY MANHOLE.					
802.978	SET RAILROAD SPIKE IN NORTHEAST SIDE OF UTILITY POLE ON SOUTHERLY SIDE OF RIVERVIEW AT 90° BEND IN ROAD.					
806.437	NORTHERLY RIM OF MANHOLE AT CENTERLINE INTERSECTION OF RIVERVIEW AND HUNTINGTON.					
837.735	SET RAILROAD SPIKE IN NORTH SIDE OF UTILITY POLE ON SOUTH SIDE OF GEDDES AT CENTERLINE OF RIVERVIEW EXTENDED.					
837.621	NORTHERLY RIM ON STORM MANHOLE OF CENTERLINE OF RIVERVIEW, 25'± SOUTH OF CENTERLINE DOVER.					
810.010	NORTHERLY RIM OF STORM MANHOLE ON CENTERLINE OF RIVERVIEW, 20'± NORTH OF CENTERLINE DRIVE FOR HOUSE #480.					
847.262	CENTERLINE OF TOP STEP FOR STEPS AT WEST END OF DOVER LEADING TO HOUSE #3055					
	847.027 843.990 809.801 827.613 817.365 801.362 802.978 806.437 837.735 837.621 810.010					

RIVERVIEW DRIVE SANITARY SEWER AND WATER MAIN PROJECT CITY OF ANN ARBOR

HORIZONTAL DATUM: NAD 83 STATE PLANE COORDINATES **VERTICAL DATUM: NAVD 88 UNITS: INTERNATIONAL FEET SURVEYED BY: CITY OF ANN ARBOR**

HORIZONTAL CONTROL POINTS

CONTROL POINT:

DESCRIPTION:

SET PIPE WITH TRAVERSE CAP ON SOUTH SIDE OF GEDDES. PIPE IS 30'± EAST OF CENTERLINE DRIVE FOR HOUSE NUMBERS 3090/3100, AND 3.6'± SOUTH OF

SOUTH BACK OF CURB.

COORDINATES: N=282398.850, E=13302337.400, ELEV=837.26'

CONTROL POINT: DESCRIPTION:

FOUND MAGNAIL IN ASPHALT ON NORTH SIDE OF RIVERVIEW OPPOSITE HOUSE

N=282558.810, E=13302272.970, ELEV=844.08' **COORDINATES:**

CONTROL POINT:

DESCRIPTION:

FOUND PIPE WITH TRAVERSE CAP ON EAST SIDE OF RIVERVIEW IN FRONT OF HOUSE #615. 2.5' OFF BACK OF CURB.

N=282719.540, E=13302280.780, ELEV=838.64' COORDINATES:

CONTROL POINT:

DESCRIPTION: SET PIPE WITH TRAVERSE CAP ON NORTH SIDE OF DOVER. PIPE IS 50'± WEST

OF CENTERLINE RIVERVIEW AND 9.0'± NORTH OF CENTERLINE DOVER.

COORDINATES: N=282802.220, E=13302250.120, ELEV=838.97'

CONTROL POINT

DESCRIPTION: SET PIPE WITH TRAVERSE CAP AT NORTH EDGE OF GRAVEL ON DOVER. PIPE IS

26'± WEST OF WEST EDGE OF BLOCK WALL ON WEST EDGE OF DRIVE FOR

HOUSE #3081.

COORDINATES: N=282827.150, E=13302147.460, ELEV=843.59'

CONTROL POINT:

FOUND PIPE WITH TRAVERSE CAP ON WEST SIDE OF RIVERVIEW. 3' OFF BACK **DESCRIPTION:**

OF CURB AND 28' NORTH OF CENTERLINE DRIVE FOR HOUSE #580. N=282893.590, E=13302350.600, ELEV=823.70' COORDINATES:

CONTROL POINT:

BACK OF CURB AND OPPOSITE CENTERLINE DRIVE FOR HOUSE #480. **COORDINATES:** N=283124.480, E=13302365.980, ELEV=811.92'

DESCRIPTION:

CONTROL POINT: DESCRIPTION:

FOUND PIPE WITH TRAVERSE CAP ON NORTH SIDE (AFTER CURB) OF

FOUND PIPE WITH TRAVERSE CAP ON EASTERLY SIDE OF RIVERVIEW. 2.2' OFF

RIVERVIEW. 3.0' OFF BACK OF CURB AND 50'± WEST OF MAILBOX FOR HOUSE

COORDINATES: N=283231.200, E=13302225.190, ELEV=804.58'

CONTROL POINT:

SET MAGNAIL IN ASPHALT AT BEND IN ROAD. NAIL IS NEAR BM30. DESCRIPTION: COORDINATES:

N=283125.190, E=13302083.540, ELEV=803.38'

EXISTING LEGEND PROPOSED LEGEND WATER MAIN ♦+ FIRE HYDRANT → HYDRANT (PLAN) I GATE VALVE IN BOX -----/-/-----/-/------ WATER MAIN ABANDONED ⊗ GATE VALVE IN WELL — — r — STORM SEWER SANITARY SEWER ▼ REDUCER STOP BOX -----/ ----/ STORM SEWER ABANDONED WATER GATE VALVE **FIDER OPTIC** ———— SANITARY SEWER WATER VAULT **₩** WELL -----/ ----/ SANITARY SEWER ABANDONED W WATER VAULT ----- CENTERLINE OF DITCH ☐ CATCH BASIN (SQ) ——— g —— —— —— GAS MAIN INLET — — CENTERLINE OF ROAD ⊕ CATCH BASIN (RD) DOUBLE INLET _____//_______________________FENCE O STORM MANHOLE INLET JUNCTION CHAMBER SILT FENCE ☐ NON-CURB CATCH BASIN (SQ) ROUND CATCH BASIN) END SECTION e duct bank ELECTRICAL DUCT BANK STORM MANHOLE PROTECTIVE FENCE O SANITARY MANHOLE DRAIN ARROW GUARDRAIL O CLEAN-OUT FLARED END SECTION POST SANITARY MANHOLE CURB t duct bank TELEPHONE DUCT BANK CLEAN—OUT — — — — TEMPORARY GRADING PERMIT ▶ SIGN BARREL -800 --- CONTOUR MAJOR ☐ HAND HOLE ⊸ SIGN CONTOUR MINOR ——— fo — — — — FIBER OPTIC ORNAMENTAL LIGHT PUSH BUTTON fo duct bank FIBER OPTIC DUCT BANK HAND HOLE - --- STORM EASEMENT ③ UNKNOWN MANHOLE BOUNDARY — SANITARY EASEMENT **©** TELEPHONE MANHOLE — · · — · · CENTERLINE OF DITCH TELEPHONE RISER LIMITS OF CONSTRUCTION — — — CENTERLINE/CROWN OF ROAD LIMIT OF GRADING — — — — 800 – — — — CONTOUR MAJOR O GAS VENT · · · · · · · · · · STONE WALL — — — — 799 — — — — — CONTOUR MINOR ⊞ GAS BOX DETECTABLE WARNING ----- EDGE OF WATER ☑ ELECTRICAL RISER FLOODPLAIN ASPHALT Ø UTILITY POLE ○ LAMP POLE ----:·----:·----: GRA VEL CONCRETE □ GUY ANCHOR Q GUY POLE STONE WALL SIDEWALK MONITORING WELL **■** MAILBOX TREELINE SOIL BORING ----- WETLAND TREE (DECIDUOUS) △ TRAVERSE POINT EDGE OF BRUSH + BENCH MARK HEDGE • IRON PIPE ■ MON BOX TREE (CONIFEROUS) TREE (DECIDUOUS) TREE TO BE REMOVED (DECIDUOUS) TREE (CONIFEROUS) SHRUB (DECIDUOUS) TREE TO BE REMOVED (CONIFEROUS) STUMP TO BE REMOVED TREE TO REMAIN & PROTECT (DECIDUOUS) CRITICAL ROOT ZONE (C.R.Z.) = DIAMETER BREAST HEIGHT (INCHES) X 10 TREE TO REMAIN & PROTECT (CONIFEROUS) CRITICAL ROOT ZONE (C.R.Z.) = DIAMETER BREAST HEIGHT (INCHES) X 10



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NCM	NCM	NCM	NCM	CHECKED
MF	MF	MF	MF	RAWN

RIVERVIEW DRIVE SANITARY AND WATER MAIN EXTENSION LEGEND, WITNESSES AND BENCHM. **ANN ARBOR**

SHEET No.

GENERAL NOTES:

- 1. DRIVEWAYS AND ENTRANCES TO BUILDINGS, REAL PROPERTY, AND THE LIKE SHALL NOT BE BLOCKED EXCEPT FOR SHORT DURATIONS AND ONLY WHEN APPROVED BY THE ENGINEER. VEHICULAR AND PEDESTRIAN ACCESS SHALL BE MAINTAINED AT ALL TIMES TO ALL PROPERTIES. IT SHALL BE THE CONTRACTOR'S RESPONSIBILITY TO COORDINATE ALL NECESSARY DRIVEWAY CLOSURES WITH THE PROPERTY OWNER(S) AND RESIDENT(S) IN THE AREAS OF CONSTRUCTION.
- THE CONTRACTOR SHALL MAINTAIN REASONABLE ACCESS FOR RESIDENTS TO ACCESS THEIR HOMES AT ALL TIMES. A SAFE ACCESS PATH SHALL BE IDENTIFIED ALONG WITH VEHICLE PARKING IN THE EVENT THAT CONSTRUCTION ACTIVITIES INHIBIT VEHICULAR ACCESS TO THE HOMES.
- THE LOCATION AND DEPTH OF ALL EXISTING UTILITIES AND SERVICE LEADS ARE TO BE FIELD VERIFIED BY THE CONTRACTOR PRIOR TO CONSTRUCTION.
- DURING NON-WORKING HOURS NO MORE THAN TEN (10) FEET OF TRENCH SHALL REMAIN OPEN. ANY OPEN TRENCH SHALL BE PROPERLY SECURED WITH PROTECTIVE FENCING. THIS WORK SHALL BE INCLUDED IN THE ITEMS OF WORK BEING UNDERTAKEN AND WILL NOT BE PAID FOR SEPARATELY.
- TRENCHES FOR NEW WATER SERVICES SHALL BE EXCAVATED TO MIOSHA AND CITY OF ANN ARBOR PUBLIC WORKS REQUIREMENTS.
- FOR THE INSTALLATION OF CORPORATIONS, OR ANY OTHER ACTIVITIES RELATED TO THE INSTALLATION OF WATER SERVICES, WATER MAIN SHUTDOWN, OR SIMILAR WORK, THE CONTRACTOR SHALL NOT RECEIVE ADDITIONAL COMPENSATION FOR DELAYS DUE TO THE SCHEDULING OF, OR COORDINATION WITH, CITY OF ANN ARBOR PUBLIC WORKS.
- THE CONTRACTOR SHALL BACKFILL TRENCHES IN ACCORDANCE WITH TRENCH DETAIL(S) SPECIFIED ON PLANS. THIS WORK SHALL BE INCLUDED IN THE ITEM OF WORK BEING PERFORMED.
- ALL DUCTILE IRON PIPE AND FITTINGS SHALL BE POLYETHYLENE WRAPPED PER ANSI/AWWA C105/A21.5.
- ALL FITTINGS, HYDRANTS, VALVES AND CASTINGS REMOVED DURING CONSTRUCTION SHALL BECOME THE PROPERTY OF THE CITY OF ANN ARBOR. THE CONTRACTOR SHALL COORDINATE PICKUP BY THE CITY OF ANN ARBOR FIELD OPERATIONS UNIT.
- 10. FLOUROPOLYMER COATED BOLTS ARE TO BE USED AT ALL MECHANICAL WATER MAIN JOINTS (HYDRANTS AND MEGALUG FITTINGS). SEE DETAILED SPECIFICATION ENTITLED "WATER MAIN AND APPURTENANCES" FOR ADDITIONAL INFORMATION.
- THE CONTRACTOR SHALL CONSTRUCT, FLUSH, AND BACTERIOLOGICALLY TEST THE WATER MAIN PER DETAILED SPECIFICATION "WATER MAIN AND APPURTENANCES" AND AS APPROVED BY THE ENGINEER. ALL CHLORINATED WATER SHALL BE DISCHARGED DIRECTLY INTO AN APPROVED SANITARY SEWER. THE CONTRACTOR SHALL SUPPLY ALL NECESSARY HOSES, FITTINGS AND THE LIKE TO ACCOMPLISH THIS WORK.
- 12. WATER MAIN FITTINGS, OTHER THAN THOSE SPECIFICALLY LISTED AS SEPARATE PAY ITEMS, WHICH ARE REQUIRED TO COMPLETE THE WORK, SUCH AS BLOW-OFF ASSEMBLIES, CONCRETE THRUST BLOCKS, SOLID SLEEVES AND MECHANICAL PLUGS, SHALL NOT BE PAID FOR SEPARATELY, BUT SHALL BE INCLUDED IN THE ASSOCIATED ITEMS OF WORK.
- 13. THE CONTRACTOR SHALL PERFORM THE CONSTRUCTION OPERATIONS SUCH THAT POSTAL DELIVERY AND REFUSE PICKUP SERVICE SHALL BE MAINTAINED AT ALL TIMES.
- 14. WHERE CURB AND GUTTER, CURB, PAVEMENT OR SIMILAR ITEMS BECOME UNDERMINED DUE TO THE CONTRACTOR'S OPERATIONS, THEY SHALL BE REMOVED AND REPLACED AS DIRECTED BY THE ENGINEER AT THE CONTRACTOR'S SOLE EXPENSE.
- 15. THE CONTRACTOR SHALL BE RESPONSIBLE FOR THE CONTINUOUS MAINTENANCE OF THE TEMPORARY ROAD SURFACE AND SOIL EROSION CONTROL MEASURES WITHIN THE CONSTRUCTION AREA UNTIL THE COMPLETION OF THE PROJECT. THIS WORK SHALL NOT BE PAID FOR SEPARATELY, BUT SHALL BE INCLUDED IN THE ITEM OF WORK "GENERAL CONDITIONS, MAX.____".
- THE LOCATION OF MATERIAL STOCK PILES AND ON-SITE STAGING AREAS SHALL BE APPROVED BY THE ENGINEER. ALL MATERIAL STOCKPILES SHALL BE MAINTAINED SUCH THAT DRAINAGE

- 16. FOR MAINLINE PAVING, THE WIDTH OF THE MAT FOR EACH PASS OF THE PAVER SHALL BE NOT LESS THAN 10.5' OR GREATER THAN 15', AS DIRECTED BY THE ENGINEER. THE ENGINEER WILL DIRECT THE LAYOUT OF THE LONGITUDINAL JOINTS DURING CONSTRUCTION.
- 17. WHERE SEWER PIPES OF DIFFERENT SIZES OR MATERIALS ARE JOINED, FERNCO FLEXIBLE COUPLINGS WITH STAINLESS STEEL SHEAR RINGS SHALL BE USED. THE CONTRACTOR'S PURCHASE PRICE FOR THESE DEVICES, INCLUDING SHIPPING, **SHALL BE PAID AS AN** EXTRA. PRIOR TO PAYMENT FOR THIS ITEM, THE CONTRACTOR SHALL SUBMIT RECEIPTS FOR THE ENGINEER'S REVIEW AND APPROVAL ALL OTHER COSTS ASSOCIATED WITH THE INSTALLATION OF THESE DEVICES SHALL BE INCLUDED IN THE PAYMENT FOR THE SEWER.
- 18. WHERE SEWER AND WATER MAIN ARE TO BE REMOVED & REPLACED OR ADDED, ALL PIPE SHALL BE INSTALLED USING TRENCH DETAIL DETAILED IN THE SPECIFICATIONS OR SHOWN ON PLANS. BACKFILL FOR SEWER AND WATER CONSTRUCTION SHALL BE MDOT GRANULAR MATERIAL, CLASS II.
- 19. SOME STORM SEWER MAY UNAVOIDABLY BECOME DAMAGED DURING CONSTRUCTION OR IT MAY BE DETERMINED BY THE ENGINEER THAT EXISTING STORM SEWER NEEDS TO BE REPLACED. IN EITHER CASE. THE ENGINEER MAY DIRECT THE SEWER TO BE REMOVED AND REPLACED. THE REMOVAL OF THE EXISTING SEWER AND/OR DRAINAGE STRUCTURES SHALL BE INCLUDED IN THE CONTRACT WORK ITEMS "SEWER, ANY SIZE OR DEPTH, REM" OR "DR STRUCTURE, ANY SIZE OR DEPTH, REM", AND THE REPLACEMENT SEWER SHALL BE INSTALLED AND PAID FOR AT THE CORRESPONDING CONTRACT UNIT PRICE, IF CONTAINED WITHIN THE CONTRACT, FOR THE VARIOUS TYPES AND SIZES OF SEWER TO BE REPLACED.
- 20. WHERE EXISTING SEWER AND/OR DRAINAGE STRUCTURES ARE TO BE REMOVED, THEY SHALL BE PROPERLY DISPOSED OF OFF-SITE AND THE EXCAVATION SHALL BE BACKFILLED WITH MDOT CLASS II GRANULAR MATERIAL, COMPACTED TO 95% OF ITS MAX. DRY DENSITY. THIS WORK SHALL BE INCLUDED IN THE CONTRACT ITEMS "SEWER, ANY SIZE OR DEPTH, REM" AND/OR DR STRUCTURE, ANY SIZE OR DEPTH, REM".
- 21. IF THE CONTRACTOR ENCOUNTERS EXISTING EDGE DRAIN(S) DURING CONSTRUCTION OF THE PROPOSED EDGE DRAINS, INLET LEADS, OR CATCH BASINS, IT SHALL BE CAPPED AT EACH END TO PREVENT MATERIAL FROM ENTERING THE PIPE. THE COST OF THIS WORK WILL NOT BE PAID FOR SEPARATELY, BUT SHALL BE INCLUDED IN THE PARTICULAR ITEM OF WORK BEING PERFORMED WHEN EXISTING EDGE DRAIN(S) ARE ENCOUNTERED.
- 22. EXISTING STREET NAME, GUIDE AND REGULATORY SIGNS, AND MAILBOXES WHICH CONFLICT WITH THE PROPOSED CONSTRUCTION SHALL BE REMOVED PRIOR TO CONSTRUCTION, STORED IN A MANNER WHICH WILL PREVENT DAMAGE, AND RE-SET IN LOCATIONS AS DIRECTED BY THE ENGINEER. THIS WORK WILL NOT BE PAID FOR SEPARATELY, BUT SHALL BE INCLUDED IN "GENERAL CONDITIONS, MAX____".
- 23. ALL STRUCTURES SHALL RECEIVE NEW CASTINGS, EITHER TYPE B, TYPE K, TYPE Q, OR TYPE R AS SPECIFIED ON THE STANDARD CASTING SCHEDULE. THE EXISTING CASTINGS SHALL BE NEATLY STACKED ON-SITE IN A SINGLE LOCATION SO THAT THE CITY OF ANN ARBOR FORCES CAN RETRIEVE THEM AT A LATER DATE. THE CONTRACTOR SHALL ASSIST CITY FORCES BY LOADING THEM INTO CITY TRUCKS. ALL COSTS ASSOCIATED WITH STORING, STOCKPILING AND LOADING CASTINGS SHALL BE INCLUDED IN THE ITEM OF WORK "GENERAL CONDITIONS, MAX.___" AND WILL NOT BE PAID FOR SEPARATELY.
- 24. ALL EXCAVATION REQUIRED FOR PROJECT GRADING WITHIN THE PROJECT LIMITS, INCLUDING PROPOSED PAVEMENT, DRIVE APPROACHES, SIDEWALK, AND SIDEWALK RAMPS SHALL BE INCLUDED IN "MACHINE GRADING, MODIFIED, ____.
- 25. ALL CURB, SIDEWALK, AND DRIVEWAY APPROACH REMOVALS SHALL BE APPROVED BY THE ENGINEER BEFORE THE WORK IS PERFORMED. ALL CONCRETE AND BITUMINOUS MATERIALS SHALL BE SAW-CUT FULL-DEPTH AT THEIR REMOVAL LIMITS PRIOR TO REMOVAL. SAW-CUTTING WILL NOT BE PAID FOR SEPARATELY, BUT SHALL BE INCLUDED IN THE ITEM OF WORK "MACHINE GRADING, MODIFIED, _____".

26. PLACE 8" (MINIMUM) 21AA LIMESTONE AGGREGATE COMPACTED TO 98% OF ITS MAX. WORK SHALL BE INCLUDED IN THE CONTRACT ITEM "AGGREGATE BASE, 8 INCH, 21AA MODIFIED".

DRY DENSITY UNDER DRIVE APPROACHES. THIS

WATER MAIN AND SANITARY SEWER QUANTITIES

GATE VALVE AND BOX, 12-INCH GATE VALVE AND WELL, 8-INCH

1515 LET PC 350 DT WATER MAIN 12-INCH

PERMANENT BLOW-OFF, 12-INCH SEWER SDR 35 PVC PIPE, 8-INCH

Basis of Design F	or Rivervi	ew Drive	<u> </u>		
Single Family Unit	s =			9	
9 Units * 3.5 Peop	le/Unit * 1	100 GPD	Person=	3,150	
				or 0.0048	37 CFS
Population =	32				
Peaking Factor =	(18+(P) [^]	0.5)/(4+(F	P)^.5) Where	P is in Tho	usands
Peaking Factor =	4.35				
Dook Flow = 4.25	* 0 0040	7.000-0	0242 050		

PERMITS REQUIRED TO BE OBTAINED BY THE CONTRACTOR DDIOD TO THE REGINNING OF CONSTRUCTION

PERMIT	ISSUING AUTHORITY
LANE CLOSURE PERMIT*	CITY OF ANN ARBOR ENGINEERING
GRADING/SOIL EROSION & SEDIMENTATION CONTROL PERMIT*	CITY OF ANN ARBOR CUSTOMER SERVICE
RIGHT-OF-WAY PERMIT*	CITY OF ANN ARBOR CUSTOMER SERVICE

* NO COST TO CONTRACTOR

PERMITS REQUIRED TO BE OBTAINED BY THE CITY OF ANN ARBOR PRIOR TO THE BEGINNING OF CONSTRUCTION.

PERMIT	ISSUING AUTHORITY		
M.D.E.Q. WATER MAIN CONSTRUCTION PERMIT	MICHIGAN DEPARTMENT OF ENVIRONMENTAL QUALITY		
M.D.E.Q. SANITARY SEWER CONSTRUCTION PERMIT	MICHIGAN DEPARTMENT OF ENVIRONMENTAL QUALITY		

CONTACT INFORMATION

PUBLIC UTILITIES	OWNER	CONTACT
WATER		DAN WOODEN (734) 794-6350
SANITARY		RYAN FERRELL (734) 794-6350
STORM	CITY OF ANN ARBOR PUBLIC WORKS W.R. WHEELER SERVICE CENTER 4251 STONE SCHOOL ROAD	PAT MAINO (734) 794–6350
FORESTRY	ANN ARBOR, MI 48108	CHUCk GOEBEL (734) 794-6350
SIGNS SIGNALS STREET LIGHTS		CHUCK FOJTIK (734) 794-6361
PRIVATE UTILITIES	OWNER	CONTACT
GAS	DTE ENERGY 3150 E. MICHIGAN AVE, YPSILANTI TOWNSHIP, MI 48198	LAURIE FORRESTER (734) 389-7261
ELECTRIC	DTE ENERGY WESTERN WAYNE SERVICE CENTER 8001 HAGGERTY ROAD BELLEVILLE, MI 48111	JULIE GOTTARDI (734) 397-4303
CABLE	COMCAST 25626 TELEGRAPH ROAD SOUTHFIELD, MI 48034	JON LABEAU (248) 809-2704
PHONE	AT&T 550 S. MAPLE ROAD ANN ARBOR, MI 48103	SHAWN BURNSIDE (734) 996-5350
FIBER OPTIC	ANN ARBOR PUBLIC SCHOOLS FIBER LINK 3529 W. GENSEE, SUITE 6 LAPEER, MI 48446	TINA SNOBLEN (810) 667-2891
FIBER OPTIC	MCI/VERIZON 730 W. HENRY STREET INDIANAPOLIS, IN 46225	CHRIS FOWLER (317) 685-8050
FIBER OPTIC	ZAYO GROUP 1060 HARDEES DRIVE, SUITE H ABERDEEN, MD 21001	GEORGE HUSS (443) 403-2023

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SEWEF PROJE

SANITARY EXTENSION I ENGINEERIN шШ / DRIVI RIVERVIEW AND WATER IN

ARBO ANN

SHEET No.


3 OF 30

10	L' '	1 0 000 D.I. WATER WAIN, 12 HOLL
37	LFT	PC 350 D.I. WATER MAIN, 8-INCH
	LFT	PC 350 D.I. WATER MAIN, 6-INCH
52	LFT	WATER MAIN, HDPE, 10-INCH, DIRECTIONAL DRILL
)5	LFT	WATER MAIN, HDPE, 14-INCH, DIRECTIONAL DRILL
	EA	FIRE HYDRANT

SANITARY SEWER, DROP CONNECTION, 8-INCH

DR STRUCTURE, MANHOLE, TYPE I, 48 INCH DIA, SANITARY

Basis of Design F	or Rivervi	ew Drive			
Single Family Unit	ts =			9	
9 Units * 3.5 Peop	e/Unit * 1	100 GPD/	Person=	3,150	
				or 0.0048	37 CFS
Population =	32				
Peaking Factor =	(18+(P) [^]	0.5)/(4+(F)	P)^.5) Where I	P is in Tho	usands
Peaking Factor =	4.35				
Peak Flow = 4.35	* 0.00487	7 CFS= 0	.0212 CFS		

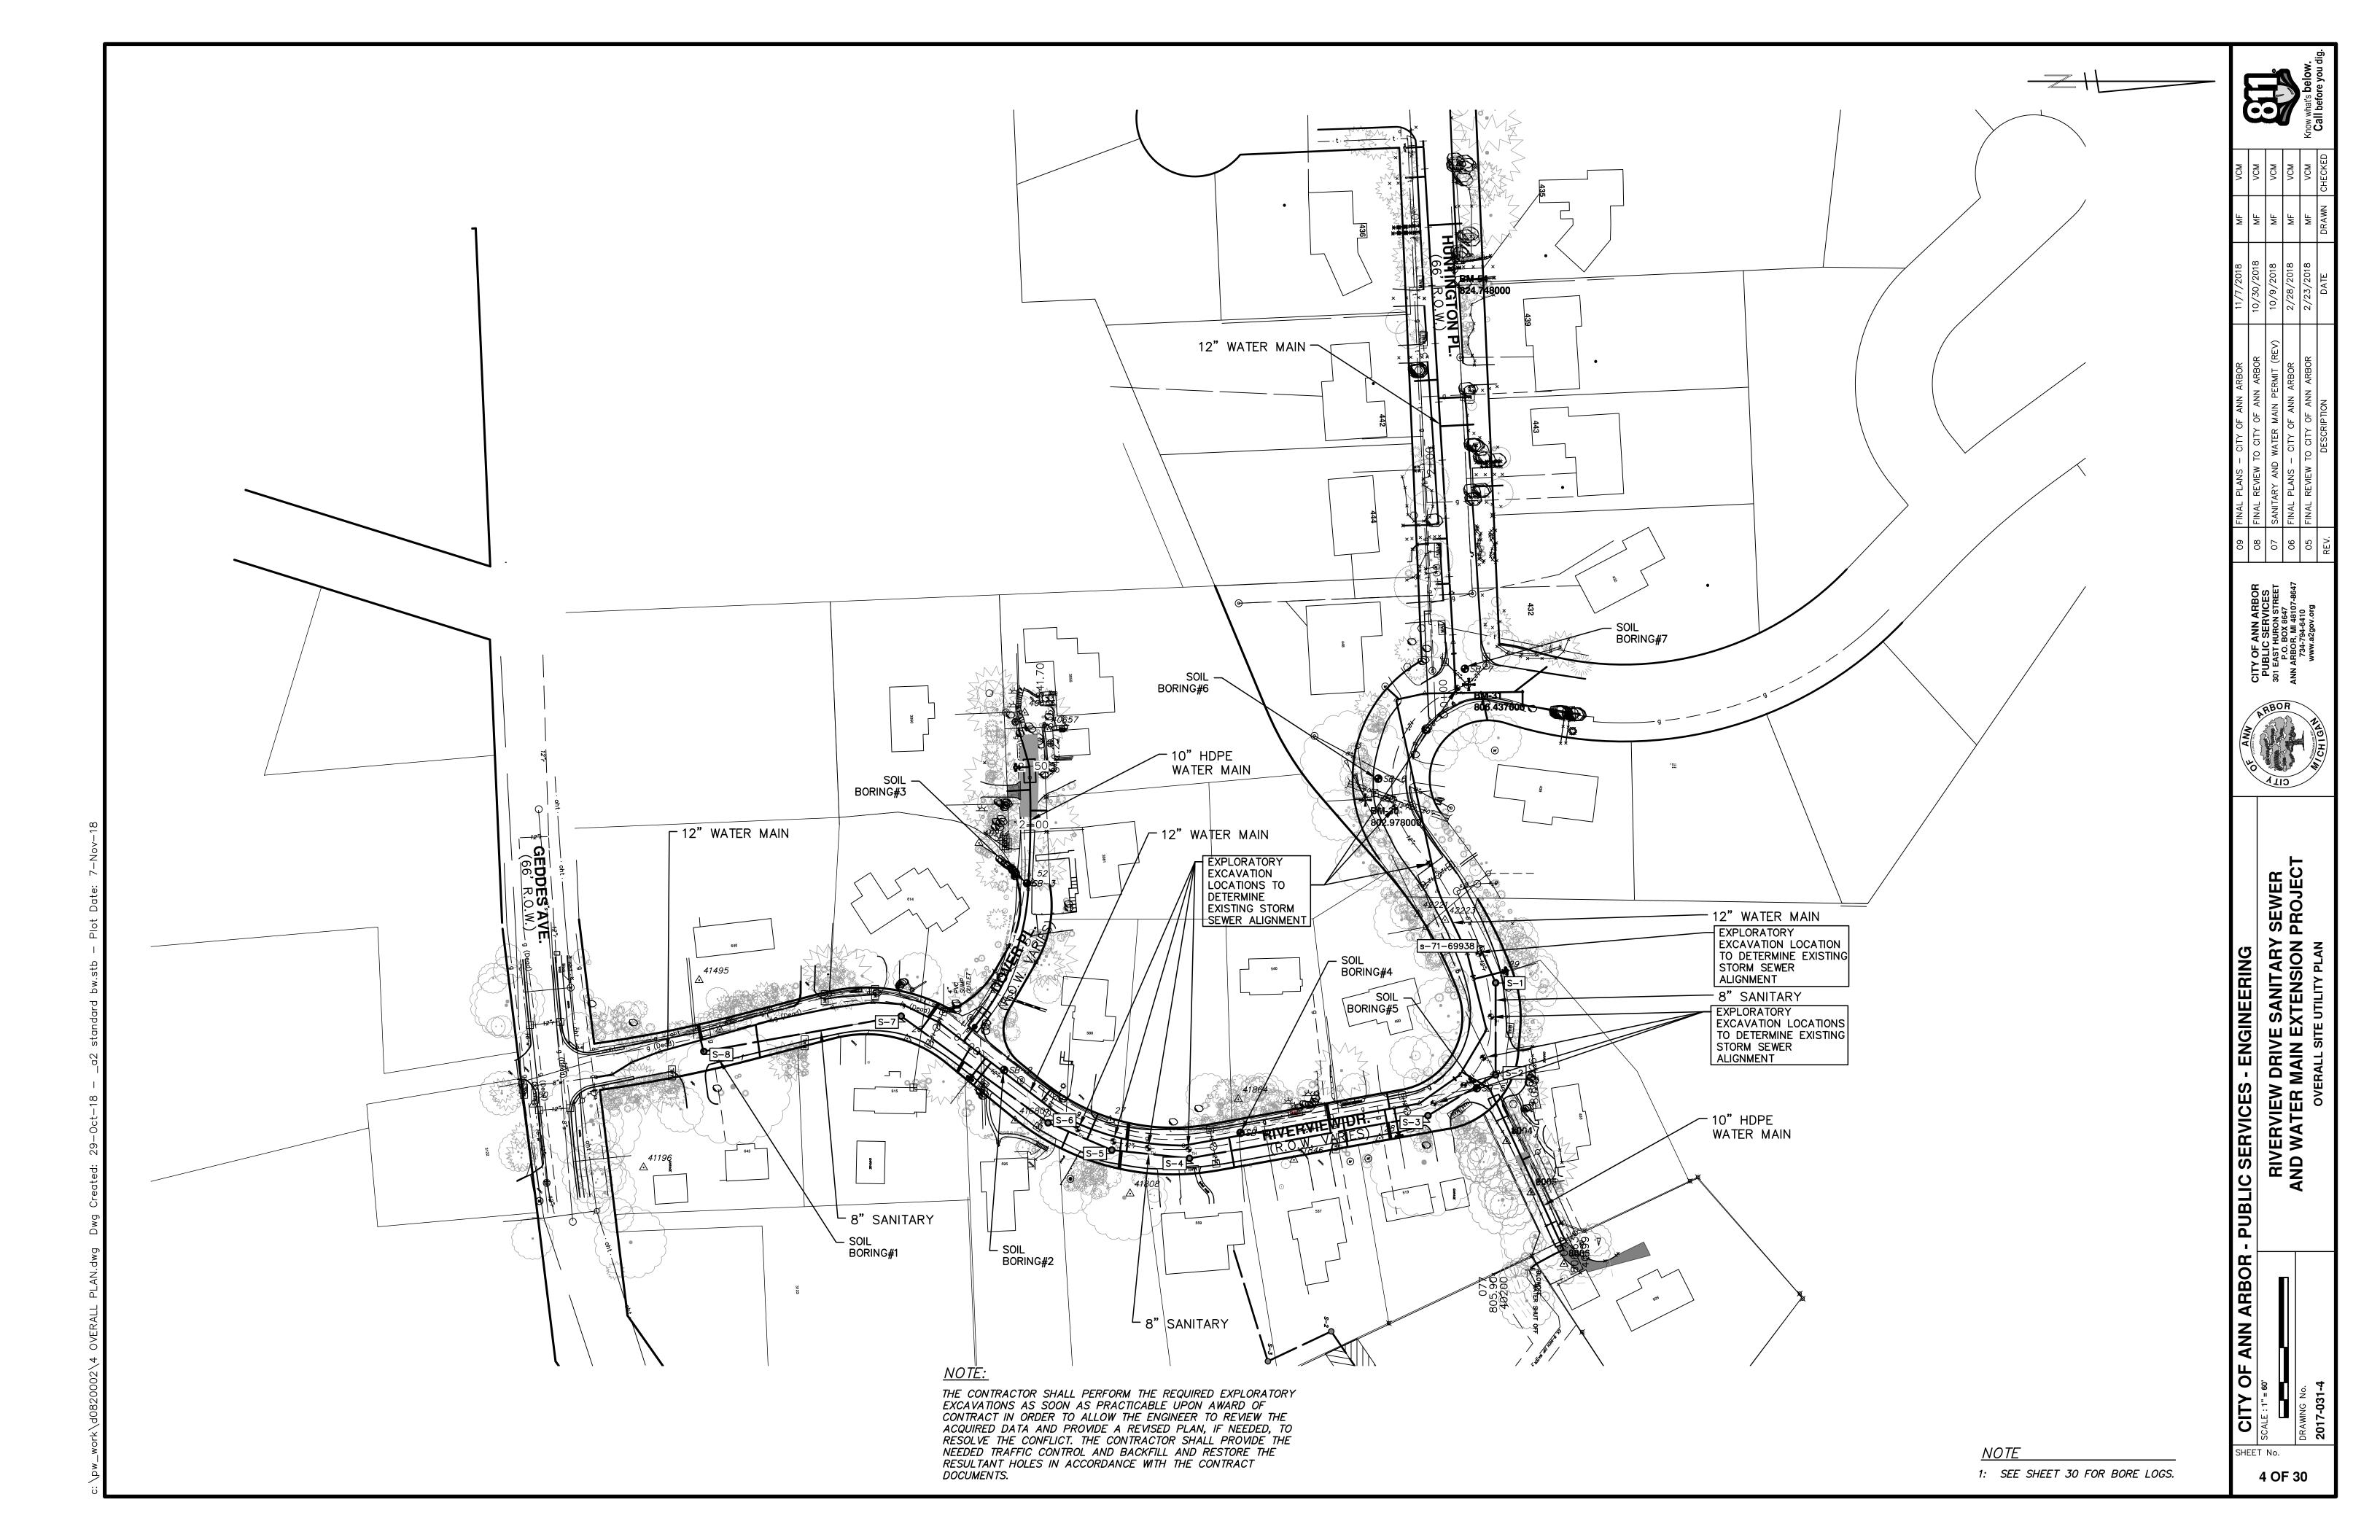





SOIL EROSION NOTES

- 1: ALL AREAS TO BE PERMANENTLY RESTORED WITH GRASS SHALL RECEIVE TOPSOIL, HYDROSEED, AND STAKED EROSION CONTROL BLANKETS (MULCH BLANKETS).
- 2: STREETS EXTERNAL TO THE PROJECT AREA SHALL BE MONITORED FOR TRACKED MUD AND/OR CONSTRUCTION DEBRIS AND SHALL BE IMMEDIATELY CLEANED FOLLOWING ANY SUCH OCCURRENCE.

SOIL EROSION SEQUENCE OF CONSTRUCTION*


- 1: PLACE INLET FILTERS ON EXISTING DRAINAGE FEATURES THAT WILL REMAIN IN PLACE AFTER CONSTRUCTION BEGINS.
- 2: INSTALL SEWERS, WATER MAIN AND PAVEMENT IMPROVEMENTS.
- 3: RESTORE ALL DISTURBED AREAS TO A CONDITION THAT IS BETTER THAN, OR EQUAL TO, THAT WHICH EXISTED PRIOR TO
- THE COMMENCEMENT OF CONSTRUCTION ACTIVITIES. 4: INSPECT & REPAIR OR REPLACE ALL TEMPORARY SESC MEASURES WEEKLY AND WITHIN 24 HOURS OF A STORM
- 5: ESTABLISH VEGETATION FOR ALL DISTURBED AREAS WITHIN CONSTRUCTION LIMITS.
- 6: CLEAN OUT STORM SEWER SYSTEMS.
- 7: REMOVE TEMPORARY SESC FEATURES (CALL FOR FINAL INSPECTION).
- 8: REMEDY ANY NOTED DEFECTS TO THE SATISFACTION OF THE CITY'S SESC OFFICIAL.

*NOTE: THIS SEQUENCE IS FOR INFORMATION ONLY. IT IS INTENDED TO SHOW THE SEQUENCE OF CONSTRUCTION WITH RESPECT TO THE SOIL EROSION CONTROL MEASURES. THE CONTRACTOR IS RESPONSIBLE FOR SUBMITTING THEIR OWN DETAILED CONSTRUCTION SEQUENCE AND SCHEDULE TO THE ENGINEER FOR REVIEW, COMMENT AND ACCEPTANCE.

<u>LEGEND</u>

INLET FILET (FOR EXISTING STRUCTURE)

PAVEMENT TO BE REMOVED
(WITHIN THE PHASES OF CONSTRUCTION
DETAILED WITHIN THE CONTRACT DOCUMENTS)

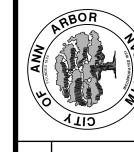

RIVERVIEW DRIVE SANITARY SEWER AND WATER MAIN EXTENSION PROJECTION SOIL EROSION AND SEDIMENTATION CONTROL PLAN

CITY OF ANN ARBOR - PUBLIC SERVICES - ENGINEERING

SHEET No.

NOTIFY THE CITY OF ANN ARBOR SOIL EROSION CONTROL OFFICE 48 HOURS PRIOR TO BEGINNING WORK ON THE PROJECT. PHONE: 734-794-6265.

- 1. THE CONTRACTOR SHALL IMPLEMENT AND MAINTAIN THE SOIL EROSION CONTROL MEASURES AS SHOWN ON THE PLANS AND AS DIRECTED BY THE ENGINEER AT ALL TIMES DURING CONSTRUCTION. ANY MODIFICATIONS OR ADDITIONS TO THE SOIL EROSION CONTROL MEASURES DUE TO CONSTRUCTION OR CHANGED CONDITIONS SHALL BE AS DIRECTED AND APPROVED BY THE ENGINEER.
- 2. ALL SOIL EROSION AND SEDIMENTATION CONTROL WORK SHALL CONFORM TO THE PERMIT REQUIREMENTS OF THE CITY OF ANN ARBOR, CITY ORDINANCE CHAPTER 63. CITY OF ANN ARBOR STANDARDS DIVISION VII. THE LAWS OF THE STATE OF MICHIGAN, AND THE REQUIREMENTS OF THE CONTRACT DOCUMENTS.
- 3. DAILY, OR AFTER ANY STORM EVENT, INSPECTIONS OF EROSION CONTROL MEASURES SHALL BE MADE BY THE CONTRACTOR. PERIODIC INSPECTIONS MAY BE MADE BY THE ENGINEER TO DETERMINE THE EFFECTIVENESS OF EROSION AND SEDIMENTATION CONTROL MEASURES. ANY NECESSARY CORRECTIONS SHALL BE MADE WITHOUT DELAY, AND WITHOUT ADDITIONAL COST TO THE CITY OF ANN ARBOR.
- 4. EROSION AND SEDIMENTATION FROM WORK ON THE SITE SHALL BE CONTAINED ON THE SITE AND NOT BE ALLOWED TO COLLECT ON ANY OFF-SITE AREAS, ROADWAYS OR WATERWAYS.
- 5. ALL MUD/SOIL TRACKED ONTO ROADWAYS FROM THE SITE DUE TO CONSTRUCTION, SHALL BE PROMPTLY REMOVED BY THE CONTRACTOR. IF SO ORDERED, THE CONTRACTOR SHALL PROVIDE AND OPERATE A VACUUM-TYPE STREET SWEEPER, AT NO ADDITIONAL COST TO THE CITY OF ANN ARBOR, WITHIN FOUR (4) HOURS OF BEING SO ORDERED.
- 6. RESTORATION OF ALL DISTURBED AREAS, INCLUDING PLACEMENT OF TOPSOIL, SEED, FERTILIZER AND MULCH AND/OR SOD SHALL BE PERFORMED WITHIN FIVE (5) DAYS OF THE COMPLETION OF FINAL GRADE.
- 7. CONSTRUCTION OPERATIONS SHALL BE SCHEDULED AND PERFORMED SO THAT PREVENTATIVE SOIL EROSION CONTROL MEASURES ARE IN PLACE PRIOR TO

- EXCAVATION IN CRITICAL AREAS AND TEMPORARY STABILIZATION MEASURES ARE IN PLACE IMMEDIATELY FOLLOWING BACKFILLING OPERATIONS.
- 8. SPECIAL PRECAUTIONS WILL BE TAKEN IN THE USE OF CONSTRUCTION EQUIPMENT TO PREVENT SITUATIONS THAT PROMOTE EROSION.
- 9. PROPER DUST CONTROL SHALL BE MAINTAINED DURING CONSTRUCTION BY USE OF WATER TRUCKS AND/OR DUST PALLATIVE AS REQUIRED.
- 10. THE CONTRACTOR SHALL BE RESPONSIBLE FOR MAINTAINING ALL TEMPORARY SOIL EROSION CONTROL MEASURES AND REMOVAL OF SOME MEASURES UPON AUTHORIZED COMPLETION OF THE PROJECT. FINAL COMPLETION OF PROJECT WILL NOT BE AUTHORIZED UNTIL ALL SITE WORK AND UTILITY CONSTRUCTION IS COMPLETE AND ALL SOILS ARE STABILIZED.
- 11. THE CONTRACTOR SHALL NOT GRADE INTO ADJACENT PROPERTIES. SILT AND PROTECTIVE FENCE SHALL BE INSTALLED AND MAINTAINED TO PREVENT GRADING, EROSION AND SEDIMENTATION INTO THE ADJACENT PROPERTIES.
- 12. TREE PROTECTION FENCING MUST REMAIN INTACT UNTIL RESTORATION OF THE SITE IS COMPLETE.

SEQUENCE OF EROSION CONTROL MEASURES:

1. THE CONTRACTOR IS TO SUBMIT TO THE ENGINEER, A SEQUENCE OF CONSTRUCTION WITH RESPECT TO THE SOIL EROSION CONTROL MEASURES FOR REVIEW, COMMENT AND APPROVAL. THIS SCHEDULE IS TO INCLUDE INSPECTION AND REPAIR OF ALL TEMPORARY EROSION CONTROL MEASURES DAILY AND WITHIN 24 HOURS OF A STORM EVENT.

ON SITE SOILS PER THE USDA SOIL SURVEY OF WASHTENAW COUNTY, MICHIGAN: MmD - MIAMI LOAM - 12 TO 18 PERCENT SLOPES. IN BROAD AREAS AND ALONG DRAINAGEWAYS OF TILL PLAINS AND MORAINES. SLOPES IN BROAD AREAS ARE SHORT AND COMPLEX.

> TOTAL AREA OF PROPOSED DISTURBANCE = 0.74 AC 0.71 AC - RIVERVIEW DRIVE

0.03 AC - DOVER PLACE

CURB OPENING 1" REBAR FOR BAG REMOVAL FROM INLET OPTIONAL OVERFLOW SILTSACK -DUMP LOOPS (REBAR -NOT INCLUDED) SIDE VIEW INSTALLED **INSTALLATION DETAIL**

SILTSACK DETAIL

NOTE: THE SILTSACK WILL BE MANUFACTURED FROM A WOVEN POLYPROPYLENE FABRIC THAT MEETS OR EXCEEDS THE FOLLOWING SPECIFICATIONS.

REGULAR FLOW SILTSACK

(FOR AREAS OF LOW TO MODERATE PRECIPITATION AND RUN-OFF) TEST METHOD <u>PROPERTIES</u> REQUIRED VALUE GRAB TENSILE STRENGTH GRAB TENSILE ELONGATION MULLEN BURST TRAPEZOID TEAR 120 LBS

ASTM D-4751

ASTM D-4491

ASTM D-4491

40 US SIEVE

40 GAL/MIN/SQ FT 0.55 SEC -1

HI-FLOW SILTSACK

APPARENT OPENING SIZE


FLOW RATE PERMITTIVITY

(FOR AREAS OF MODERATE	TO HEAVY PRECIPITATION A	ND RUN-OFF)
<u>PROPERTIES</u>	REQUIRED VALUE	TEST METHOD
GRAB TENSILE STRENGTH GRAB TENSILE ELONGATION PUNCTURE MULLEN BURST TRAPEZOID TEAR UV RESISTANCE APPARENT OPENING SIZE	ASTM D-4833 ASTM D-3786 ASTM D-4533 ASTM D-4355	420 PSI 45 LBS 90% 20 US SIEVE
FLOW RATE PERMITTIVITY	ASTM D-4491 ASTM D-4491	200 GAL/MIN/SQ FT 1.5 SEC-1

OIL-ABSORBANT SILTSACK


(FOR AREAS WHERE THERE IS A CONCERN FOR OIL RUN-OFF OR SPILLS)

IT IS THE INTENT OF THE PLANS AND SPECIFICATIONS THAT THE CONTRACTOR INSTALL THE REBAR AS SHOWN IN THIS DETAIL TO PROVIDE A FULLY FUNCTIONING UNIT. ALL COSTS ASSOCIATED
WITH FURNISHING, CLEANING AS MANY TIMES AS REQUIRED, DISPOSAL
OF SEDIMENT, AND REMOVING THE INLET FILTER WHEN NO LONGER NEEDED IS INCLUDED IN THE ITEM OF WORK AND WILL NOT BE PAID FOR SEPARATELY.

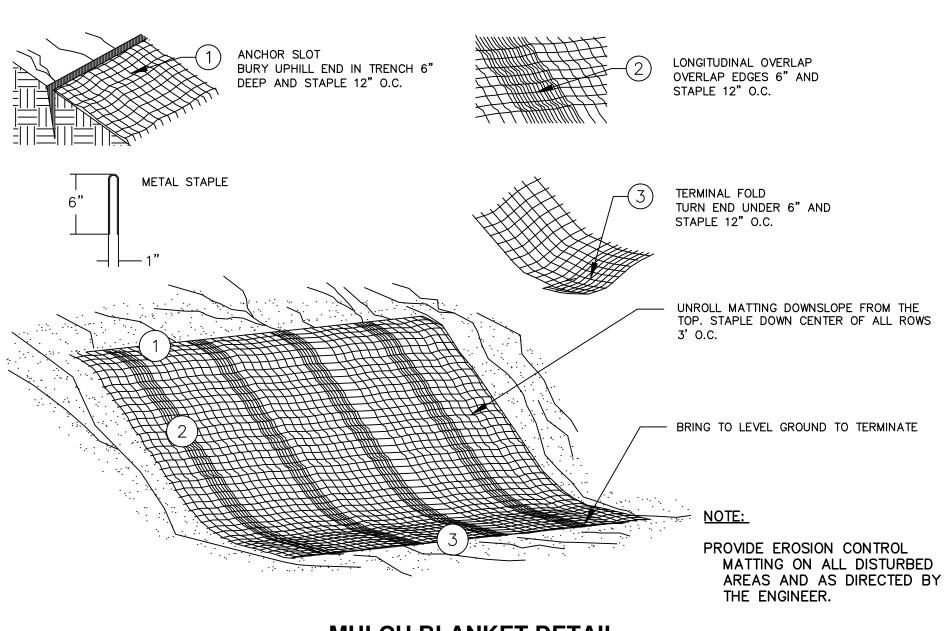


MULCH BLANKET DETAIL

APPLIES TO ALL AREAS TO BE PERMANENTLY RESTORED WITH GRASS.

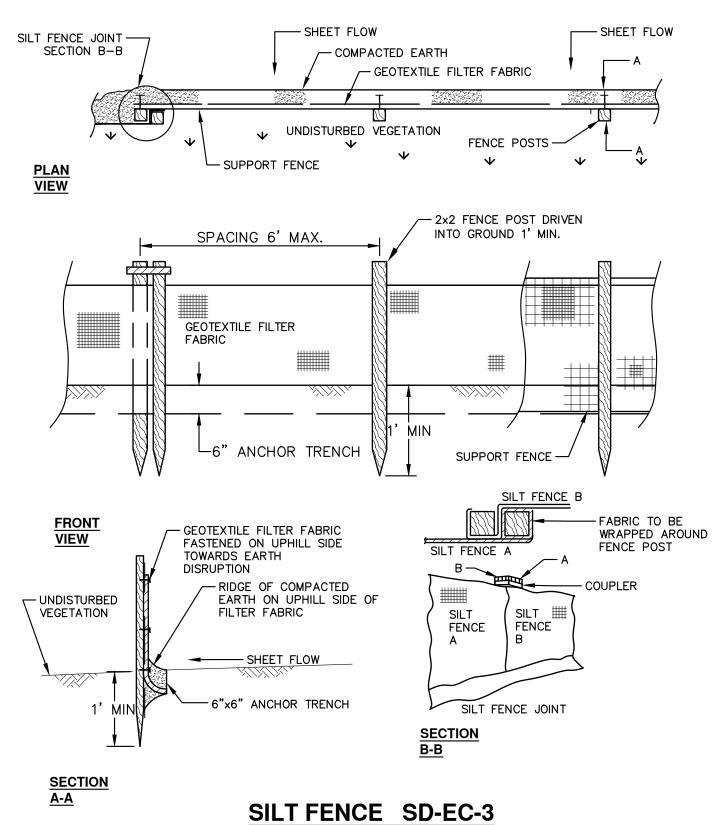

| # | # | # | # | <u>*</u>

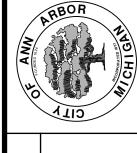


SEWER PROJEC

RIVERVIEW DRIVE SANITARY
AND WATER MAIN EXTENSION
SOIL EROSION DETAILS

SERVICES

ANN ARBO

SHEET No. 6 OF 30

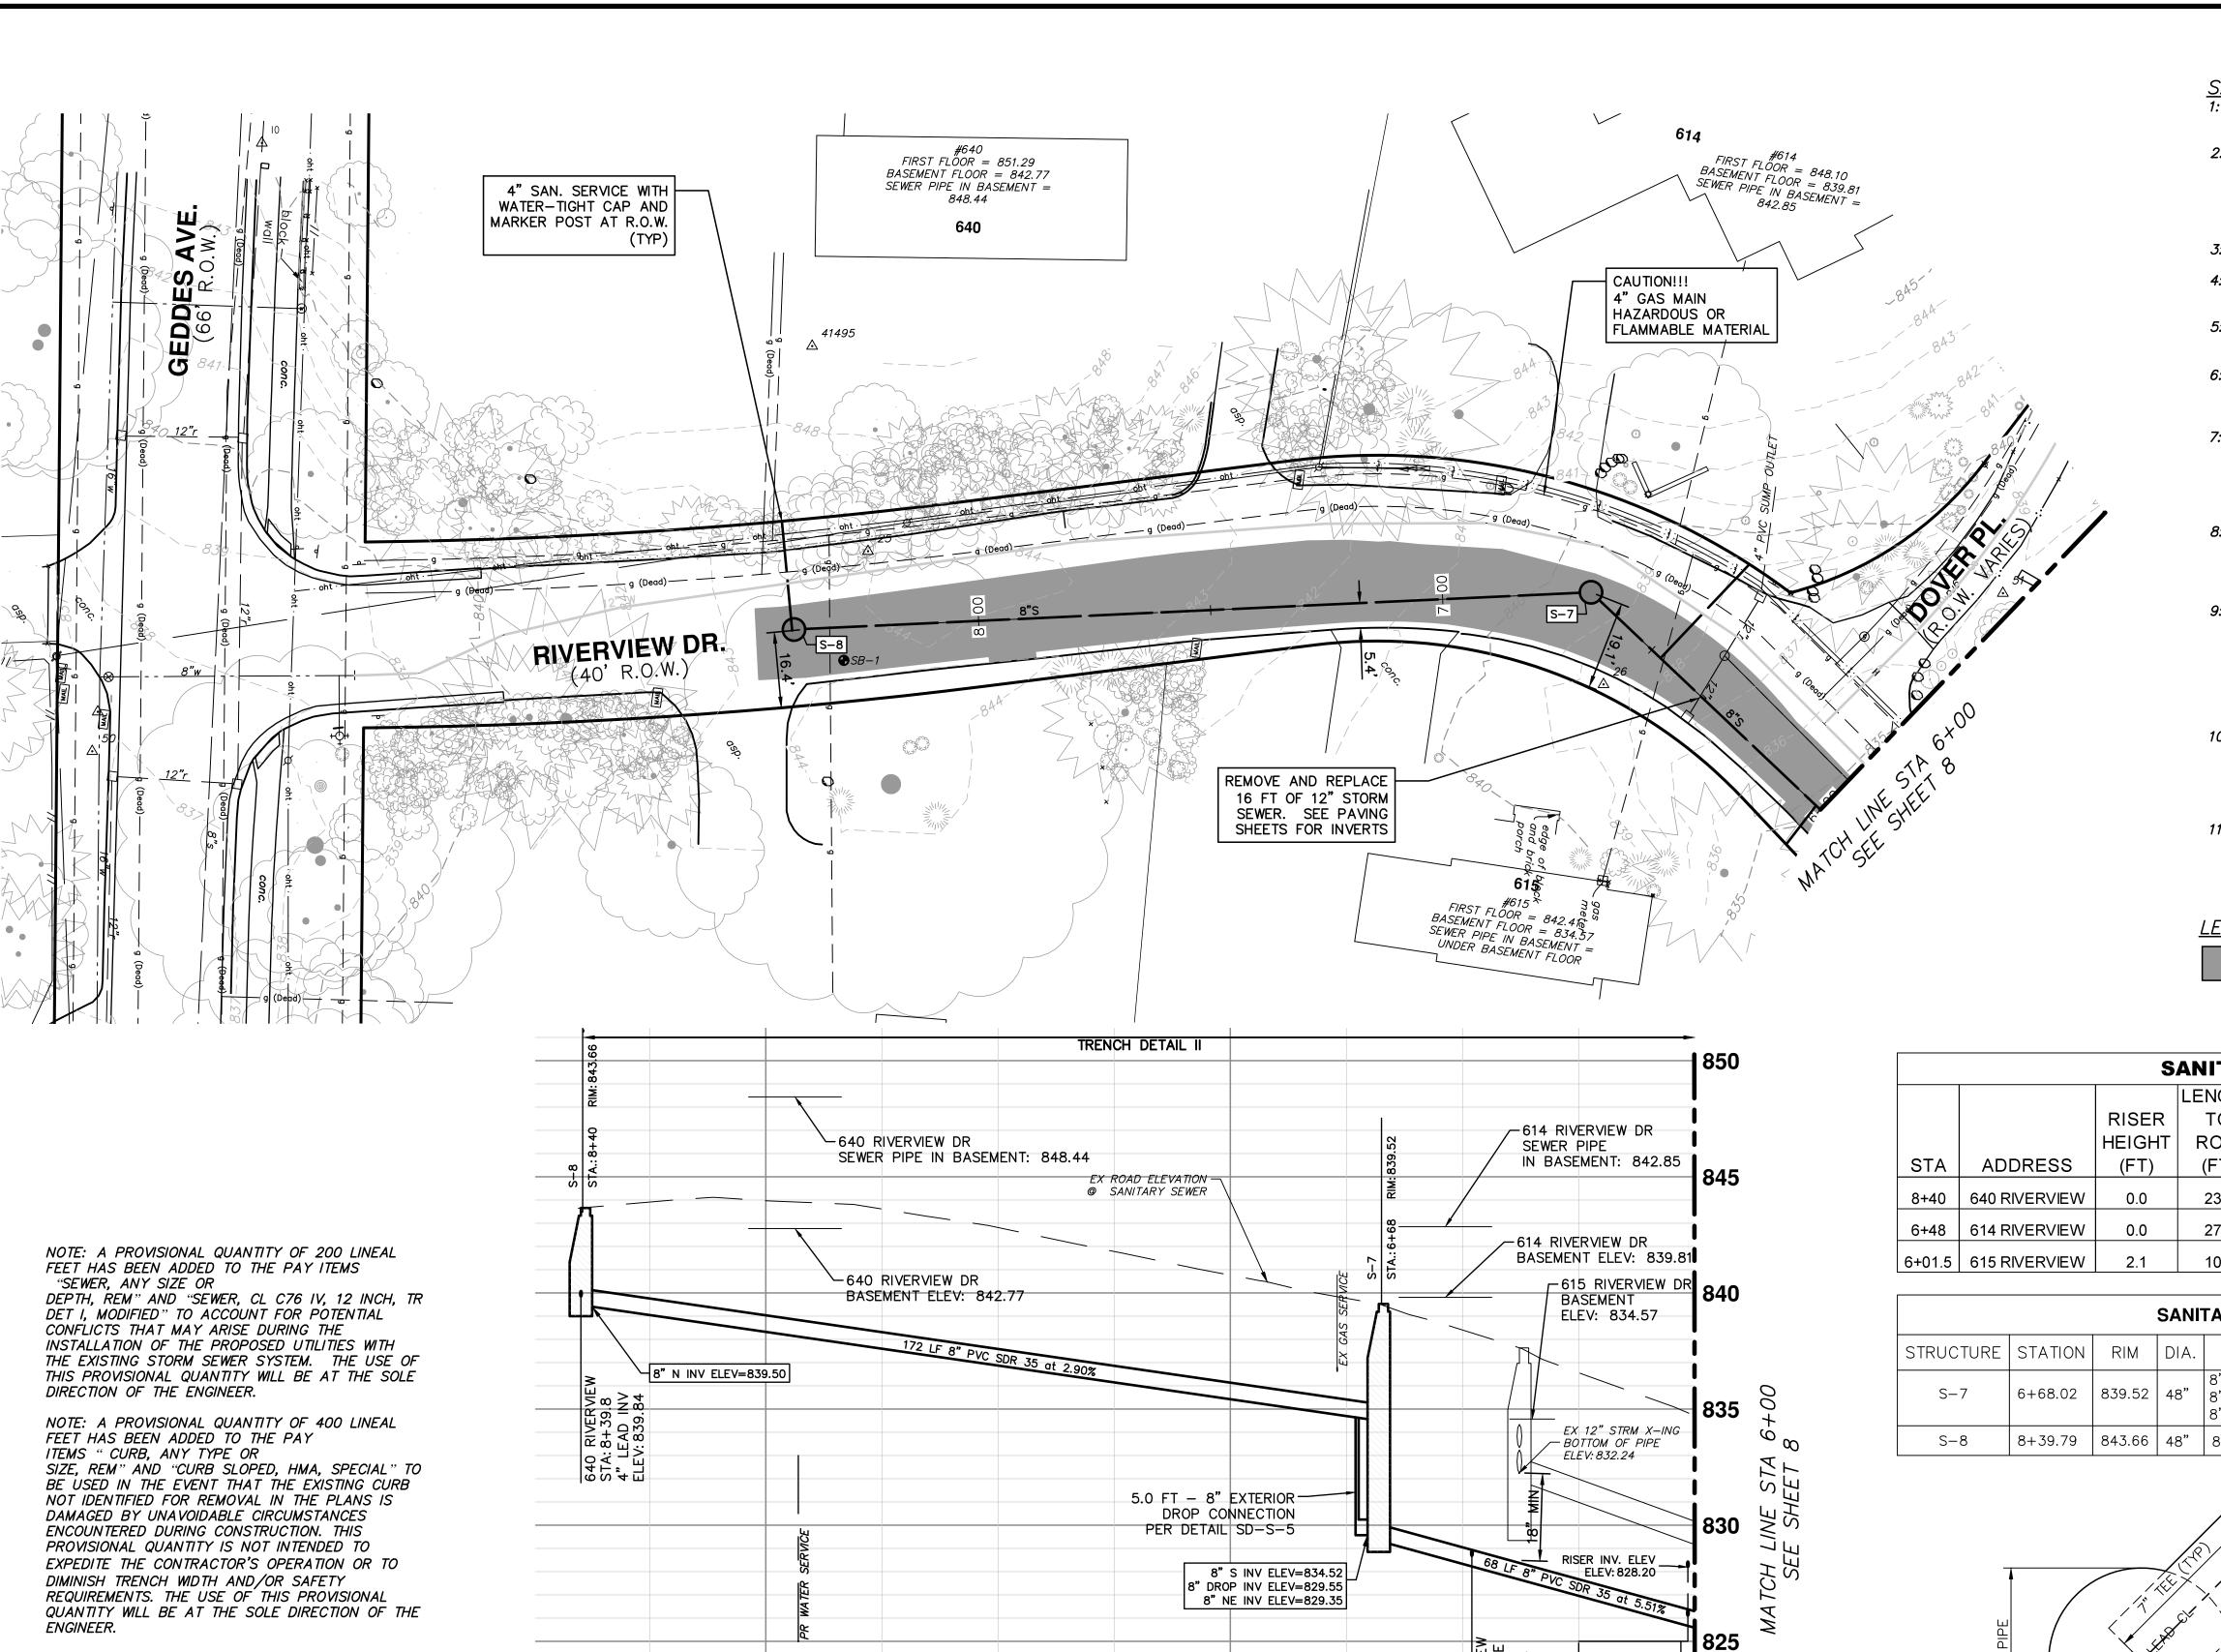

+25

+50

7+00

+75

8+00

+75

+25

SANITARY SEWER NOTES

- 1: SEE SOIL EROSION CONTROL SHEETS FOR DETAILS ON PLACEMENT, MAINTENANCE, AND REMOVAL OF EROSION CONTROL ITEMS.
- 2: NEW SANITARY SEWER SHALL CONSIST OF ASTM D3034 SOLID WALL PVC SDR35 PIPE AND SDR 26 PIPE WITH WATER-TIGHT GASKETED JOINTS, CLASS B STONE BEDDING (UP TO 12 INCHES ABOVE TOP OF PIPE) AND COMPACTED SAND BACKFILL. DEFLECTION OF PVC PIPE AFTER INSTALLATION AND BACKFILL SHALL NOT EXCEED 5.0% OF THE PIPE DIAMETER.
- 3: MANUFACTURED TEES SHALL BE USED AT ALL SERVICE CONNECTIONS.
- 4: NEW SANITARY SERVICES SHALL CONSIST OF PVC SDR26 OR SDR35 PIPE WITH WATER-TIGHT GASKETED JOINTS, STONE BEDDING AND BACKFILLED WITH COMPACTED SAND BACKFILL.
- 5: TERMINATE NEW SANITARY SERVICES WITH A WATER-TIGHT PLUG AND 2" X 2" PRESSURE TREATED HARDWOOD MARKER OR PK NAIL IF IN DRIVEWAY. AS REQUIRED BY SPECIFICATIONS. 6: PROVIDE EARTH RESTRAINT AND TRENCH SUPPORT AS

NEEDED TO PROTECT ADJOINING UTILITIES, STRUCTURES, ASPHALT CURB AND PAVEMENT AND LANDSCAPING FROM


- SETTLEMENT OR DAMAGE DURING CONSTRUCTION. 7: THE CONTRACTOR SHALL PROVIDE ALL NECESSARY SUPPORT TO PRESERVE AND PROTECT UTILITIES CROSSING THE TRENCH DURING CONSTRUCTION. METHODS OF SUPPORT SHALL BE APPROVED BY UTILITY OWNER. THIS WORK SHALL NOT BE PAID FOR SEPARATELY, BUT SHALL BE INCLUDED IN THE ITEM OF
- WORK "SEWER, SDR 35 PVC PIPE, 8-INCH, TR DET I". 8: THE CONTRACTOR SHALL PROVIDE DEWATERING AS NEEDED TO MAINTAIN A DRY, SAFE AND STABLE TRENCH BOTTOM DURING CONSTRUCTION. THIS WORK SHALL NOT BE PAID FOR SEPARATELY, BUT SHALL BE INCLUDED IN THE ITEM OF WORK "SEWER, SDR 35 PVC PIPE, 8-INCH, TR DET I".
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- 11: ALL LEAD INVERT ELEVATIONS ARE CALCULATED BASED ON AN 8"X4" TEE ROTATED 45° VERTICALLY. SEE DETAIL ON THIS

<u>LEGEND</u>

PROPOSED STAGE 1 PAVEMENT REMOVAL LIMITS-18" SECTION OF ASPHALT CURB AND PAVEMENT TO REMAIN IN PLACE AS SHOWN ON THE PLANS. SEE PAVING SHEETS FOR ADDITIONAL REMOVAL DETAILS

	SANITARY LEAD TABLE							
			LENGTH					
		RISER	ТО					
		HEIGHT	ROW	LEAD	INV @			
STA	ADDRESS	(FT)	(FT)	SLOPE	ROW	DIRECTION	SIZE	MATERIAL
8+40	640 RIVERVIEW	0.0	23.5	2.5%	840.43	West	4"	PVC SDR 35
6+48	614 RIVERVIEW	0.0	27.8	2.5%	829.57	West	4"	PVC SDR 35
6+01.5	615 RIVERVIEW	2.1	10.5	2.5%	828.46	East	4"	PVC SDR 35

			SANI	TARY SEWER	STRUCTURE TABLE
STRUCTURE	STATION	RIM	DIA.	INVERTS	APPLICATION/CONSTRUCTION/DETAIL
S-7	6+68.02	839.52	48"	8" S 834.52 8" S 829.55 8" NE 829.35	SANITARY MANHOLE; SD-S-1; EJIW 1040 TYPE Q COVER
S-8	8+39.79	843.66	48"	8" N 839.50	SANITARY MANHOLE; SD-S-1; EJIW 1040 TYPE Q COVER

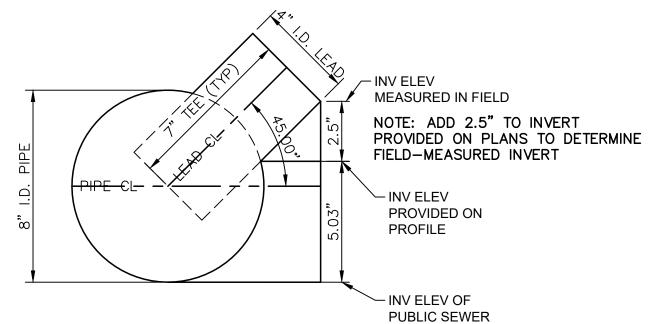

8" X 4"SANITARY LEAD TEE DETAIL

NTS

820

+25

+50

60	09 FINAL PLANS - CITY OF ANN ARBOR	11/7/2018	MF	NCM
90	08 FINAL REVIEW TO CITY OF ANN ARBOR	10/30/2018	ЫF	MOV
07	07 SANITARY AND WATER MAIN PERMIT (REV)	10/9/2018	MF	NON
90	06 FINAL PLANS - CITY OF ANN ARBOR	2/28/2018	MF	NCM
05	05 FINAL REVIEW TO CITY OF ANN ARBOR	2/23/2018	MF	MOV
REV.	DESCRIPTION	DATE	DRAWN CHECKE	CHECKE




/ SEWER | PROJEC +00 TO STA - ENGINEERING

RIVERVIEW DRIVE SANITARY AND WATER MAIN EXTENSION ROPOSED SANITARY PLAN & PROFILE STA 6+ SERVICES

ARBOR

OF CITY

SHEET No.

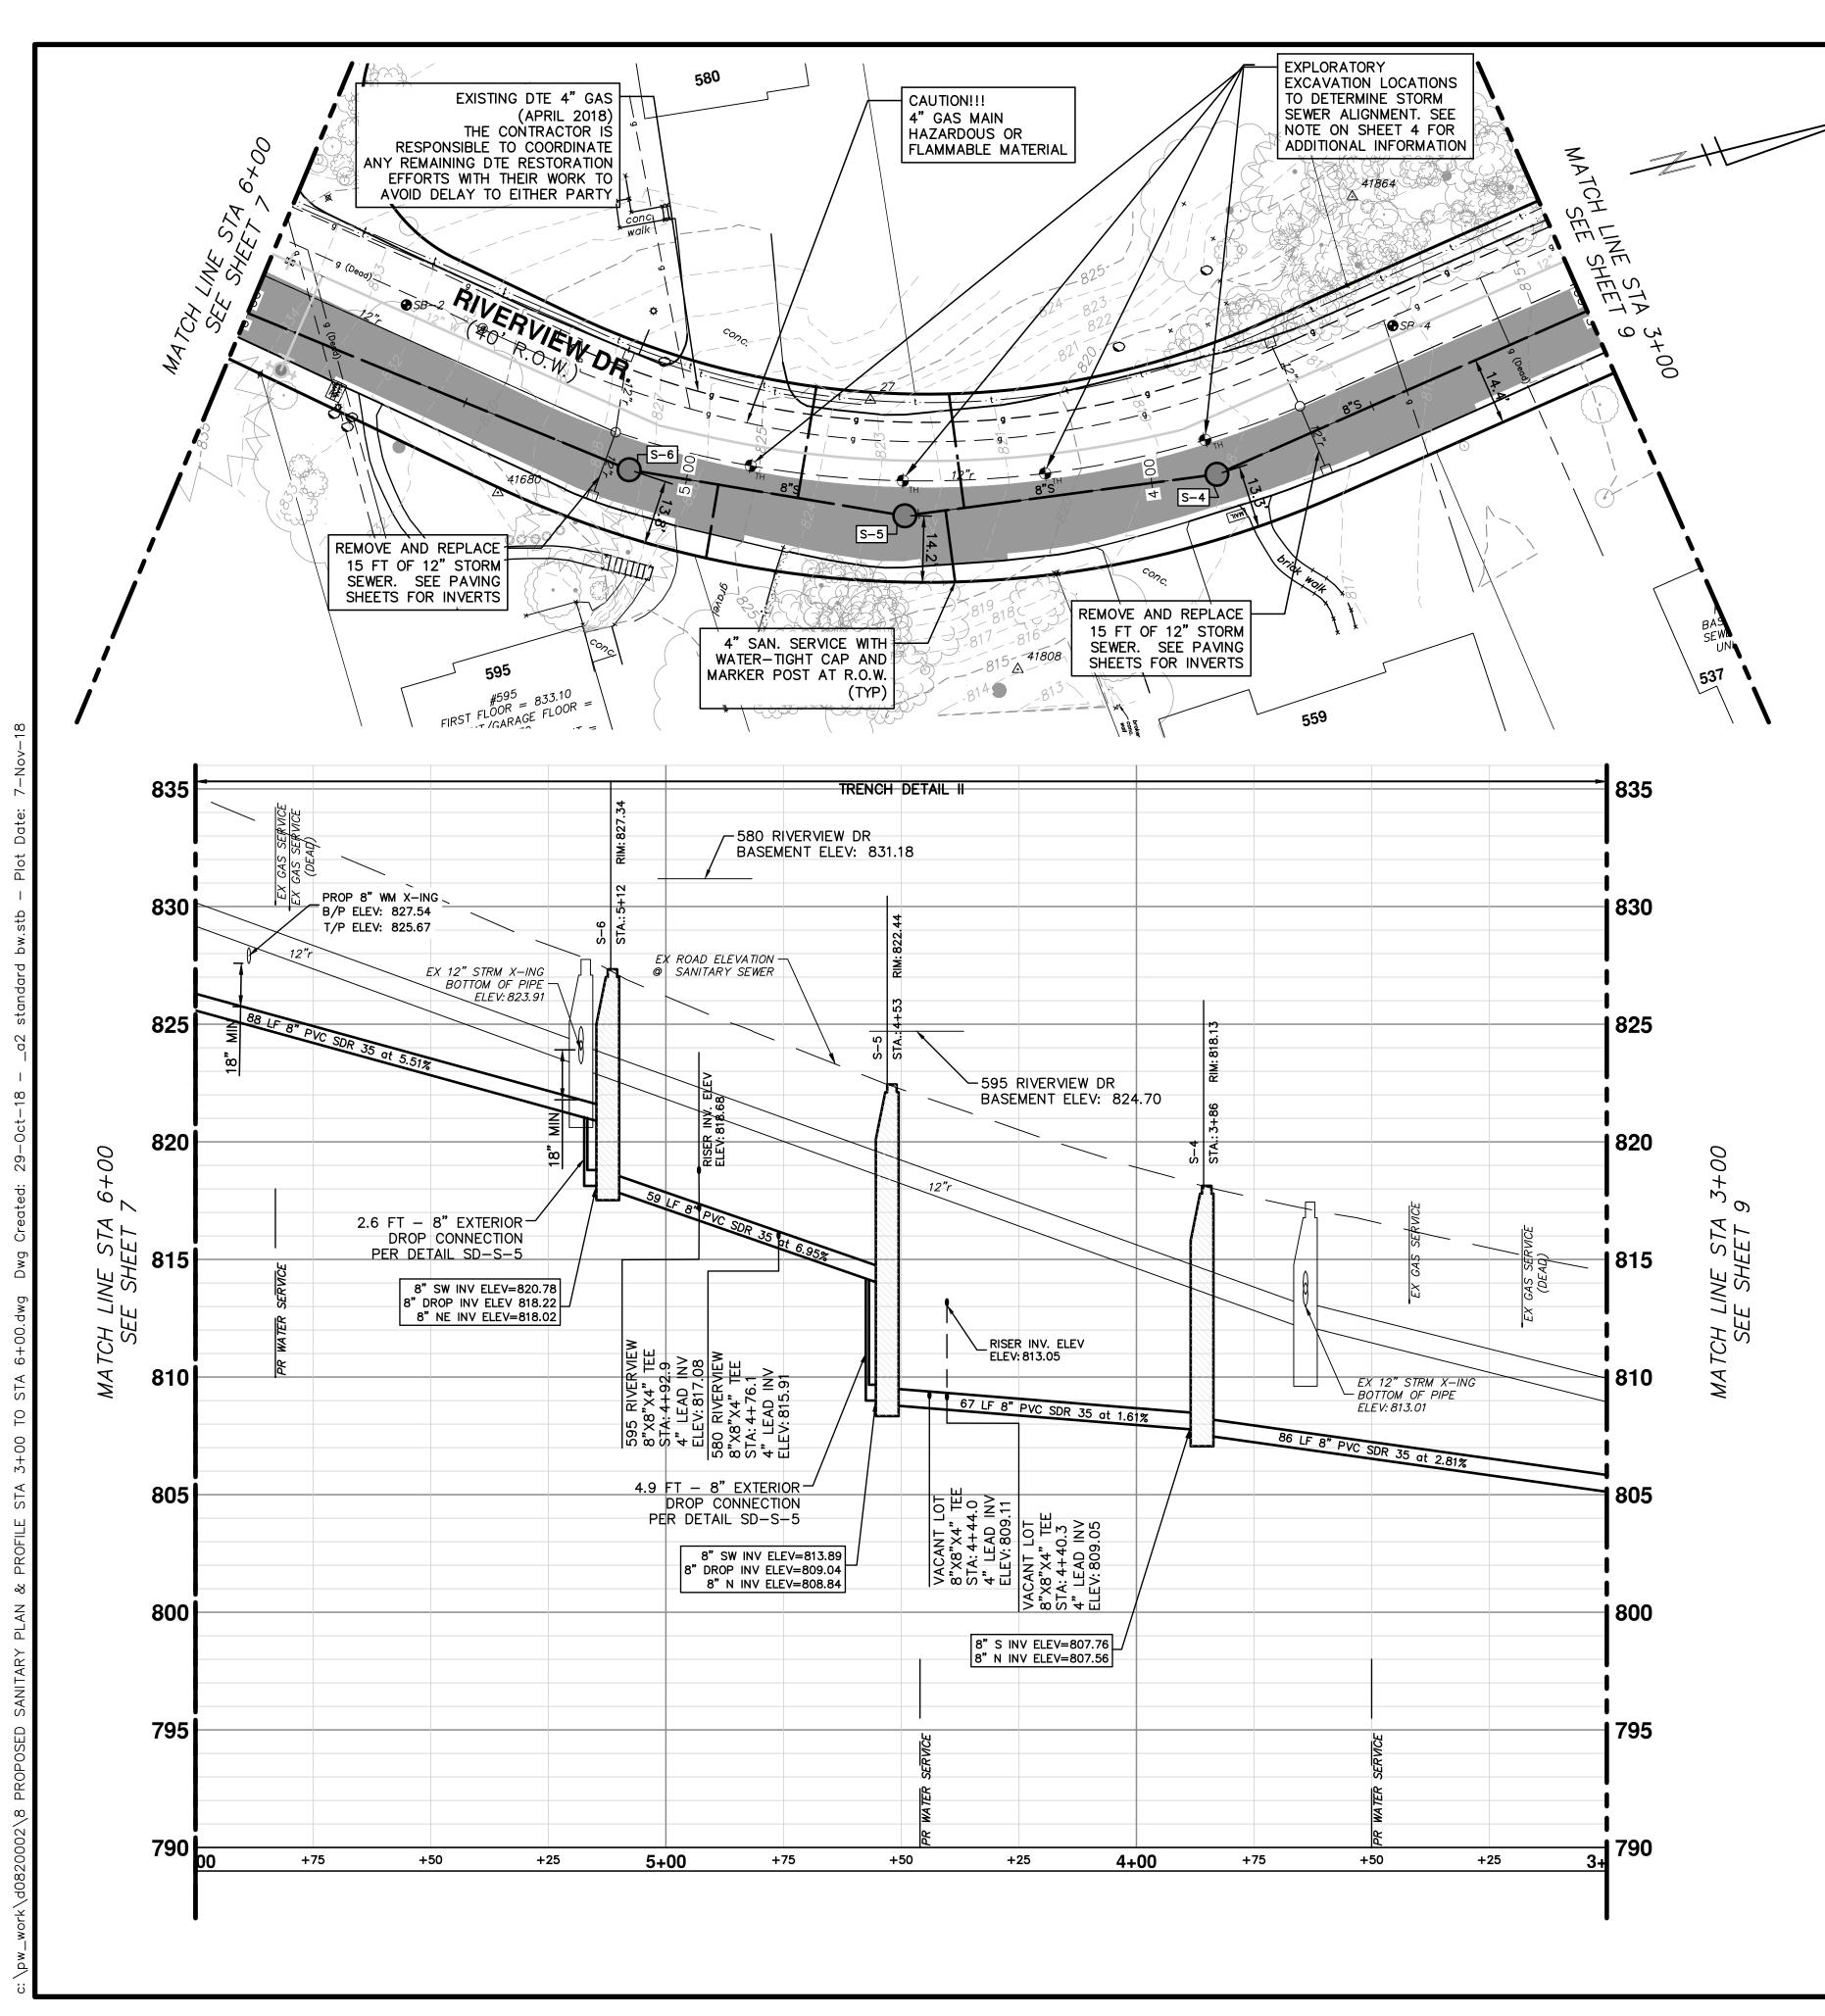

SANITARY SEWER NOTES

NOTE: A PROVISIONAL QUANTITY OF 200 LINEAL

DEPTH, REM" AND "SEWER, CL C76 IV, 12 INCH, TR

FEET HAS BEEN ADDED TO THE PAY ITEMS

DET I, MODIFIED" TO ACCOUNT FOR POTENTIAL

INSTALLATION OF THE PROPOSED UTILITIES WITH

NOTE: A PROVISIONAL QUANTITY OF 400 LINEAL

SIZE, REM" AND "CURB SLOPED, HMA, SPECIAL" TO

BE USED IN THE EVENT THAT THE EXISTING CURB

NOT IDENTIFIED FOR REMOVAL IN THE PLANS IS

EXPEDITE THE CONTRACTOR'S OPERATION OR TO

QUANTITY WILL BE AT THE SOLE DIRECTION OF THE

REQUIREMENTS. THE USE OF THIS PROVISIONAL

DAMAGED BY UNAVOIDABLE CIRCUMSTANCES

ENCOUNTERED DURING CONSTRUCTION. THIS

DIMINISH TRENCH WIDTH AND OR SAFETY

PROVISIONAL QUANTITY IS NOT INTENDED TO

THE EXISTING STORM SEWER SYSTEM. THE USE OF

THIS PROVISIONAL QUANTITY WILL BE AT THE SOLE

CONFLICTS THAT MAY ARISE DURING THE

FEET HAS BEEN ADDED TO THE PAY

"SEWER, ANY SIZE OR

DIRECTION OF THE ENGINEER.

ITEMS " CURB, ANY TYPE OR

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LEGEND

PROPOSED STAGE 1 PAVEMENT REMOVAL LIMITS-18" SECTION OF ASPHALT CURB AND PAVEMENT TO REMAIN IN PLACE AS SHOWN ON THE PLANS. SEE PAVING SHEETS FOR ADDITIONAL REMOVAL DETAILS


		S	ANITAR	Y LEAI	TABL	E		
			LENGTH					
		RISER	TO					
		HEIGHT	ROW	LEAD	INV @			
STA	ADDRESS	(FT)	(FT)	SLOPE	ROW	DIRECTION	SIZE	MATERIAL
4+93	595 RIVERVIEW	1.6	15.8	2.5%	819.07	East	4"	PVC SDR 35
4+76	580 RIVERVIEW	0.0	24.0	2.5%	816.72	West	4"	PVC SDR 35
4+44	595 VACANT LOT	0.0	15.4	2.5%	809.70	East	4"	PVC SDR 35
4+40	580 VACANT LOT	4.0	24.5	2.5%	813.66	West	4"	PVC SDR 35

			SANI	TARY SEWER	STRUCTURE TABLE
STRUCTURE	STATION	RIM	DIA.	INVERTS	APPLICATION/CONSTRUCTION/DETAIL
S-4	3+86.04	818.13	48"	8" S 807.76 8" N 807.56	SANITARY MANHOLE; SD-S-1; EJIW 1040 TYPE Q COVER
S-5	4+52.96	822.44	48"	8" SW 813.89 8" N 809.04 8" N 809.84	SANITARY MANHOLE; SD-S-1; EJIW 1040 TYPE Q COVER
S-6	5+12.36	827.34	48"	8" SW 820.78 8" SW 818.22 8" NE 818.02	SANITARY MANHOLE; SD-S-1; EJIW 1040 TYPE Q COVER



- CITY OF ANN ARBOR	11/7/2018	ЫF	NCM
TO CITY OF ANN ARBOR	10/30/2018	MF	NCM
D WATER MAIN PERMIT (REV)	10/9/2018	JМ	NCM
- CITY OF ANN ARBOR	2/28/2018	JW	NCM
TO CITY OF ANN ARBOR	2/23/2018	JМ	NCM
DESCRIPTION	DATE	DRAWN	CHECKEI

OF ANN ARBOR	08	FINA
AST HURON STREET	07	SAN
P.O. BOX 8647 RBOR, MI 48107-8647	90	FINA
734-794-6410 www.a2gov.org	05	FINA
	RFV	

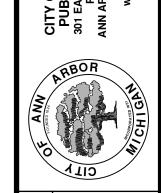


RIVERVIEW DRIVE SANITARY SEWER AND WATER MAIN EXTENSION PROJECTOPOSED SANITARY PLAN & PROFILE STA 3+00 TO STA

- PUBLIC SERVICES - ENGINEERING

ANN ARBOR -CITY OF

SHEET No.

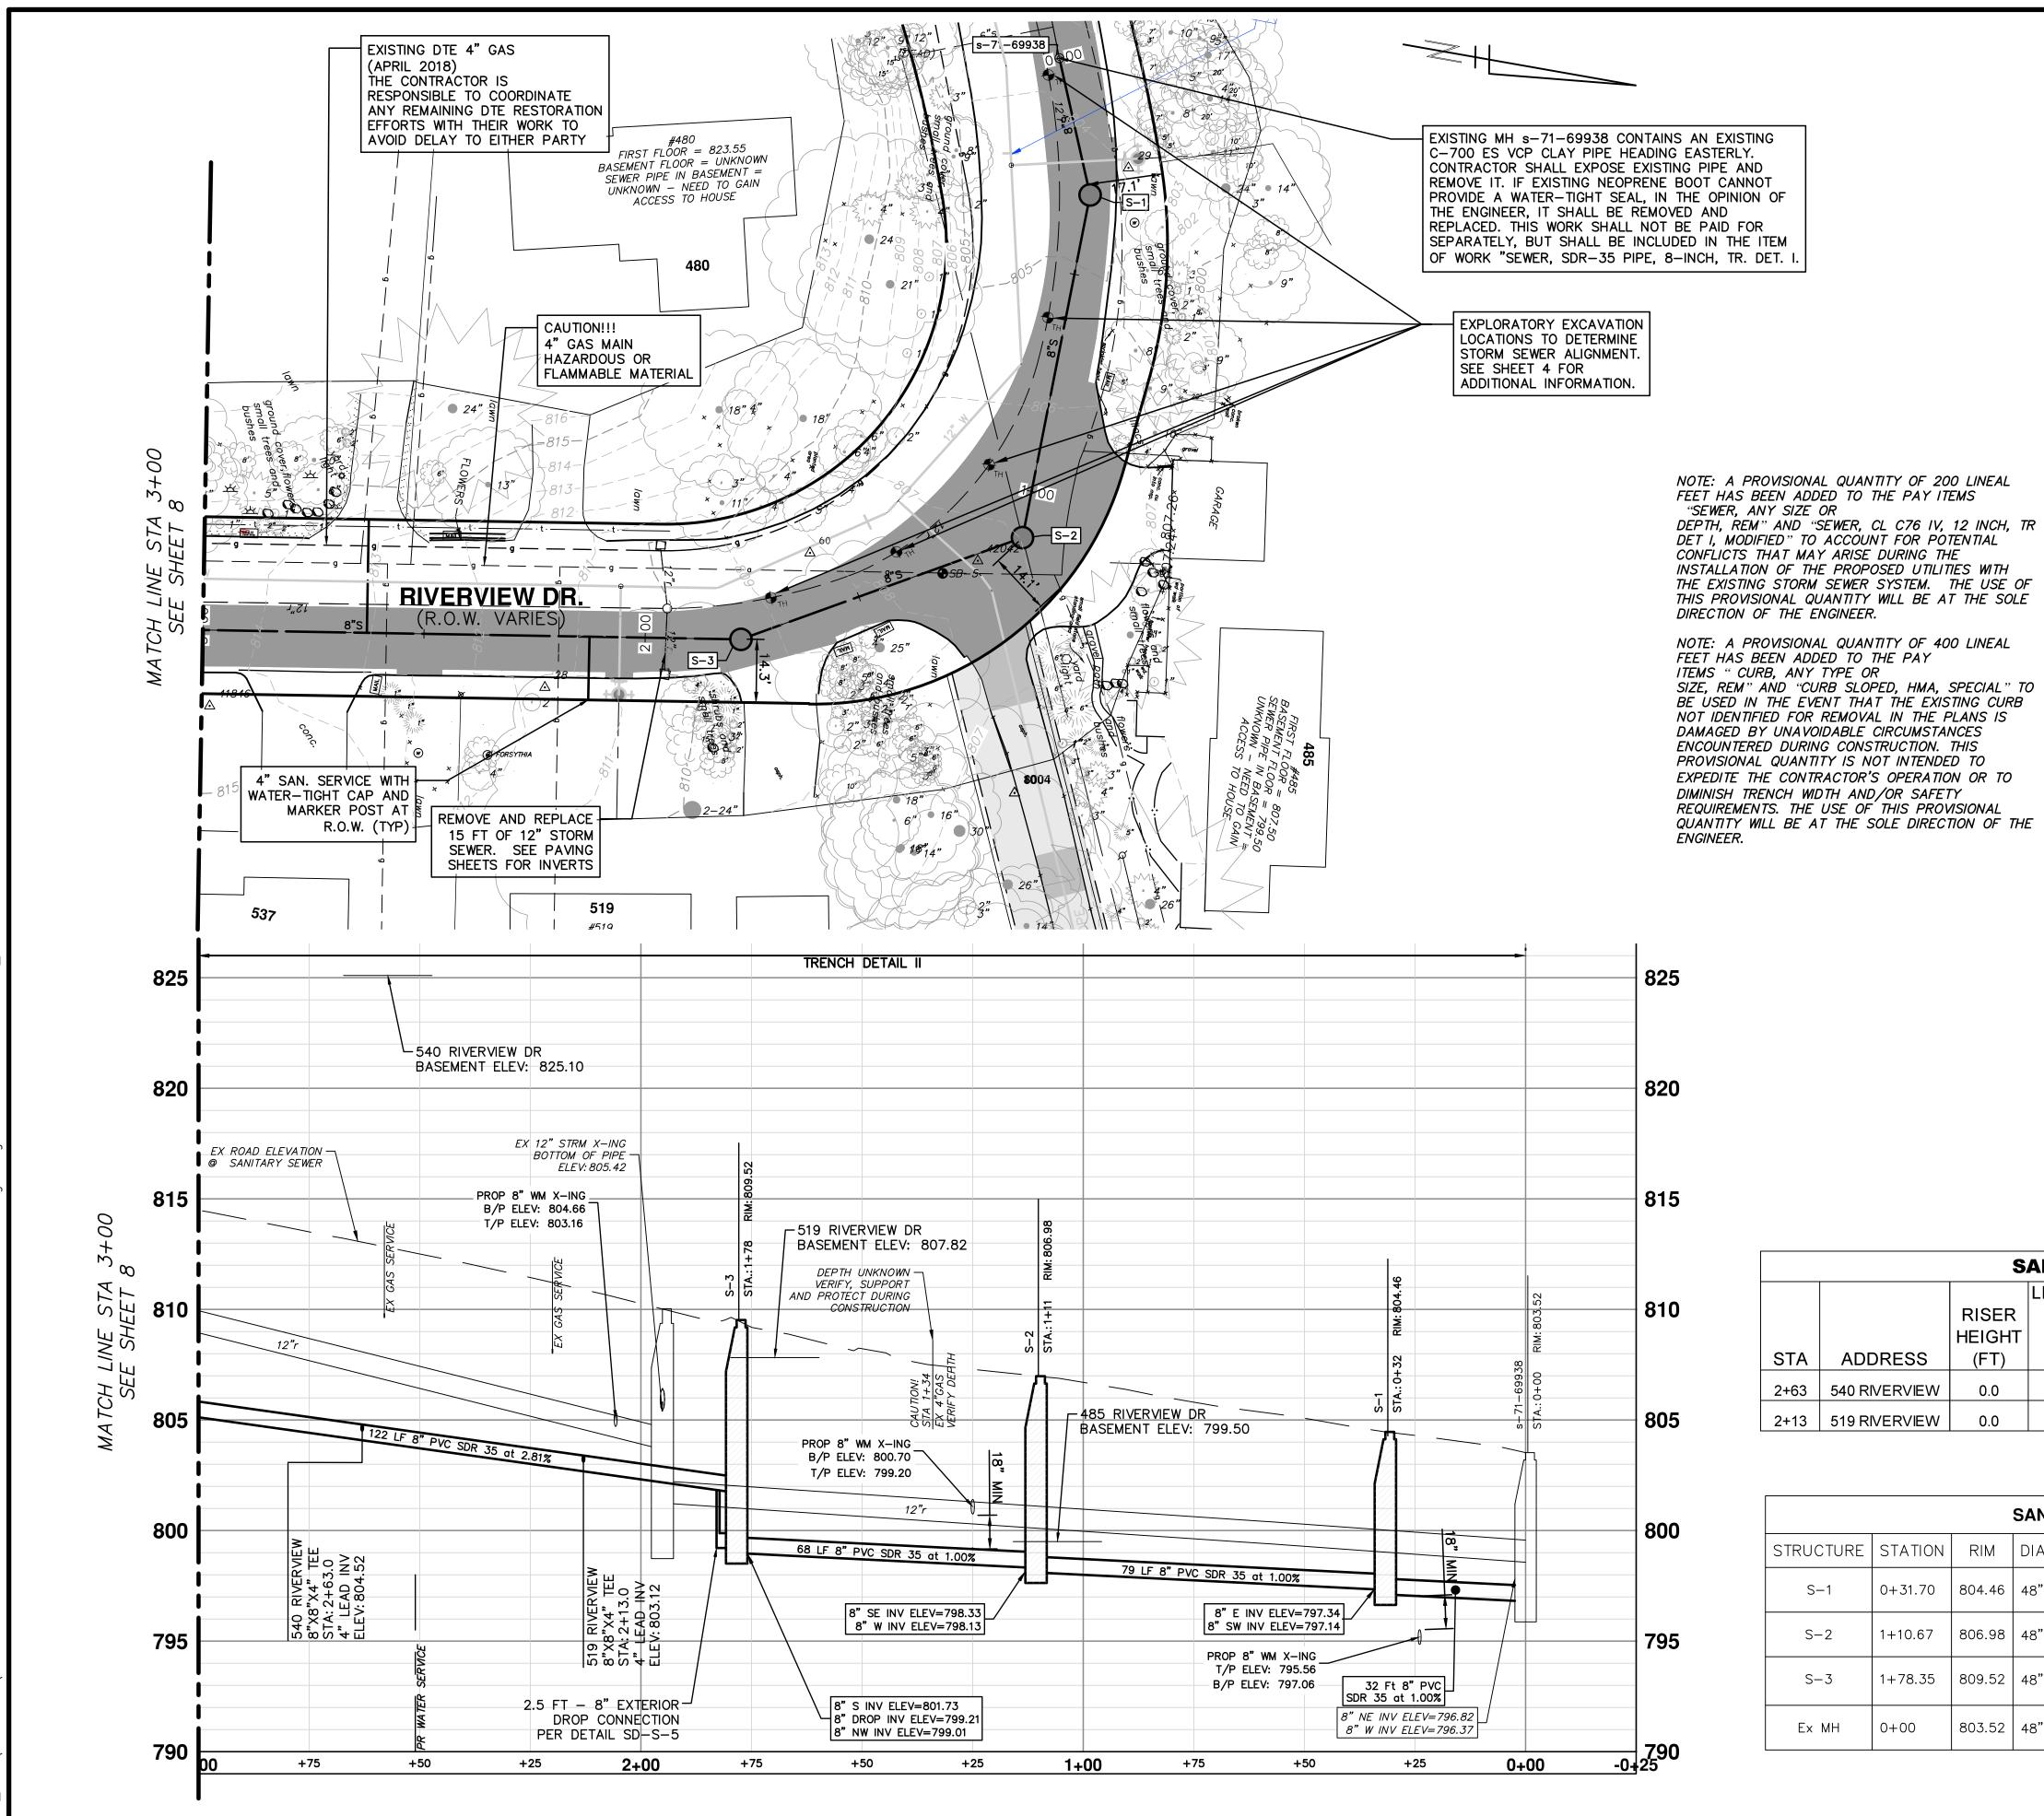

SANITARY SEWER NOTES

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ASPHALT CURB AND PAVEMENT AND LANDSCAPING FROM

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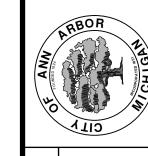
<u>LEGEND</u>

PROPOSED STAGE 1 PAVEMENT REMOVAL LIMITS-18" SECTION OF ASPHALT CURB AND PAVEMENT TO REMAIN IN PLACE AS SHOWN ON THE PLANS. SEE PAVING SHEETS FOR ADDITIONAL REMOVAL DETAILS

		S	ANITAR	Y LEAI	D TABL	E		
			LENGTH					
		RISER	TO					
		HEIGHT	ROW	LEAD	INV @			
STA	ADDRESS	(FT)	(FT)	SLOPE	ROW	DIRECTION	SIZE	MATERIAL
2+63	540 RIVERVIEW	0.0	25.7	2.5%	805.37	West	4"	PVC SDR 35
2+13	519 RIVERVIEW	0.0	14.3	2.5%	803.48	East	4"	PVC SDR 35

			SANI	TARY SEWER	STRUCTURE TABLE
STRUCTURE	STATION	RIM	DIA.	INVERTS	APPLICATION/CONSTRUCTION/DETAIL
S-1	0+31.70	804.46	48"	8" E 797.34 8" SW 797.14	SANITARY MANHOLE; SD-S-1; EJIW 1040 TYPE Q COVER
S-2	1+10.67	806.98	48"	8" SE 798.33 8" W 798.13	SANITARY MANHOLE; SD-S-1; EJIW 1040 TYPE Q COVER
S-3	1+78.35	809.52	48"	8" S 801.73 8" S 799.21 8" NW 799.01	SANITARY MANHOLE; SD-S-1; EJIW 1040 TYPE Q COVER
Ex MH	0+00	803.52	48"	8" NE 796.82 8" W 796.37(EX)	EXISTING SANITARY MANHOLE

			l
- CITY OF ANN ARBOR	11/7/2018	MF	NCM VCM
TO CITY OF ANN ARBOR	10/30/2018	JW	NCM
) WATER MAIN PERMIT (REV)	10/9/2018	JМ	NCM
- CITY OF ANN ARBOR	2/28/2018	JW	VCM
TO CITY OF ANN ARBOR	2/23/2018	JМ	VCM
DESCRIPTION	DATE	DRAWN	CHECKE




RIVERVIEW DRIVE SANITARY SEWER AND WATER MAIN EXTENSION PROJECTOPOSED SANITARY PLAN & PROFILE STA 0+00 TO STA - ENGINEERING

- PUBLIC SERVICES

ANN ARBOR OF CITY

SHEET No.

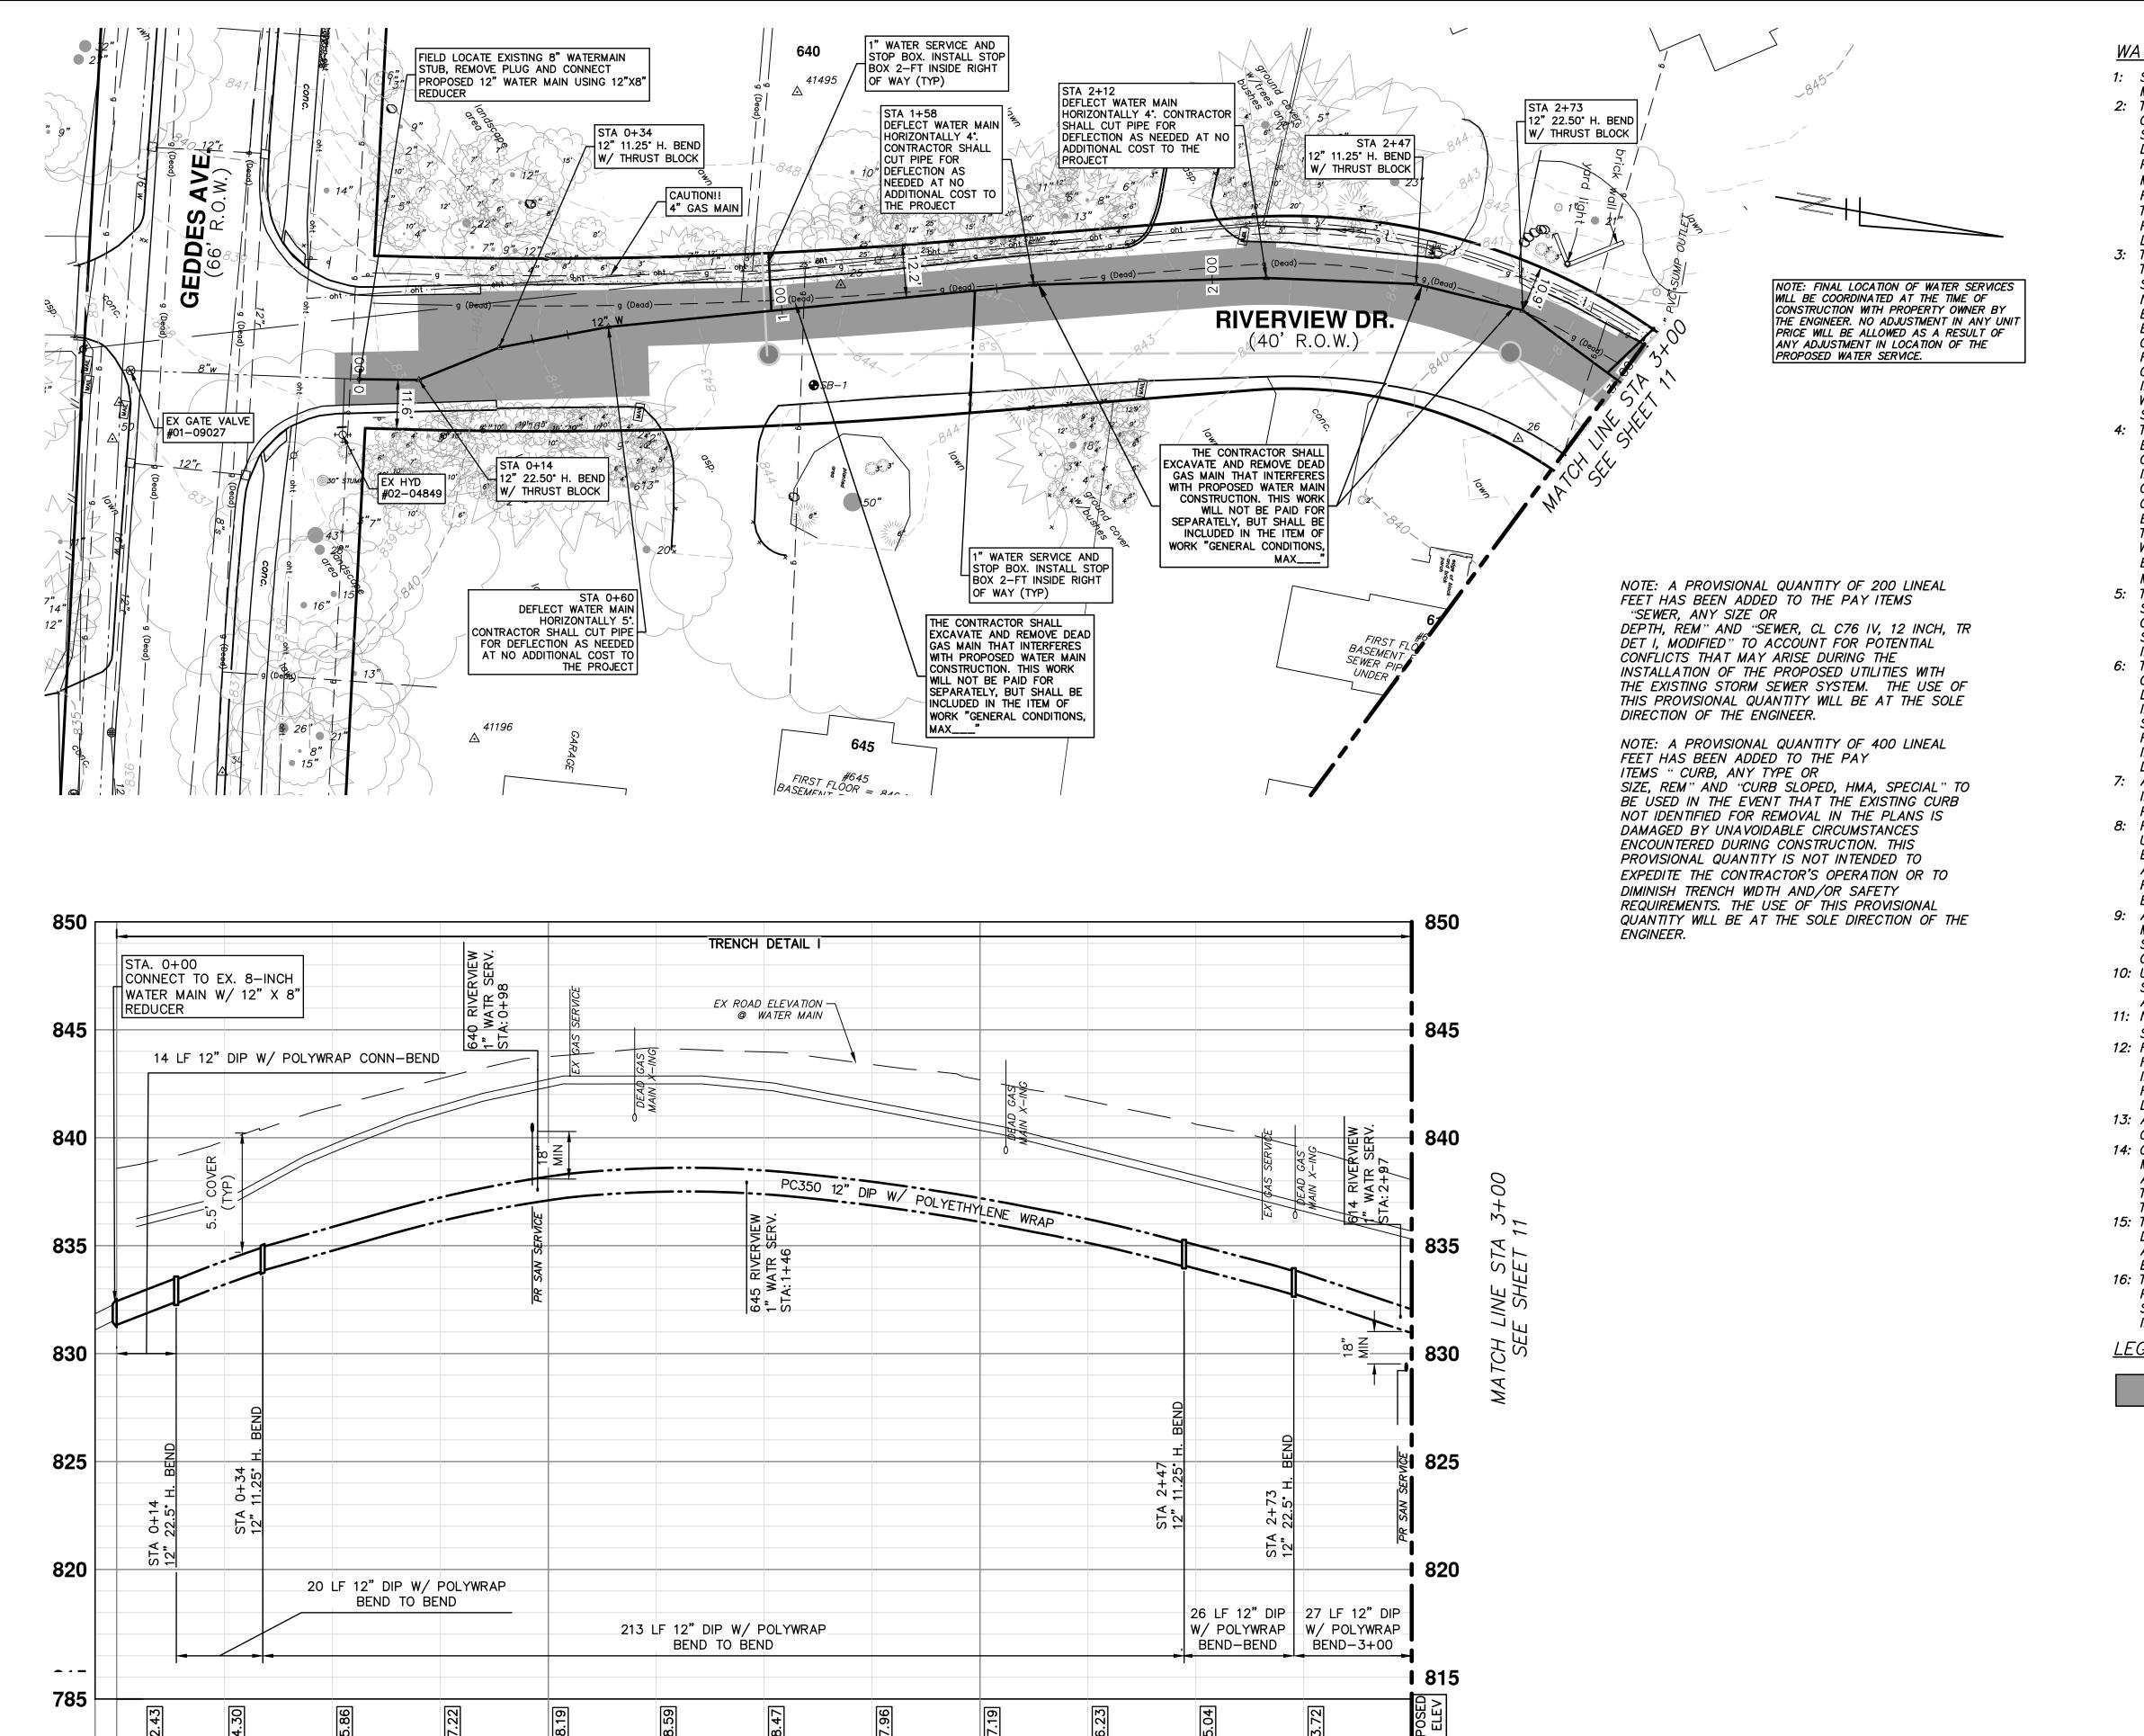

+25

+75

3+

+50

-0+05 0+00

+25

+75

+50

1+00

+25

+50

+75

2+00

WATER MAIN CONSTRUCTION NOTES

1: SEE EROSION CONTROL SHEETS FOR DETAILS ON PLACEMENT, MAINTENANCE, AND REMOVAL OF EROSION CONTROL ITEMS.

2: THE CONTRACTOR SHALL CAREFULLY PROTECT FROM DAMAGE OR INJURY DURING CONSTRUCTION OPERATIONS ALL UTILITIES, SITE FEATURES, LANDSCAPING, AND OTHER ITEMS NOT DESIGNATED FOR REMOVAL OR ABANDONMENT. PAYMENT FOR PROTECTION OF UTILITIES INCLUDED IN "GENERAL CONDITIONS, MAX____". EXISTING FACILITIES NOT DESIGNATED FOR REMOVAL OR ABANDONMENT, BUT WHICH ARE DAMAGED BY THE CONTRACTOR'S OPERATION SHALL BE REPAIRED OR REPLACED BY THE CONTRACTOR AT HIS SOLE EXPENSE, AS DETERMINED BY THE ENGINEER.

3: THE EXISTING UTILITIES SHOWN ON THESE PLANS REPRESENT THE BEST INFORMATION AVAILABLE AS OBTAINED THROUGH SURVEYS AND/OR EXISTING PLANS. THIS INFORMATION DOES NOT RELIEVE THE CONTRACTOR OF THE RESPONSIBILITY TO BE SATISFIED AS TO ITS ACCURACY AND THE LOCATION OF EXISTING UTILITIES. IF STORM, SANITARY, OR WATERMAINS CROSS OTHER UTILITIES, CONTACT THEIR RESPECTIVE OWNERS FOR INFORMATION ON HOW TO PROCEED. PAYMENT FOR THE COORDINATION EFFORTS AND ASSOCIATED ITEMS SHALL BE INCLUDED IN ASSOCIATED PROPOSED STORM, SANITARY, OR WATERMAIN ITEMS AND SHALL NOT BE PAID FOR SEPARATELY.

4: THE EXISTING 8" WATER MAIN FROM GEDDES MAY BE
EXPOSED DURING CONSTRUCTION IN THE VICINITY SHOWN. THE
CONTRACTOR SHALL CAREFULLY PROTECT FROM DAMAGE OR
INJURY THE EXISTING WATER MAIN DURING CONSTRUCTION
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CONTRACTOR'S OPERATION SHALL BE REPAIRED OR REPLACED
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WATER MAIN WILL NOT BE PAID FOR SEPARATELY, BUT SHALL
BE INCLUDED IN THE ITEM OF WORK "GENERAL CONDITIONS,"

5: THE CONTRACTOR SHALL NOT REMOVE OR DAMAGE EXISTING SANITARY SEWER OR WATER MAIN LEADS FOR EASE OF CONSTRUCTING OTHER ASPECTS OF WORK. THE CONTRACTOR SHALL CAREFULLY PROTECT ALL LEADS FROM DAMAGE OR

6: THE CONSTRUCTION COVERED BY THESE PLANS SHALL CONFORM TO THE CITY OF ANN ARBOR PUBLIC SERVICES DEPARTMENT STANDARD SPECIFICATIONS WHICH ARE INCLUDED BY REFERENCE. THE OMISSION OF ANY CURRENT STANDARD DETAIL DOES NOT RELIEVE THE CONTRACTOR FROM THE REQUIREMENT. THE WORK SHALL BE PERFORMED IN COMPLETE CONFORMANCE WITH CURRENT PUBLIC SERVICE DEPARTMENT STANDARD SPECIFICATIONS AND DETAILS.

7: ALL WATER MAIN SHALL BE PRESSURE CLASS 350 DUCTILE IRON WATER MAIN, CEMENT—LINED (DOUBLE THICKNESS), WITH POLYWRAP UNLESS NOTED OTHERWISE.

8: RESTRAINED JOINT SYSTEMS FOR WATER MAIN SHALL BE UTILIZED WHERE INDICATED ON THE PLANS OR AS DIRECTED BY THE ENGINEER. RESTRAINED JOINT GASKET SYSTEMS ARE TO BE USED. (FIELD—LOK 350 BY U.S. PIPE, FAST—GRIP BY AMERICAN DUCTILE IRON PIPE, OR APPROVED EQUAL)

9: ALL WATER MAIN TO HAVE 5.5 FEET OF COVER. MAINTAIN A MINIMUM OF 18-INCH VERTICAL CLEARANCE FOR STORM AND SANITARY CROSSINGS AND A MINIMUM OF 12-INCH VERTICAL CLEARANCE WITH ALL OTHER UTILITIES.

10: UNLESS OTHERWISE NOTED, THE CONTRACTOR SHALL UTILIZE STANDARD PIPE DEFLECTIONS FOR FOLLOWING THE PROPOSED ALIGNMENT.

11: NEW FIRE HYDRANTS SHALL BE EJIW 5BR-250 WITH 4-INCH STORZ QUICK CONNEC AND 2-23 HYDRANT OUTLETS .

12: FIRE HYDRANT ASSEMBLIES SHALL INCLUDE ALL NECESSARY HYDRANT EXTENSIONS, THRUST BLOCKS, PIPE AND FITTINGS, INCLUDING ADJUSTMENT OF THE COMPANION VALVE. FIRE HYDRANT ASSEMBLY INCLUDES 6—INCH COMPANION VALVE LOCATED THREE FEET FROM THE HYDRANT.

13: ALL WATER MAIN TRENCH BACKFILL SHALL BE MDOT CLASS II GRANULAR MATERIAL (SEE UTILITY TRENCH TYPE I DETAIL).

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15: THE CONTRACTOR SHALL PERFORM ALL WATER SYSTEM SHUT DOWNS AFTER APPROPRIATE NOTIFICATION TO THOSE AFFECTED AND APPROVAL HAS BEEN GRANTED BY THE ENGINEER.

16: THE DRILLING MACHINE IS TO BE PLACED AT THE EAST BORE PIT AND PULL PIPE FROM THE WEST BORE PIT. PIPE TO BE STAGED ALONG RIVERVIEW DRIVE WITHOUT UNDULY INTERFERING WITH TRAFFIC.

<u>LEGEND</u>

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PROPOSED STAGE 2 PAVEMENT REMOVAL
LIMITS-18" SECTION OF ASPHALT CURB AND
PAVEMENT TO REMAIN IN PLACE AS SHOWN ON
THE PLANS. SEE PAVING SHEETS FOR ADDITIONAL
REMOVAL DETAILS

ow what's below.

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TO CITY OF ANN ARBOR	10/30/2018	МF	MOV
D WATER MAIN PERMIT (REV)	10/9/2018	MF	NCM
- CITY OF ANN ARBOR	2/28/2018	MF	NCM
TO CITY OF ANN ARBOR	2/23/2018	MF	MOV
DESCRIPTION	DATE	DRAWN	CHECKE

CITY OF ANN ARBOR PUBLIC SERVICES 301 EAST HURON STREET P.O. BOX 8647 ANN ARBOR, MI 48107-8647 734-794-6410 www.a2gov.org




IC SERVICES - ENGINEERING
RIVERVIEW DRIVE SANITARY SEWER
AND WATER MAIN EXTENSION PROJECTORSED WATER MAIN PROFILE STA 0+00 TO ST.

ARBOR - PUBLIC SERVIC
PROFILE: 1" = 4"
RIVERVIE
AND WATE

CALE PLAN: 1" = 20' PROFILE: 1" = 4'

RAWING NO.

SHEET No.

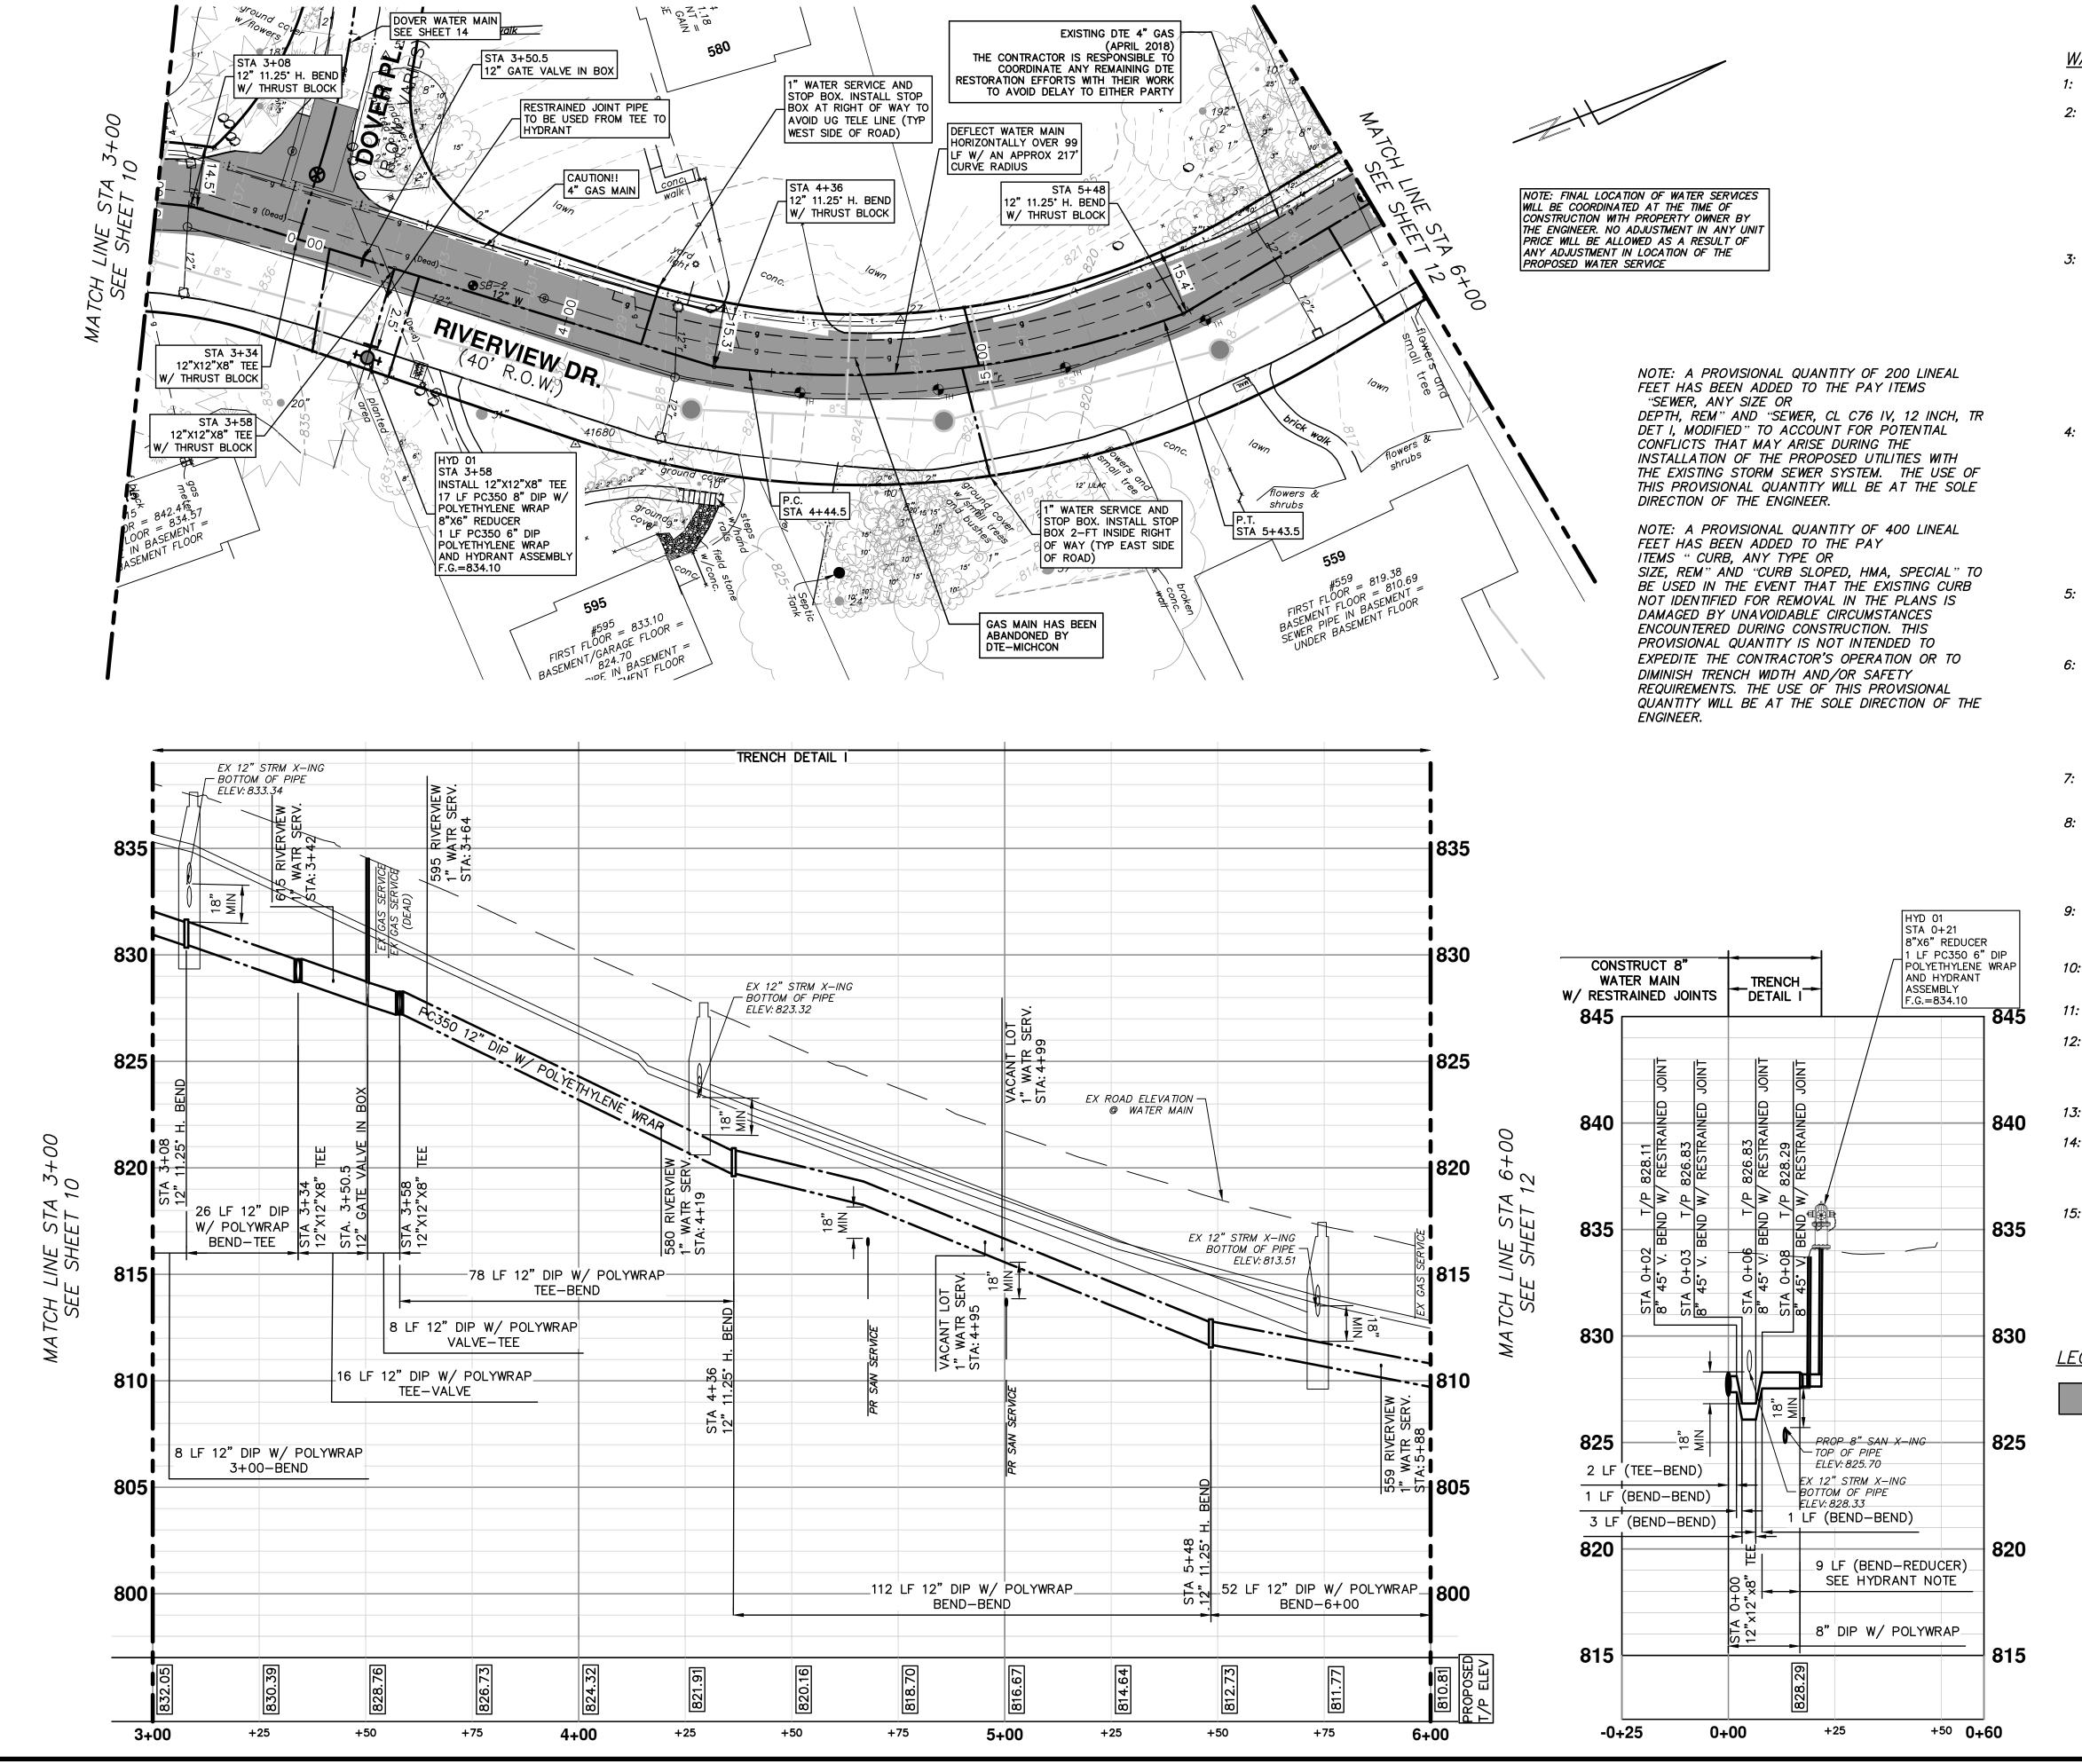

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MF	ЫF	JМ	JМ	DRAWN
10/30/2018	10/9/2018	2/28/2018	2/23/2018	DATE
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 80	FINAL REVIEW TO CITY OF ANN ARBOR	10/30/2018	_
 07	O7 SANITARY AND WATER MAIN PERMIT (REV)	10/9/2018	1
 90	FINAL PLANS — CITY OF ANN ARBOR	2/28/2018	4
 90	FINAL REVIEW TO CITY OF ANN ARBOR	2/23/2018	1
REV.	DESCRIPTION	DATE	DR




PROJEC 3+00 TO STA RIVERVIEW DRIVE SANITARY AND WATER MAIN EXTENSION PROSED WATER MAIN PLAN & PROFILE STA - ENGINEERING SERVICES

PUBLIC 8 ARBOR

OF CITY

SHEET No.

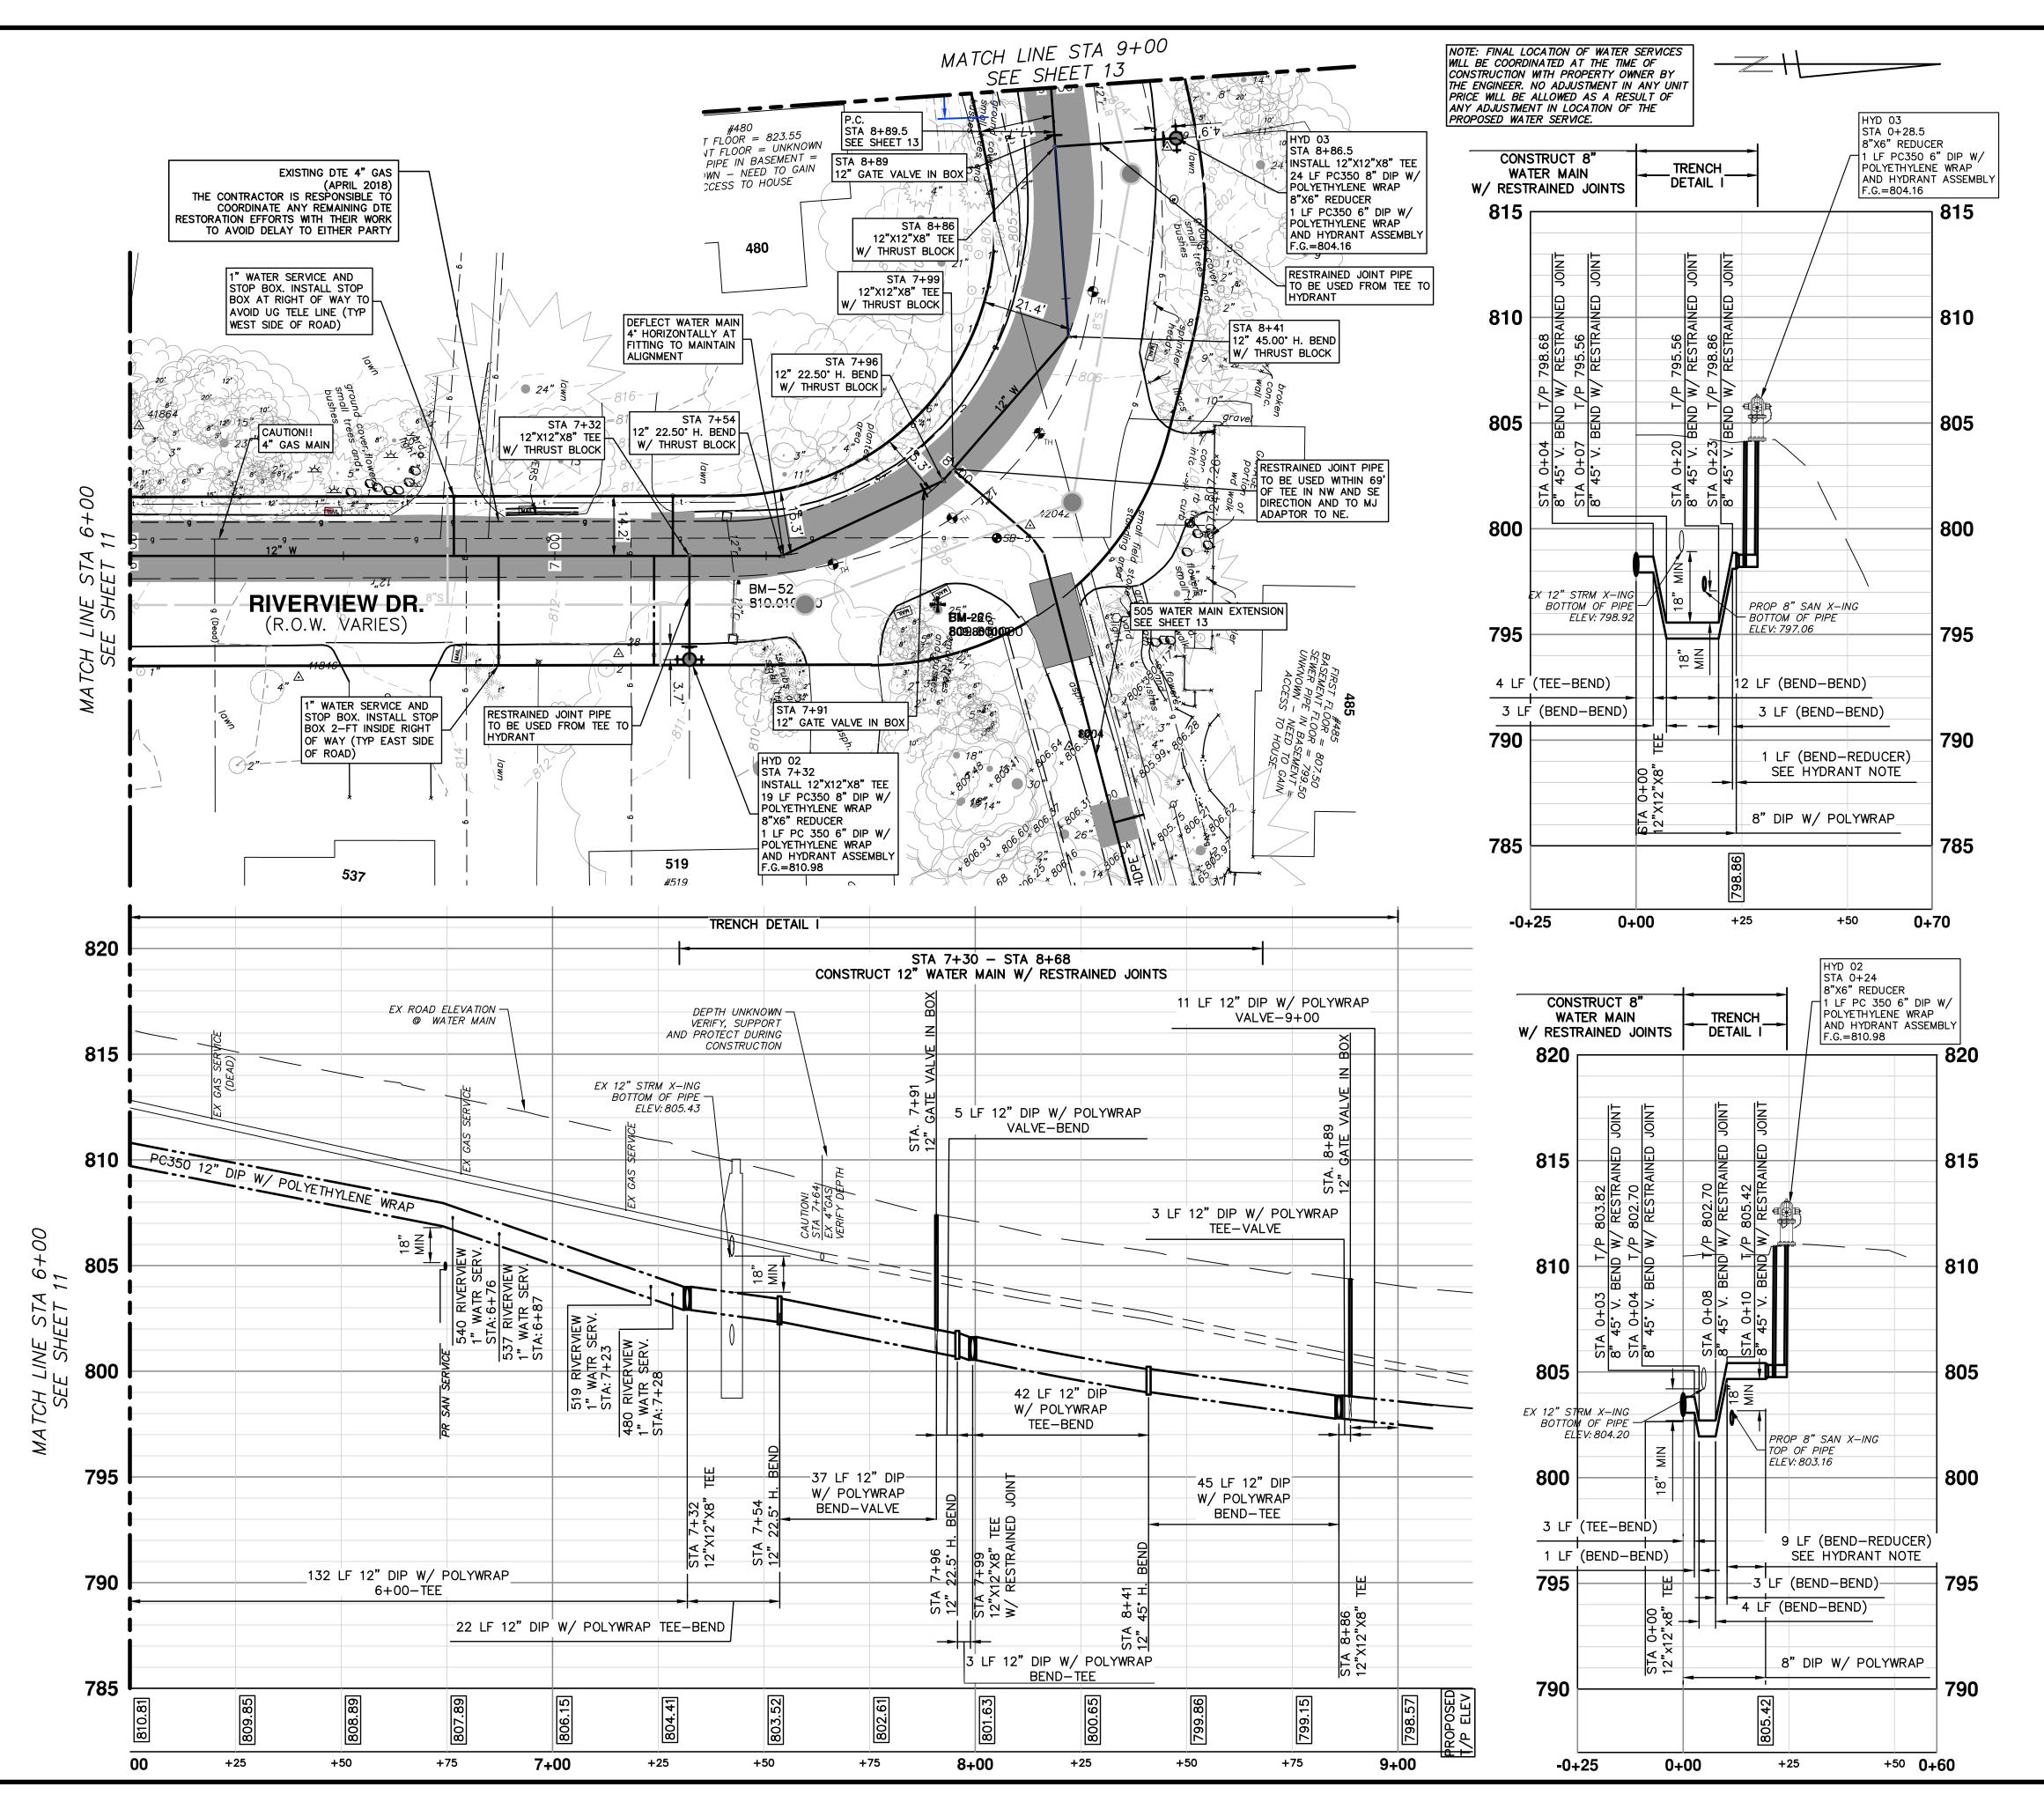

WATER MAIN CONSTRUCTION NOTES

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Know what's below.

FINAL PLANS - CITY OF ANN ARBOR	11///2018	ΜF	NCM NCM
FINAL REVIEW TO CITY OF ANN ARBOR	10/30/2018	MF	NCM
SANITARY AND WATER MAIN PERMIT (REV)	10/9/2018	MF	NCM
FINAL PLANS - CITY OF ANN ARBOR	2/28/2018	MF	NCM
FINAL REVIEW TO CITY OF ANN ARBOR	2/23/2018	MF	NCM
DESCRIPTION	DATE	DRAWN	DRAWN CHECKED

CITY OF ANN ARBOR
PUBLIC SERVICES
301 EAST HURON STREET
P.O. BOX 8647
ANN ARBOR, MI 48107-8647
734-794-6410
www.a2gov.org

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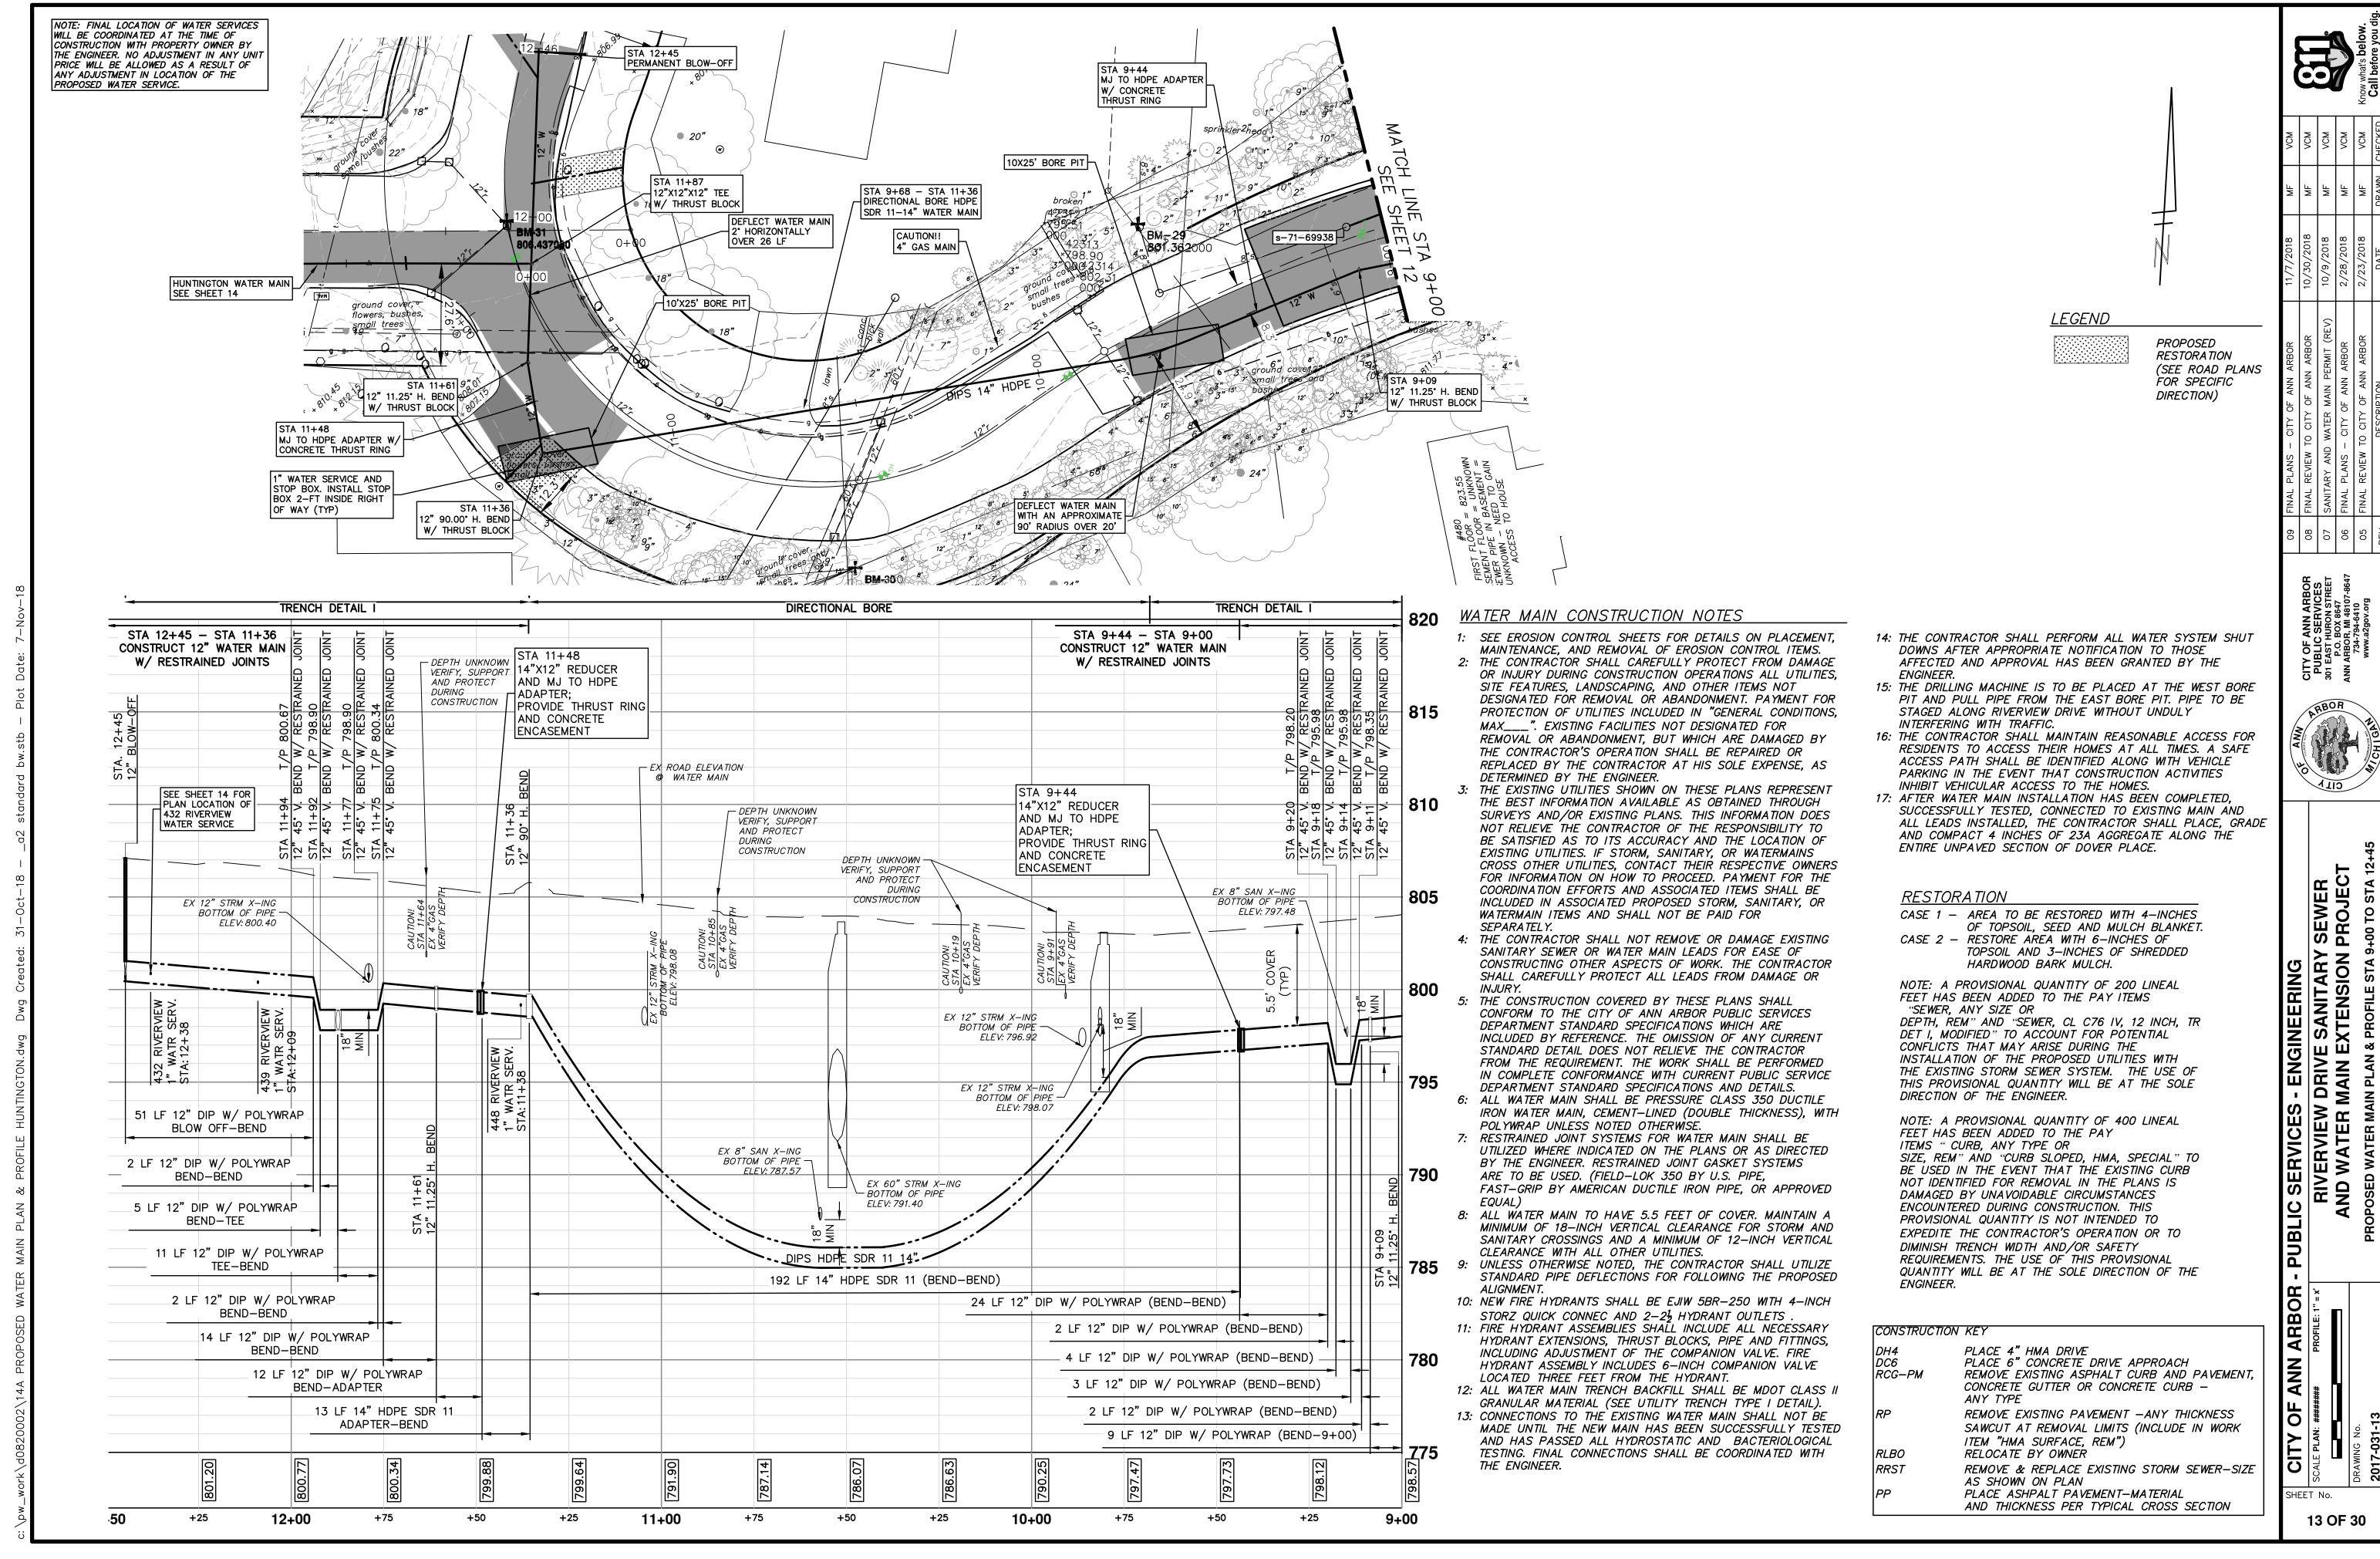


IC SERVICES - ENGINEERING
RIVERVIEW DRIVE SANITARY SEWER
AND WATER MAIN EXTENSION PROJEC
PPOSED WATER MAIN PLAN & PROFILE STA 6+00 TO STA


CALE PLAN: 1" = 20' PROFILE: 1" = 4' RAWING No.


SHEET No.

12 OF 30





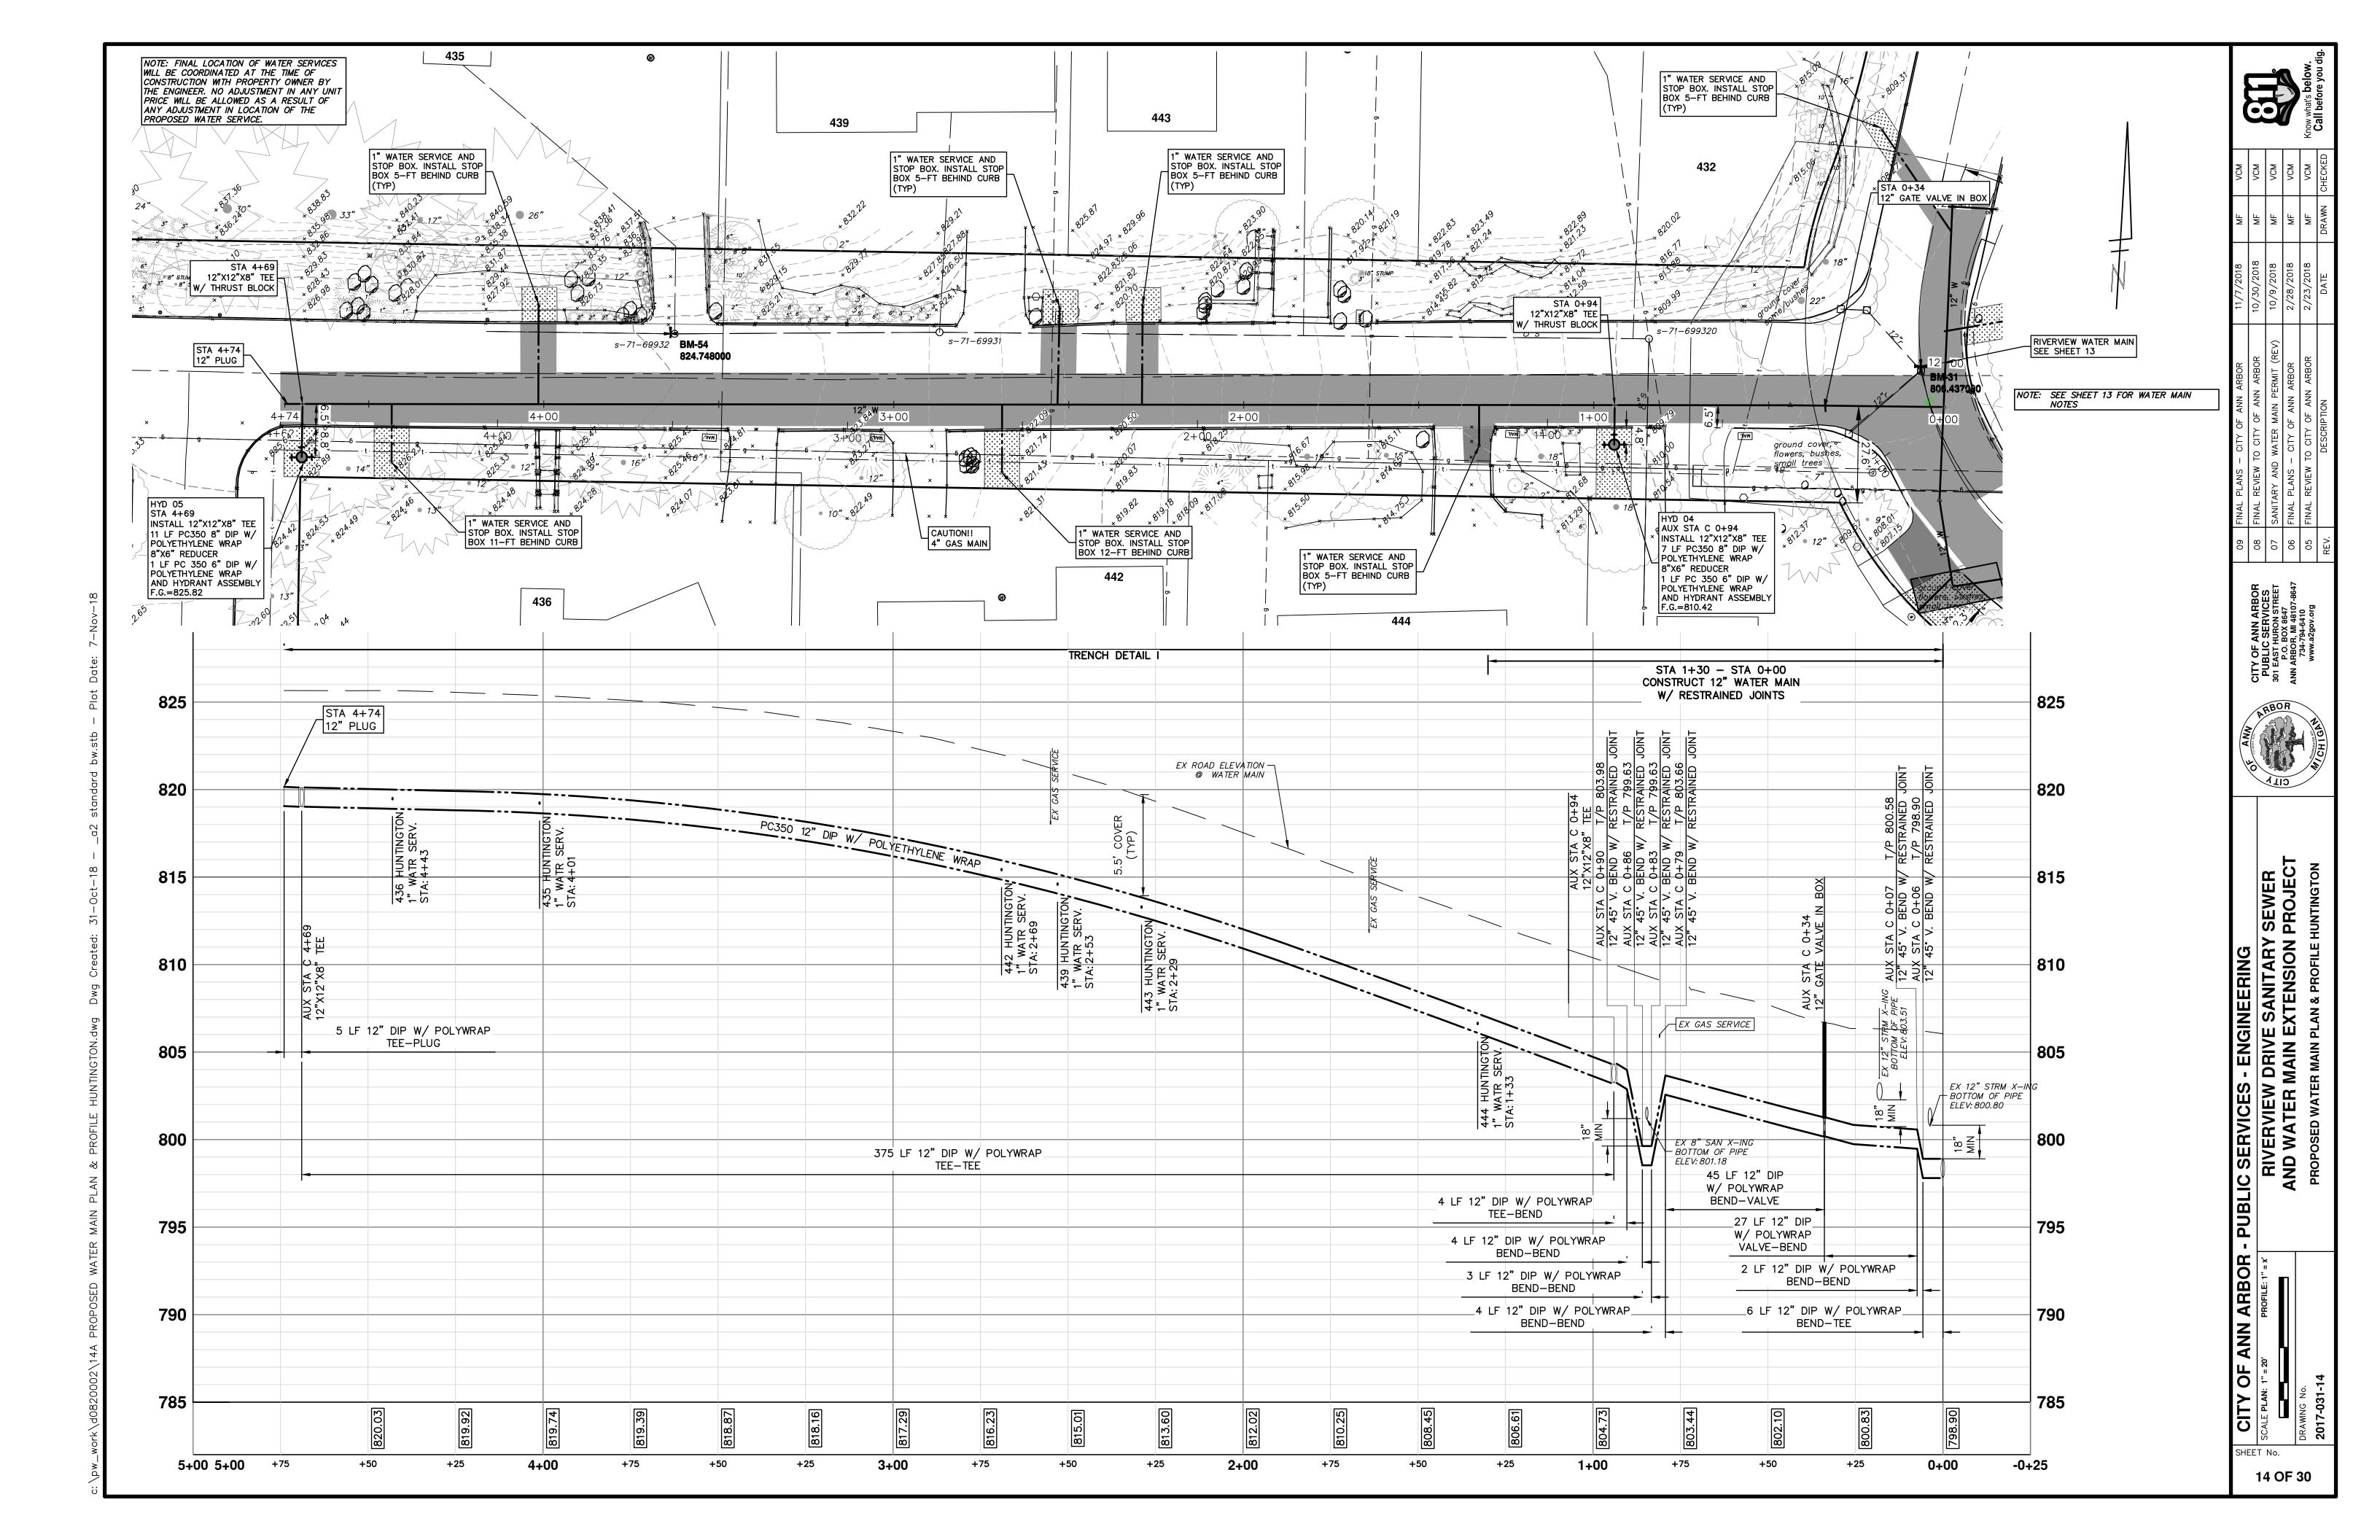

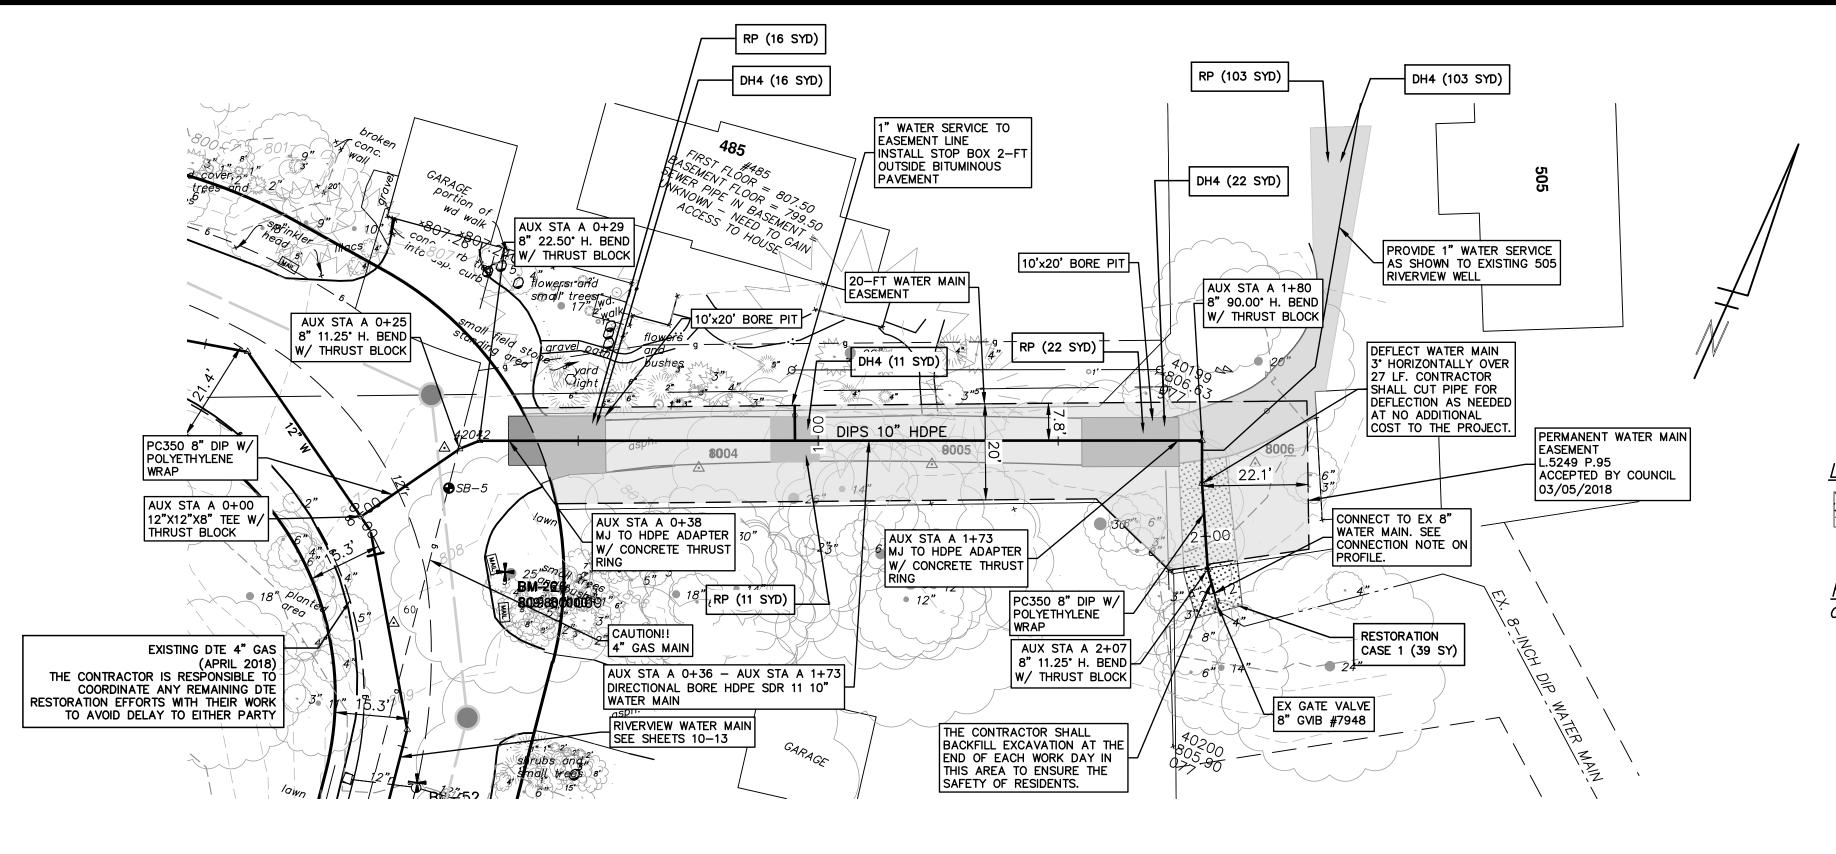

DIRECTIONAL BORE

EX ROAD ELEVATION -

@ WATER MAIN

STA 0+00 - STA 0+38

CONSTRUCT 12" WATER

MAIN W/ RESTRAINED

AUX STA A 0+38

AND CONCRETE

ENCASEMENT

4 LF 8" DIP W/ POLYWRAP (BEND-BEND)

⁻11 LF 8" DIP W/ POLYWRAP (BEND-BEND)

3 LF 8" DIP W/ POLYWRAP (BEND-BEND)

+50

4 LF 8" DIP W/ POLYWRAP (BEND-BEND)

3 LF 8" DIP W/ POLYWRAP (BEND-BEND)

4 LF 8" DIP W/ POLYWRAP (TEE-BEND)

+25

785

-0+10 0+00

8"x10" REDUCER AND

MJ TO HDPE ADAPTER;

PROVIDE THRUST RING

9 LF 8" DIP W/ POLYWRAP (BEND-ADAPTER

+75

TRENCH DETAIL I

CROSSINGS

1. T/P WM 798.78

2. B/P WM 800.63

AUX STA A 0+65

CAUTION!!

EX 4" GAS

AT ALL CROSSINGS

8 LF 8" DIP W/ POLYWRAP

(ADAPTER-BEND)

AUX STA A 1+71

AND CONCRETE

ENCASEMENT

DIPS HDPE SDR 11 10

133 LF 10" HDPE SDR 11 (ADAPTER-ADAPTER)

1+00

+25

8"X10" REDUCER AND

MJ TO HDPE ADAPTER;

PROVIDE THRUST RING

+50

+75

B/P EX 12" STM 800.28

T/P PROP 8" SAN 799.14

VERIFY DEPTH, SUPPORT AND

PROTECT DURING CONSTRUCTION

NOTE: MAINTAIN 18" VERTICAL CLEARANCE

5 LF LF 8" DIP W/ POLYWRAP

BEND-CONN

27 LF 8" DIP

W/ POLYWRAP_

BEND-BEND

2+00

2+15

AUX STA A 2+12

805 BACTERIOLOGICAL TESTING

REQUIREMENTS.

800 CONFIGURATION.

REMOVE EXISTING BLOW-OFF

ASSEMBLY WHEN WATER MAIN HAS

PASSED ALL HYDROSTATIC AND

CONNECT TO EX. 8-INCH WATER

MAIN W/ LONG-PATTERN SOLID

EXPLORATORY EXCAVATION AT

SLEEVE. CONTRACTOR TO PERFORM

TIE-IN POINT TO CONFIRM TIE-IN

TRENCH DETAIL I

ESTRAINED JOI F/P 798.45 ESTRAINED JOI T/P 801.45 RESTRAINED

AUX STA A
B" 45° V. E
AUX STA A
B" 45° V. BE
AUX STA A
B" 45° V. BE
AUX STA A
B" 45° V.
AUX STA A
B" 11.25° H
AUX STA A
B" 22.5° H.

<u>LEGEND</u>

NOTE: FINAL LOCATION OF WATER SERVICES WILL BE COORDINATED AT THE TIME OF

CONSTRUCTION WITH PROPERTY OWNER BY

PRICE WILL BE ALLOWED AS A RESULT OF

ANY ADJUSTMENT IN LOCATION OF THE

PROPOSED WATER SERVICE.

THE ENGINEER. NO ADJUSTMENT IN ANY UNIT

PROPOSED RESTORATION

RESTORATION

CASE 1 - AREA TO BE RESTORED WITH 4-INCHES OF TOPSOIL, SEED AND MULCH BLANKET.

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8: RESTRAINED JOINT SYSTEMS FOR WATER MAIN SHALL BE UTILIZED WHERE INDICATED ON THE PLANS OR AS DIRECTED BY THE ENGINEER. RESTRAINED JOINT GASKET SYSTEMS ARE TO BE USED. (FIELD-LOK 350 BY U.S. PIPE, FAST-GRIP BY AMERICAN DUCTILE IRON PIPE, OR APPROVED

9: ALL WATER MAIN TO HAVE 5.5 FEET OF COVER. MAINTAIN A MINIMUM OF 18-INCH VERTICAL CLEARANCE FOR STORM AND SANITARY CROSSINGS AND A MINIMUM OF 12-INCH VERTICAL

CLEARANCE WITH ALL OTHER UTILITIES. 10: UNLESS OTHERWISE NOTED, THE CONTRACTOR SHALL UTILIZE STANDARD PIPE DEFLECTIONS FOR FOLLOWING THE PROPOSED ALIGNMENT.

11: NEW FIRE HYDRANTS SHALL BE EJIW 5BR-250 WITH 4-INCH STORZ QUICK CONNEC AND 2-23 HYDRANT OUTLETS

12: FIRE HYDRANT ASSEMBLIES SHALL INCLUDE ALL NECESSARY HYDRANT EXTENSIONS, THRUST BLOCKS, PIPE AND FITTINGS, INCLUDING ADJUSTMENT OF THE COMPANION VALVE. FIRE HYDRANT ASSEMBLY INCLUDES 6-INCH COMPANION VALVE LOCATED THREE FEET FROM THE HYDRANT.

13: ALL WATER MAIN TRENCH BACKFILL SHALL BE MDOT CLASS II GRANULAR MATERIAL (SEE UTILITY TRENCH TYPE I DETAIL).

14: CONNECTIONS TO THE EXISTING WATER MAIN SHALL NOT BE MADE UNTIL THE NEW MAIN HAS BEEN SUCCESSFULLY TESTED AND HAS PASSED ALL HYDROSTATIC AND BACTERIOLOGICAL TESTING. FINAL CONNECTIONS SHALL BE COORDINATED WITH THE ENGINEER.

15: THE CONTRACTOR SHALL PERFORM ALL WATER SYSTEM SHUT DOWNS AFTER APPROPRIATE NOTIFICATION TO THOSE AFFECTED AND APPROVAL HAS BEEN GRANTED BY THE ENGINEER.

16: THE DRILLING MACHINE IS TO BE PLACED AT THE EAST BORE PIT TO PULL PIPE FROM THE WEST BORE PIT. PIPE TO BE STAGED ALONG RIVERVIEW DRIVE WITHOUT UNDULY INTERFERING WITH TRAFFIC.

17: THE CONTRACTOR SHALL MAINTAIN REASONABLE ACCESS FOR RESIDENTS TO ACCESS THEIR HOMES AT ALL TIMES. A SAFE ACCESS PATH SHALL BE IDENTIFIED ALONG WITH VEHICLE PARKING IN THE EVENT THAT CONSTRUCTION ACTIVITIES INHIBIT VEHICULAR ACCESS TO THE HOMES.

18: EQUIPMENT USED TO INSTALL THE PROPOSED WATER MAIN ON LOT 505 SHALL BE SIZED APPROPRIATELY SUCH THAT THERE IS MINIMUM DISTURBANCE TO EXISTING SITE FEATURES. THE CONTRACTOR SHALL ENSURE THE PROTECTION OF THE EXISTING HMA DRIVEWAY WHEN USING TRACKED EQUIPMENT OR USE RUBBER TIRED EQUIPMENT.

PLACE 4" HMA DRIVE PLACE 6" CONCRETE DRIVE APPROACH REMOVE EXISTING ASPHALT CURB AND PAVEMENT. RCG-PM CONCRETE GUTTER OR CONCRETE CURB -ANY TYPE REMOVE EXISTING PAVEMENT —ANY THICKNESS

SAWCUT AT REMOVAL LIMITS (INCLUDE IN WORK ITEM "HMA SURFACE, REM")

RELOCATE BY OWNER RRST REMOVE & REPLACE EXISTING STORM SEWER-SIZE AS SHOWN ON PLAN

PLACE ASHPALT PAVEMENT-MATERIAL AND THICKNESS PER TYPICAL CROSS SECTION

90	08 FINAL REVIEW TO CITY OF ANN ARBOR	10/30/2018	MF	NCM
07	07 SANITARY AND WATER MAIN PERMIT (REV)	10/9/2018	MF	NCM
90	06 FINAL PLANS - CITY OF ANN ARBOR	2/28/2018	MF	NCM
05	05 FINAL REVIEW TO CITY OF ANN ARBOR	2/23/2018	MF	NCM
REV.	DESCRIPTION	DATE	DRAWN CHECKE	CHECKE

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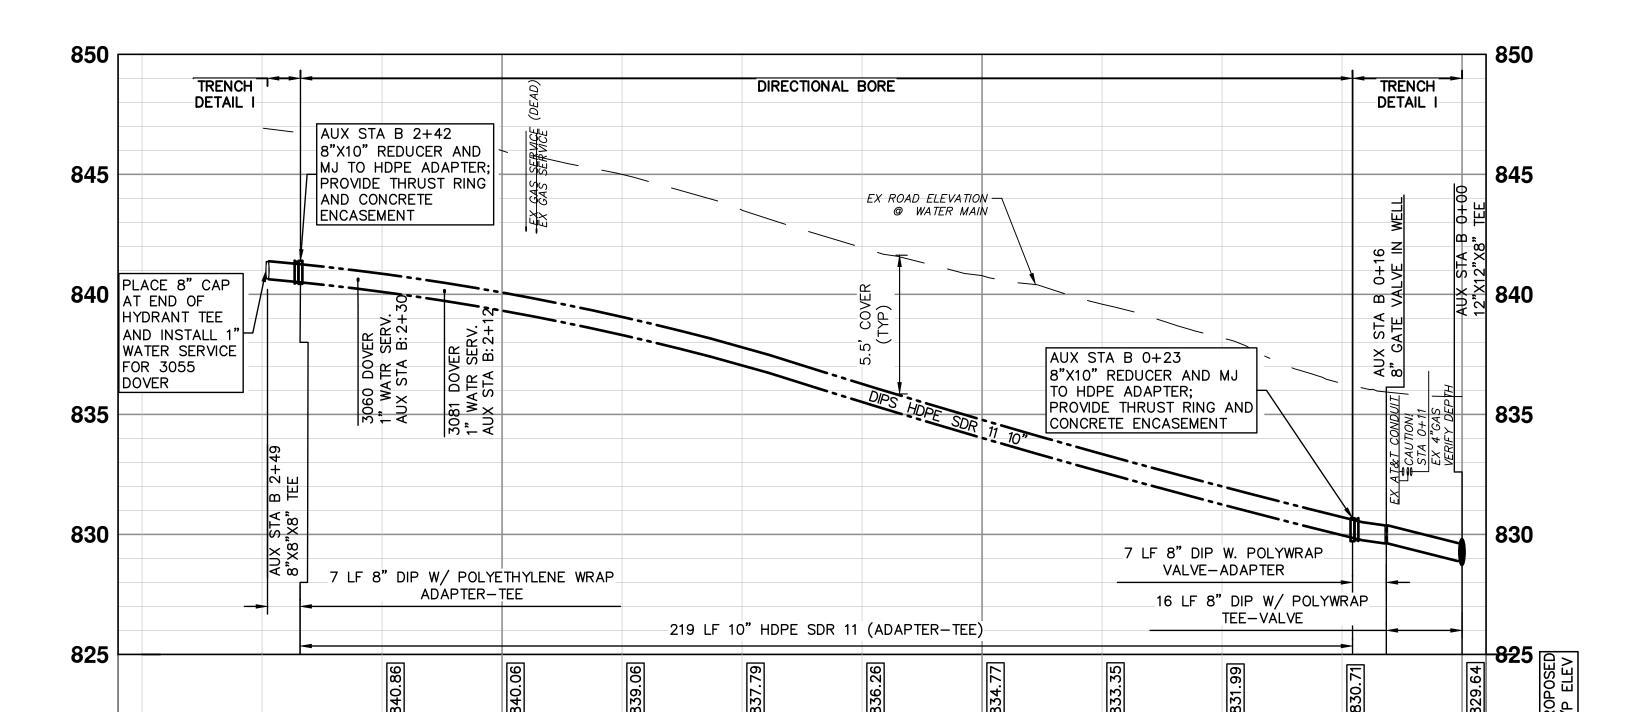


SEWER PROJEC SANITARY

EXTENSION I ENGINEERIN шШЗ / DRIVI MAIN PLA

RIVERVIEW I AND WATER IN PROPOSED WATER IM SERVICES

SHEET No.



+25

1+00

+75

+50

+25

0+00 -0+05

2+00

+75

+50

2+80 +75

+50

+25

PROPOSED RESTORATION

RESTORATION

CASE 1 - AREA TO BE RESTORED WITH 4-INCHES OF TOPSOIL, SEED AND MULCH BLANKET. CASE 2 - RESTORE AREA WITH 6-INCHES OF TOPSOIL AND 3-INCHES OF SHREDDED HARDWOOD BARK MULCH.

NOTE: A PROVISIONAL QUANTITY OF 200 LINEAL FEET HAS BEEN ADDED TO THE PAY ITEMS "SEWER, ANY SIZE OR DEPTH. REM" AND "SEWER. CL C76 IV. 12 INCH. TR DET I, MODIFIED" TO ACCOUNT FOR POTENTIAL CONFLICTS THAT MAY ARISE DURING THE INSTALLATION OF THE PROPOSED UTILITIES WITH THE EXISTING STORM SEWER SYSTEM. THE USE OF THIS PROVISIONAL QUANTITY WILL BE AT THE DIRECTION OF THE ENGINEER.

NOTE: A PROVISIONAL QUANTITY OF 400 LINEAL FEET HAS BEEN ADDED TO THE PAY ITEMS " CURB, ANY TYPE OR SIZE, REM" AND "CURB SLOPED, HMA, SPECIAL" TO BE USED IN THE EVENT THAT THE EXISTING CURB NOT IDENTIFIED FOR REMOVAL IN THE PLANS IS DAMAGED BY UNAVOIDABLE CIRCUMSTANCES ENCOUNTERED DURING CONSTRUCTION. THIS PROVISIONAL QUANTITY IS NOT INTENDED TO EXPEDITE THE CONTRACTOR'S OPERATION OR TO DIMINISH TRENCH WIDTH AND/OR SAFETY REQUIREMENTS. THE USE OF THIS PROVISIONAL QUANTITY WILL BE AT THE DIRECTION OF THE ENGINEER.

WATER MAIN CONSTRUCTION NOTES

1: SEE EROSION CONTROL SHEETS FOR DETAILS ON PLACEMENT, MAINTENANCE. AND REMOVAL OF EROSION CONTROL ITEMS.

2: THE CONTRACTOR SHALL CAREFULLY PROTECT FROM DAMAGE OR INJURY DURING CONSTRUCTION OPERATIONS ALL UTILITIES, SITE FEATURES, LANDSCAPING, AND OTHER ITEMS NOT DESIGNATED FOR REMOVAL OR ABANDONMENT. PAYMENT FOR PROTECTION OF UTILITIES INCLUDED IN "GENERAL CONDITIONS, MAX____". EXISTING FACILITIES NOT DESIGNATED FOR REMOVAL OR ABANDONMENT, BUT WHICH ARE DAMAGED BY THE CONTRACTOR'S OPERATION SHALL BE REPAIRED OR REPLACED BY THE CONTRACTOR AT HIS SOLE EXPENSE, AS DETERMINED BY THE ENGINEER.

3: THE EXISTING UTILITIES SHOWN ON THESE PLANS REPRESENT THE BEST INFORMATION AVAILABLE AS OBTAINED THROUGH SURVEYS AND/OR EXISTING PLANS. THIS INFORMATION DOES NOT RELIEVE THE CONTRACTOR OF THE RESPONSIBILITY TO BE SATISFIED AS TO ITS ACCURACY AND THE LOCATION OF EXISTING UTILITIES. IF STORM, SANITARY, OR WATERMAINS CROSS OTHER UTILITIES, CONTACT THEIR RESPECTIVE OWNERS FOR INFORMATION ON HOW TO PROCEED. PAYMENT FOR THE COORDINATION EFFORTS AND ASSOCIATED ITEMS SHALL BE INCLUDED IN ASSOCIATED PROPOSED STORM, SANITARY, OR WATERMAIN ITEMS AND SHALL NOT BE PAID FOR SEPARATELY.

4: THE EXISTING 8" WATER MAIN FROM GEDDES MAY BE EXPOSED DURING CONSTRUCTION IN THE VICINITY SHOWN. THE CONTRACTOR SHALL CAREFULLY PROTECT FROM DAMAGE OR INJURY THE EXISTING WATER MAIN DURING CONSTRUCTION OPERATIONS. ANY DAMAGE TO THIS FACILITY BY THE CONTRACTOR'S OPERATION SHALL BE REPAIRED OR REPLACED BY THE CONTRACTOR AT HIS EXPENSE. AS DETERMINED BY THE ENGINEER. PAYMENT FOR PROTECTION OF THE EXISTING WATER MAIN WILL NOT BE PAID FOR SEPARATELY, BUT SHALL BE INCLUDED IN THE ITEM OF WORK "GENERAL CONDITIONS.

5: THE CONTRACTOR SHALL NOT REMOVE OR DAMAGE EXISTING SANITARY SEWER OR WATER MAIN LEADS FOR EASE OF CONSTRUCTING OTHER ASPECTS OF WORK. THE CONTRACTOR SHALL CAREFULLY PROTECT ALL LEADS FROM DAMAGE OR INJURY.

6: THE CONSTRUCTION COVERED BY THESE PLANS SHALL CONFORM TO THE CITY OF ANN ARBOR PUBLIC SERVICES DEPARTMENT STANDARD SPECIFICATIONS WHICH ARE INCLUDED BY REFERENCE. THE OMISSION OF ANY CURRENT STANDARD DETAIL DOES NOT RELIEVE THE CONTRACTOR FROM THE REQUIREMENT. THE WORK SHALL BE PERFORMED IN COMPLETE CONFORMANCE WITH CURRENT PUBLIC SERVICE DEPARTMENT STANDARD SPECIFICATIONS AND DETAILS.

7: ALL WATER MAIN SHALL BE PRESSURE CLASS 350 DUCTILE IRON WATER MAIN, CEMENT-LINED (DOUBLE THICKNESS), WITH POLYWRAP UNLESS NOTED OTHERWISE.

8: RESTRAINED JOINT SYSTEMS FOR WATER MAIN SHALL BE UTILIZED WHERE INDICATED ON THE PLANS OR AS DIRECTED BY THE ENGINEER. RESTRAINED JOINT GASKET SYSTEMS ARE TO BE USED. (FIELD-LOK 350 BY U.S. PIPE, FAST-GRIP BY AMERICAN DUCTILE IRON PIPE, OR APPROVED

9: ALL WATER MAIN TO HAVE 5.5 FEET OF COVER. MAINTAIN A MINIMUM OF 18-INCH VERTICAL CLEARANCE FOR STORM AND SANITARY CROSSINGS AND A MINIMUM OF 12-INCH VERTICAL CLEARANCE WITH ALL OTHER UTILITIES.

10: UNLESS OTHERWISE NOTED, THE CONTRACTOR SHALL UTILIZE STANDARD PIPE DEFLECTIONS FOR FOLLOWING THE PROPOSED ALIGNMENT.

11: NEW FIRE HYDRANTS SHALL BE EJIW 5BR-250 WITH 4-INCH STORZ QUICK CONNEC AND 2-23 HYDRANT OUTLETS

12: FIRE HYDRANT ASSEMBLIES SHALL INCLUDE ALL NECESSARY HYDRANT EXTENSIONS, THRUST BLOCKS, PIPE AND FITTINGS, INCLUDING ADJUSTMENT OF THE COMPANION VALVE. FIRE HYDRANT ASSEMBLY INCLUDES 6-INCH COMPANION VALVE LOCATED THREE FEET FROM THE HYDRANT.

13: ALL WATER MAIN TRENCH BACKFILL SHALL BE MDOT CLASS II GRANULAR MATERIAL (SEE UTILITY TRENCH TYPE I DETAIL).

14: CONNECTIONS TO THE EXISTING WATER MAIN SHALL NOT BE MADE UNTIL THE NEW MAIN HAS BEEN SUCCESSFULLY TESTED AND HAS PASSED ALL HYDROSTATIC AND BACTERIOLOGICAL TESTING. FINAL CONNECTIONS SHALL BE COORDINATED WITH THE ENGINEER.

15: THE CONTRACTOR SHALL PERFORM ALL WATER SYSTEM SHUT DOWNS AFTER APPROPRIATE NOTIFICATION TO THOSE AFFECTED AND APPROVAL HAS BEEN GRANTED BY THE

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17: THE CONTRACTOR SHALL MAINTAIN REASONABLE ACCESS FOR RESIDENTS TO ACCESS THEIR HOMES AT ALL TIMES. A SAFE ACCESS PATH SHALL BE IDENTIFIED ALONG WITH VEHICLE PARKING IN THE EVENT THAT CONSTRUCTION ACTIVITIES INHIBIT VEHICULAR ACCESS TO THE HOMES.

18: AFTER WATER MAIN INSTALLATION HAS BEEN COMPLETED, SUCCESSFULLY TESTED, CONNECTED TO EXISTING MAIN AND ALL LEADS INSTALLED, THE CONTRACTOR SHALL PLACE, GRADE AND COMPACT 4 INCHES OF 23A AGGREGATE ALONG THE ENTIRE UNPAVED SECTION OF DOVER PLACE.

CONSTRUCTION KEY

PLACE 4" HMA DRIVE PLACE 6" CONCRETE DRIVE APPROACH RCG-PM REMOVE EXISTING ASPHALT CURB AND PAVEMENT, CONCRETE GUTTER OR CONCRETE CURB -ANY TYPE REMOVE EXISTING PAVEMENT -ANY THICKNESS

SAWCUT AT REMOVAL LIMITS (INCLUDE IN WORK ITEM "HMA SURFACE, REM")

RLBO RELOCATE BY OWNER REMOVE & REPLACE EXISTING STORM SEWER-SIZE

AS SHOWN ON PLAN PLACE ASHPALT PAVEMENT-MATERIAL AND THICKNESS PER TYPICAL CROSS SECTION

SHEET No. 16 OF 30



SEWER PROJECT DOVER PL

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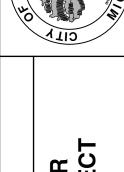
- PUBLIC SERVICES

SHEET No.

60	09 FINAL PLANS - CITY OF ANN ARBOR	11/7/2018	MF	NON	
80	08 FINAL REVIEW TO CITY OF ANN ARBOR	10/30/2018	MF	NCM	
07	07 SANITARY AND WATER MAIN PERMIT (REV)	10/9/2018	MF	NCM	
90	06 FINAL PLANS - CITY OF ANN ARBOR	2/28/2018	MF	NCM	
05	05 FINAL REVIEW TO CITY OF ANN ARBOR	2/23/2018	MF	NCM	
EV.	DESCRIPTION	DATE	DRAWN	DRAWN CHECKED	



NOTE: THE CONTRACTOR SHALL CONTAIN ALL CONSTRUCTION OPERATIONS TO THE PAVED/GRAVEL ROADWAY AREAS TO THE GREATEST EXTENT POSSIBLE. DAMAGE TO PRIVATE PROPERTY SHALL BE RESTORED BY THE CONTRACTOR TO A CONDITION THAT IS EQUAL TO, OR BETTER THAN, THAT WHICH EXISTED PRIOR TO THE DAMAGE. ALL REPAIRS SHALL BE AT THE CONTRACTOR'S SOLE EXPENSE.



RIVERVIEW DRIVE SANITARY SEWER AND WATER MAIN EXTENSION PROJEC CITY OF ANN ARBOR - PUBLIC SERVICES - ENGINEERING

SCALE: NTS

18 OF 30

40' R.O.W. FROM POB TO 8+00, VARIES BETWEEN 40' AND 55' FROM 8+00 TO 10+13.21, 66' FROM 10+13.21 TO POE CONSTRUCTION € 31'± B/B VARIES BETWEEN 17.3' AND 14.1' FROM P.O.B. TO P.O.E. VARIES BETWEEN 13.7' AND 16.9' FROM P.O.B. TO P.O.E. DISTANCE BETWEEN BACK OF CURB AND ROW DISTANCE BETWEEN BACK OF CURB AND ROW VARIES BETWEEN 3.4' AND 6.0 POB TO 8+00' VARIES BETWEEN 4.1' AND 5.5 POB TO 8+00' VARIES BETWEEN 6.0' AND 15.4 8+00 TO 10+13.21' VARIES BETWEEN 5.3' AND 19.9 8+00 TO 10+13.21' VARIES BETWEEN 16.6' AND 18.7 10+13.21 TO POE' VARIES BETWEEN 17.2' AND 19.0 10+13.21 TO POE' LIMITS OF PAVEMENT REMOVAL
P.O.B. TO P.O.E. PAID FOR AS HMA
SURFACE REM SAWCUT FULL DEPTH FOR A CLEAN EDGE BOTH SIDES *** EXISTING
BITUMINOUS PAVEMENT— PROTECT HEAVILY LANDSCAPED AREAS SEE PLAN FOR LOCATIONS CROWN POINT PROTECT HEAVILY LANDSCAPED AREAS SEE PLAN FOR LOCATIONS VARIES SEE CHART BELOW VARIES SEE CHART BELOW ** EXISTING AGGREGATE BASE COURSE *** SOIL BORINGS INDICATE
ASPHALT THICKNESS RANGING
FROM 2.5" TO 4" — EXISTING STORM INLET OR CATCH BASIN ** EXISTING AGGREGATE BASE RANGING FROM 7" TO 12.5"

> EXISTING TYPICAL CROSS SECTION RIVERVIEW DRIVE

EFT GRADE	STATION	RIGHT GRADE
3.1%	0+53	-3.6%
-1.2%	1+00	-3.7%
0.2%	1+50	-1.3%
-1.0%	2+00	-2.7%
-1.0%	2+50	-4.2%
-0.1%	3+00	-3.7%
0%	3+50	-2.5%
1.3%	4+00	-1%
-1.6%	4+50	-0.8%
-1.6%	5+00	-1.3%
-1.2%	5+50	-1.9%
-0.4%	6+00	-3.4%
-1.7%	6+50	-3.6%
0.7%	7+00	-1.2%
-0.7%	7+50	-0.6%
-1.7%	8+00	-0.4%
-1.3%	8+50	2%
-1.8%	9+00	1.6%
-0.2%	9+50	-2.5%
0.2%	10+00	-10.1%

* EXISTING GRADES ARE RELATIVE TO CROWN ELEVATION

P.O.B. STA 0+58.00 TO P.O.E. STA 10+00.00 NOT TO SCALE

3.1%	0+53	-3.6%
-1.2%	1+00	-3.7%
0.2%	1+50	-1.3%
-1.0%	2+00	-2.7%
-1.0%	2+50	-4.2%
-0.1%	3+00	-3.7%
0%	3+50	-2.5%
1.3%	4+00	-1%
-1.6%	4+50	-0.8%
-1.6%	5+00	-1.3%
-1.2%	5+50	-1.9%
-0.4%	6+00	-3.4%
-1.7%	6+50	-3.6%
0.7%	7+00	-1.2%
-0.7%	7+50	-0.6%
-1.7%	8+00	-0.4%
-1.3%	8+50	2%
-1.8%	9+00	1.6%
-0.2%	9+50	-2.5%

1+50

2+00

2+50

3+00

3+50

4+00

4+50

5+00

5+50

6+00

6+50

7+00

7+50

8+00

8+50

9+00

9+50

-1.0%

-1.0%

-0.1%

0%

1.3%

-1.6%

-1.6%

-1.2%

-0.4%

-1.7%

0.7%

-0.7%

-1.7%

-1.3%

-1.8%

-0.2%

-1.3%

-2.7%

-4.2%

-3.7%

-2.5%

-1%

-0.8%

-1.3%

-1.9%

-3.4%

-3.6%

-1.2%

-0.6%

-0.4%

2%


1.6% -2.5%

HMA APPLICATION ESTIMATE

STREET	PAY	HMA MIX	APPLICATION	EST.	PERF	AWI
NAME	ITEM		RATE	THICKNESS	GRADE	(MIN)
RIVERVIEW	HMA, LVSP	LVSP (TOP)	226 LB/SYD	2.0"	PG 58-28	260
DRIVE	HMA, LVSP	LVSP (BASE)	282.5 LB/SYD	2.5"	PG 58-28	260
HUNTINGTON	HMA, LVSP	LVSP (TOP)	226 LB/SYD	2.0"	PG 58-28	260
PLACE	HMA, LVSP	LVSP (BASE)	282.5 LB/SYD	2.5"	PG 58-28	260
HMA DRIVEWAYS: 485 AND 505 RIVERVIEW DRIVEWAY AREAS	HMA APPROACH	HMA, LVSP (TOP)	452 LB/SYD (2 LIFTS)	4.0"	PG 58-28	260
DOVER PLACE	HMA APPROACH	HMA, LVSP (TOP)	452 LB/SYD (2 LIFTS)	4.0"	PG 58-28	260

LVSP = LOW VOLUME SUPER PAVE


NOTE: AREAS OF HMA PLACEMENT AS DESIGNATED ON THE PLANS AS "DH4" SHALL BE PAID FOR AS THE ITEM OF WORK "HMA APPROACH." AREAS OF HMA PLACEMENT AS DESIGNATED ON THE PLANS AS "PP" ALONG DOVER PLACE SHALL BE PAID FOR AS THE ITEM OF WORK "HMA APPROACH."

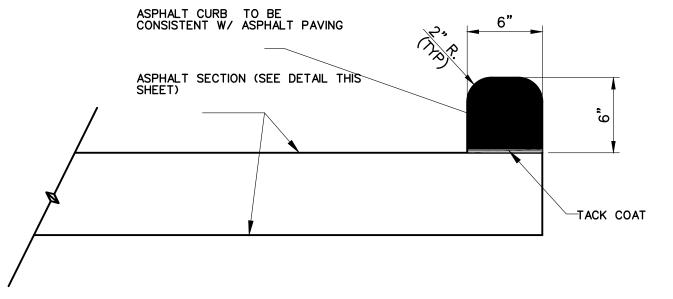

ASPHALT CURB NO SCALE

0.2% 10+00 -10.1% * PROPOSED GRADES ARE RELATIVE TO CROWN ELEVATION

SHEET No.

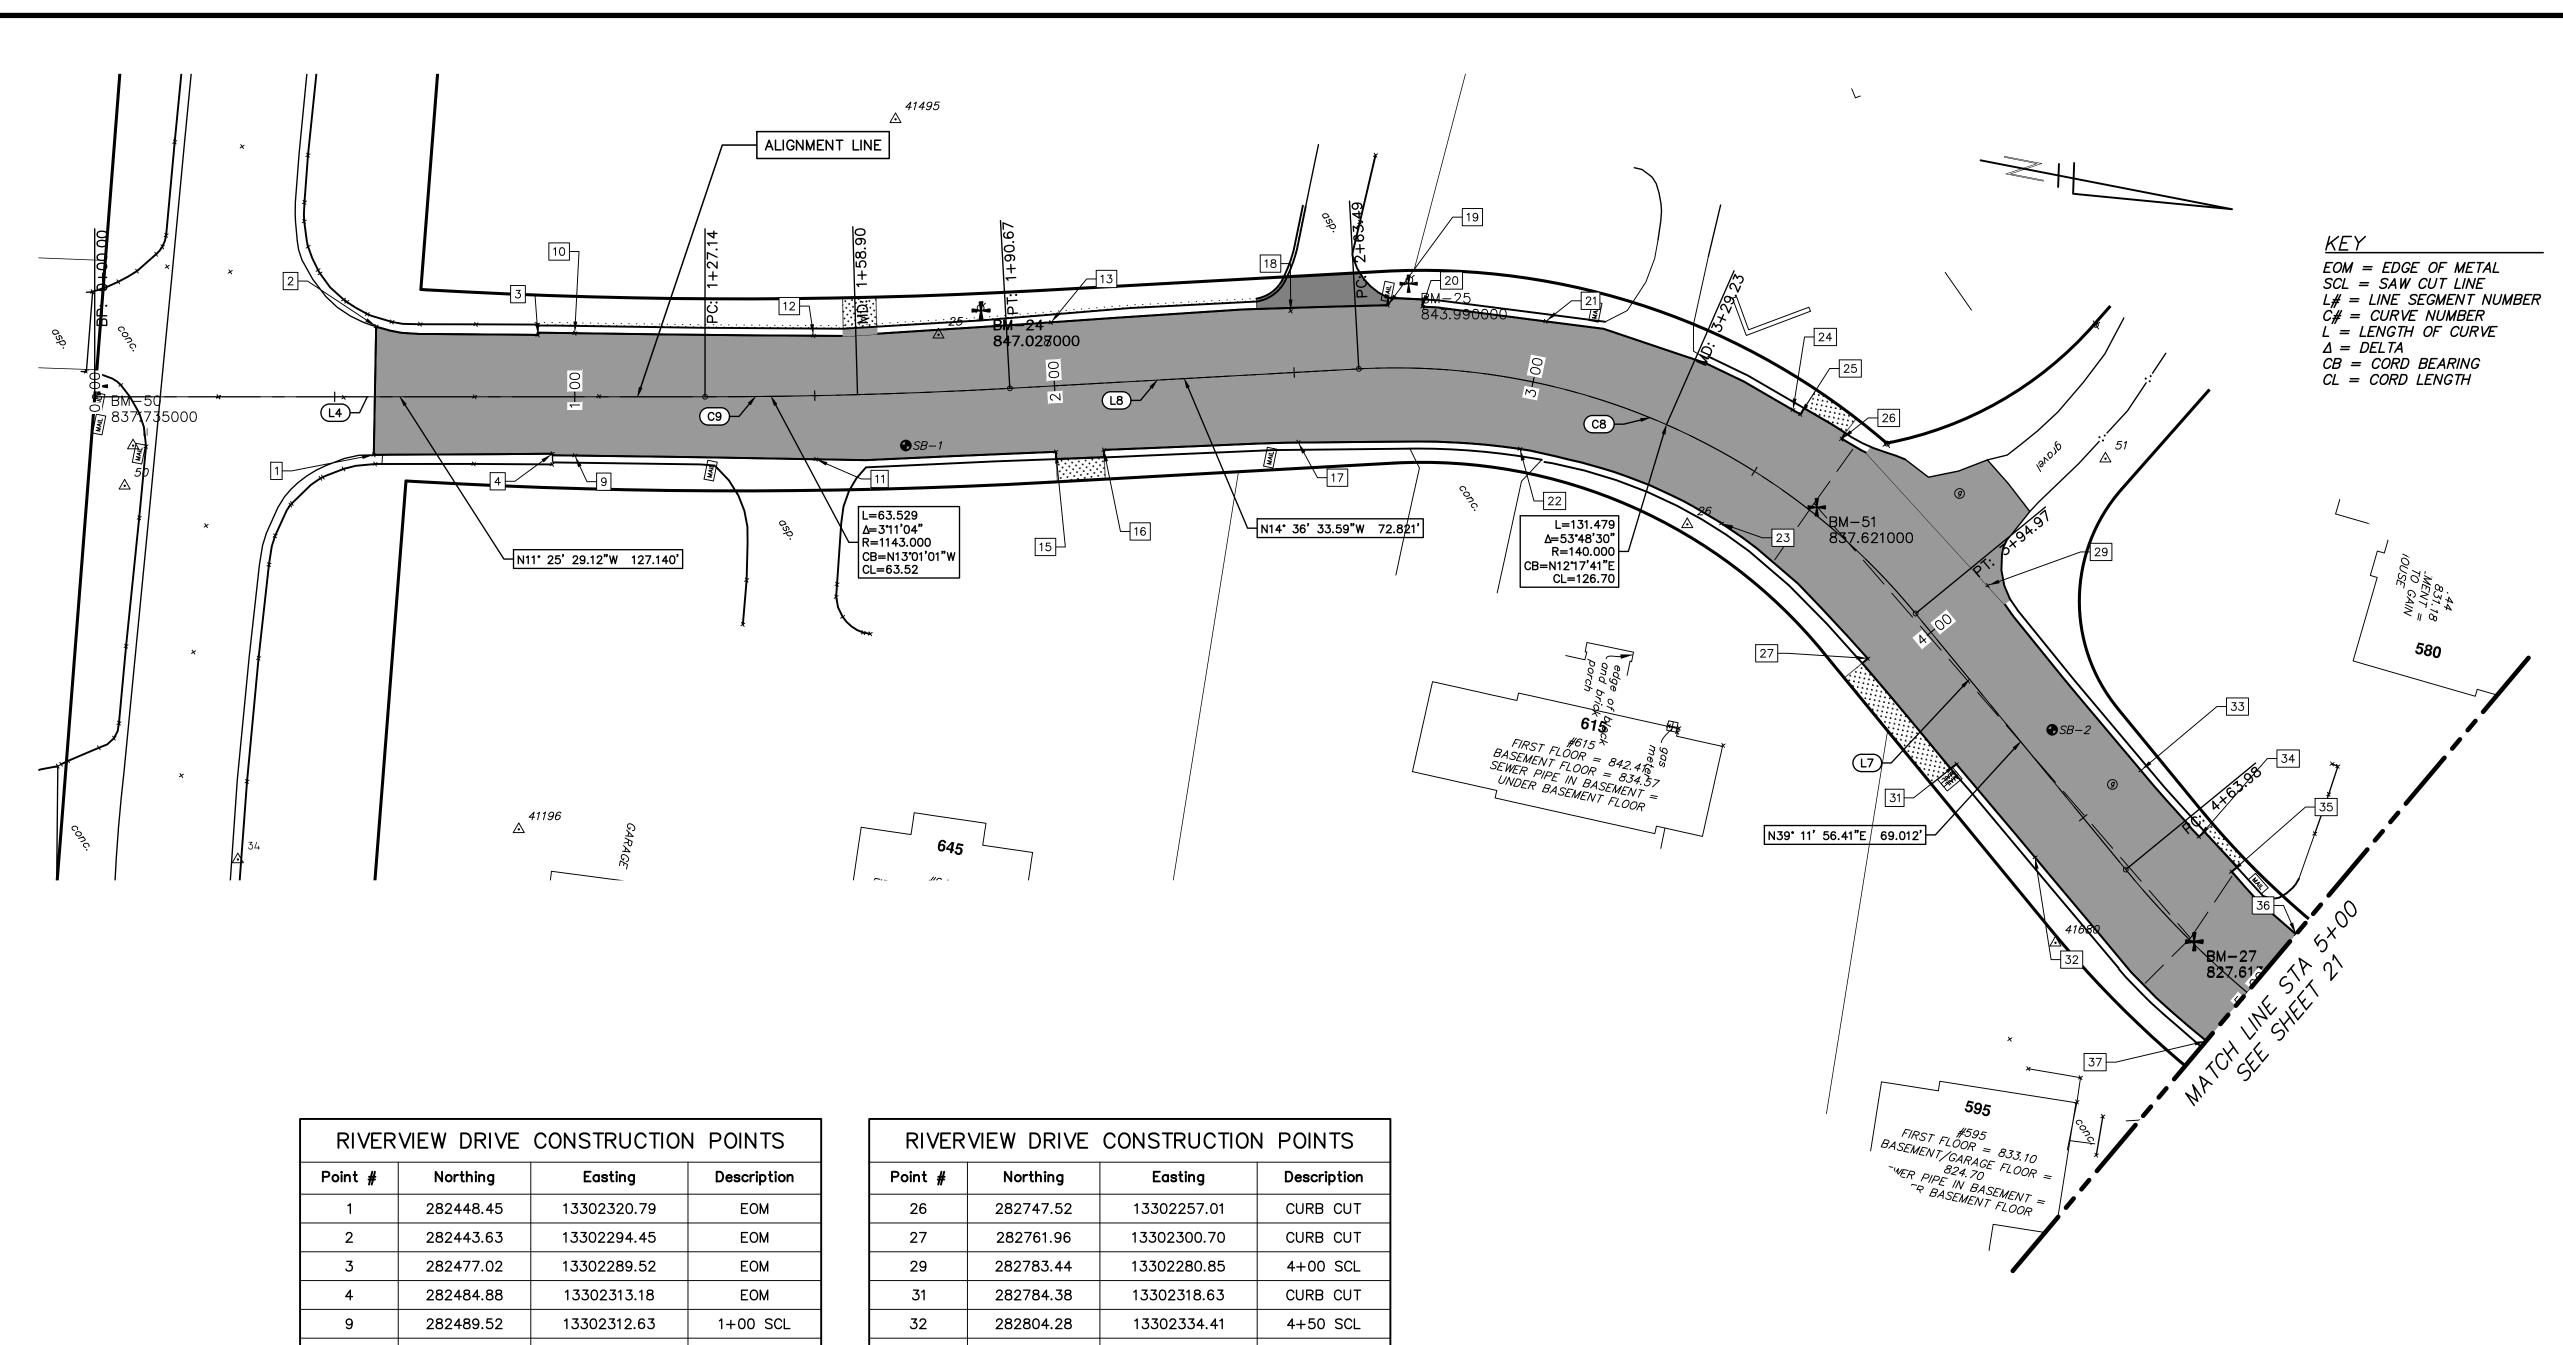

Point #	Northing	Easting	Description
1	282448.45	13302320.79	EOM
2	282443.63	13302294.45	EOM
3	282477.02	13302289.52	EOM
4	282484.88	13302313.18	EOM
9	282489.52	13302312.63	1+00 SCL
10	282484.47	13302287.64	1+00 SCL
11	282538.94	13302303.44	1+50 SCL
12	282533.34	13302278.31	1+50 SCL
13	282581.28	13302265.82	2+00 SCL
15	282587.61	13302292.02	CURB CUT
16	282597.32	13302289.65	CURB CUT
17	282636.66	13302280.05	2+50 SCL
18	282629.77	13302253.59	2+50 SCL
19	282649.36	13302248.37	CURB CUT
20	282656.51	13302247.23	CURB CUT
21	282682.25	13302245.17	3+00 SCL
22	282682.25	13302272.28	3+00 SCL
23	282726.51	13302279.17	3+50 SCL

13302253.07

13302253.65

282736.39

282738.11

24

25

3+50 SCL

CURB CUT

RIVERVIEW DRIVE CONSTRUCTION POINTS					
Point #	Northing	Easting	Description		
26	282747.52	13302257.01	CURB CUT		
27	282761.96	13302300.70	CURB CUT		
29	282783.44	13302280.85	4+00 SCL		
31	282784.38	13302318.63	CURB CUT		
32	282804.28	13302334.41	4+50 SCL		
33	282822.32	13302312.30	4+50 SCL		
34	282836.96	13302323.44	CURB CUT		
35	282844.99	13302329.31	CURB CUT		
36	282860.77	13302339.35	5+00 SCL		
37	282846.85	13302364.83	5+00 SCL		

Line #	Start Point	End Point
L4	N =282389.08 E =13302320.44,	N =282513.70 E =13302295.26
C9	N =282513.70 E =13302295.26,	N =282575.59 E =13302280.95
L8	N =282575.59 E =13302280.95,	N =282646.05 E =13302262.59
C8	N =282646.05 E =13302262.59,	N =282769.85 E =13302289.57
L7	N =282769.85 E =13302289.57,	N =282823.33 E =13302333.18
C7	N =282823.33 E =13302333.18,	N =282981.65 E =13302374.10

FINAL PLANS - CITY OF ANN ARBOR	11/7/2018	MF	NCM	
FINAL REVIEW TO CITY OF ANN ARBOR	10/30/2018	MF	NCM	
SANITARY AND WATER MAIN PERMIT (REV)	10/9/2018	MF	NCM	
FINAL PLANS - CITY OF ANN ARBOR	2/28/2018	MF	NCM	
FINAL REVIEW TO CITY OF ANN ARBOR	2/23/2018	MF	NCM	
DESCRIPTION	DATE	DRAWN	DRAWN CHECKED	

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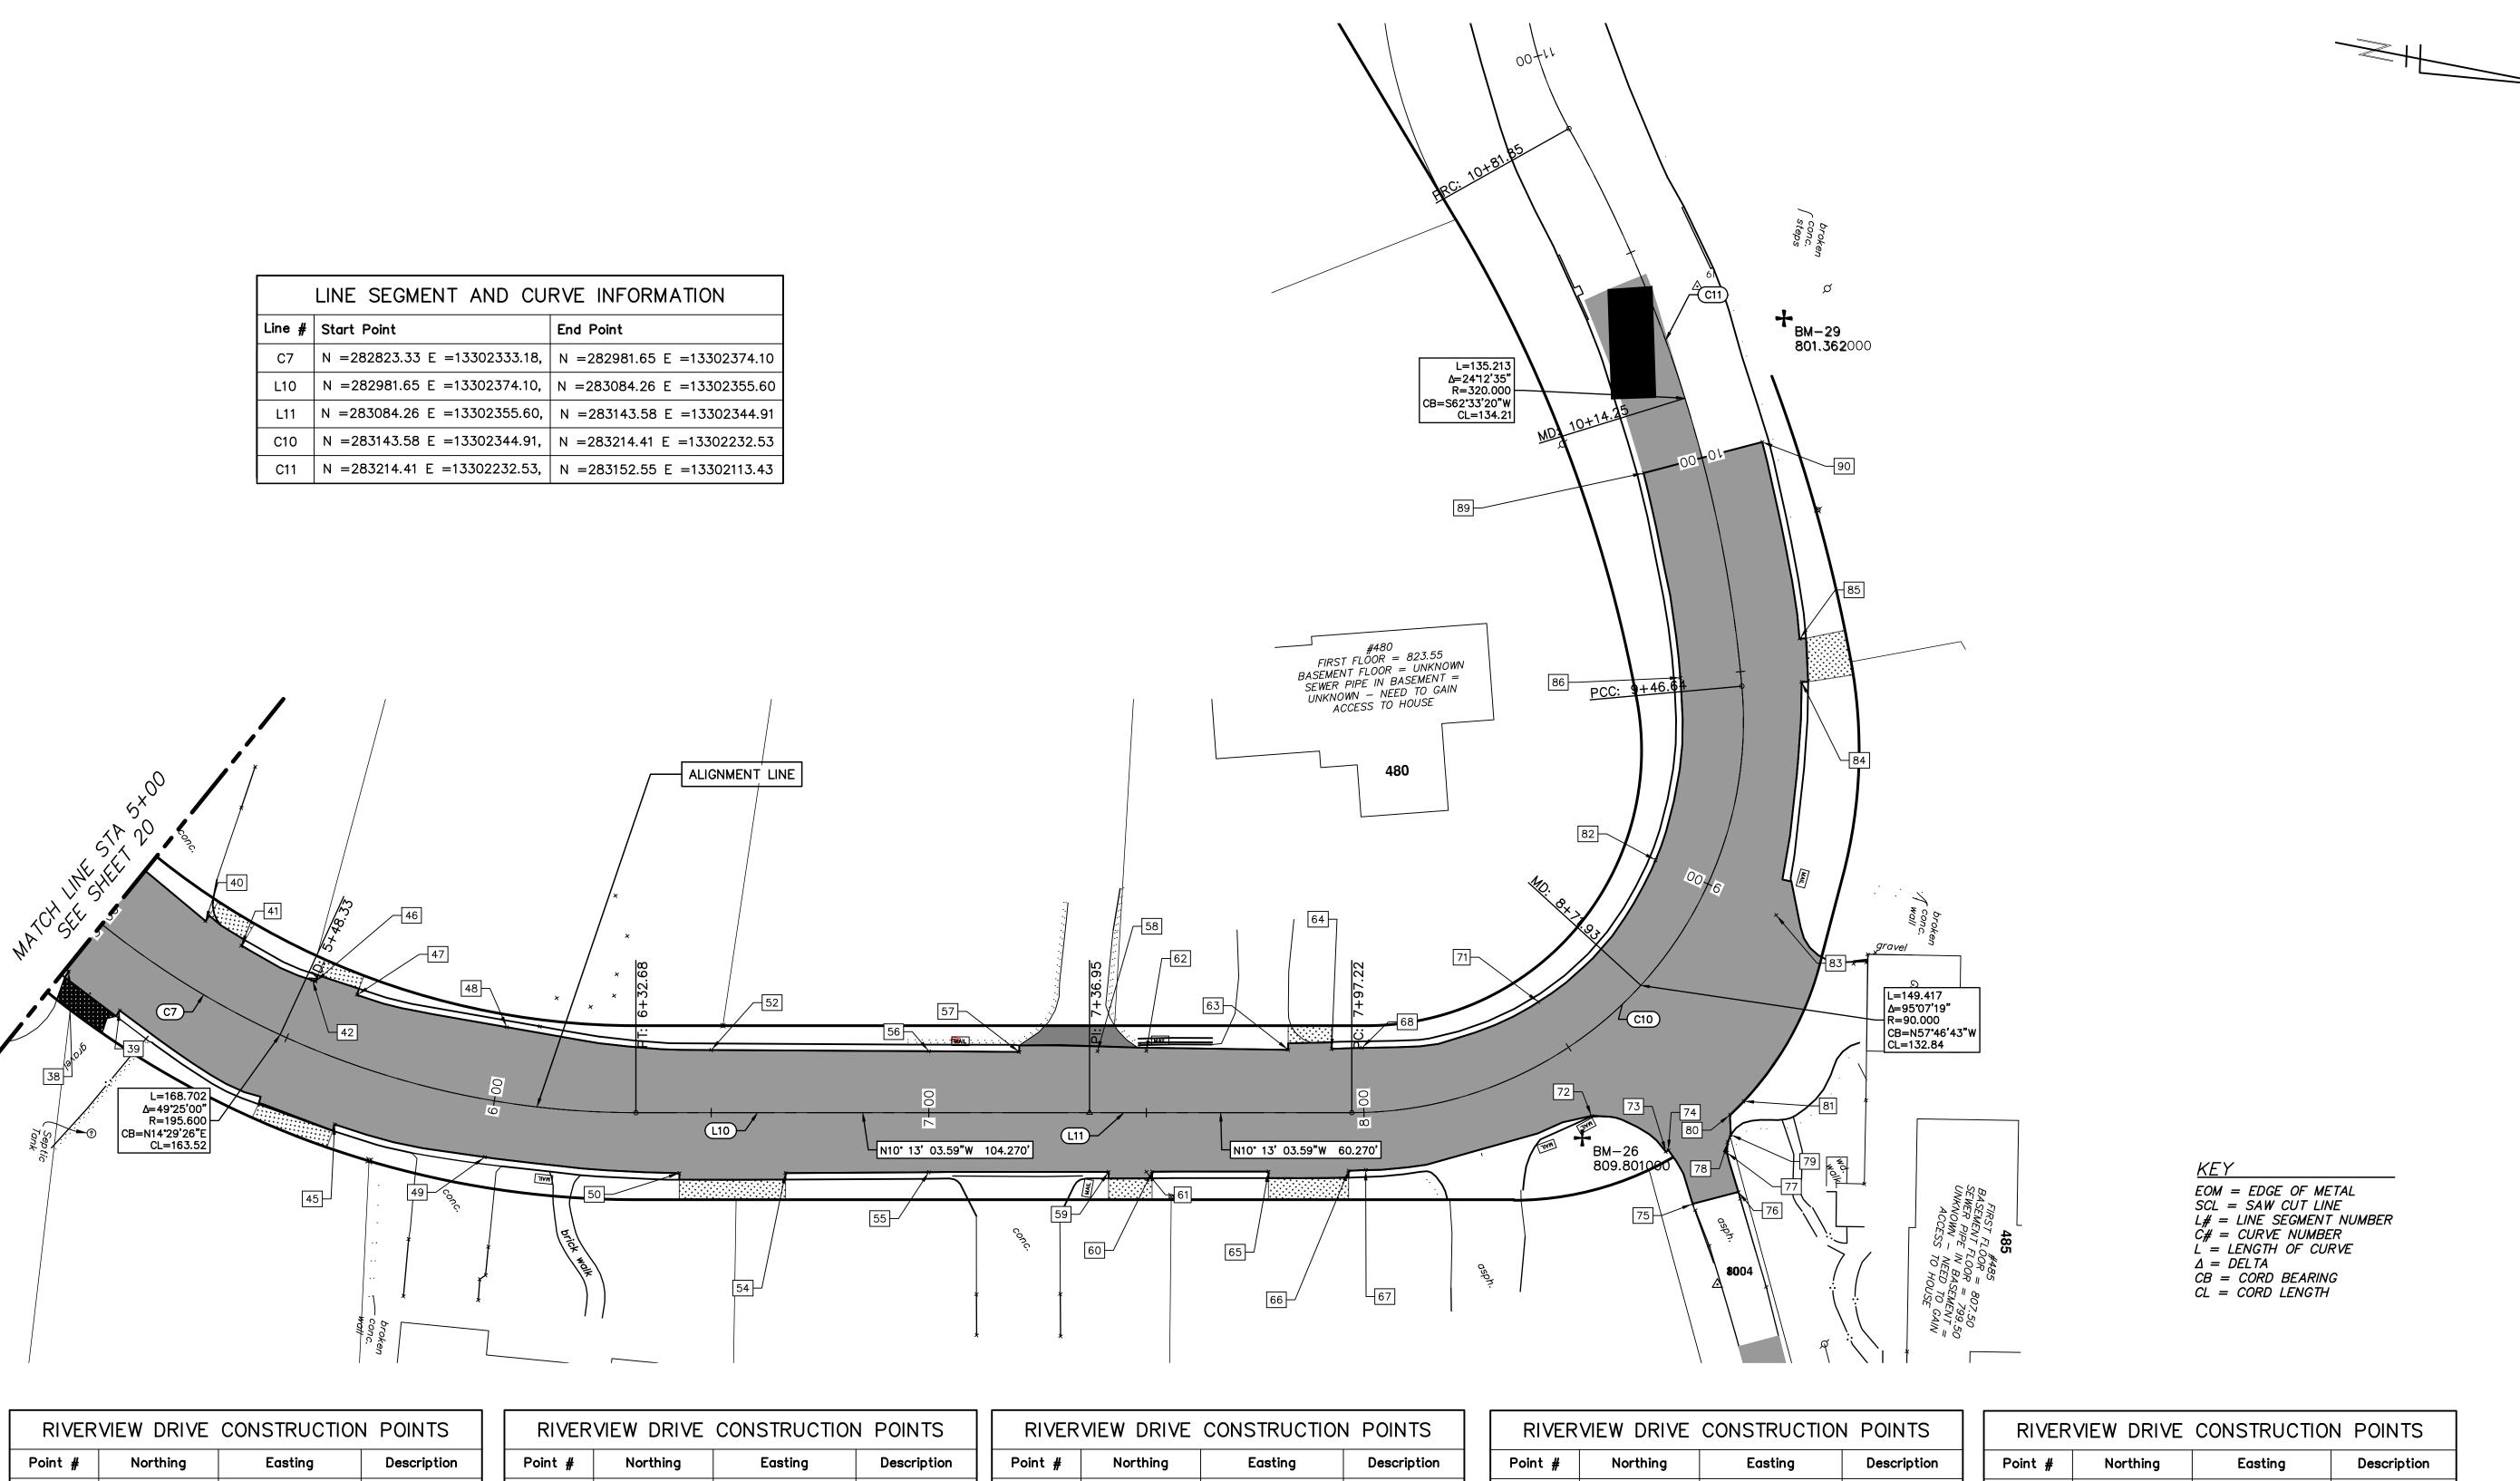
CITY OF ANN ARBOR - PUBLIC SERVICES

SCALE PLAN: 1" = 20'

SCALE PLAN: 1" = 20'

BRAWING NO.

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RIVER	VIEW DRIVE	CONSTRUCTION	N POINTS
Point #	Northing	Easting	Description
38	282847.61	13302365.24	CURB CUT
39	282860.72	13302372.02	CURB CUT
40	282876.49	13302348.29	CURB CUT
41	282885.58	13302352.46	CURB CUT
42	282903.13	13302357.33	5+50 SCL
45	282913.99	13302389.01	CURB CUT
46	282903.86	13302357.44	CURB CUT
47	282913.77	13302358.83	CURB CUT
48	282948.96	13302360.01	6+00 SCL

RIVER	VIEW DRIVE	CONSTRUCTION	POINTS
Point #	Northing	Easting	Description
49	282949.30	13302390.31	6+00 SCL
50	282993.93	13302386.00	CURB CUT
52	282996.13	13302356.85	6+50 EOM
54	283017.94	13302381.65	CURB CUT
55	283050.32	13302375.61	7+00 SCL
56	283045.39	13302348.25	7+00 SCL
57	283065.88	13302344.74	CURB CUT
58	283083.56	13302341.38	CURB CUT
59	283090.96	13302368.23	CURB CUT
60	283100.80	13302366.42	CURB CUT
61	283099.51	13302366.66	7+50 SCL

RIVER	VIEW DRIVE	CONSTRUCTION	N POINTS
Point #	Northing	Easting	Description
62	283094.58	13302339.31	7+50 SCL
63	283126.63	13302333.27	CURB CUT
64	283136.44	13302331.35	CURB CUT
65	283127.12	13302361.63	CURB CUT
66	283145.19	13302358.21	CURB CUT
67	283149.04	13302357.29	8+00 SCL
68	283143.22	13302329.84	8+00 SCL
71	283181.24	13302312.23	8+50 SCL
72	283197.91	13302335.86	EOP
73	283216.22	13302340.95	EOP
74	283216.70	13302340.47	EOP

RIVER	VIEW DRIVE	CONSTRUCTION	POINTS
Point #	Northing	Easting	Description
75	283224.37	13302351.64	EOP
76	283234.24	13302347.07	EOP
77	283230.03	13302338.65	EOP
78	283229.80	13302336.34	EOP
79	283230.20	13302334.42	EOP
80	283229.18	13302329.99	EOP
81	283231.72	13302326.36	EOP
82	283201.99	13302275.37	9+00 SCL
83	283231.50	13302282.92	EOP
84	283227.74	13302229.15	CURB CUT
85	283225.59	13302219.40	CURB CUT


RIVERVIEW DRIVE CONSTRUCTION POINTS			
Point #	Northing	Easting	Description
86	283200.14	13302233.11	9+50 SCL
89	283183.47	13302188.33	10+00 SCL
90	283209.04	13302176.47	10+00 SCL

VCM
VCM
Know what's below.

Call before you dig.

F ANN ARB(OR - PUBLIC SERVICES - ENGINEERING RIVERVIEW DRIVE SANITARY SEWER AND WATER MAIN EXTENSION PROJECT	ARBOR	CITY OF ANN ARBOR PUBLIC SERVICES 301 EAST HURON STREET P.O. BOX 8647 ANN ARBOR, MI 48107-8647 734-794-6410 www.a2gov.org	09 08 09 09 00 00 00 00 00 00 00 00 00 00 00	FINAL PLANS – CITY OF ANN OB FINAL REVIEW TO CITY OF AN OT SANITARY AND WATER MAIN OF FINAL PLANS – CITY OF AN FINAL REVIEW TO CITY OF AN OT OT AND WATER MAIN OF FINAL REVIEW TO CITY OF AN OT AND WATER MAIN OF TO CITY OF AN OT AND WATER MAIN OT TO CITY OF AN OT AND WATER MAIN OT TO CITY OF AN OT AND WATER MAIN OT TO CITY OF AN OT TO CITY OF TO CITY
2017-031-21	ALIGINIMENT PLAN STA 3+00 TO STA 10+00	CHIGH		REV.	DESCRIPTION

SHEET No.

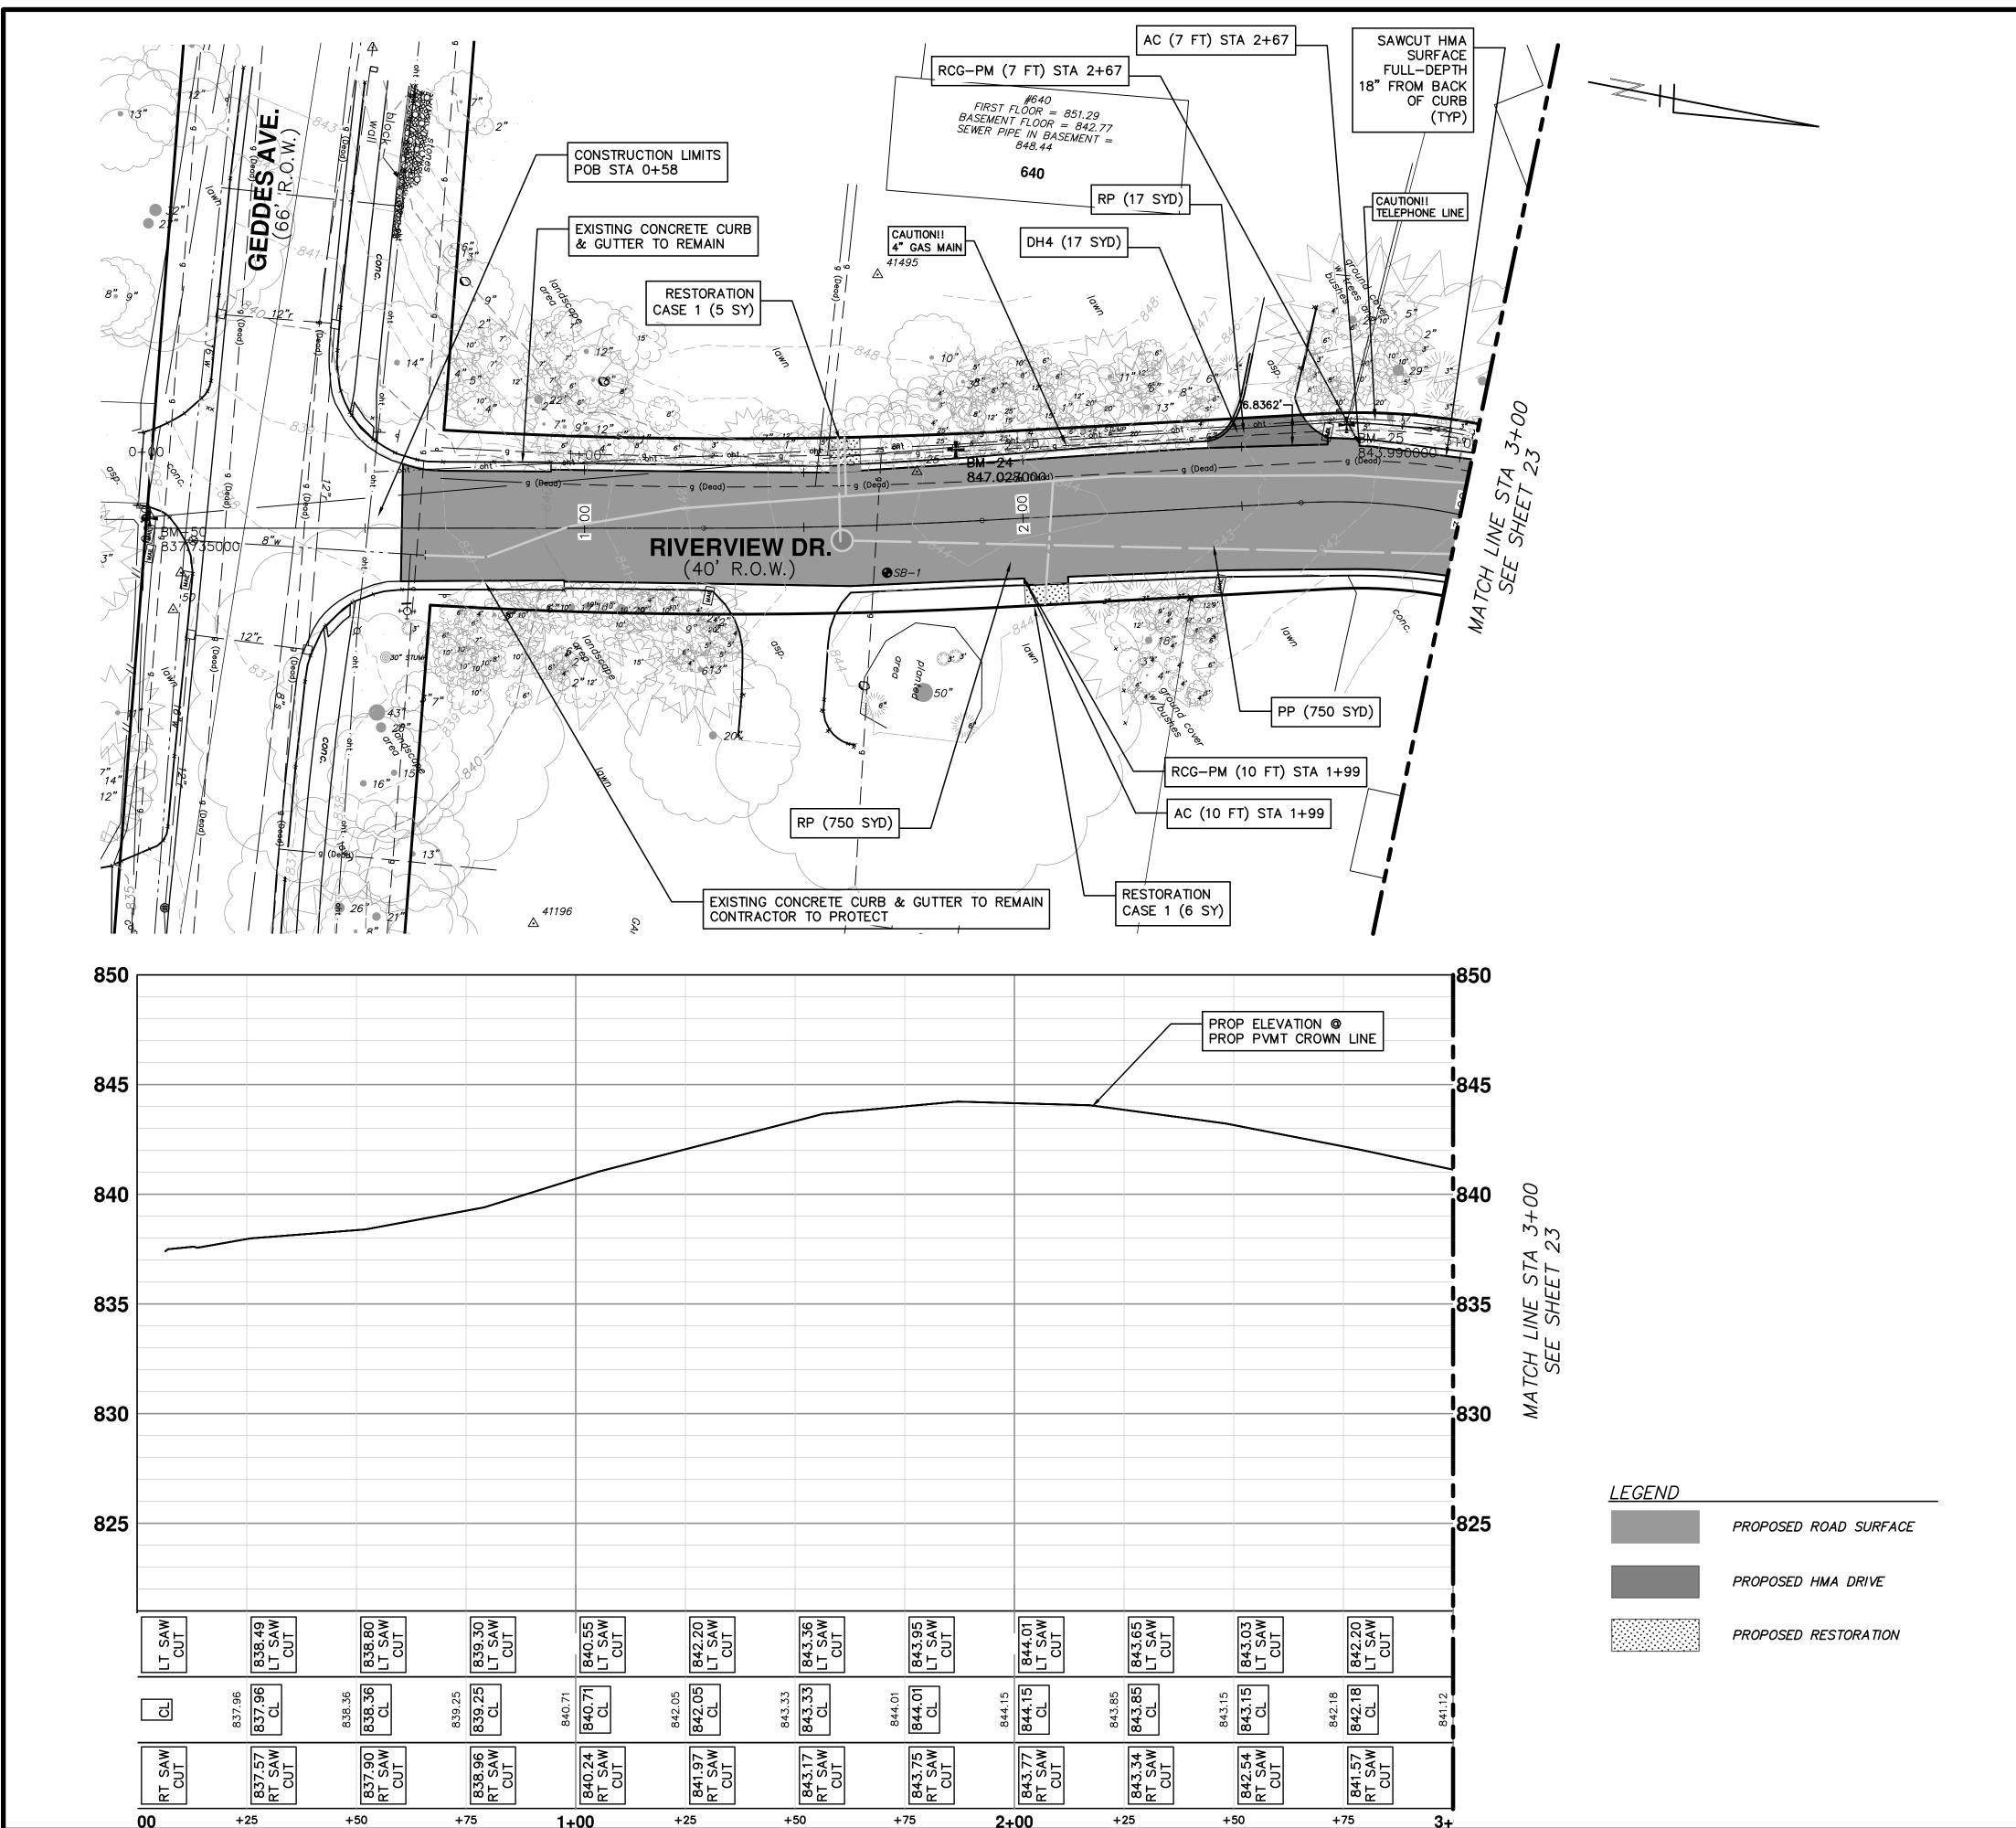

NOTES

- 1: SEE SOIL EROSION CONTROL SHEETS FOR DETAILS ON PLACEMENT, MAINTENANCE, AND REMOVAL OF EROSION CONTROL ITEMS.
- 2: SEE UTILITY SHEETS FOR WATER MAIN AND SANITARY STRUCTURE AND PIPE PLACEMENTS.
- 3: THE CONTRACTOR SHALL CAREFULLY PROTECT FROM DAMAGE OR INJURY DURING CONSTRUCTION OPERATIONS ALL UTILITIES NOT DESIGNATED FOR REMOVAL OR ABANDONMENT. PAYMENT FOR PROTECTION OF UTILITIES INCLUDED IN "GENERAL CONDITIONS, MAX____". EXISTING FACILITIES NOT DESIGNATED FOR REMOVAL OR ABANDONMENT BUT WHICH ARE DAMAGED BY THE CONTRACTORS OPERATION SHALL BE REPAIRED OR REPLACED BY THE CONTRACTOR AT HIS SOLE EXPENSE, AS DETERMINED BY THE ENGINEER.
- 4: THE EXISTING UTILITIES SHOWN ON THESE PLANS REPRESENT THE BEST INFORMATION AVAILABLE AS OBTAINED THROUGH SURVEYS AND/OR EXISTING PLANS. THIS INFORMATION DOES NOT RELIEVE THE CONTRACTOR OF THE RESPONSIBILITY TO BE SATISFIED AS TO ITS ACCURACY AND THE LOCATION OF EXISTING UTILITIES. IF STORM, SANITARY, OR WATER CROSS OTHER UTILITIES CONTACT THEIR RESPECTIVE OWNERS FOR INFORMATION ON HOW TO PROCEED. PAYMENT FOR COORDINATION EFFORTS, AND ASSOCIATED OTHER TASKS SHALL BE INCLUDED IN ASSOCIATED PROPOSED STORM, SANITARY, OR WATER MAIN ITEMS AND SHALL NOT BE PAID FOR SEPARATELY.
- WATER MAIN ITEMS AND SHALL NOT BE PAID FOR SEPARATELY.

 5: LANDSCAPING SHALL BE PROTECTED AT ALL TIMES. ANY DAMAGE TO LANDSCAPING OUTSIDE THE WORK ZONE SHALL BE REPAIRED AT THE CONTRACTORS EXPENSE AND NOT PAID FOR SEPARATELY.
- 6: THE EXISTING ASPHALT CURB AND IMMEDIATELY ADJACENT PAVEMENT IS TO REMAIN IN PLACE. SEE PLAN FOR LOCATIONS WHERE PORTIONS OF THE CURB AND PAVEMENT ARE BEING REMOVED AND REPLACED. ANY DAMAGE TO THE CURB AND PAVEMENT OTHER THAN WHAT IS CALLED FOR ON THE PLANS AND AS DIRECTED BY THE ENGINEER TO BE REMOVED SHALL BE REPLACED AT THE CONTRACTORS SOLE EXPENSE AND NOT PAID FOR SEPARATELY.
- 7: CONTRACTOR SHALL SAWCUT 18" FROM BACK OF EXISTING ASPHALT CURB FULL DEPTH FOR A CLEAN EDGE. PAVEMENT REMOVAL SHALL BE ACCORDING TO AREAS SHOWN ON PLANS. IF SAWED EDGE IS DAMAGED DURING CONSTRUCTION ACTIVITIES A CLEAN EDGE WILL BE RE-ESTABLISHED AND ALL ADDITIONAL HMA REQUIRED TO ACCOUNT FOR EDGE CHANGE SHALL BE THE CONTRACTORS EXPENSE AND NOT PAID FOR SEPARATELY.
- 8: CONTRACTOR MUST MAINTAIN ACCESS TO ALL DRIVEWAYS AT ALL TIMES DURING CONSTRUCTION. THIS SHALL BE INCLUDED IN THE ITEM OF WORK "GENERAL CONDITIONS, MAX.____" AND NOT PAID FOR SEPARATELY.
- 9: PAVEMENT REMOVAL SHALL OCCUR IN STAGES AS PART OF SANITARY AND WATER MAIN INSTALLATION. ALL COSTS NECESSARY TO PERFORM THE PAVEMENT REMOVAL IN A PART—WIDTH MANNER SHALL BE DEEMED TO BE INCLUDED IN THE ITEM OF WORK "HMA SURFACE, REM" AND SHALL NOT BE PAID FOR SEPARATELY.
- 10: AT THE CONCLUSION OF UNDERGROUND UTILITY CONSTRUCTION, AND IN ACCORDANCE WITH THE DIRECTION OF THE ENGINEER, THE CONTRACTOR SHALL REMOVE THE UPPERMOST 2" LAYER OF MAINTENANCE GRAVEL THAT HAS BEEN PLACED WITHIN THE ROADWAY FOR MAINTENANCE OF TRAFFIC PURPOSES IN ORDER TO REMOVE ALL CONSTRUCTION DEBRIS, TRENCH SPOILS, OR ANY OTHER DELETERIOUS MATERIALS THAT MAY EXIST IN ORDER TO PROVIDE A PROPER SURFACE FOR THE FINE GRADING OF THE AGGREGATE BASE COURSE. THE CONTRACTOR SHALL THEN AUGMENT THE REMAINING MAINTENANCE AGGREGATE WITH ADDITIONAL MAINTENANCE AGGREGATE MATERIAL IN ORDER TO BRING THE AGGREGATE BASE COURSE TO ITS FINAL GRADE. IF IT IS DETERMINED BY THE ENGINEER THAT THE ENTIRE MAINTENANCE AGGREGATE CROSS SECTION HAS BECOME EXCESSIVELY CONTAMINATED BY THE CONTRACTOR'S OPERATION, EXHIBITS SIGNS OF IMPROPER SUBGRADE SUPPORT, OR IS NOT USABLE FOR ANY OTHER REASON, IN THE SOLE OPINION OF THE ENGINEER, IT SHALL BE COMPLETELY REMOVED AND REPLACED AT NO ADDITIONAL COST TO THE PROJECT. THE CONTRACTOR SHALL THEN PROVIDE THE REQUIRED CROSS-SECTION OF AGGREGATE BASE COURSE MATERIAL AND PLACE. COMPACT, AND FINE GRADE IT IN ACCORDANCE WITH THE REQUIREMENTS OF THE CONTRACT. CONTRACT TIME SHALL CONTINUE THROUGHOUT THE ENTIRE AGGREGATE REMOVAL AND REPLACEMENT OPERATION IF IT IS DETERMINED BY THE ENGINEER TO BE NECESSARY. IT IS THE INTENT OF THE CITY THAT THE MAINTENANCE AGGREGATE MATERIAL BE RE-USED TO THE EXTENT PRACTICABLE AND ALLOWED BY THE CONTRACTOR'S OPERATIONS.

LEFT GRADE	STATION	RIGHT GRAD
3.1%	0+53	-3.6%
-1.2%	1+00	-3.7%
0.2%	1+50	-1.3%
-1.0%	2+00	-2.7%
-1.0%	2+50	-4.2%
-0.1%	3+00	-3.7%

* PROPOSED CROSS-SLOPES ARE RELATIVE TO CROWN ELEVATION

CONSTRUCTI	ON KEY
DH4 DC6 RCG–PM	PLACE 4" HMA DRIVE PLACE 6" CONCRETE DRIVE APPROACH REMOVE EXISTING ASPHALT CURB AND PAVEMENT CONCRETE GUTTER OR CONCRETE CURB — ANY TYPE
RP RI BO	REMOVE EXISTING PAVEMENT —ANY THICKNESS SAWCUT AT REMOVAL LIMITS (INCLUDE IN WORK ITEM "HMA SURFACE, REM") RELOCATE BY OWNER
RRST	REMOVE & REPLACE EXISTING STORM SEWER-SIZE AS SHOWN ON PLAN
PP	PLACE ASHPALT PAVEMENT—MATERIAL AND THICKNESS PER TYPICAL CROSS SECTION
AC	PLACE ASHPALT CURB

<u>RESTORATION</u>


CASE 1 — AREA TO BE RESTORED WITH 4—INCHES OF TOPSOIL, SEED AND MULCH BLANKET.



- CILL OF ANN ARBOR	0107///11	JIM	N N
TO CITY OF ANN ARBOR	10/30/2018	JW	NCM
WATER MAIN PERMIT (REV)	10/9/2018	ЫF	NCM
- CITY OF ANN ARBOR	2/28/2018	MF	NCM
TO CITY OF ANN ARBOR	2/23/2018	МF	NCM
DESCRIPTION	DATE	DRAWN	СНЕСКЕD

CITY OF ANN ARBOF PUBLIC SERVICES 301 EAST HURON STREE P.O. BOX 8647 ANN ARBOR, MI 48107-864 734-794-6410 www.a2gov.org

09 08 09 09

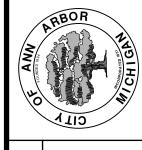

RIVERVICES - ENGINEERING
RIVERVIEW DRIVE SANITARY SEWER
AND WATER MAIN EXTENSION PROJECT
PROPOSED PAVING STA 0+00 TO STA 3+00


CITY OF ANN ARBOR - PI

CALE PLAN: 1" = 20' PROFILE: 1" = 4'

RAWING NO.

SHEET No.

22 OF 30

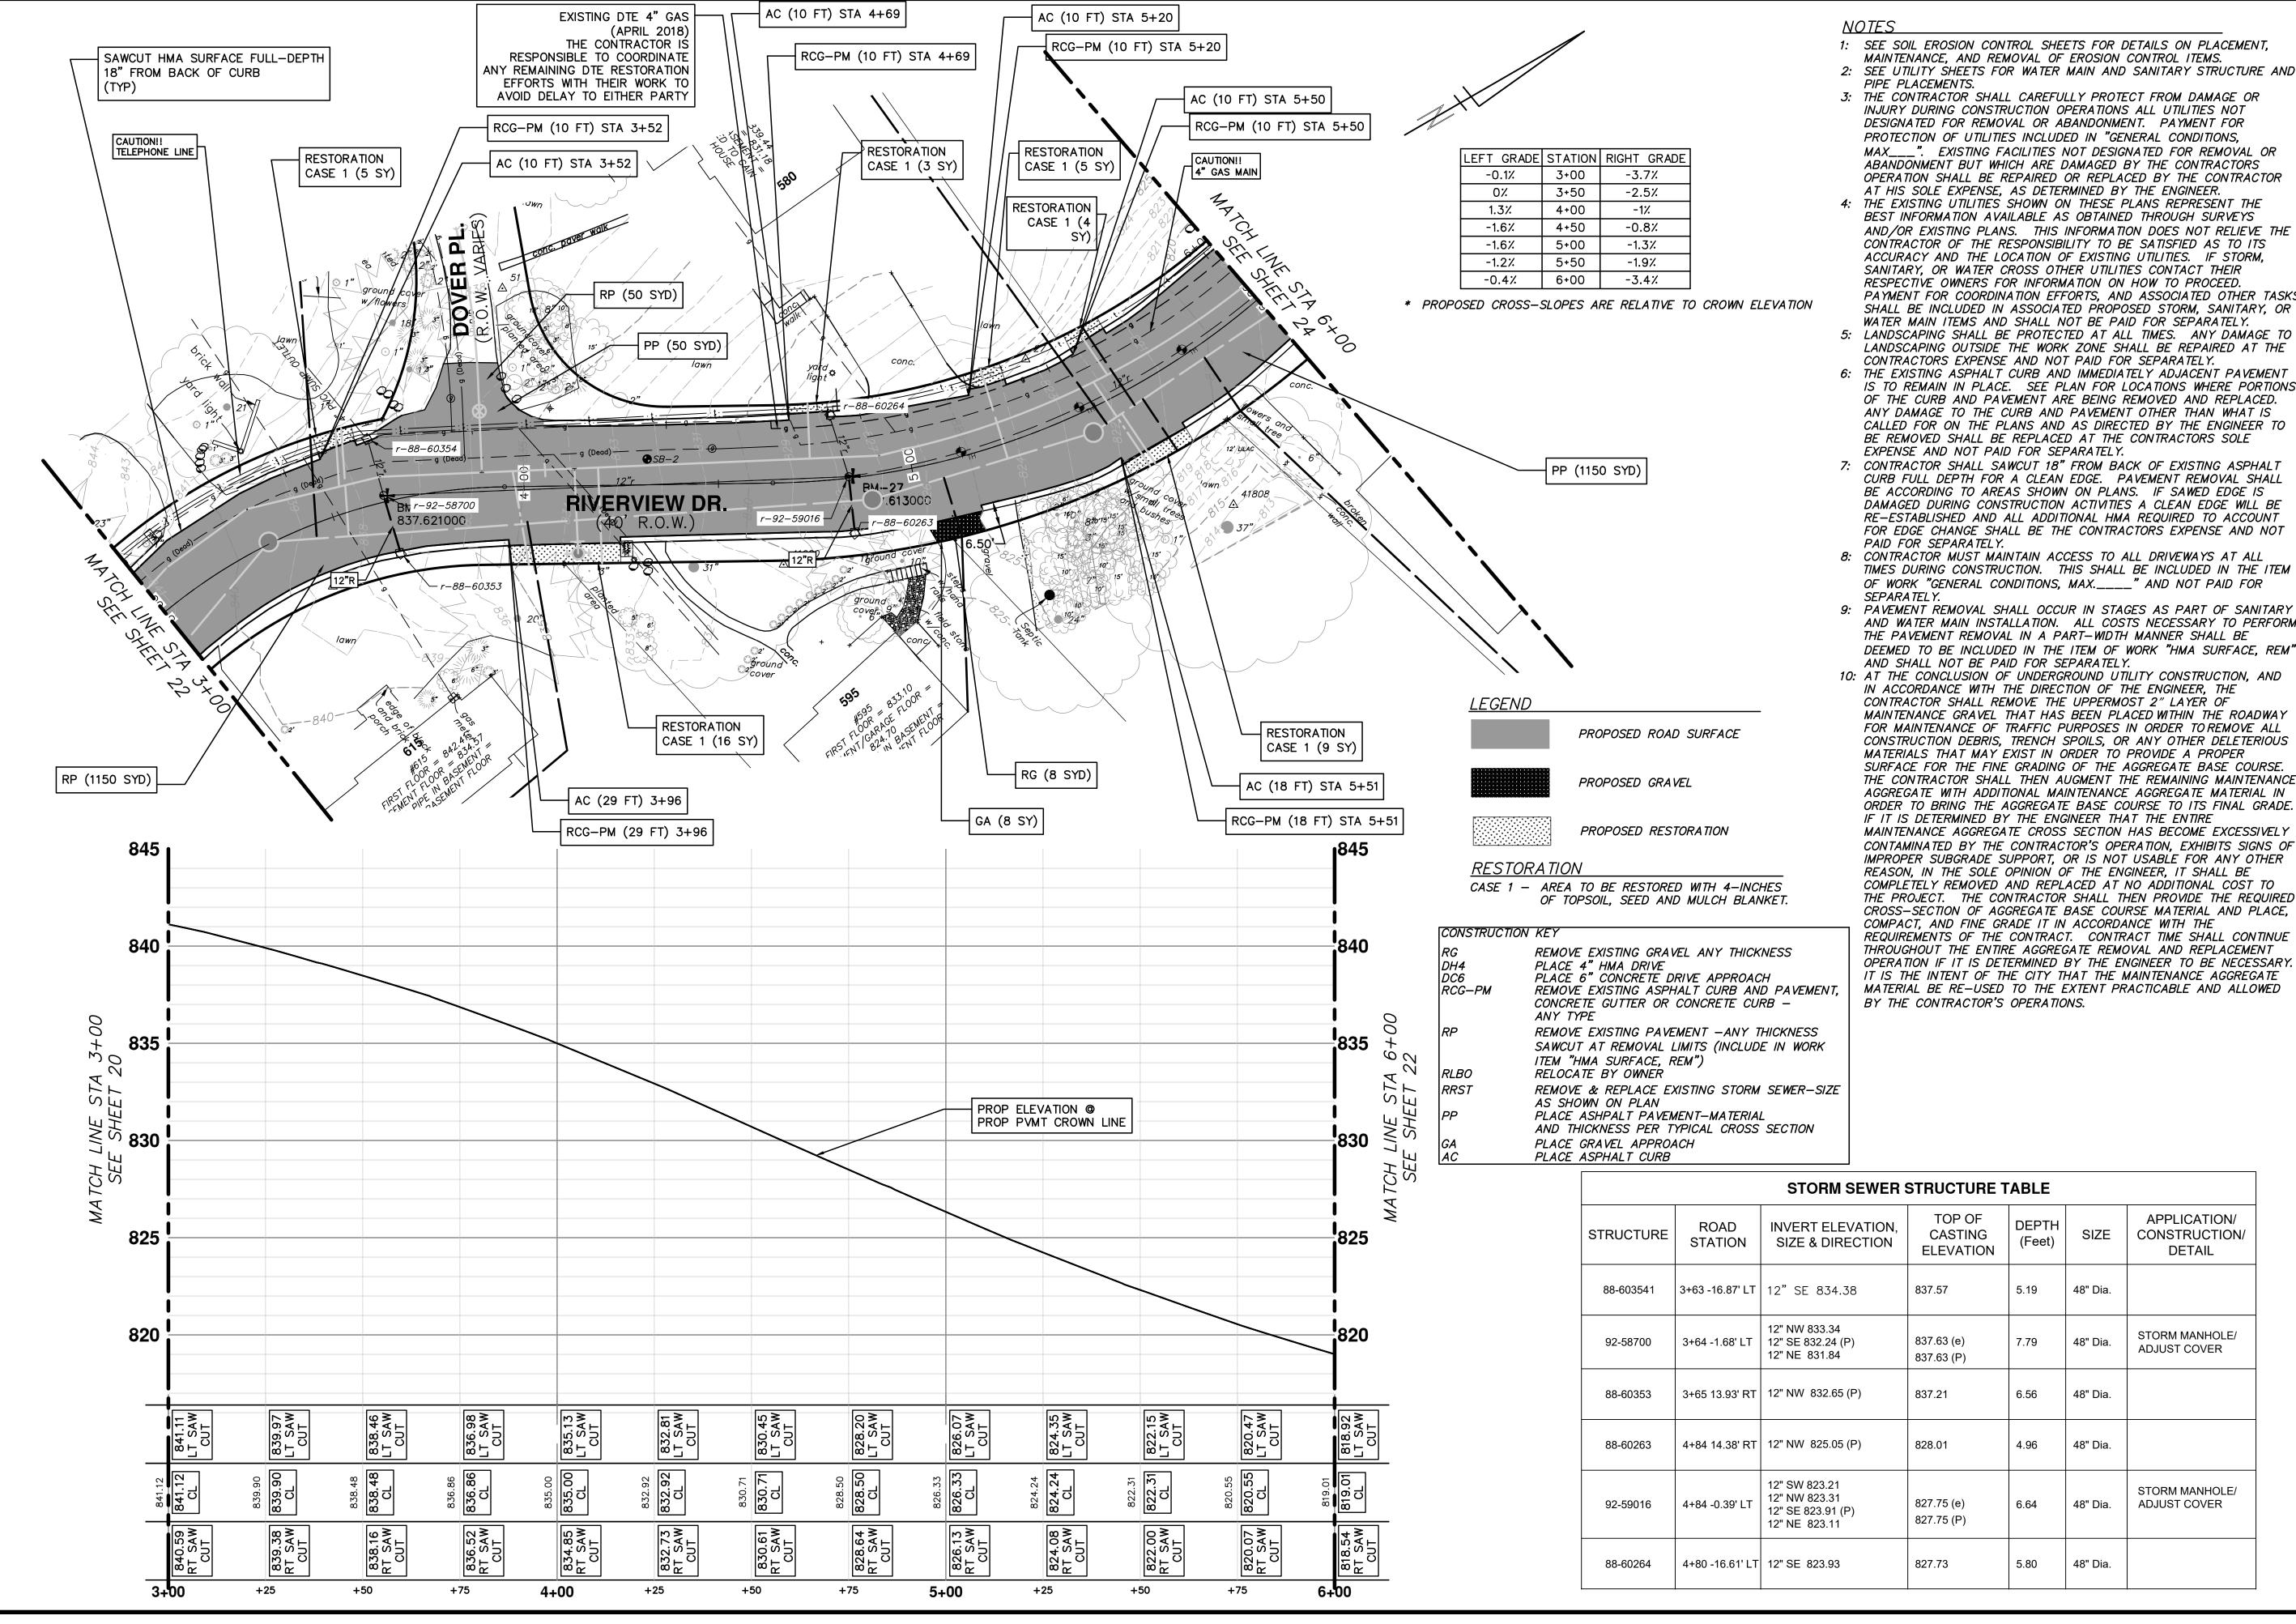

2: SEE UTILITY SHEETS FOR WATER MAIN AND SANITARY STRUCTURE AND

AND/OR EXISTING PLANS. THIS INFORMATION DOES NOT RELIEVE THE PAYMENT FOR COORDINATION EFFORTS, AND ASSOCIATED OTHER TASKS SHALL BE INCLUDED IN ASSOCIATED PROPOSED STORM, SANITARY, OR 5: LANDSCAPING SHALL BE PROTECTED AT ALL TIMES. ANY DAMAGE TO

LANDSCAPING OUTSIDE THE WORK ZONE SHALL BE REPAIRED AT THE


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TIMES DURING CONSTRUCTION. THIS SHALL BE INCLUDED IN THE ITEM

AND WATER MAIN INSTALLATION. ALL COSTS NECESSARY TO PERFORM DEEMED TO BE INCLUDED IN THE ITEM OF WORK "HMA SURFACE, REM"

10: AT THE CONCLUSION OF UNDERGROUND UTILITY CONSTRUCTION, AND MAINTENANCE GRAVEL THAT HAS BEEN PLACED WITHIN THE ROADWAY FOR MAINTENANCE OF TRAFFIC PURPOSES IN ORDER TO REMOVE ALL CONSTRUCTION DEBRIS, TRENCH SPOILS, OR ANY OTHER DELETERIOUS SURFACE FOR THE FINE GRADING OF THE AGGREGATE BASE COURSE. THE CONTRACTOR SHALL THEN AUGMENT THE REMAINING MAINTENANCE AGGREGATE WITH ADDITIONAL MAINTENANCE AGGREGATE MATERIAL IN ORDER TO BRING THE AGGREGATE BASE COURSE TO ITS FINAL GRADE. MAINTENANCE AGGREGATE CROSS SECTION HAS BECOME EXCESSIVELY CONTAMINATED BY THE CONTRACTOR'S OPERATION, EXHIBITS SIGNS OF IMPROPER SUBGRADE SUPPORT, OR IS NOT USABLE FOR ANY OTHER COMPLETELY REMOVED AND REPLACED AT NO ADDITIONAL COST TO THE PROJECT. THE CONTRACTOR SHALL THEN PROVIDE THE REQUIRED CROSS-SECTION OF AGGREGATE BASE COURSE MATERIAL AND PLACE, REQUIREMENTS OF THE CONTRACT. CONTRACT TIME SHALL CONTINUE THROUGHOUT THE ENTIRE AGGREGATE REMOVAL AND REPLACEMENT OPERATION IF IT IS DETERMINED BY THE ENGINEER TO BE NECESSARY. IT IS THE INTENT OF THE CITY THAT THE MAINTENANCE AGGREGATE MATERIAL BE RE-USED TO THE EXTENT PRACTICABLE AND ALLOWED


ANS - CITY OF ANN ARBOR	11/7/2018	MF	MOV
EVIEW TO CITY OF ANN ARBOR	10/30/2018	ЫF	MOV
Y AND WATER MAIN PERMIT (REV)	10/9/2018	MF	NOM
ANS - CITY OF ANN ARBOR	2/28/2018	MF	NON
EVIEW TO CITY OF ANN ARBOR	2/23/2018	MF	NON
DESCRIPTION	DATE	DRAWN	DRAWN CHECKED

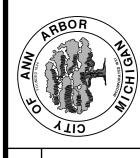



SEWER PROJEC RIVERVIEW DRIVE SANITARY
AND WATER MAIN EXTENSION
PROPOSED PAVING STA 3+00 TO STA - PUBLIC SERVICES

ARBOR PROFILE: 1" = 4" ANA CITY

SHEET No.

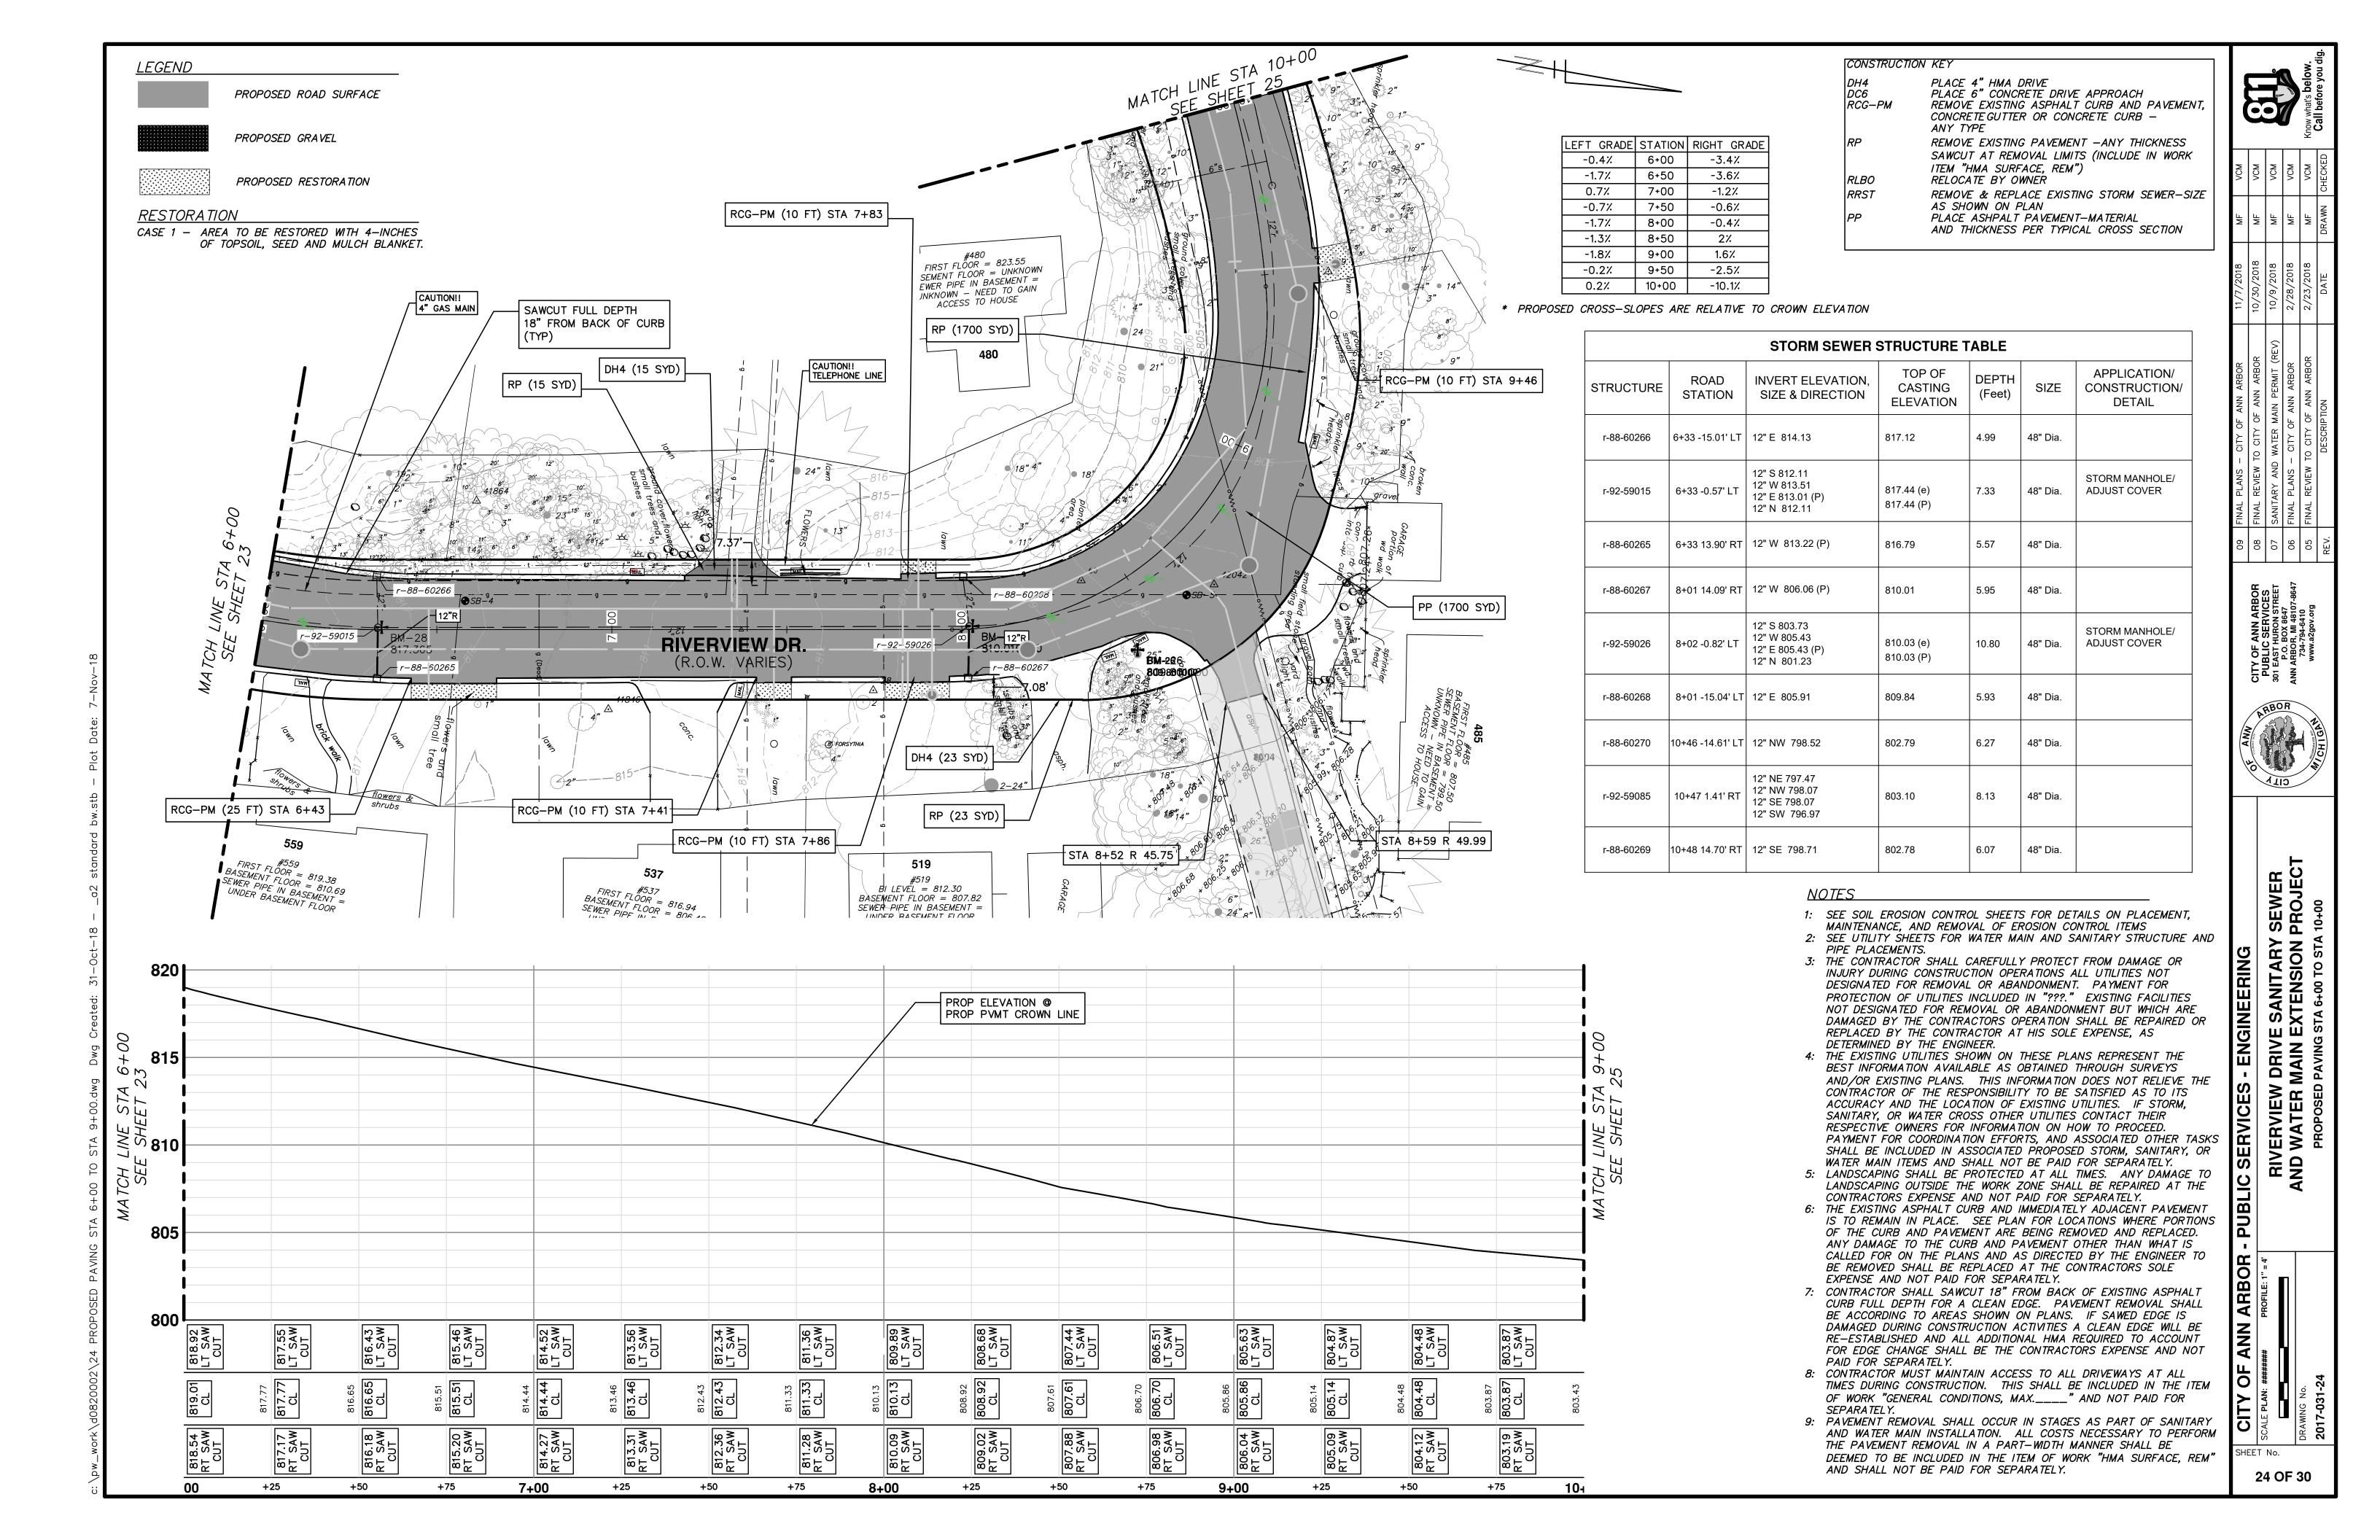

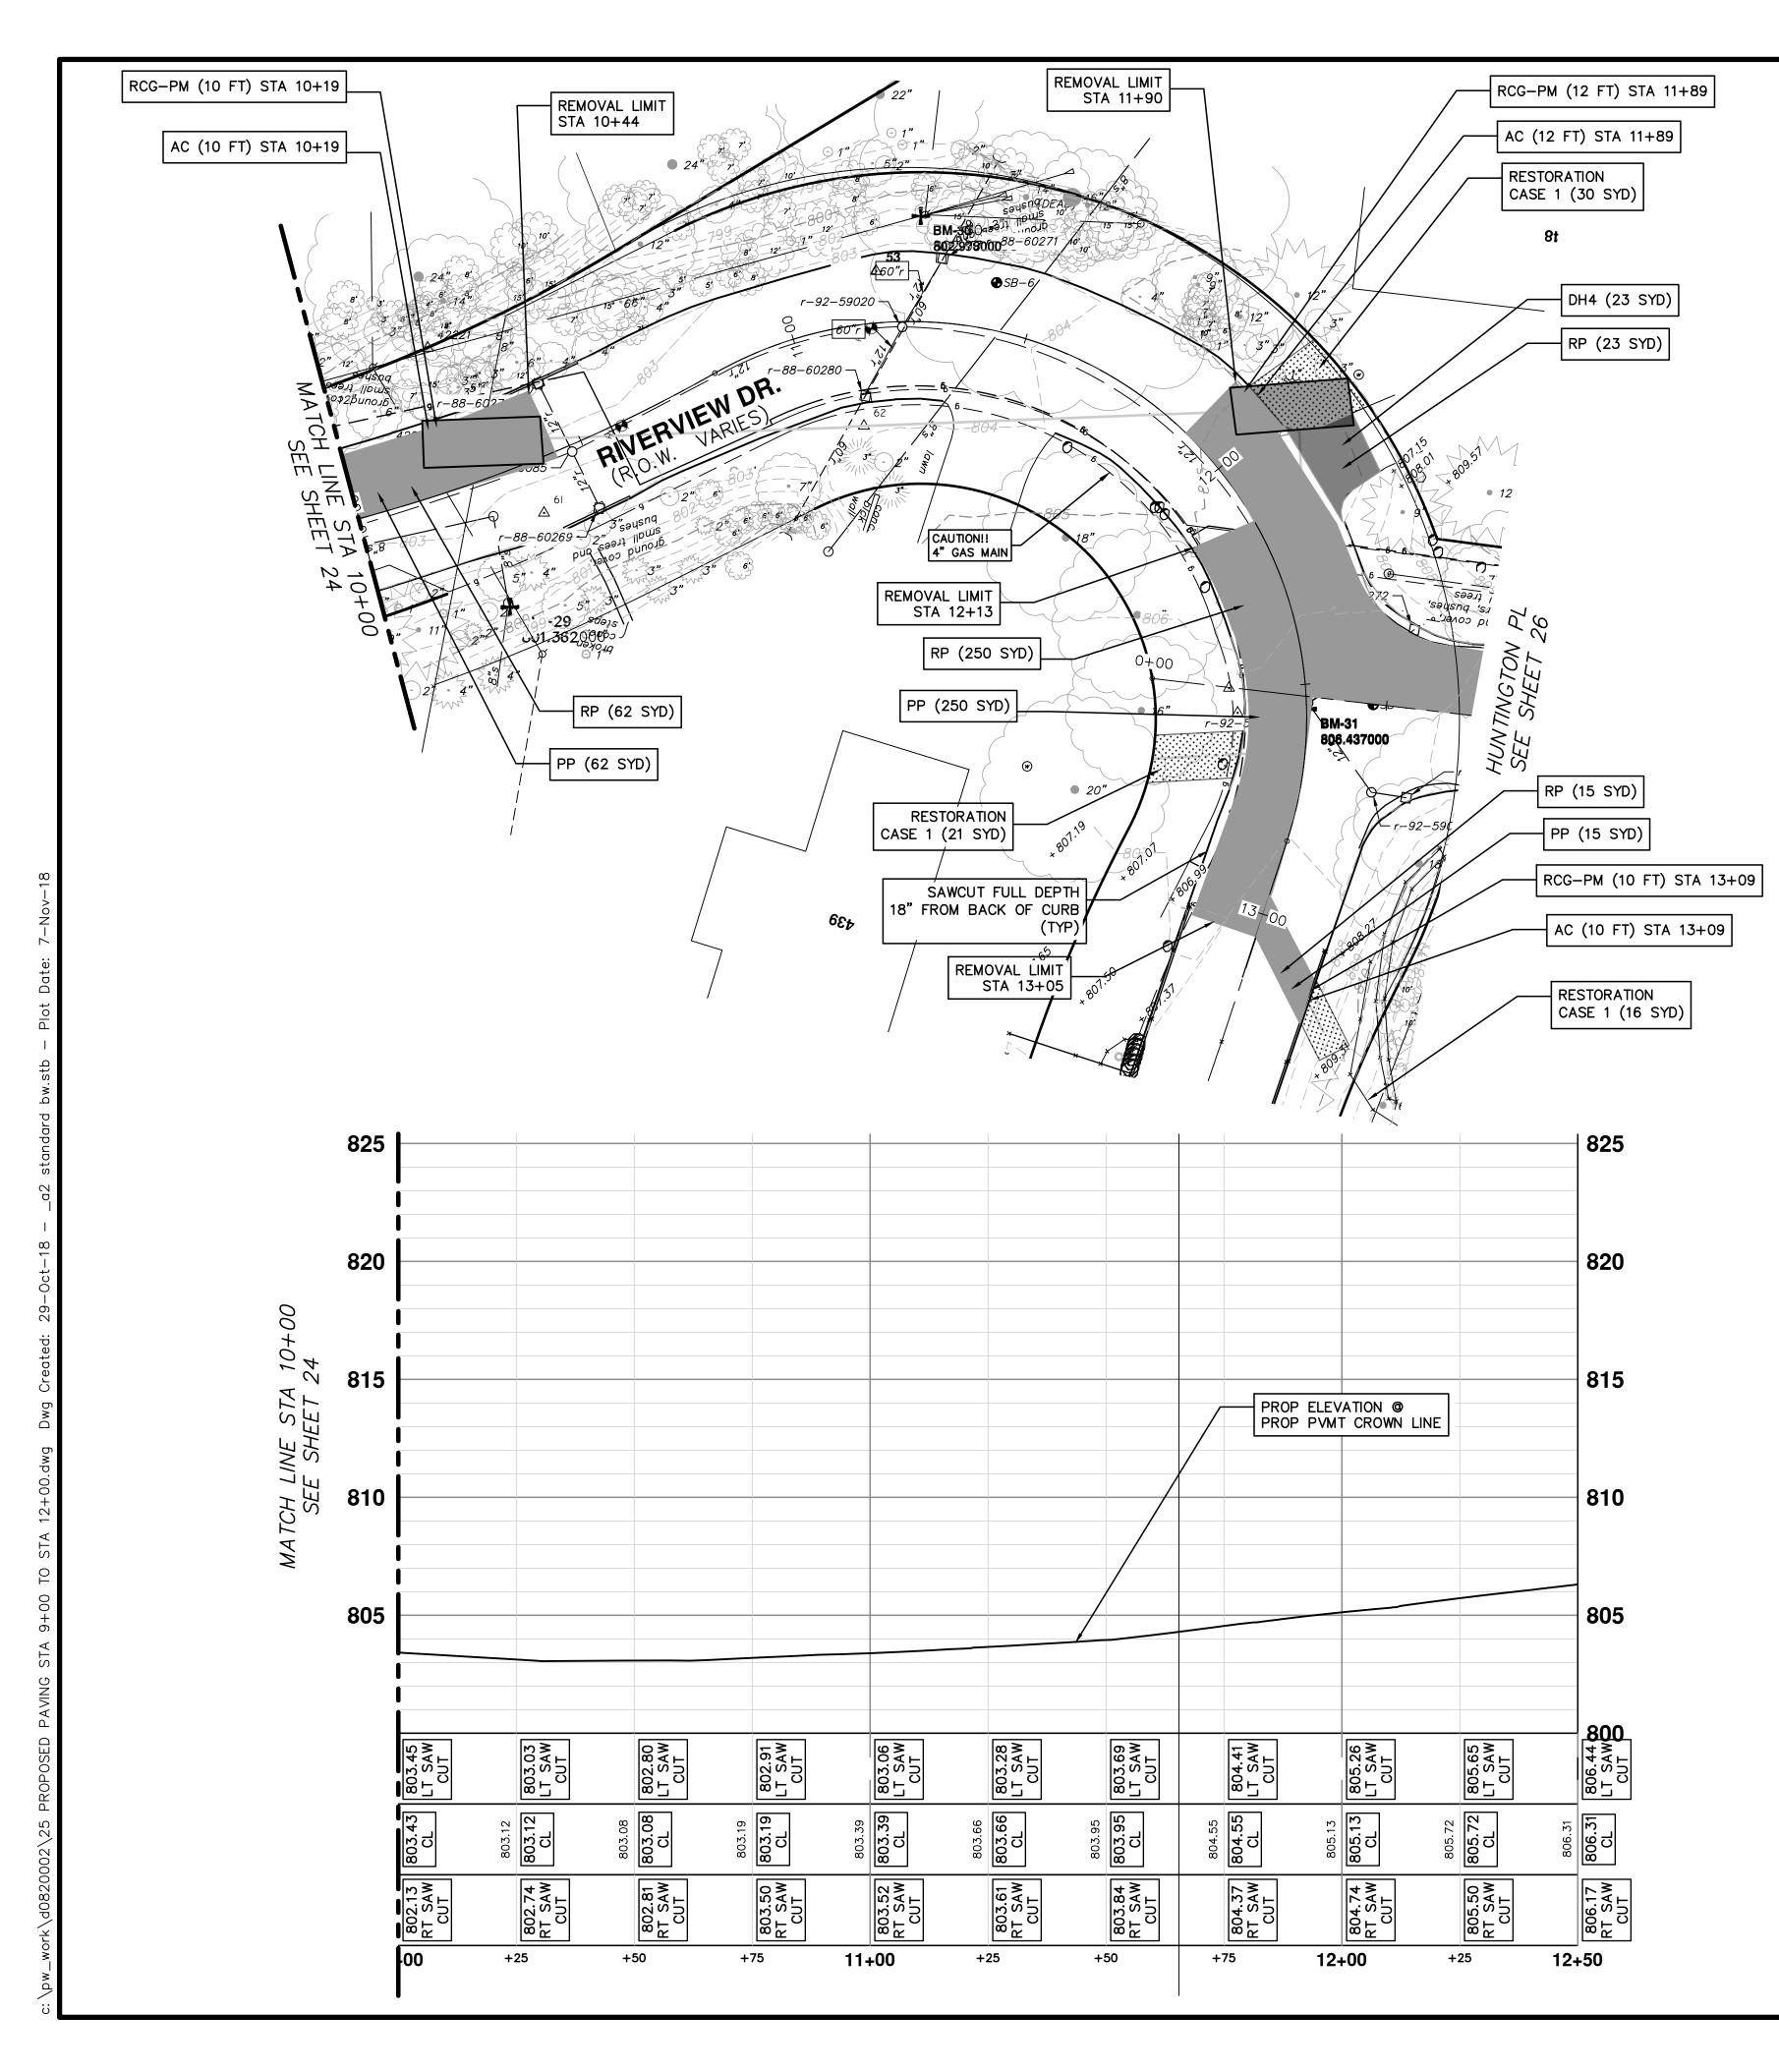

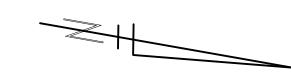

LEFT GRADE	STATION	RIGHT GRADE
0.9%	12+00	
1.0%	12+50	-0.9%
	13+00	-3.6%

* PROPOSED CROSS-SLOPES ARE RELATIVE TO CROWN ELEVATION



PROPOSED ROAD SURFACE



PROPOSED GRAVEL



PROPOSED RESTORATION

RESTORATION

CASE 1 - AREA TO BE RESTORED WITH 4-INCHES OF TOPSOIL, SEED AND MULCH BLANKET.

CONSTRUCTION KEY

RG	REMOVE EXISTING GRAVEL ANY THICKNESS
DH4	PLACE 4" HMA DRIVE
DC6	PLACE 6" CONCRETE DRIVE APPROACH
RCG-PM	REMOVE EXISTING ASPHALT CURB AND PAVEMENT,
	CONCRETE GUTTER OR CONCRETE CURB —
	ANY TYPE
<i>RP</i>	REMOVE EXISTING PAVEMENT —ANY THICKNESS

SAWCUT AT REMOVAL LIMITS (INCLUDE IN WORK

ITEM "HMA SURFACE, REM") *RLBO* RELOCATE BY OWNER RRST REMOVE & REPLACE EXISTING STORM SEWER-SIZE AS SHOWN ON PLAN

PLACE ASHPALT PAVEMENT-MATERIAL AND THICKNESS PER TYPICAL CROSS SECTION PLACE GRAVEL APPROACH PLACE ASPHALT CURB

NOTES


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JDM	SE/W	ED 6.	TDI IC	THE	TABLE
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		STORM SEWER	STRUCTURE T	ABLE		
STRUCTURE	ROAD STATION	INVERT ELEVATION, SIZE & DIRECTION	TOP OF CASTING ELEVATION	DEPTH (Feet)	SIZE	APPLICATION/ CONSTRUCTION/ DETAIL
88-60270	10+46 -14.28' LT	12" N 798.52	802.72	4.20	24" Dia.	
92-59085	10+47 1.44' RT	12" N 798.07 12" E 797.47 12" S 798.07 12" W 796.97	802.97	6.00	48" Dia.	
88-60269	10+48 14.67' RT	12" S 798.71	802.81	4.10	24" Dia.	
88-60271	11+31 -13.77' LT	12" N 792.06	803.16	11.10	24" Dia.	
92-59020	11+23 0.92' RT	12" N 791.80 12" E 796.30 12" S 791.80 12" W 795.50	803.60	11.80	48" Dia.	
88-60280	11+74 15.21' RT	12" S 791.69	803.29	11.60	24" Dia.	




CIT OF ANN ARBOR	0107///11	MIL	NO _A
TO CITY OF ANN ARBOR	10/30/2018	JW	NON
WATER MAIN PERMIT (REV)	10/9/2018	JW	NOM
CITY OF ANN ARBOR	2/28/2018	ЫF	NON
TO CITY OF ANN ARBOR	2/23/2018	JW	NON
DESCRIPTION	DATE	DRAWN	СНЕСКЕВ



RIVERVIEW DRIVE SANITARY SEWEF AND WATER MAIN EXTENSION PROJECT PROPOSED PAVING STA 10+00 TO STA 13+00 - ENGINEERING

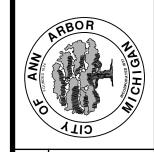ANN ARBOR

SHEET No. 25 OF 30

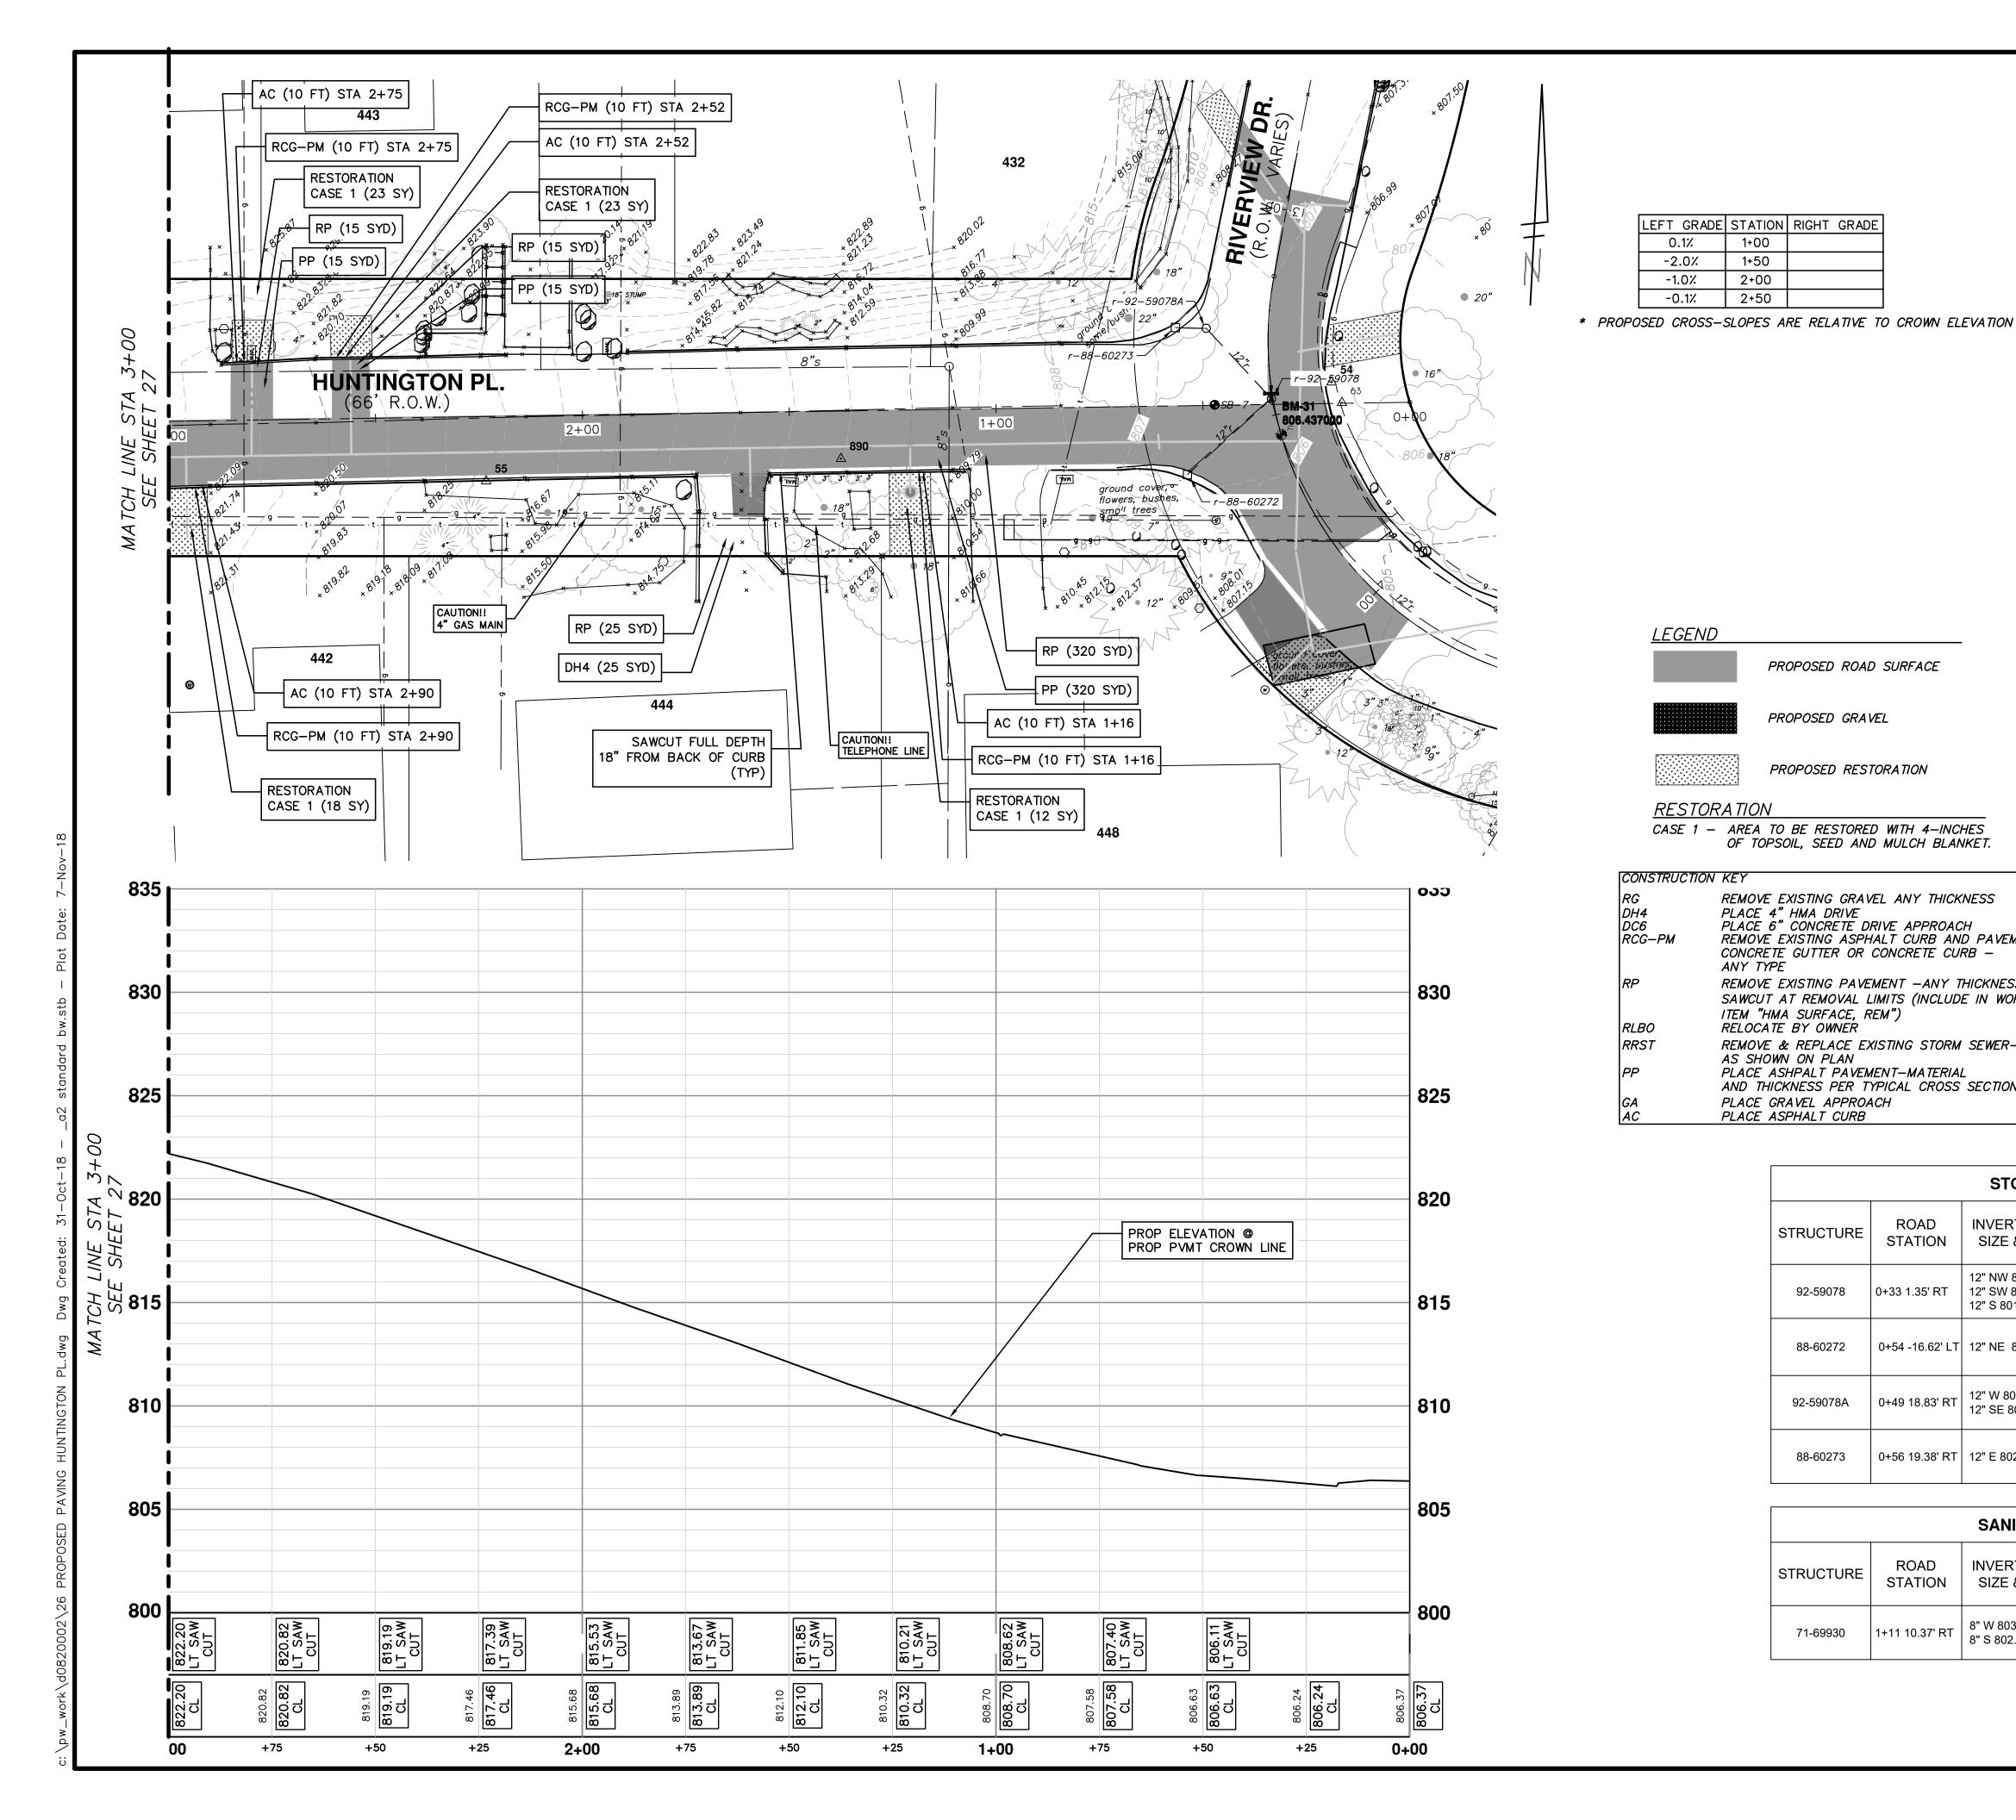

NOTES

LEFT GRADE STATION RIGHT GRADE

1+00

1+50

2+00

2+50

PROPOSED ROAD SURFACE

PROPOSED RESTORATION

OF TOPSOIL, SEED AND MULCH BLANKET.

REMOVE EXISTING GRAVEL ANY THICKNESS

CONCRETE GUTTER OR CONCRETE CURB -

REMOVE EXISTING ASPHALT CURB AND PAVEMENT,

REMOVE EXISTING PAVEMENT -ANY THICKNESS

AND THICKNESS PER TYPICAL CROSS SECTION

SAWCUT AT REMOVAL LIMITS (INCLUDE IN WORK

REMOVE & REPLACE EXISTING STORM SEWER-SIZE

PLACE 6" CONCRETE DRIVE APPROACH

PLACE ASHPALT PAVEMENT-MATERIAL

PROPOSED GRAVEL

CASE 1 - AREA TO BE RESTORED WITH 4-INCHES

PLACE 4" HMA DRIVE

ITEM "HMA SURFACE. REM")

PLACE GRAVEL APPROACH

RELOCATE BY OWNER

AS SHOWN ON PLAN

PLACE ASPHALT CURB

ANY TYPE

-2.0%

-1.0%

-0.1%

LEGEND

RESTORATION

CONSTRUCTION KEY

DC6 RCG-PM

RRST

- 1: SEE SOIL EROSION CONTROL SHEETS FOR DETAILS ON PLACEMENT, MAINTENANCE, AND REMOVAL OF EROSION CONTROL ITEMS.
- 2: SEE UTILITY SHEETS FOR WATER MAIN AND SANITARY STRUCTURE AND PIPE PLACEMENTS.
- 3: THE CONTRACTOR SHALL CAREFULLY PROTECT FROM DAMAGE OR INJURY DURING CONSTRUCTION OPERATIONS ALL UTILITIES NOT DESIGNATED FOR REMOVAL OR ABANDONMENT. PAYMENT FOR PROTECTION OF UTILITIES INCLUDED IN "GENERAL CONDITIONS, MAX____". EXISTING FACILITIES NOT DESIGNATED FOR REMOVAL OR ABANDONMENT BUT WHICH ARE DAMAGED BY THE CONTRACTORS OPERATION SHALL BE REPAIRED OR REPLACED BY THE CONTRACTOR AT HIS SOLE EXPENSE, AS DETERMINED BY THE ENGINEER.
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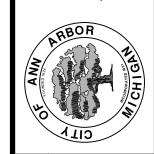
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	STORM SEWER STRUCTURE TABLE						
STRUCTURE	ROAD STATION	INVERT ELEVATION, SIZE & DIRECTION	TOP OF CASTING ELEVATION	DEPTH (Feet)	SIZE	APPLICATION/ CONSTRUCTION/ DETAIL	
92-59078	0+33 1.35' RT	12" NW 801.78 12" SW 802.03 12" S 801.28	806.43	5.15	48" Dia.		
88-60272	0+54 -16.62' LT	12" NE 802.43	806.03	5.60	48" Dia.		
92-59078A	0+49 18.83' RT	12" W 802.22 12" SE 802.02	806.77 (e) 806.77 (P)	4.75	48" Dia.	STORM MANHOLE/ ADJUST COVER	
88-60273	0+56 19.38' RT	12" E 802.45	806.65	6.20	48" Dia.		

	SANITARY SEWER STRUCTURE TABLE					
STRUCTURE	ROAD STATION	INVERT ELEVATION, SIZE & DIRECTION	TOP OF CASTING ELEVATION	DEPTH (Feet)	SIZE	APPLICATION/ CONSTRUCTION/ DETAIL
71-69930	1+11 10.37' RT	8" W 803.11 8" S 802.01	809.41	7.40	48" Dia.	



TY OF ANN ARBOR	10/30/2018	MF	NCM	
ER MAIN PERMIT (REV)	10/9/2018	MF	NCM	
OF ANN ARBOR	2/28/2018	MF	NCM	
TY OF ANN ARBOR	2/23/2018	MF	NCM	준,
CRIPTION	DATE	DRAWN	CHECKED	




RIVERVIEW DRIVE SANITARY SEWER AND WATER MAIN EXTENSION PROJECTOPOSED PAVING HUNTINGTON PLACE STA 0+00 TO STA

- PUBLIC SERVICES - ENGINEERING

ANN ARBOR CITY OF

SHEET No.

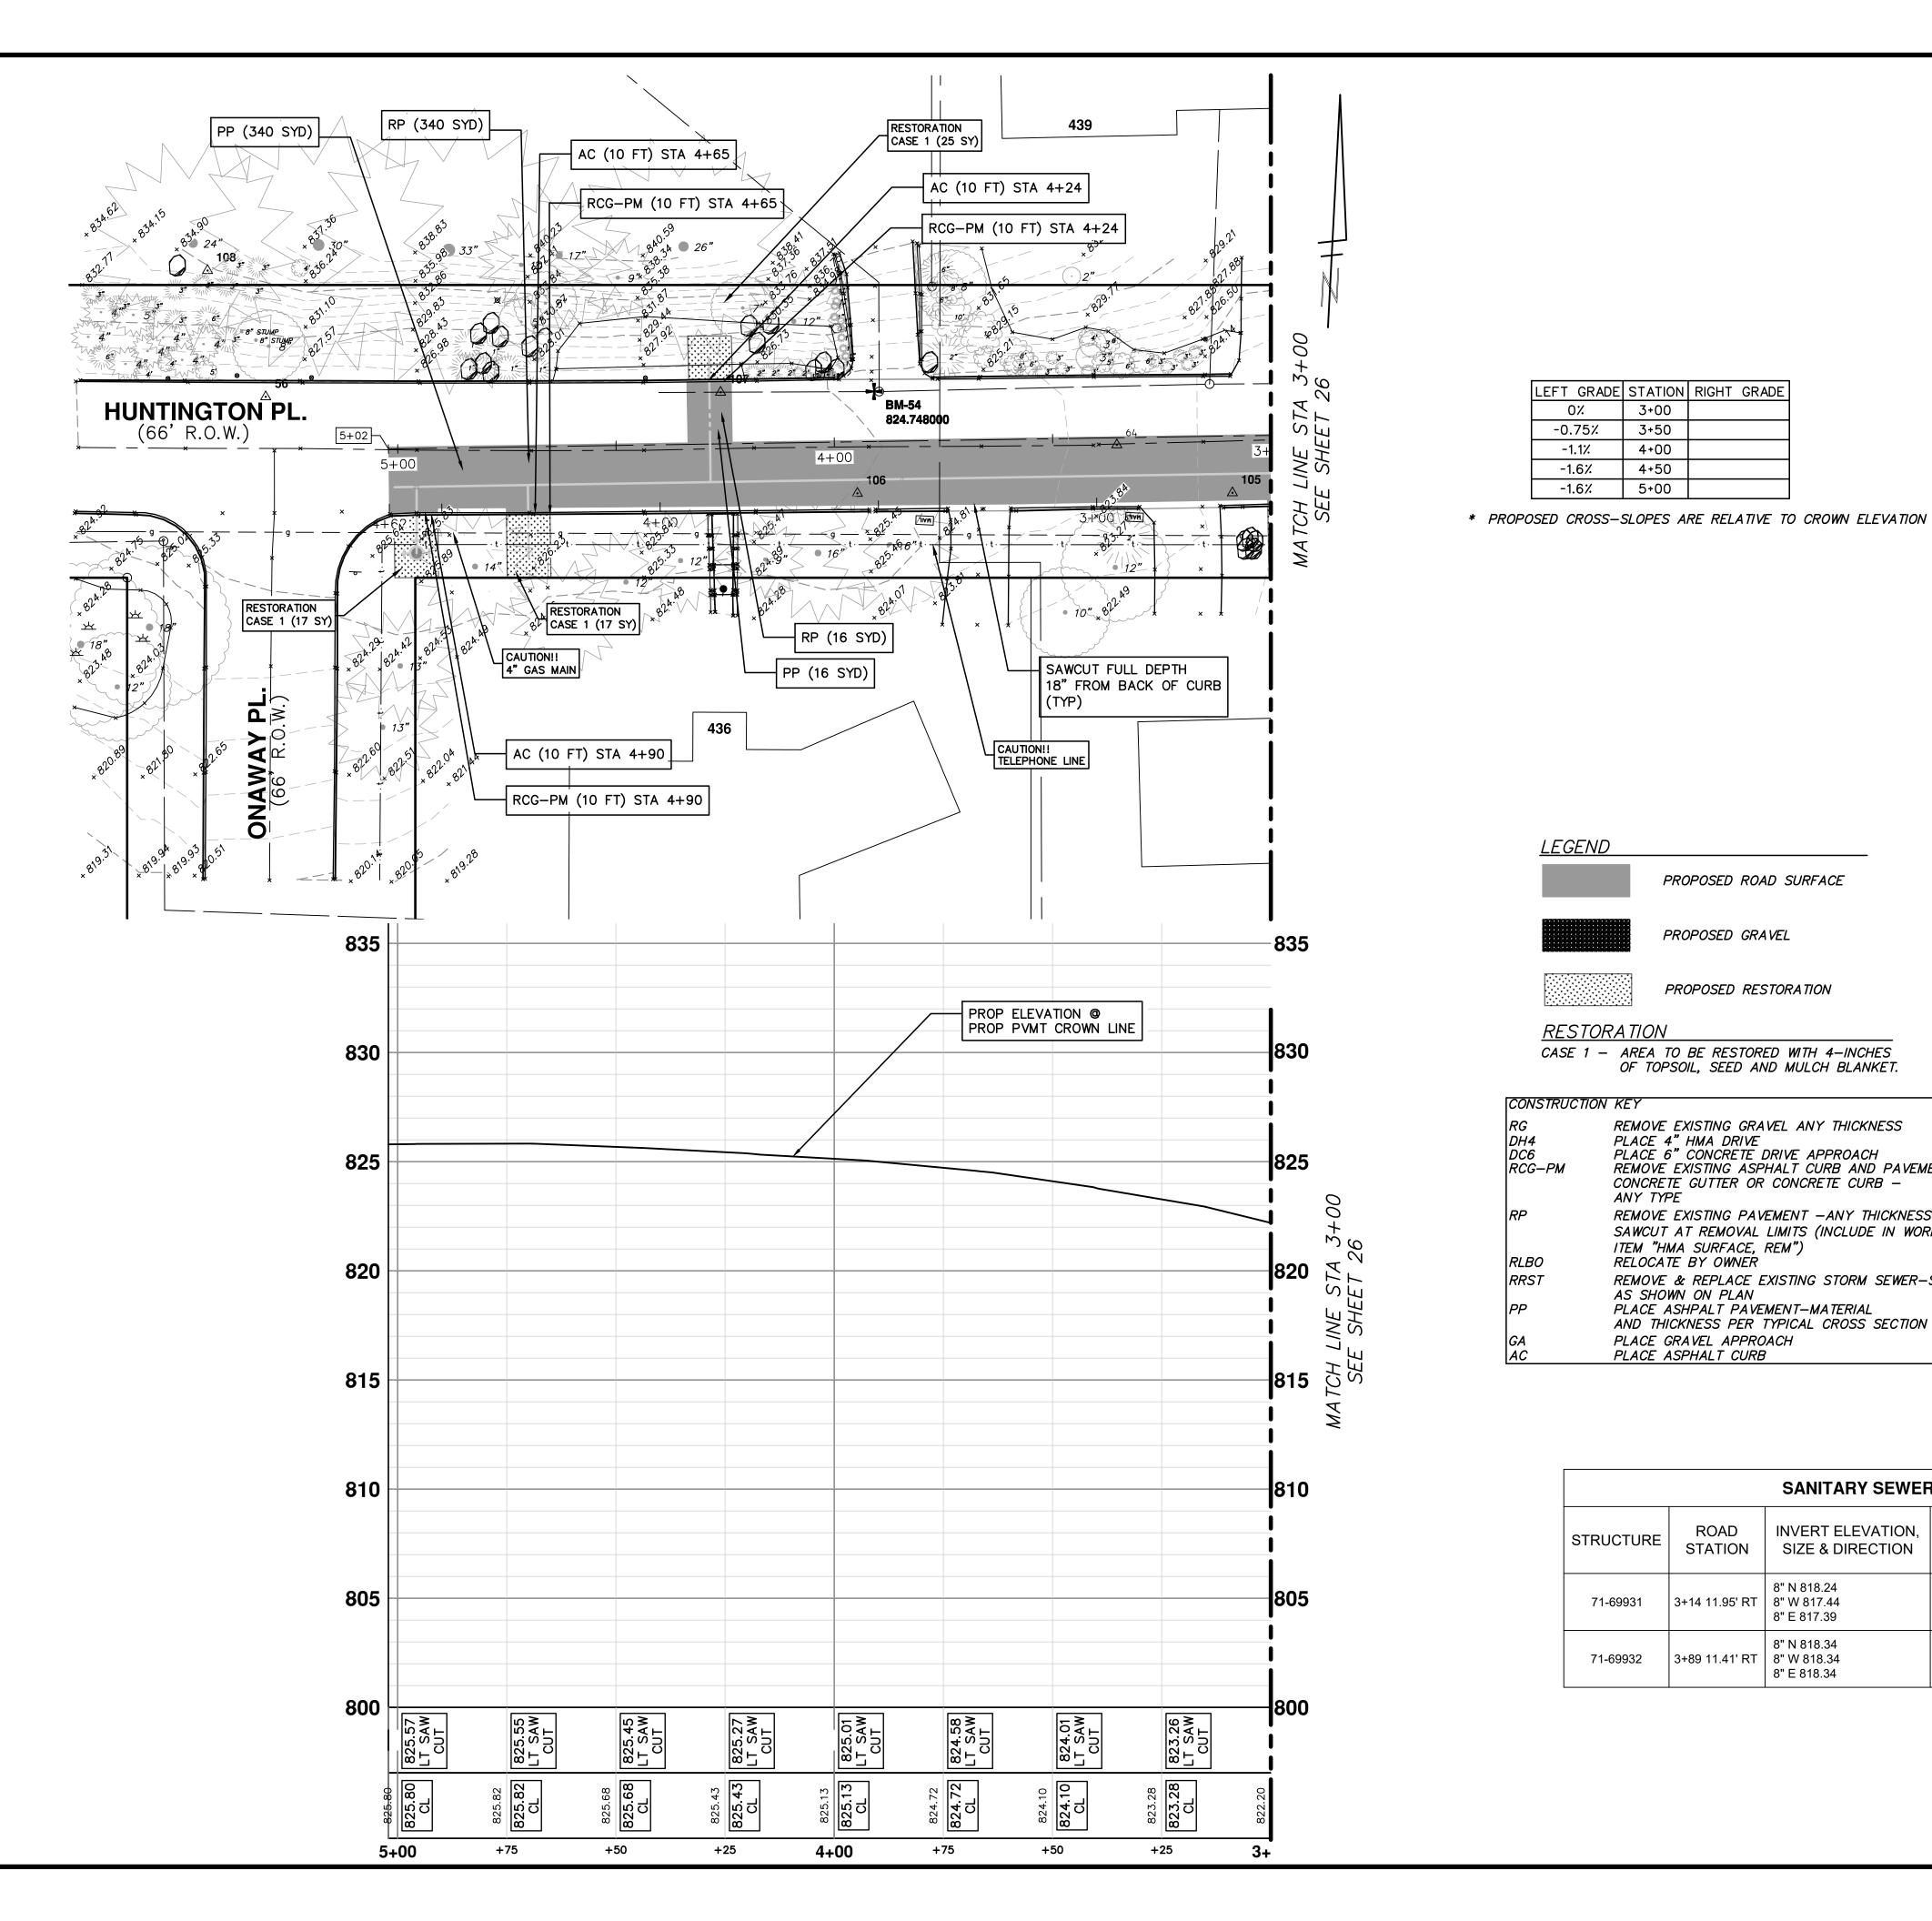

NOTES

LEFT GRADE STATION RIGHT GRADE

3+00

3+50

4+00

4+50

5+00

PROPOSED ROAD SURFACE

PROPOSED RESTORATION

OF TOPSOIL, SEED AND MULCH BLANKET.

REMOVE EXISTING GRAVEL ANY THICKNESS

CONCRETE GUTTER OR CONCRETE CURB -

REMOVE EXISTING PAVEMENT -ANY THICKNESS SAWCUT AT REMOVAL LIMITS (INCLUDE IN WORK

REMOVE & REPLACE EXISTING STORM SEWER-SIZE

AND THICKNESS PER TYPICAL CROSS SECTION

3+89 11.41' RT | 8" W 818.34

8" E 818.34

PLACE 6" CONCRETE DRIVE APPROACH

PLACE ASHPALT PAVEMENT-MATERIAL

PROPOSED GRAVEL

CASE 1 - AREA TO BE RESTORED WITH 4-INCHES

PLACE 4" HMA DRIVE

ITEM "HMA SURFACE, REM")

PLACE GRAVEL APPROACH PLACE ASPHALT CURB

RELOCATE BY OWNER

AS SHOWN ON PLAN

ANY TYPE

71-69932

0%

-0.75%

-1.1%

-1.6%

-1.6%

LEGEND

RESTORATION

CONSTRUCTION KEY

DH4 DC6 RCG-PM

RLBO

RRST

- 1: SEE SOIL EROSION CONTROL SHEETS FOR DETAILS ON PLACEMENT, MAINTENANCE, AND REMOVAL OF EROSION CONTROL ITEMS.
- 2: SEE UTILITY SHEETS FOR WATER MAIN AND SANITARY STRUCTURE AND PIPE PLACEMENTS.
- 3: THE CONTRACTOR SHALL CAREFULLY PROTECT FROM DAMAGE OR INJURY DURING CONSTRUCTION OPERATIONS ALL UTILITIES NOT DESIGNATED FOR REMOVAL OR ABANDONMENT. PAYMENT FOR PROTECTION OF UTILITIES INCLUDED IN "GENERAL CONDITIONS, MAX____". EXISTING FACILITIES NOT DESIGNATED FOR REMOVAL OR ABANDONMENT BUT WHICH ARE DAMAGED BY THE CONTRACTORS OPERATION SHALL BE REPAIRED OR REPLACED BY THE CONTRACTOR AT HIS SOLE EXPENSE, AS DETERMINED BY THE ENGINEER.
- 4: THE EXISTING UTILITIES SHOWN ON THESE PLANS REPRESENT THE BEST INFORMATION AVAILABLE AS OBTAINED THROUGH SURVEYS AND/OR EXISTING PLANS. THIS INFORMATION DOES NOT RELIEVE THE CONTRACTOR OF THE RESPONSIBILITY TO BE SATISFIED AS TO ITS ACCURACY AND THE LOCATION OF EXISTING UTILITIES. IF STORM, SANITARY, OR WATER CROSS OTHER UTILITIES CONTACT THEIR RESPECTIVE OWNERS FOR INFORMATION ON HOW TO PROCEED. PAYMENT FOR COORDINATION EFFORTS, AND ASSOCIATED OTHER TASKS SHALL BE INCLUDED IN ASSOCIATED PROPOSED STORM, SANITARY, OR WATER MAIN ITEMS AND SHALL NOT BE PAID FOR SEPARATELY.
- 5: LANDSCAPING SHALL BE PROTECTED AT ALL TIMES. ANY DAMAGE TO LANDSCAPING OUTSIDE THE WORK ZONE SHALL BE REPAIRED AT THE CONTRACTORS EXPENSE AND NOT PAID FOR SEPARATELY. 6: THE EXISTING ASPHALT CURB AND IMMEDIATELY ADJACENT PAVEMENT IS TO REMAIN IN PLACE. SEE PLAN FOR LOCATIONS WHERE PORTIONS
- OF THE CURB AND PAVEMENT ARE BEING REMOVED AND REPLACED. ANY DAMAGE TO THE CURB AND PAVEMENT OTHER THAN WHAT IS CALLED FOR ON THE PLANS AND AS DIRECTED BY THE ENGINEER TO BE REMOVED SHALL BE REPLACED AT THE CONTRACTORS SOLE EXPENSE AND NOT PAID FOR SEPARATELY.
- 7: CONTRACTOR SHALL SAWCUT 18" FROM BACK OF EXISTING ASPHALT CURB FULL DEPTH FOR A CLEAN EDGE. PAVEMENT REMOVAL SHALL BE ACCORDING TO AREAS SHOWN ON PLANS. IF SAWED EDGE IS DAMAGED DURING CONSTRUCTION ACTIVITIES A CLEAN EDGE WILL BE RE-ESTABLISHED AND ALL ADDITIONAL HMA REQUIRED TO ACCOUNT FOR EDGE CHANGE SHALL BE THE CONTRACTORS EXPENSE AND NOT PAID FOR SEPARATELY.
- 8: CONTRACTOR MUST MAINTAIN ACCESS TO ALL DRIVEWAYS AT ALL TIMES DURING CONSTRUCTION. THIS SHALL BE INCLUDED IN THE ITEM OF WORK "GENERAL CONDITIONS, MAX.____" AND NOT PAID FOR SEPARATELY.
- 9: PAVEMENT REMOVAL SHALL OCCUR IN STAGES AS PART OF SANITARY AND WATER MAIN INSTALLATION. ALL COSTS NECESSARY TO PERFORM THE PAVEMENT REMOVAL IN A PART-WIDTH MANNER SHALL BE DEEMED TO BE INCLUDED IN THE ITEM OF WORK "HMA SURFACE, REM" AND SHALL NOT BE PAID FOR SEPARATELY.
- 10: AT THE CONCLUSION OF UNDERGROUND UTILITY CONSTRUCTION, AND IN ACCORDANCE WITH THE DIRECTION OF THE ENGINEER, THE CONTRACTOR SHALL REMOVE THE UPPERMOST 2" LAYER OF MAINTENANCE GRAVEL THAT HAS BEEN PLACED WITHIN THE ROADWAY FOR MAINTENANCE OF TRAFFIC PURPOSES IN ORDER TO REMOVE ALL CONSTRUCTION DEBRIS, TRENCH SPOILS, OR ANY OTHER DELETERIOUS MATERIALS THAT MAY EXIST IN ORDER TO PROVIDE A PROPER SURFACE FOR THE FINE GRADING OF THE AGGREGATE BASE COURSE. THE CONTRACTOR SHALL THEN AUGMENT THE REMAINING MAINTENANCE AGGREGATE WITH ADDITIONAL MAINTENANCE AGGREGATE MATERIAL IN ORDER TO BRING THE AGGREGATE BASE COURSE TO ITS FINAL GRADE. IF IT IS DETERMINED BY THE ENGINEER THAT THE ENTIRE MAINTENANCE AGGREGATE CROSS SECTION HAS BECOME EXCESSIVELY CONTAMINATED BY THE CONTRACTOR'S OPERATION, EXHIBITS SIGNS OF IMPROPER SUBGRADE SUPPORT, OR IS NOT USABLE FOR ANY OTHER REASON, IN THE SOLE OPINION OF THE ENGINEER, IT SHALL BE COMPLETELY REMOVED AND REPLACED AT NO ADDITIONAL COST TO THE PROJECT. THE CONTRACTOR SHALL THEN PROVIDE THE REQUIRED CROSS-SECTION OF AGGREGATE BASE COURSE MATERIAL AND PLACE, COMPACT, AND FINE GRADE IT IN ACCORDANCE WITH THE REQUIREMENTS OF THE CONTRACT. CONTRACT TIME SHALL CONTINUE THROUGHOUT THE ENTIRE AGGREGATE REMOVAL AND REPLACEMENT OPERATION IF IT IS DETERMINED BY THE ENGINEER TO BE NECESSARY. IT IS THE INTENT OF THE CITY THAT THE MAINTENANCE AGGREGATE MATERIAL BE RE-USED TO THE EXTENT PRACTICABLE AND ALLOWED REMOVE EXISTING ASPHALT CURB AND PAVEMENT,

BY THE CONTRACTOR'S OPERATIONS.

48" Dia.

6.40


SANITARY SEWER STRUCTURE TABLE						
STRUCTURE	ROAD STATION	INVERT ELEVATION, SIZE & DIRECTION	TOP OF CASTING ELEVATION	DEPTH (Feet)	SIZE	APPLICATION/ CONSTRUCTION/ DETAIL
71-69931	3+14 11.95' RT	8" N 818.24 8" W 817.44 8" E 817.39	822.84	7.40	48" Dia.	
		8" N 818 34				

824.74



L		
Σ	NCM	
MF	NCM	
MF	VCM	
MF	NCM	
DRAWN	CHECKED	
MF MF DRAWN		MF VCM MF VCM DRAWN CHECKED


CITY OF ANN ARBOR PUBLIC SERVICES 301 EAST HURON STREET P.O. BOX 8647 ANN ARBOR, MI 48107-8647 734-794-6410 www.a2gov.org

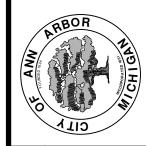

RIVERVIEW DRIVE SANITARY SEWEF AND WATER MAIN EXTENSION PROJECTPOSED PAVING HUNTINGTON PLACE STA 3+00 TO STA

ANN ARBOR

SHEET No.

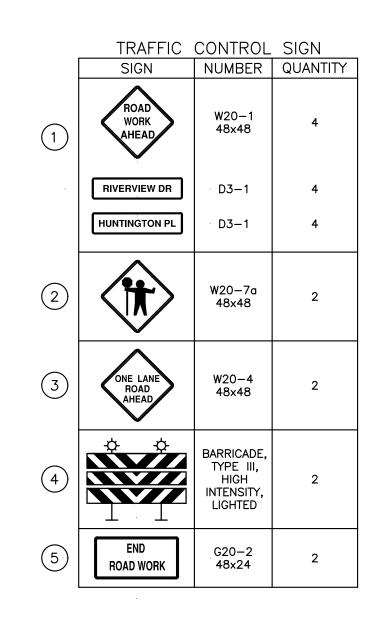

- CHANNELIZING DEVICE
- TEMPORARY SIGN
- TRAFFIC REGULATOR

LIGHTED ARROW (CAUTION MODE)

WORK ZONE CONSTRUCTION LIMITS

—28.62—

Identifier: D3-1;

1.63" Radius, 0.63" Border, 0.38" Indent, Black on, Orange; [RIVERVIEW] C; [DR] C;

Table of widths and spaces

R | I | V | E | R | V | I | E | W | 4.93 | 2.74 | 1.05 | 0.70 | 0.85 | 3.04 | 0.85 | 2.50 | 0.84 | 2.74 | 0.84 | 3.05 | 0.84 | 0.71 | 1.05 | 2.50 | 0.57 | 3.75

D R 3.00 2.73 1.05 2.74 4.93

GENERAL NOTES:

- 1: ALL TRAFFIC CONTROL DEVICES SHALL MEET CURRENT MDOT, MMUTCD AND CITY OF ANN ARBOR STANDARDS.
- 2: CONTRACTOR IS RESPONSIBLE FOR ALL CITY OF ANN ARBOR PERMITS. SEE SHEET NO.3 FOR ADDITIONAL INFORMATION.
- 3: CONTRACTOR IS TO CONTINUOUSLY MAINTAIN ALL TRAFFIC CONTROL DEVICES.
- 4: CONTRACTOR TO MAINTAIN 2-WAY TRAFFIC USING FLAGGER OPERATIONS AND AS DETAILED IN THE SPECIFICATIONS AND PLAN SHEETS (SEE DETAILS AND NOTES BELOW).
- 5: CONTRACTOR SHALL MAINTAIN ACCESS TO ALL PROPERTIES AT ALL TIMES AND PROVIDE ACCESS FOR EMERGENCY VEHICLES, MAIL DELIVERY, GARBAGE PICKUP AND RELATED SERVICES THROUGHOUT THE ENTIRE PROJECT TIMELINE.
- 6: CONTRACTOR SHALL PROTECT ALL WORK ZONES AT ALL TIMES.

STAGING NOTES:

STAGE 1 CONSTRUCTION OF THE SANITARY SEWER WILL BEGIN AT MH S-71-69938 AND PROGRESS TO THE SOUTH. MAINTAIN TWO-WAY VEHICULAR AND PEDESTRIAN TRAFFIC USING ROLLING LANE CLOSURES AS DETAILED HEREIN. CONSTRUCTION OF THE SEWER WILL BE COMPLETED IN INCREMENTS WITH 50 FOOT BUFFER ZONES.


STAGE 2

CONSTRUCTION OF THE WATER MAIN WILL BEGIN AT THE SOUTH END OF THE PROJECT AND PROGRESS TO THE NORTH. MAINTAIN TWO-WAY VEHICULAR AND PEDESTRIAN TRAFFIC USING ROLLING LANE CLOSURES AS DETAILED HEREIN. CONSTRUCTION OF THE SEWER WILL BE COMPLETED IN INCREMENTS WITH 50 FOOT BUFFER ZONES.

CONTRACTOR SHALL MAINTAIN ACCESS TO ALL DRIVEWAYS.

PRIOR TO BEGINNING CONSTRUCTION IN EACH PHASE OF THE PROJECT, THE CONTRACTOR SHALL REMOVE, STORE AND PROTECT THE EXISTING ROADWAY GUIDE AND REGULATORY SIGNS THAT ARE WITHIN THE PROJECT CONSTRUCTION LIMITS. THE SIGNS WILL BE REINSTALLED BY THE CITY FORCES AT THE CONCLUSION OF THE PROJECT. THIS WORK SHALL NOT BE PAID FOR SEPARATELY BUT SHALL BE INCLUDED IN THE ITEM OF WORK "GENERAL CONDITIONS, MAX.____".

REFERENCE THE "DETAILED SPECIFICATION FOR MAINTAINING TRAFFIC AND CONSTRUCTION SEQUENCING" FOR ADDITIONAL PROJECT REQUIREMENTS. THE CONTRACTOR'S ATTENTION IS SPECIFICALLY DIRECTED TO THE SECTION OF THE SAME DETAILED SPECIFICATION REGARDING COORDINATING WITH THE CITY PUBLIC WORKS SIGNS AND SIGNALS UNIT.

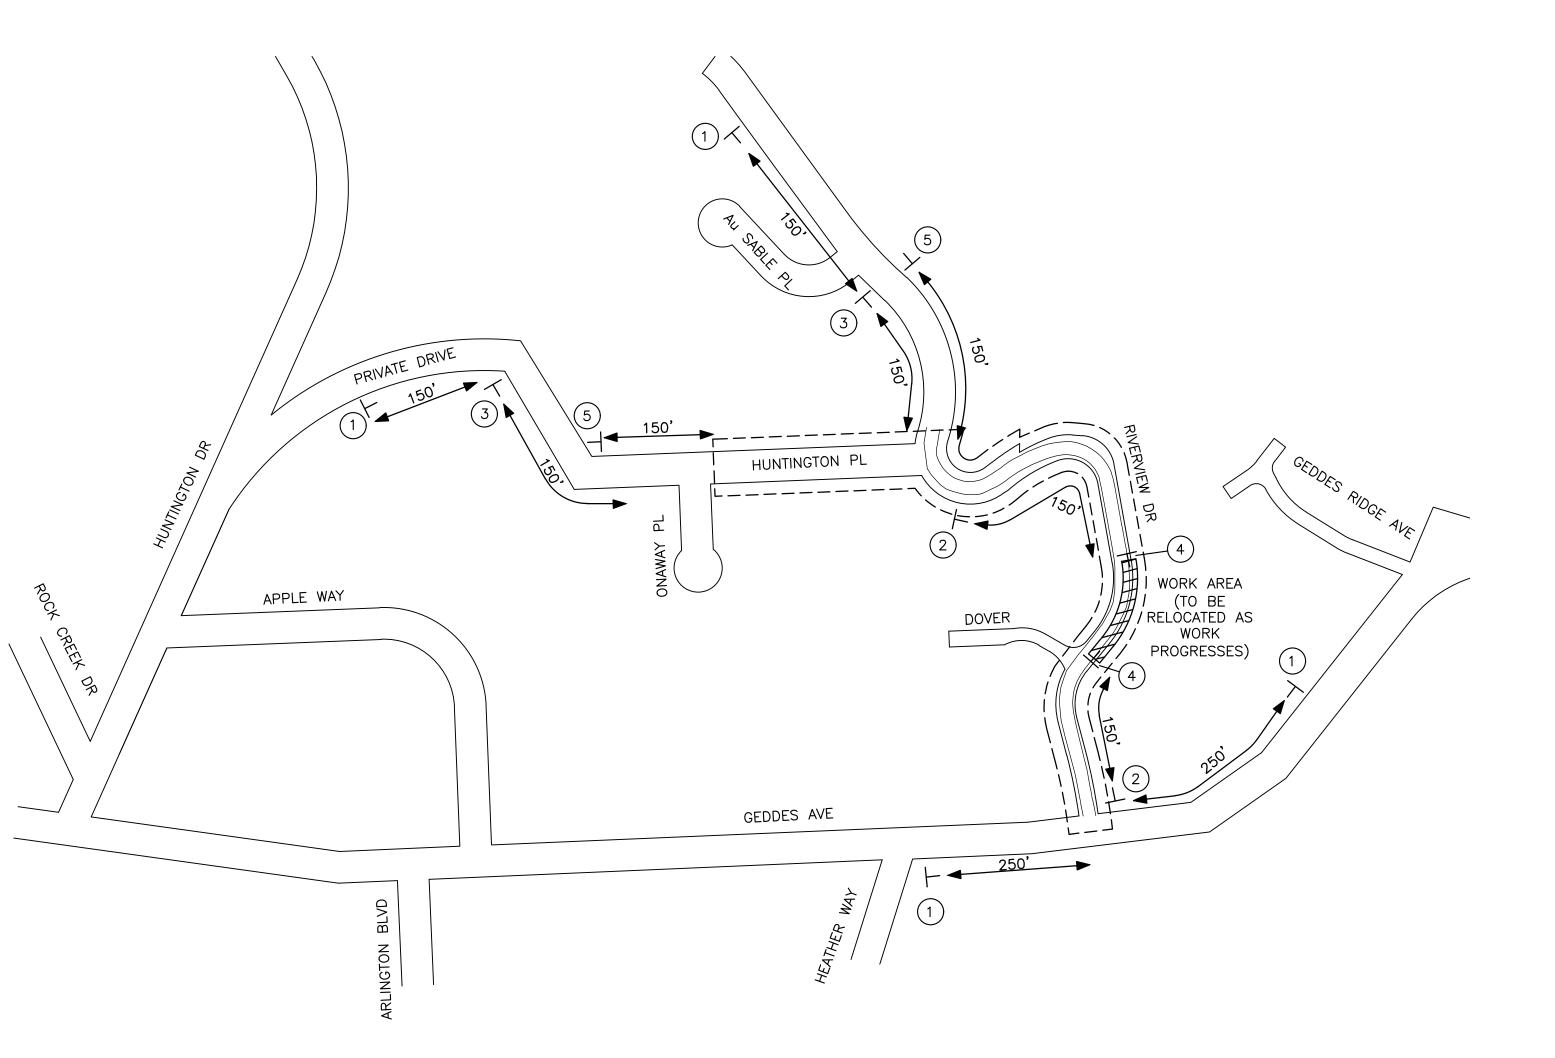


RIVERVIEW DRIVE ROLLING CLOSURE


NOT TO SCALE

THE EXISTING FEATURES, THE WORK, AND ALL

EMPLOYED IN THE CONSTRUCTION AND

INSPECTION OF THE WORK.

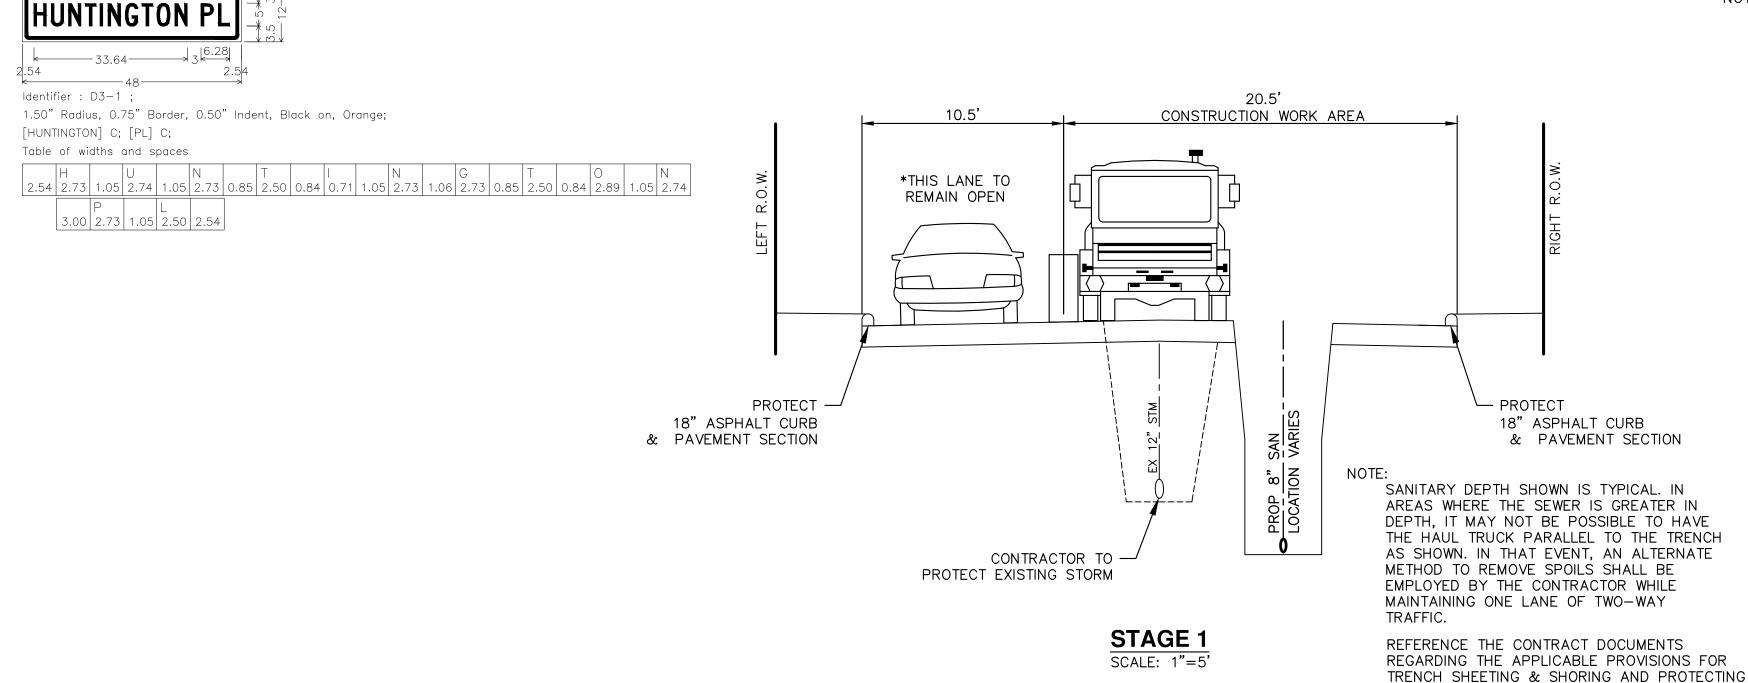

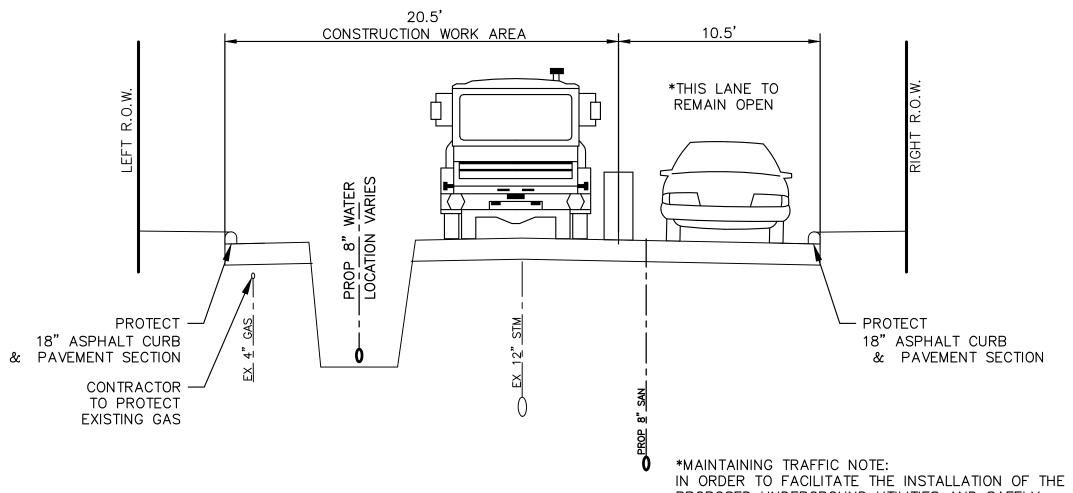

STAGE 2

SCALE: 1"=5"

PROPOSED UNDERGROUND UTILITIES AND SAFELY MAINTAIN TRAFFIC, THE CONTRACTOR SHALL BE ALLOWED TO WORK TO INSTALL THE UNDERGROUND UTILITIES UNINTERRUPTED. HOWEVER, ONCE EVERY 30 MINUTES (AT THE TOP AND BOTTOM OF EACH WORKING HOUR) THE CONTRACTOR SHALL CLEAR HIS EQUIPMENT AND TRUCKS FROM THE REMAINING LANE OF RIVERVIEW DRIVE FOR 5 MINUTES TO ALLOW LOCAL TRAFFIC TO PASS. THE CONTRACTOR SHALL THEN RESUME WORKING UNTIL THE NEXT

CLEARANCE INTERVAL OCCURS.

SHEET No.

RIVERVIEW DRIVE SANITARY SEWEF AND WATER MAIN EXTENSION PROJE

- ENGINEERING

PUBLIC SERVICES

ARBOR

OF

<u>Line</u>	PayItemCode	SupplementalDescription	<u>Units</u>	Quantity
·	<u> </u>	Exploratory Excavation (0 - 10' deep), Special	Ea	12
		Dr Structure Cover, Type B, Special	Ea	1
	3 8237001	Excavate & Backfill for Water Service Tap and Lead	Ft	649
		PC 350, D.I. Water Main, w/Polyethylene Wrap, 12 inch, Tr Det I, Mod	Ft	1515
		PC 350, D.I. Water Main, w/Polyethylene Wrap, 6 inch, Tr Det I, Mod	Ft -	6
		PC 350, D.I. Water Main, w/Polyethylene Wrap, 8 inch, Tr Det I, Mod	Ft F+	194
		Water Main, HDPE, 10 inch, Directional Drill Water Main, HDPE, 14 inch, Directional Drill	Ft Ft	352 205
		11.25 deg Bend, 12 inch	Ea	9
1		11.25 deg Bend, 8 inch	Ea	1
1		22.5 deg Bend, 12 inch	Ea	5
1	2 8237050	22.5 deg Bend, 8 inch	Ea	1
1		45 deg Bend, 12 inch	Ea	15
1		45 deg Bend, 8 inch	Ea	16
1		90 deg Bend, 14 inch	Ea	1
1		90 deg Bend, 8 inch Cap, 12 inch	Ea Ea	1
1		Cap, 8 inch	Ea	1
1		Fire Hydrant Assembly, with Extensions, Complete	Ea	6
2	0 8237050	Gate Valve-in-Box, 12 inch	Ea	4
2	1 8237050	Gate Valve-in-Well, 8 inch	Ea	1
2		Permanent Blow-Off	Ea	1
2		Reducer, 10 inch x 8 inch	Ea	4
2. 2.		Reducer, 12 inch x 8 inch	Ea Ea	2
2		Reducer, 14 inch x 12 inch Reducer, 8 inch x 6 inch	Ea Ea	6
2		Tee, 12 inch x 12 inch x 12 inch	Ea	1
2		Tee, 12 inch x 12 inch x 8 inch	Ea	7
2:	9 8237050	Tee, 8 inch x 8 inch	Ea	1
3	0 8237050	Water Service Connection to HDPE Water Main	Ea	4
3		Dr Structure Cover, Type Q, Special	Ea	8
3		Dr Structure, Manhole, Type I, 48 inch dia, Sanitary, Add Depth	Ft	15
3.		Sewer, SDR 35 PVC Pipe, 8 inch, Tr Det I Sewer, SDR 35 PVC Pipe, Riser, 4 inch	Ft Ft	841 8
3.		Sewer, SDR 35 PVC, Drop Connection, 8 inch	Ft	15
3		Sewer, SDR 35 PVC, Service Lead, 4 inch, Tr Det I	Ft	182
3		Pipe Undercut & Refill (6A Limestone)	Cyd	23
3	8 8507050	Dr Structure, Manhole, Type I, 48 inch dia, Sanitary	Ea	8
3	9 8507050	Sewer Tap, 8 inch	Ea	1
4		Sewer, 8 inch x 8 inch x 4 inch Tee, SDR 35 PVC	Ea	9
4		Sewer, Any Size or Depth, Rem	Ft	259
4. 4.		Curb, Any Type or Size, Rem Subgrade Undercutting, Type II	Ft Cyd	678 120
4		Machine Grading, Modified, Dover	Sta	2.5
4.		Machine Grading, Modified, Huntington Pl	Sta	7
4		Machine Grading, Modified, Riverview Drive	Sta	10
4	7 2080036	Erosion Control, Silt Fence	Ft	200
4		Erosion Control, Inlet Filter	Ea	14
4:		Aggregate Base, 8 inch, 21AA Modified	Syd	5505
5		Maintenance Gravel, LM	Cyd	1494
5 5		Aggregate Surface Course, 23A Approach, Cl II	Ton Ton	64 3
5.		Sewer, Cl C76 IV, 12 inch, Tr Det I, Modified	Ft	259
5		Additional Depth Structure Adjust/Repair	Ft	6
5.		Adjust Structure Cover	Ea	6
5	6 5010005	HMA Surface, Rem	Syd	5205
5		HMA, LVSP	Ton –	1340
5		HMA Approach, LVSP, Special	Ton	50
59 6		Curb, Conc, E4 Curb Sloped, HMA, Special	Ft Ft	20 678
6		Double Shredded Hardwood Bark Mulch, 6 inch	Syd	35
6		Hydroseeding	Syd	520
6	3 8167011	Topsoil Surface, 4 inch	Syd	520
6	4 8167011	Topsoil Surface, 6 inch	Syd	35
6.		Audiovisual Recording	LSUM	1
6		Certified Payroll Compliance and Reporting	LSUM	1
6 6		General Conditions, Max xxxx Protective Fence, Orange, Plastic, 4 Foot Ht.	LSUM Ft	1 200
6		Barricade, Type III, High Intensity, Lighted, Furn	гі Ea	200 4
7		Barricade, Type III, High Intensity, Lighted, Oper	Ea	4
7		Plastic Drum, High Intensity, Furn	Ea	50
7.		Plastic Drum, High Intensity, Oper	Ea	50
7		Sign, Type B, Temp, Prismatic, Furn	Sft	160
7		Sign, Type B, Temp, Prismatic, Oper	Sft	160
7.		Traf Regulator Control Minor Traffic Davices Max	LSUM	1
7 [.] 7		Minor Traffic Devices, Max Project Clean-Up and Restoration, Special	LSUM LSUM	1
,	. 010/031			1

	Know what's below. Call before you dig.
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СНЕСКЕD	DRAWN	DATE	DESCRIPTION	REV.	
NCM	MF	2/23/2018	05 FINAL REVIEW TO CITY OF ANN ARBOR	05	_ <u>5</u>
NCM	MF	2/28/2018	06 FINAL PLANS - CITY OF ANN ARBOR	90	07-8647
NCM	MF	10/9/2018	07 SANITARY AND WATER MAIN PERMIT (REV)	07	TREET
NCM	MF	10/30/2018	08 FINAL REVIEW TO CITY OF ANN ARBOR	80	RBOR
MOA	MF	11/7/2018	FINAL PLANS - CITY OF ANN ARBOR	60	

CIJ 901
ARBOR NNA NNA
<u> </u>

CITY OF ANN ARBOR - PUBLIC SERVICES - ENGINEERING


SCALE :NONE

SCALE :NONE

BRIVERVIEW DRIVE SANITARY SEWER

AND WATER MAIN EXTENSION PROJECT SOL7-031-29

SUMMARY OF QUANTITIES

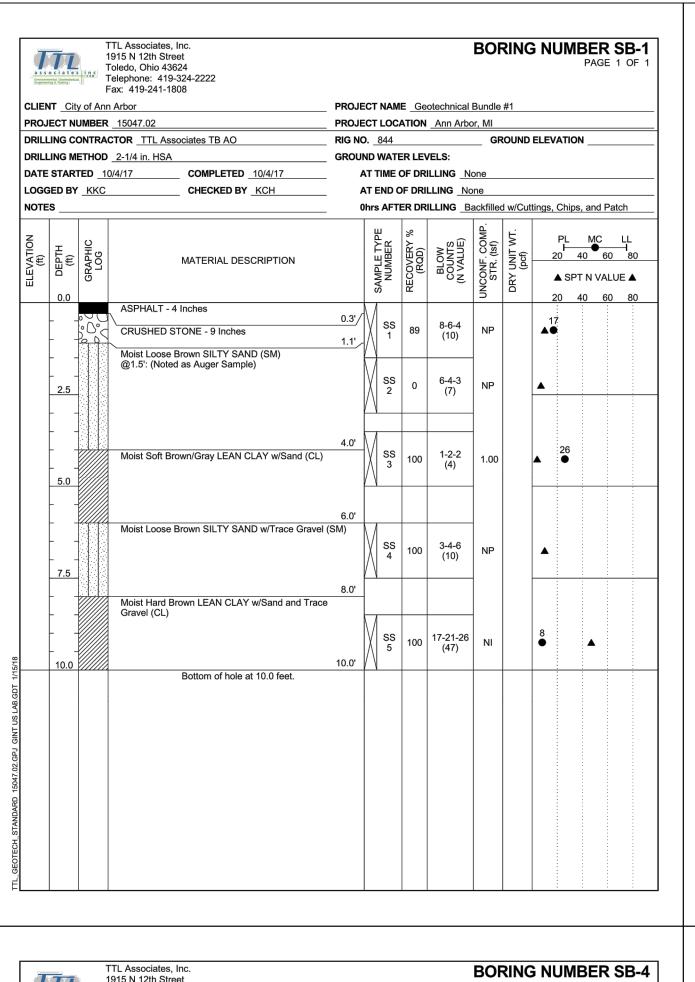


a s s	TL o c i a t e : ental. Grotechnica ing & Testing	inc	1915 N 12th St Foledo, Ohio 4 Felephone: 41	3624 9-324-2222						БОІ	XIIVC	3 NUM	PAGE	
		y of Anr		1808					otechnical		#1			
			15047.02						Ann Arbo					
				ssociates TB AO						GR	ROUND	ELEVATIO	ON	
			2-1/4 in. HS/	COMPLETED 10/4/17	GROU				ELS: LLING N					
				CHECKED BY KCH					LING No					
		KKO		GILORED DT _KGH							d w/Cut	tings, Chip	s, and F	atch
ELEVATION (ft)	o DEPTH	GRAPHIC LOG		MATERIAL DESCRIPTION		SAMPLE TYPE	NUMBER	RECOVERY % (RQD)	BLOW COUNTS (N VALUE)	UNCONF. COMP. STR. (tsf)	DRY UNIT WT. (pcf)	▲ SF	MC 40 6 PT N VA	LUE
				STONE - 9 Inches	0.3'/ 1.1'	111	SS 1	56	10-7-5 (12)	3.00		24 A •	40 0	iO {
	 _ 2.5		(CL)	Brown LEAN CLAY w/Sand and Tra um Stiff Brown LEAN CLAY w/Sand el (CL)	1.5'		SS 2	100	4-4-4 (8)	1.50		15 A •		
	 		Moist Loose	e Brown SILTY SAND w/Trace Gra			SS 3	100	2-2-5	NP		A		
	5.0						3		(7)	-				
	 7.5						SS 4	100	3-3-5 (8)	NP		A		
	 					:	SS 5	100	4-4-5 (9)	NP		A		
	10.0			Bottom of hole at 10.0 feet.	10.0'	/ \								
											-			

CLIEN	IT City	of Ann	Arbor	PROJE	СТ	NAM	E Ge	otechnical l	Bundle	#1				
			15047.02					Ann Arbo						
DRILL	ING CO	NTRAC	TTL Associates TB AO	RIG NO	٠_	844			_ GR	OUND	ELEVAT	ION _		
DRILL	ING ME	THOD	2-1/4 in. HSA	GROUN	ID	WATE	R LEV	ELS:						
			/4/17 COMPLETED 10/4/17					LLING No						
			CHECKED BY KCH					LLING No						
NOTE	S			01	nrs	AFTI	ER DR	LLING B	ackfilled	d w/Cut	tings, Ch	ips, an	id Pat	ch
ELEVATION (ft)	DEPTH (ft)	GRAPHIC LOG	MATERIAL DESCRIPTION		1071	SAMPLE I TPE NUMBER	RECOVERY % (RQD)	BLOW COUNTS (N VALUE)	UNCONF. COMP. STR. (tsf)	DRY UNIT WT. (pcf)	PL F 20	. M	—	LL H ₈₀
ELE		8.				N N N N N N N N N N N N N N N N N N N	RECC (F	<u> </u>	INCON	DRY (▲ 5	SPT N		
	0.0	ăq	CRUSHED STONE - 7 Inches		. /)		20	40	60	80
	- <u>-</u>	.0.0	Moist Medium Dense Brown SILTY SAND w/Trace Gravel (SM)	0.6' e	\bigvee	SS 1	78	24-17-10 (27)	NP		4			
	2.5			3.0'	\bigvee	SS 2	89	7-7-7 (14)	NP		A			
			Moist Medium Stiff Brown SANDY LEAN CLAY (C	CL)	./I						16			
	5.0			4	\setminus	SS 3	100	3-3-3 (6)	1.75		▲ ● ⊢			
	-		Moist Loose Brown CLAYEY SAND w/Trace Grav	6.0'	\									
	7.5		Moist Very Stiff Brown LEAN CLAY w/Sand and T Gravel (CL)	7.0' race	\setminus	SS 4	100	2-2-3 (5)	NP		A			
	- -			Ī	. /									
	10.0		Bottom of hole at 10.0 feet.	10.0'	\setminus	SS 5	100	8-13-17 (30)	4.00		9	A		

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a s s	o c l a t'e's	1 5 in c 7		Street 43624 119-324-2222						БОГ	VIIVC	NUM		E 1 OF
CLIEN	NT _Cit		ax: 419-24 ⁻ Arbor	I-1808	PROJ	ECT	NAM	IE <u>Ge</u>	otechnical	Bundle	#1			
PROJ	ECT N	UMBER	15047.02		PROJ	ECT	LOC	ATION	Ann Arbo	or, MI				
				Associates TB AO SA						GR	OUND	ELEVATION	ON	
				COMPLETED _10/4/17		AT TIME OF DRILLING None								
l .				CHECKED BY KCH					LLING No					
NOTE	:s					0hrs	AFT	ER DR	ILLING B		d w/Cut	tings, Chip	os, and I	2atch
ELEVATION (ft)	o DEPTH	GRAPHIC LOG		MATERIAL DESCRIPTION		i i	SAMPLE IYPE NUMBER	RECOVERY % (RQD)	BLOW COUNTS (N VALUE)	UNCONF. COMP. STR. (tsf)	DRY UNIT WT. (pcf)	▲ SI	40 6	80
			CRUSHE	Г - 2.5 Inches D STONE - 12.5 Inches	0.2' _/ 1.3'		SS 1	78	12-10-8 (18)	3.00		14:		
	2.5		Gravel (C	dium Dense Brown CLAYEY SAND	1.5'/		SS 2	17	5-6-6 (12)	NP		A		
	 5.0		Moist Ver Gravel (C	y Stiff Brown LEAN CLAY w/Sand a L)			SS 3	89	7-8-9 (17)	3.50		12		
	 7.5		Moist Mee Gravel (S	dium Dense Brown SILTY SAND w/ M)	6.8' Trace		SS 4	94	7-9-10 (19)	NP		4		
			Moist Stif	f Brown SANDY SILT w/Trace Grav	8.0'	4								
	10.0		out ou		10.0'		SS 5	89	6-7-7 (14)	NI		14 •		
				Bottom of hole at 10.0 feet.										

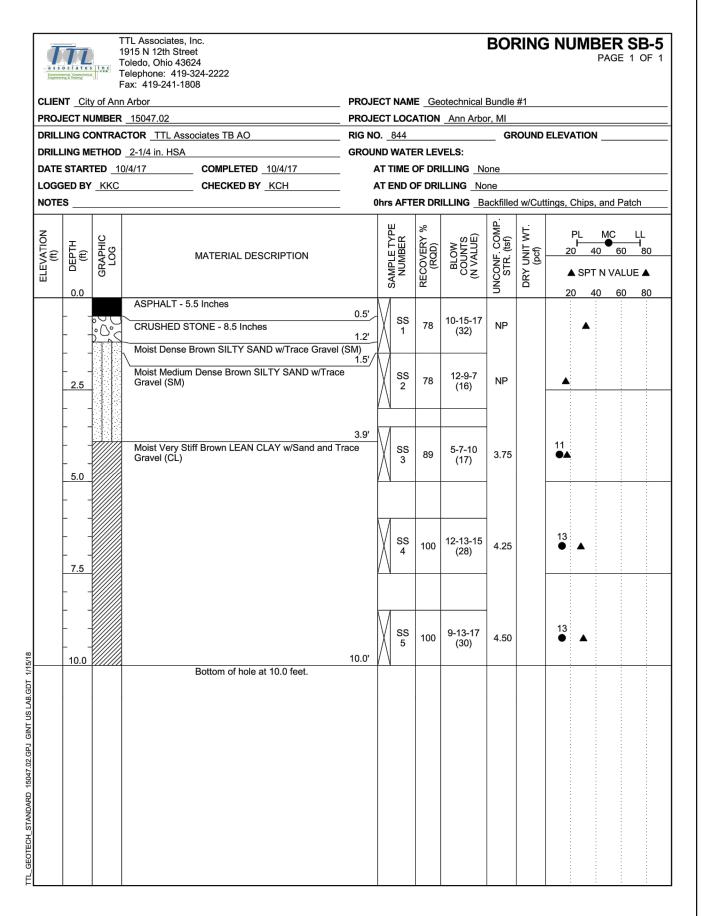


OL 151		Fax: 419-241		PPO 1503		- 0-	-4	D						
	NT <u>City of An</u>	n Arbor R _15047.02					otechnical Ann Arbo		#1					
			ASSOCIATES TB AO						OUND	ELE\	/ATIOI	N		-
			A .					_				_		
DATE	STARTED _1	0/4/17	COMPLETED 10/4/17				ILLING N	one						
LOGG	SED BY KKC		CHECKED BY KCH	AT	END C	F DRI	LLING No	ne						
NOTE	s			0hr	s AFTI	ER DR	ILLING B	ackfilled	d w/Cut	tings,	, Chips	, and	Patch	—I
ELEVATION (ft)	GRAPHIC LOG		MATERIAL DESCRIPTION		SAMPLE TYPE NUMBER	RECOVERY % (RQD)	BLOW COUNTS (N VALUE)	UNCONF. COMP. STR. (tsf)	DRY UNIT WT. (pcf)		20 ∠ Δ SP1	ΓNVA	LL 50 80 LUE 4	.
			- 3 Inches D STONE - 7 Inches BE Brown SILTY SAND w/Trace Gravel (0.3'/	SS 1	78	6-4-5 (9)	NP		•				
	2.5	:[\	ium Dense Brown SILTY SAND w/Trace	1.5'/	SS 2	56	6-11-12 (23)	NP			A			
	5.0	Moist Loos	e Brown SILTY SAND w/Trace Gravel (6.0'	SS 3	67	4-3-2 (5)	NP		A				
	7.5	Moist Med Gravel (SN	ium Dense Brown CLAYEY SAND w/Tra		SS 4	89	3-4-4 (8)	NP		A				
	10.0	Moist Med	ium Dense Brown SILTY SAND (SM) Bottom of hole at 10.0 feet.	9.0'	SS 5	100	8-16-10 (26)	NP			A			

Environme Engineerin	ciates ntal Geotechnica g & Testing	T	1915 N 12th Street Foledo, Ohio 43624 Felephone: 419-324-2222								P	AGE 1 OF
CLIEN	T _City		Fax: 419-241-1808 n Arbor	PROJE	CT NAM	IE Ge	otechnical	Bundle	#1			
PROJE	ECT N	JMBER	15047.02		CT LOC	ATION	Ann Arbo	or, MI				
DRILL	ING CO	ONTRA	CTOR TTL Associates TB AO					GF	ROUND	ELEV	ATION _	
				GROU								
			0/4/17				illing <u>N</u> Lling <u>N</u> o					
		Tito					ILLING B		d w/Cu	tings,	Chips, a	nd Patch
z	DEPTH (ft)		MATERIAL DESCRIPTION		SAMPLE TYPE NUMBER	RECOVERY % (RQD)	BLOW COUNTS (N VALUE)	UNCONF. COMP. STR. (tsf)	DRY UNIT WT. (pcf)	2	0 40	AC LL 60 80
Ш	0.0				SA	뀖)	ONO	DR	2	0 40	
			ASPHALT - 3 Inches	0.3'/	ss		8-5-5					
		300	CRUSHED STONE - 9 Inches	1.0'/	1 33	78	(10)	NP		•		
-			Moist Loose Brown SILTY SAND w/Trace Gr	avel (SM)	$\left(\cdot \right)$							
	2.5			3.0'	SS 2	56	5-3-3 (6)	NP		A		
	_		Moist Dense Brown SILTY SAND w/Trace G	ravel (SM)								
	5.0				ss 3	33	10-20-25 (45)	NP			•	•
	 				SS 4	56	19-21-24 (45)	NP			_	
	7.5				/\		(1,	_				
			@8.5': Very Dense		\/			_				
	 10.0			10.0'	SS 5	67	24-26-28 (54)	NP				A
			Bottom of hole at 10.0 feet.									



MF | MF | MF | X

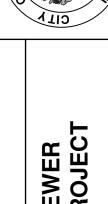

CITY OF ANN ARBOR - PUBLIC SERVICES - ENGINEERING

SCALE PLAN: NONE

SCALE PLAN: NONE

SCALE PLAN: NONE

BRAWING No.

AND WATER MAIN EXTENSION PROJECT 2017-031-30